# MED SPA INTERIOR TENANT IMPROVEMENTS

## OKATERION

1383 BUNKER HILL RD. SUITE 103 HOUSTON, TX 77055

1502 SAWYER STREET, STE 135 HOUSTON, TX 77007 TEL: (281) 888-5950

#### PROJECT TEAM

OWNER

DAMEON TRYON OKATERION 1221 MCKINNEY ST #3100 HOUSTON, TX 77004

DESIGN TEAM

2X STUDIO 1502 SAWYER STREET, STE 135 HOUSTON, TX 77007 ADMIN@2XSTUDIOHTX.COM (281) 888-5950

MEP ENGINEER

KCI TECHNOLOGIES, INC. 801 TRAVIS, STE 2000 HOUSTON, TX 77002 KAMERON.RAISI@KCI.COM (281) 975-1504

#### **GENERAL NOTES**

DO NOT SCALE DRAWINGS. NOTED DIMENSIONS TAKE PRECEDENCE

EXISTING CONSTRUCTION AND DIMENSIONS SHOWN ARE PER EXISTING DRAWINGS. ALL EXISTING INFORMATION MUST BE VERIFIED IN FIELD. NEITHER THE OWNER, COLBY DESIGN AND 2X STUDIO ARE RESPONSIBLE FOR ACCURACY OF INFORMATION.

CONTRACTOR'S CHOICE AS TO THE MEANS OF CONSTRUCTION, THE SEQUENCE OF CONSTRUCTION, AND SAFETY PRECAUTIONS INCIDENT THERETO, ARE NOT PART OF THE COLBY DESIGN & 2X STUDIO'S RESPONSIBILITY.

NEW CONSTRUCTION DIMENSIONS ARE BASED ON A SURVEY PROVIDED BY CLIENT. THE CONTRACTOR SHALL VERIFY DRAWING DIMENSIONS AGAINST ACTUAL SITE CONDITIONS AND BOUNDARIES AND SHALL NOTIFY THE COLBY DESIGN OR 2X STUDIO OF ANY AREAS WHICH WOULD DIFFER FROM THE INTENT OF THE DRAWINGS, OR THAT SHOW DISCREPANCY BETWEEN SECTIONS OF THE DRAWINGS AND/OR ACTUAL SITE CONDITIONS PRIOR TO CONSTRUCTION. IN THE EVENT OF THE CONTRACTOR'S FAILURE TO GIVE SUCH NOTICE, HE WILL BE HELD RESPONSIBLE FOR THE RESULTS OF COST RECTIFYING THE SAME.

#### PROJECT DESCRIPTION

 INTERIOR REMODEL OF EXISTING COMMERCIAL TENANT LEASE SPACE.

2. LOBBY REMODEL ONLY.

#### APPLICABLE CODES

2012 INTERNATIONAL BUILDING CODE

2017 NATIONAL ELECTRIC CODE

2012 UNIFORM MECHANICAL CODE

2015 INTERNATIONAL ENERGY CONSERVATION

2012 INTERNATIONAL FIRE CODE

ASHRAE 90.1-2013

PLUS ALL C.O.H. AMENDMENTS

2012 UNIFORM PLUMBING CODE

#### SIGNAGE NOTES

ALL SIGNAGE SUBMITTED SEPARATELY.

#### **EXISTING CODE ANALYSIS**

**EXISTING REMODEL AREA:** 1,165 SF

**EXISTING OCCUPANCY CLASSIFICATION:** BUSINESS - GROUP B

**EXISTING CONSTRUCTION:** 

TYPE: II-B

ALLOWABLE AREA PER FLOOR:

19,000 SF / 8,279 PROJECT RELATED SPACE OF 12,435 SF ON LEVEL 1

MAXIMUM FLOORS: 4 FLOORS / 1 FLOOR

MAXIMUM HEIGHT: 55' / EXISTING CONSTRUCTION

STRUCTURAL FRAME:

- COLUMNS (SUPPORTING FLOORS) 0HR / EXISTING CONSTRUCTION - FLOOR / CEILING 0HR / EXISTING CONSTRUCTION - ROOF / CEILING 0HR /EXISTING CONSTRUCTION

**EXISTING SHAFT ENCLOSURE:** 1HR / 1HR

**EXISTING WALLS:** 

- EXTERIOR BEARING 2HR / EXISTING CONSTRUCTION - EXTERIOR NON-BEARING 0HR (GREATER THAN 30') /

EXISTING CONSTRUCTION - INTERIOR BEARING 0HR / EXISTING CONSTRUCTION - INTERIOR NON-BEARING 0HR, NONCOMBUSTIBLE / **OHR NONCOMBUSTIBLE** 

CORRIDORS: 1HR / 1HR

EXISTING FIRE PROTECTION SYSTEM:

- AUTOMATIC SPRINKLER SYSTEM NOT REQUIRED FOR GROUP B / NOT SPRINKLERED - PORTABLE FIRE EXTINGUISHERS ABC TYPE; 2- A MIN.; 75' MAX. TRAVEL

**EXISTING OCCUPANCY LOAD:** - LEVEL 1 PROJECT SPACE 100 SF / PERSON = 83 (8,279 / 100)

MINIMUM NO. EXISTS / FLOOR - LEVEL 1

2 REQUIRED / 2 PROVIDED

**EXIT ACCESS TRAVEL DISTANCE:** 200' MAX. / <150'

#### **ABBREVIATIONS**

AB - ANCHOR BOLT AC - AIR CONDITIONING ACT - ACOUSTICAL CEILING TILE AD - ACCESS DOOR AFF - ABOVE FINISHED FLOOR AL - ALUMINUM

**BLDG - BUILDING** BLKG - BLOCKING B.O. - BOTTOM OF BOT - BOTTOM **BP - BUILDING PAPER** BR - BRASS

ANOD - ANODIZED

BRZ - BRONZE

BU - BUILT UP CAB - CABINET CPT - CARPET CHR - CHROME

CI - CAST IRON CJ - CONTROL JOIST CL - CENTER LINE CLG - CEILING CLR - CLEAR(ANCE) CMU - CONCRETE MASONRY UNIT COL - COLUMN CONC - CONCRETE

CONT - CONTINUOUS COP - COPPER CT - CERAMIC TILE

DIA - DIAMETER DTL - DETAIL DIM - DIMENSION LINE REFERENCE DN - DOWN DR - DOOR DWG - DRAWING E - EAST EA - EACH

**EB - EXPANSION BOLT** EJ - EXPANSION JOINT ELEC - ELECTRICAL EQ - EQUAL EWC - ELECTRICAL WATER COOLER EX - EXISTING EXT - EXTERIOR

FD - FLOOR DRAIN FE - FIRE EXTINGUISHER FEC - FIRE EXTINGUISHER CABINET FF - FACTORY FINISH FIN - FINISHED FL - FLOOR FLUOR - FLUORESCENT FWC - FABRIC WALL COVERING

GA - GAUGE GALV - GALVANIZED GC - GENERAL CONTRACTOR

R - RADIUS /OR RISERS

**REINF - REINFORCING** 

**RO - ROUGH OPENING** 

RD - ROOF DRAIN

REQD - REQUIRED

RM - ROOM

S - SEALANT

SCR - SCREW

SIM - SIMILAR

STL - STEEL

T - TREADS

THK - THICK

T.O. - TOP OF

TYP - TYPICAL

**SECT - SECTION** 

SF - SQUARE FOOT

STD - STANDARD

STR - STRUCTURAL

TB - TOGGLE BOLT

**SPEC - SPECIFICATIONS** 

SVF - SHEET VINYL FLOORING

S4S - SURFACE FOUR SIDES

TBD - TO BE DETERMINED

TGL - TEMPERED GLASS

TOC - TOP OF CONCRETE

UNO - UNLESS OTHERWISE NOTED

VCT - VINYL COMPOSITION TILE

VWC - VINYL WALL COVERING

TOS - TOP OF STEEL

TOW - TOP OF WALL

**VB - VAPOR BARRIER** 

VIF - VERIFY IN FIELD

VWB - VINYL WALL BASE

VERT - VERTICAL

WB - WALL BASE

W/O - WITHOUT

WTH - WIDTH

WGL - WIRED GLASS

WP - WORKING POINT

XR - EXISTING RELOCATED

W - WEST

W/ - WITH

WD - WOOD

T&G - TONGUE AND GROOVE

SS - STAINLESS STEEL

S - SOUTH

HT - HEIGHT HM - HOLLOW METAL HORIZ - HORIZONTAL HVAC - HEAT, VENTILATION A.C.

GWB - GYPSUM WALL BOARD

ID - INSIDE DIAMETER **INSUL - INSULATION** INT - INTERIOR

GL - GLASS

**KD - KNOCK DOWN** 

LAV - LAVATORY LVR - LOUVER LVT - LUXURY VINYL TILE

M - MOTION SENSOR MAX - MAXIMUM **MECH - MECHANICAL** MF - METAL FLASHING MFR - MANUFACTURER MIN - MINIMUM MO - MASONRY OPENING MTL - METAL

N - NORTH NIC - NOT IN CONTRACT NTS - NOT TO SCALE

OA - OVERALL OC - ON CENTER **OD - OUTSIDE DIAMETER** OH - OVERHEAD OPG - OPENING **OPP - OPPOSITE** 

OS - OCCUPANCY SENSOR P - PAINT PAR - PARALLEL PERP - PERPENDICULAR PLAM - PLASTIC LAMINATE PM - PRESSED METAL PT - PORCELAIN TILE PTL - PRESSURE TREATED LUMBER

QT - QUARRY TILE

PWD - PLYWOOD

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INTERIOR DETAILS

DOOR SCHEDULE/ HARDWARE TYPES

**MECHANICAL** 

A6.01

A8.01

M1.0 MECHANICAL SCHEDULES M1.1 MECHANICAL SPECIFICATIONS M1.2 MECHANICAL DETAILS M2.0 MECHANICAL PLAN

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TITLE SHEET / **GENERAL NOTES** SCALE: NTS

ISSUE

01 CLIENT REVIEW

DATE

20 AUG 2020

SHEET NO.

PROJECT NO.

2001

T1.00


01 PRELIMINARY RENDERINGS



COSMETIC CENTER - REMODEL


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AS-BUILT SCALE: 1/4"=1'-0"

2001 PROJECT NO. AD1.00 SHEET NO.

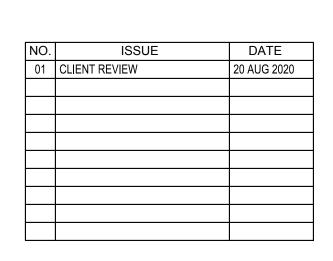

SCALE: 1/4"=1'-0"

0" 1'

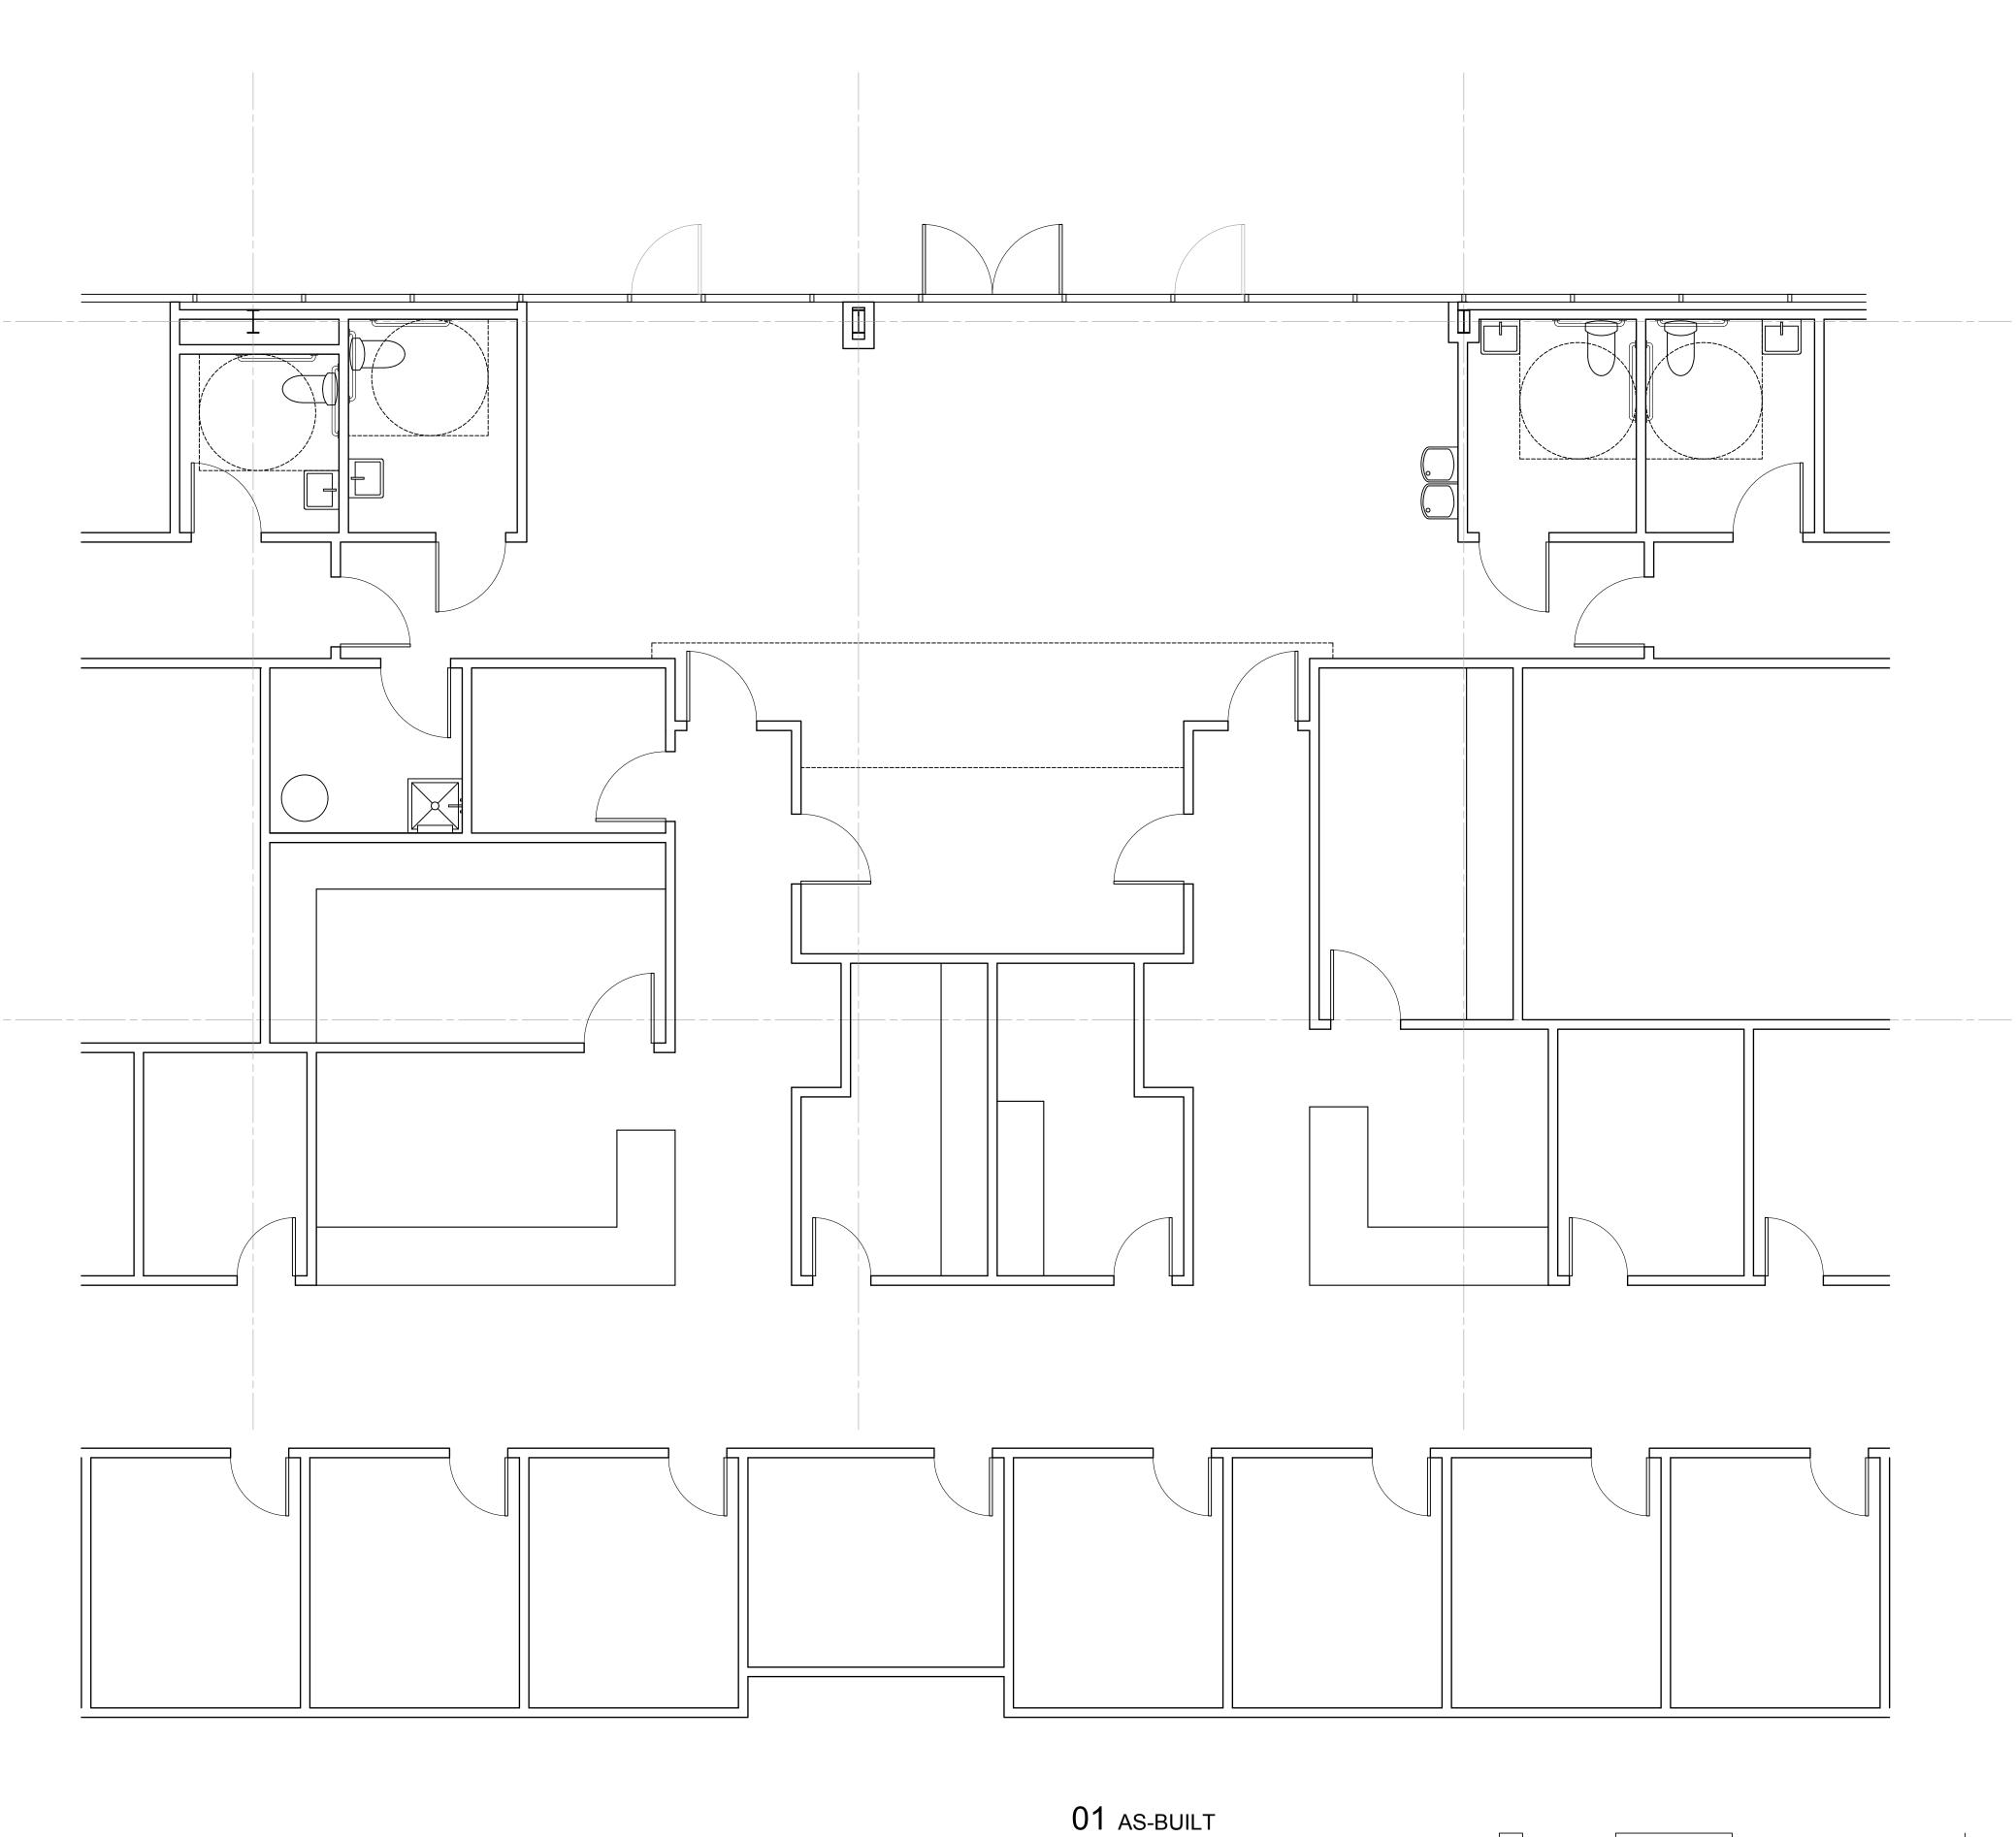
#### 02 DEMOLITION GENERAL NOTES

- 1. ACTUAL FIELD DIMENSIONS MAY VARY FROM THOSE INDICATED. CONTRACTOR SHALL FIELD VERIFY ALL DIMENSIONS PRIOR TO CONSTRUCTION.
- 2. CONTRACTOR SHALL PROTECT ALL STRUCTURAL MEMBERS, CAVITIES AND CONNECTIONS EXPOSED DURING DEMOLITION FROM THE ELEMENTS.
- 3. GC TO VERIFY ALL CONCRETE DECK PENETRATIONS AND OPENINGS SHALL BE CLOSED, FLASHED AND SEALED IN A MANNER ACCEPTABLE TO THE OWNER AND CONSISTENT WITH BUILDING STANDARDS.
- 4. CONTRACTOR SHALL ADVISE OWNER IF CONDITIONS OTHER THAN THOSE INDICATED EXIST WHICH MAY AFFECT STRUCTURAL INTEGRITY OR DESIGN INTENT.
- 5. ALL SALVAGE WILL BECOME THE PROPERTY OF THE CONTRACTOR UNLESS OTHERWISE SPECIFIED. PROMPTLY REMOVE FROM SITE AT CONTRACTOR'S EXPENSE AND DISPOSE OF IT ON A DAILY BASIS.
- 6. DASHED LINES INDICATE EXISTING WALLS TO BE REMOVED.
- 7. ALL EXISTING SURFACES REMAINING AFTER DEMOLITION IS COMPLETED ARE TO BE REPAIRED AND/OR CLEANED AS REQUIRED TO FACILITATE THE INSTALLATION OF NEW CONSTRUCTION AND NEW FINISHES.
- 8. NO MATERIALS SCHEDULED FOR DEMOLITION ARE TO BE REUSED IN THE NEW CONSTRUCTION WITHOUT WRITTEN AUTHORIZATION OF THE OWNER.
- 9. EXISTING TELEPHONE SYSTEMS, INCLUDING WIRING, CONDUIT, SPEAKERS, SWITCHES, AND MISCELLANEOUS ACCESSORIES AS NEEDED FOR NEW CONSTRUCTION, ARE TO REMAIN.
- 10. PRIOR TO DEMOLITION, FIELD VERIFY ALL STRUCTURAL COMPONENTS. DO NOT REMOVE ANY BEARING WALLS. NOTIFY ARCHITECT IMMEDIATELY OF ANY CONDITIONS WHICH VARY FROM THE PLANS.
- 11. IN NON DEMOLITION AREAS, ALL EXISTING ELECTRICAL SYSTEMS AND DEVICES TO REMAIN.
- 12. FIRE SPRINKLER SYSTEM TO REMAIN. FIRE SPRINKLER CONTRACTOR TO RE-DIRECT EXISTING SPRINKLER HEADS TO MAINTAIN FIRE PROTECTION REQUIREMENTS BY THE CITY. VERIFY W/ GC & FIRE PROTECTION CONTRACTOR AS PER BUILDING REQUIREMENTS.
- 13. REMOVE & DISPOSE OF BASE TRIM & CASE TRIM IN ENTIRE UNIT.
- 14. ALL INTERIOR DOORS TO REMAIN. VERIFY REMOVAL OF INTERIOR DOORS WITH GC'S SCOPE OF WORK. ALL DOOR FLOOR STOPS TO BE REMOVED & SAVED FOR FUTURE USE.
- 15. ALL ELECTRONIC WINDOW SHADES TO REMAIN.
- 16. GYP. BD. TO REMAIN ON FIRE-RATED DEMISING WALLS.
- 17. ALL SOUND SPEAKERS, WIRING, AND MISCELLANEOUS ACCESSORIES AS NEEDED FOR NEW CONSTRUCTION, ARE TO REMAIN.
- 18. ALL RECESSED LIGHTS TO REMAIN UNLESS OTHERWISE NOTED. RECESSED LIGHTS THAT ARE REMOVED, WILL BE SAVED FOR FUTURE USE.
- 19. EXISTING INTERNET, DATA, & TV CABLE SYSTEMS, INCLUDING WIRING AND MISCELLANEOUS ACCESSORIES AS NEEDED FOR NEW CONSTRUCTION, ARE TO REMAIN.

#### 03 DEMOLITION KEY NOTES D1 KEY NOTE SYMBOL

- D1. REMOVE & DISPOSE OF DOOR, DOOR FRAME, & HARDWARE. PREPARE FOR TALLER NEW DOORS TO BE INSTALLED IN EXACT LOCATION.
- D2. REMOVE & DISPOSE OF DOOR, DOOR FRAME, & HARDWARE.
- D3. REMOVE & DISPOSE OF GYP. BD. WALL FINISH & FRAME. D4. REMOVE & DISPOSE OF GYP. BD, NAILS, SCREWS, & FASTENERS. FRAME TO REMAIN.
- D5. REMOVE & DISPOSE OF STOREFRONT HANGING BLINDS.
- D6. REMOVE & DISPOSE OF GYP. BD. & FRAMING OF FURR DOWN.
- D7. REMOVE & DISPOSE GYP. BD & FRAMING AND PREPARE FOR TV NICHE. D8. REMOVE & DISPOSE OF 24X24 ACOUSTICAL LAY-IN CEILING TILES AND GRID FRAME.
- D9. REMOVE & DISPOSE OF HIGH & LOW WATER FOUNTAINS.
- D10.REMOVE & DISPOSE OF EXITING CABINET. VERIFY W/ OWNER PRIOR TO REMOVAL.



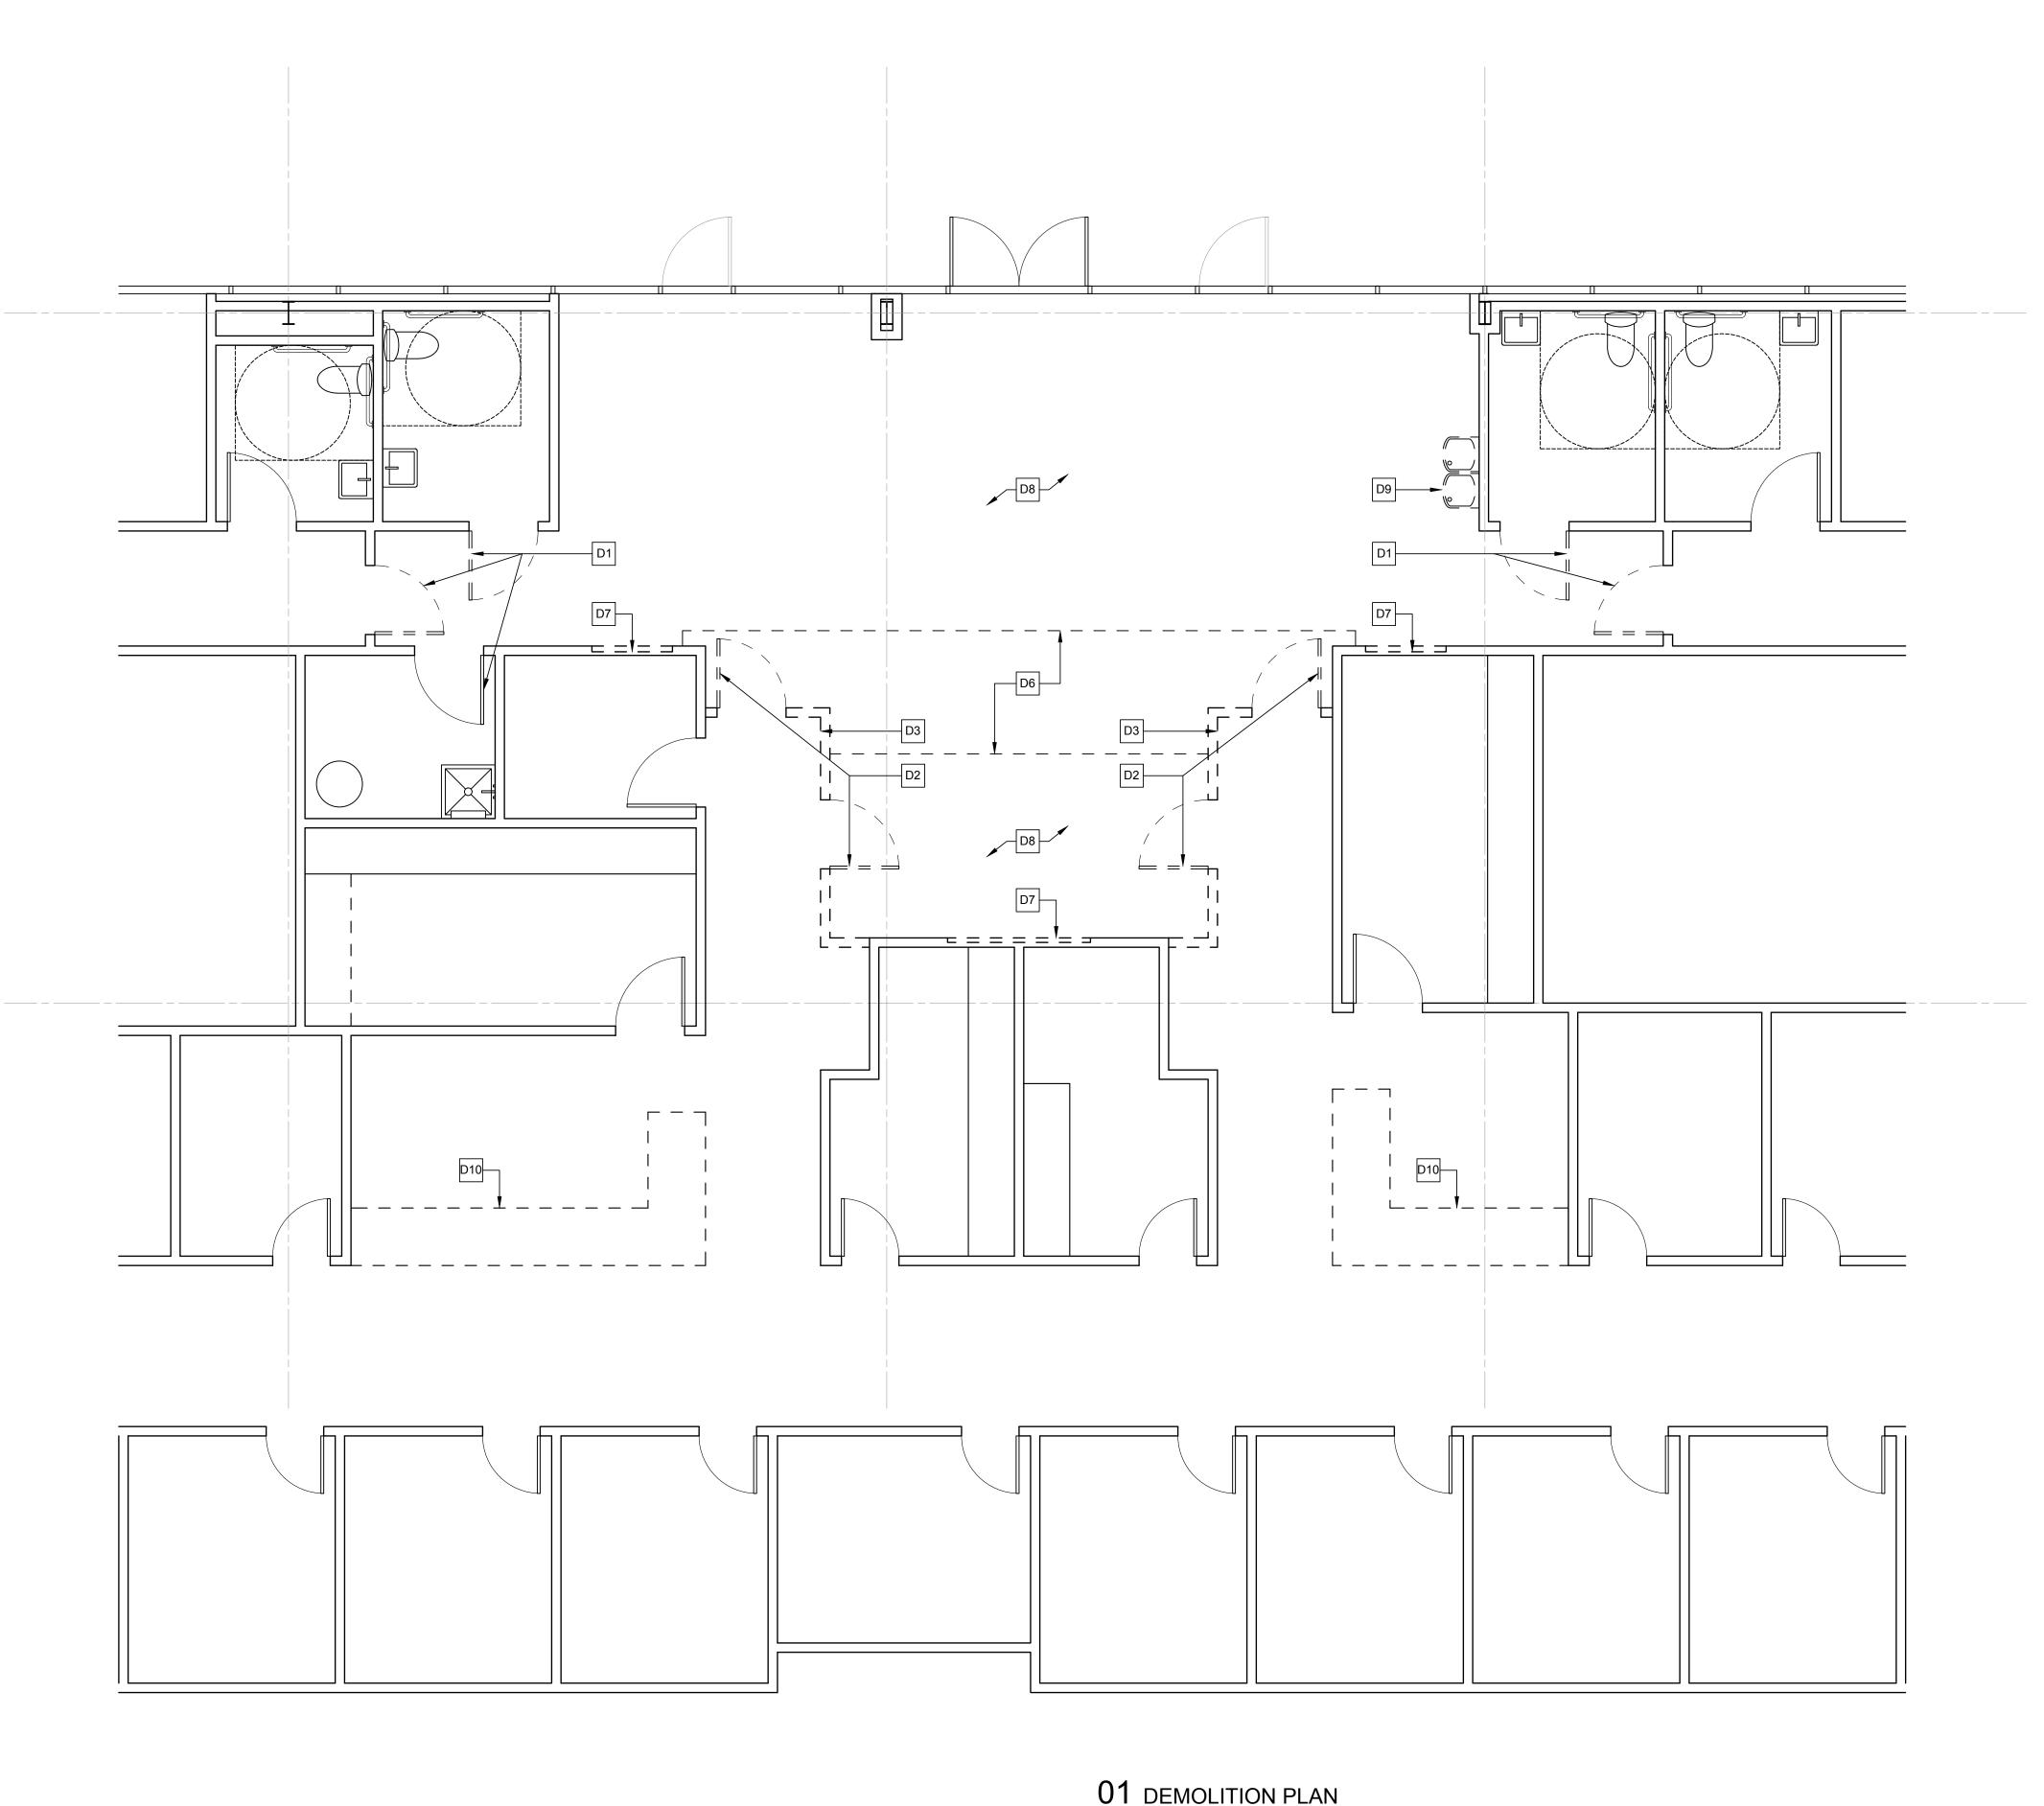

SCALE: 1/4"=1'-0"

0" 1'


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**DEMOLITION FLOOR PLAN** SCALE: 1/4"=1'-0"

2001 PROJECT NO. AD1.01 SHEET NO.

DATE




COSMETIC CENTER - REMODEL

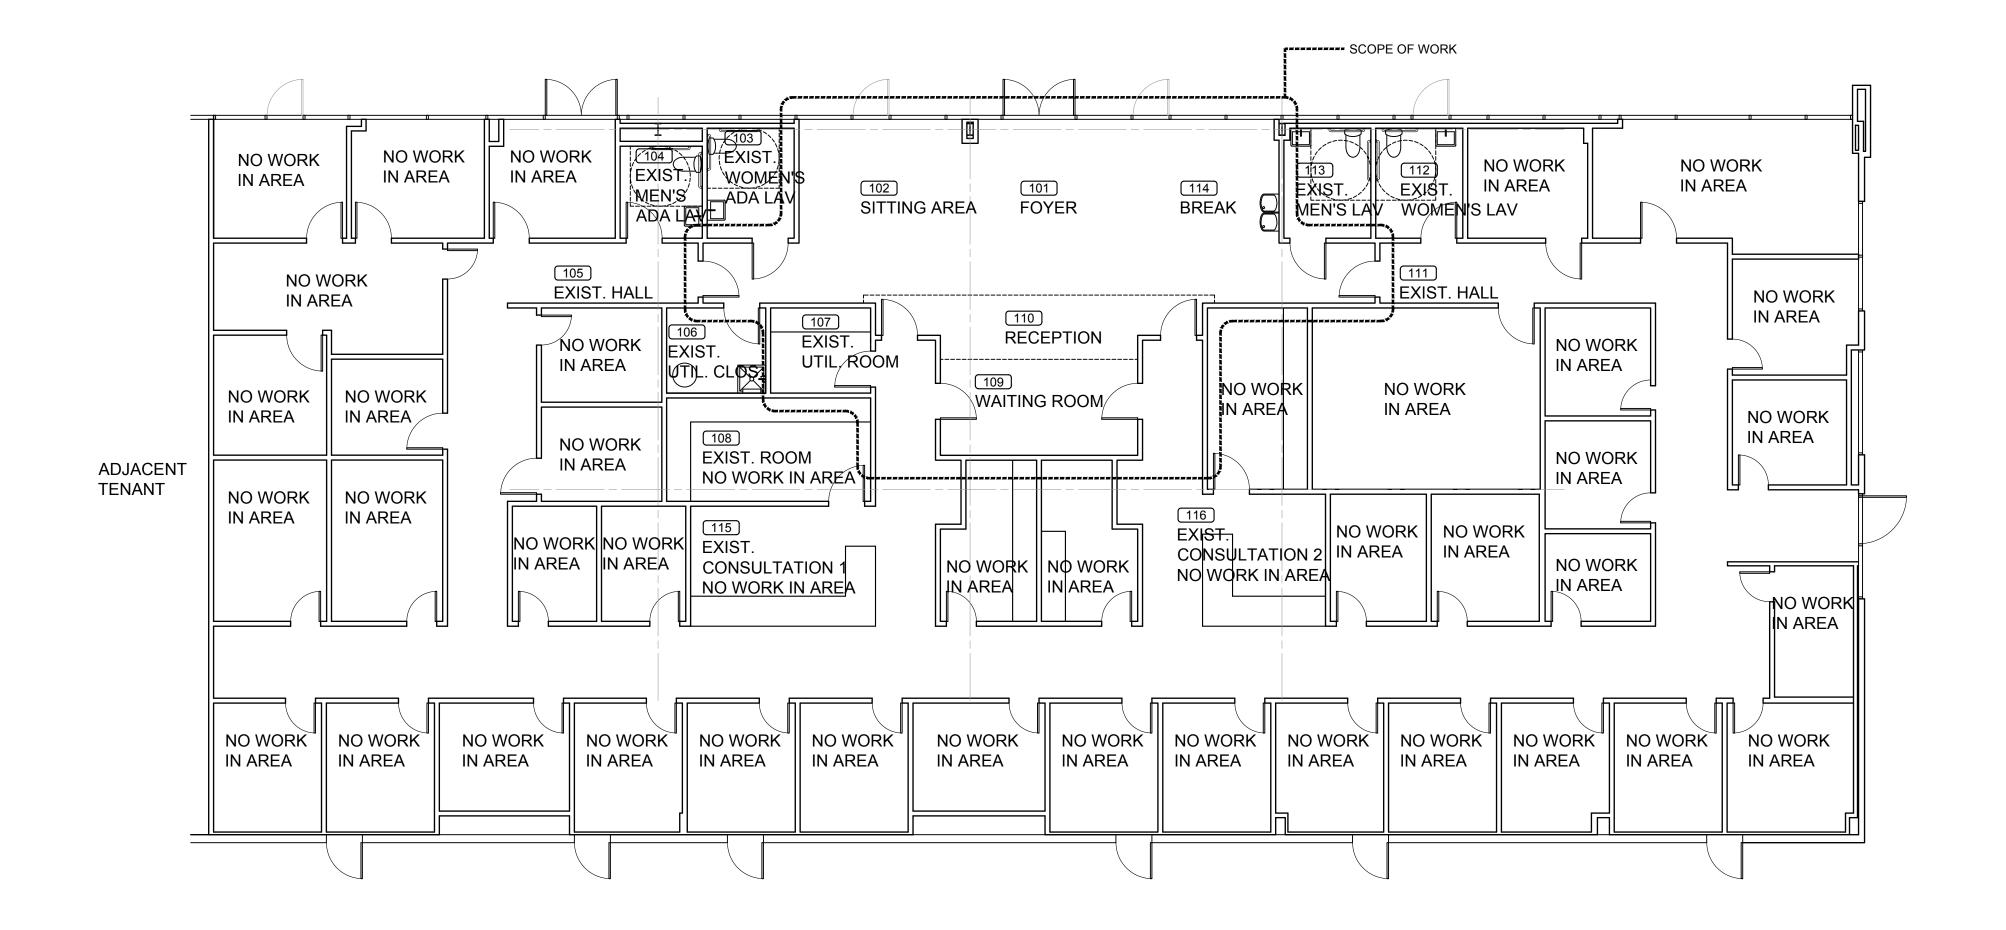
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SITE PLAN SCALE: 1/8" = 1'-0"





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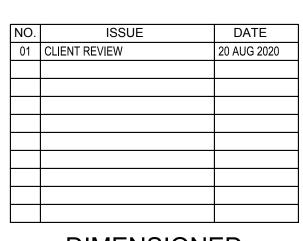
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COSMETIC CENTER - REMODEL
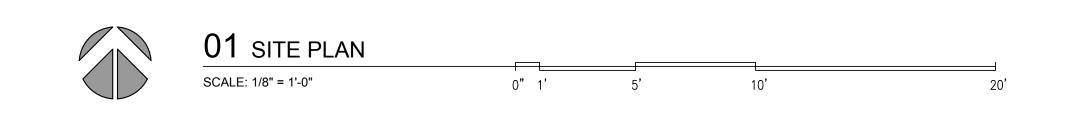
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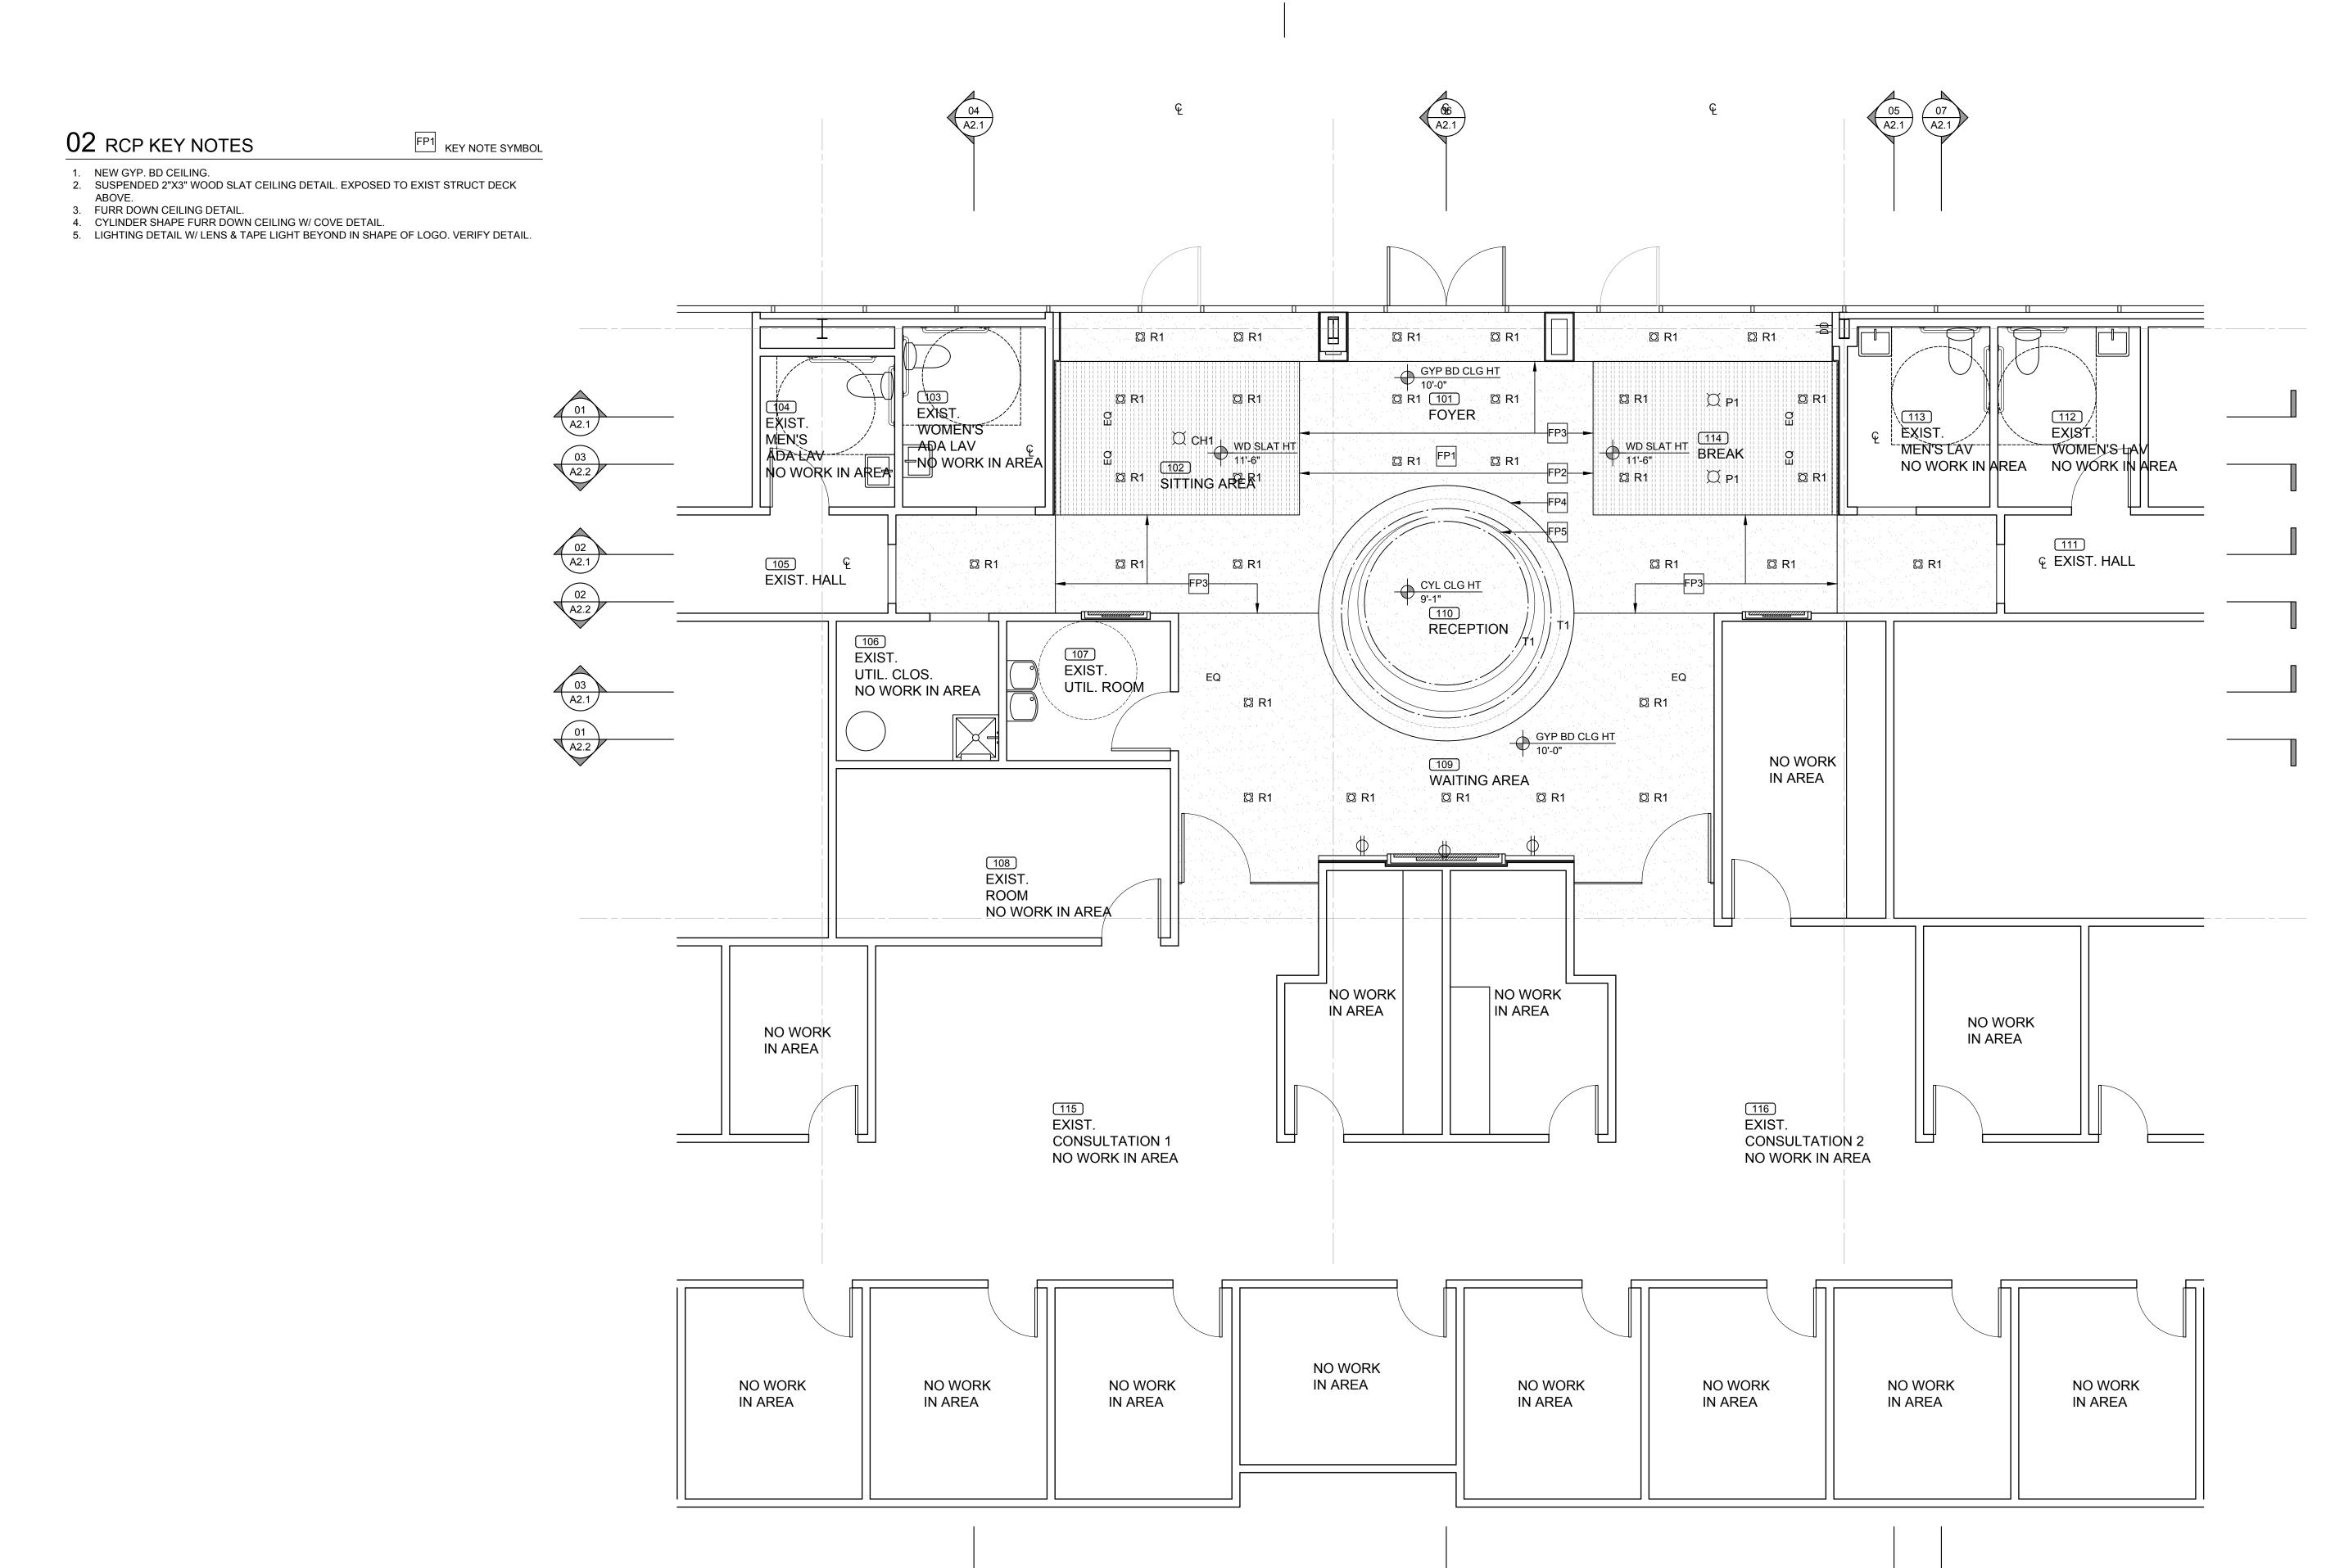
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DIMENSIONED
PROPOSED
FLOOR PLAN
SCALE: 1/4"=1'-0"

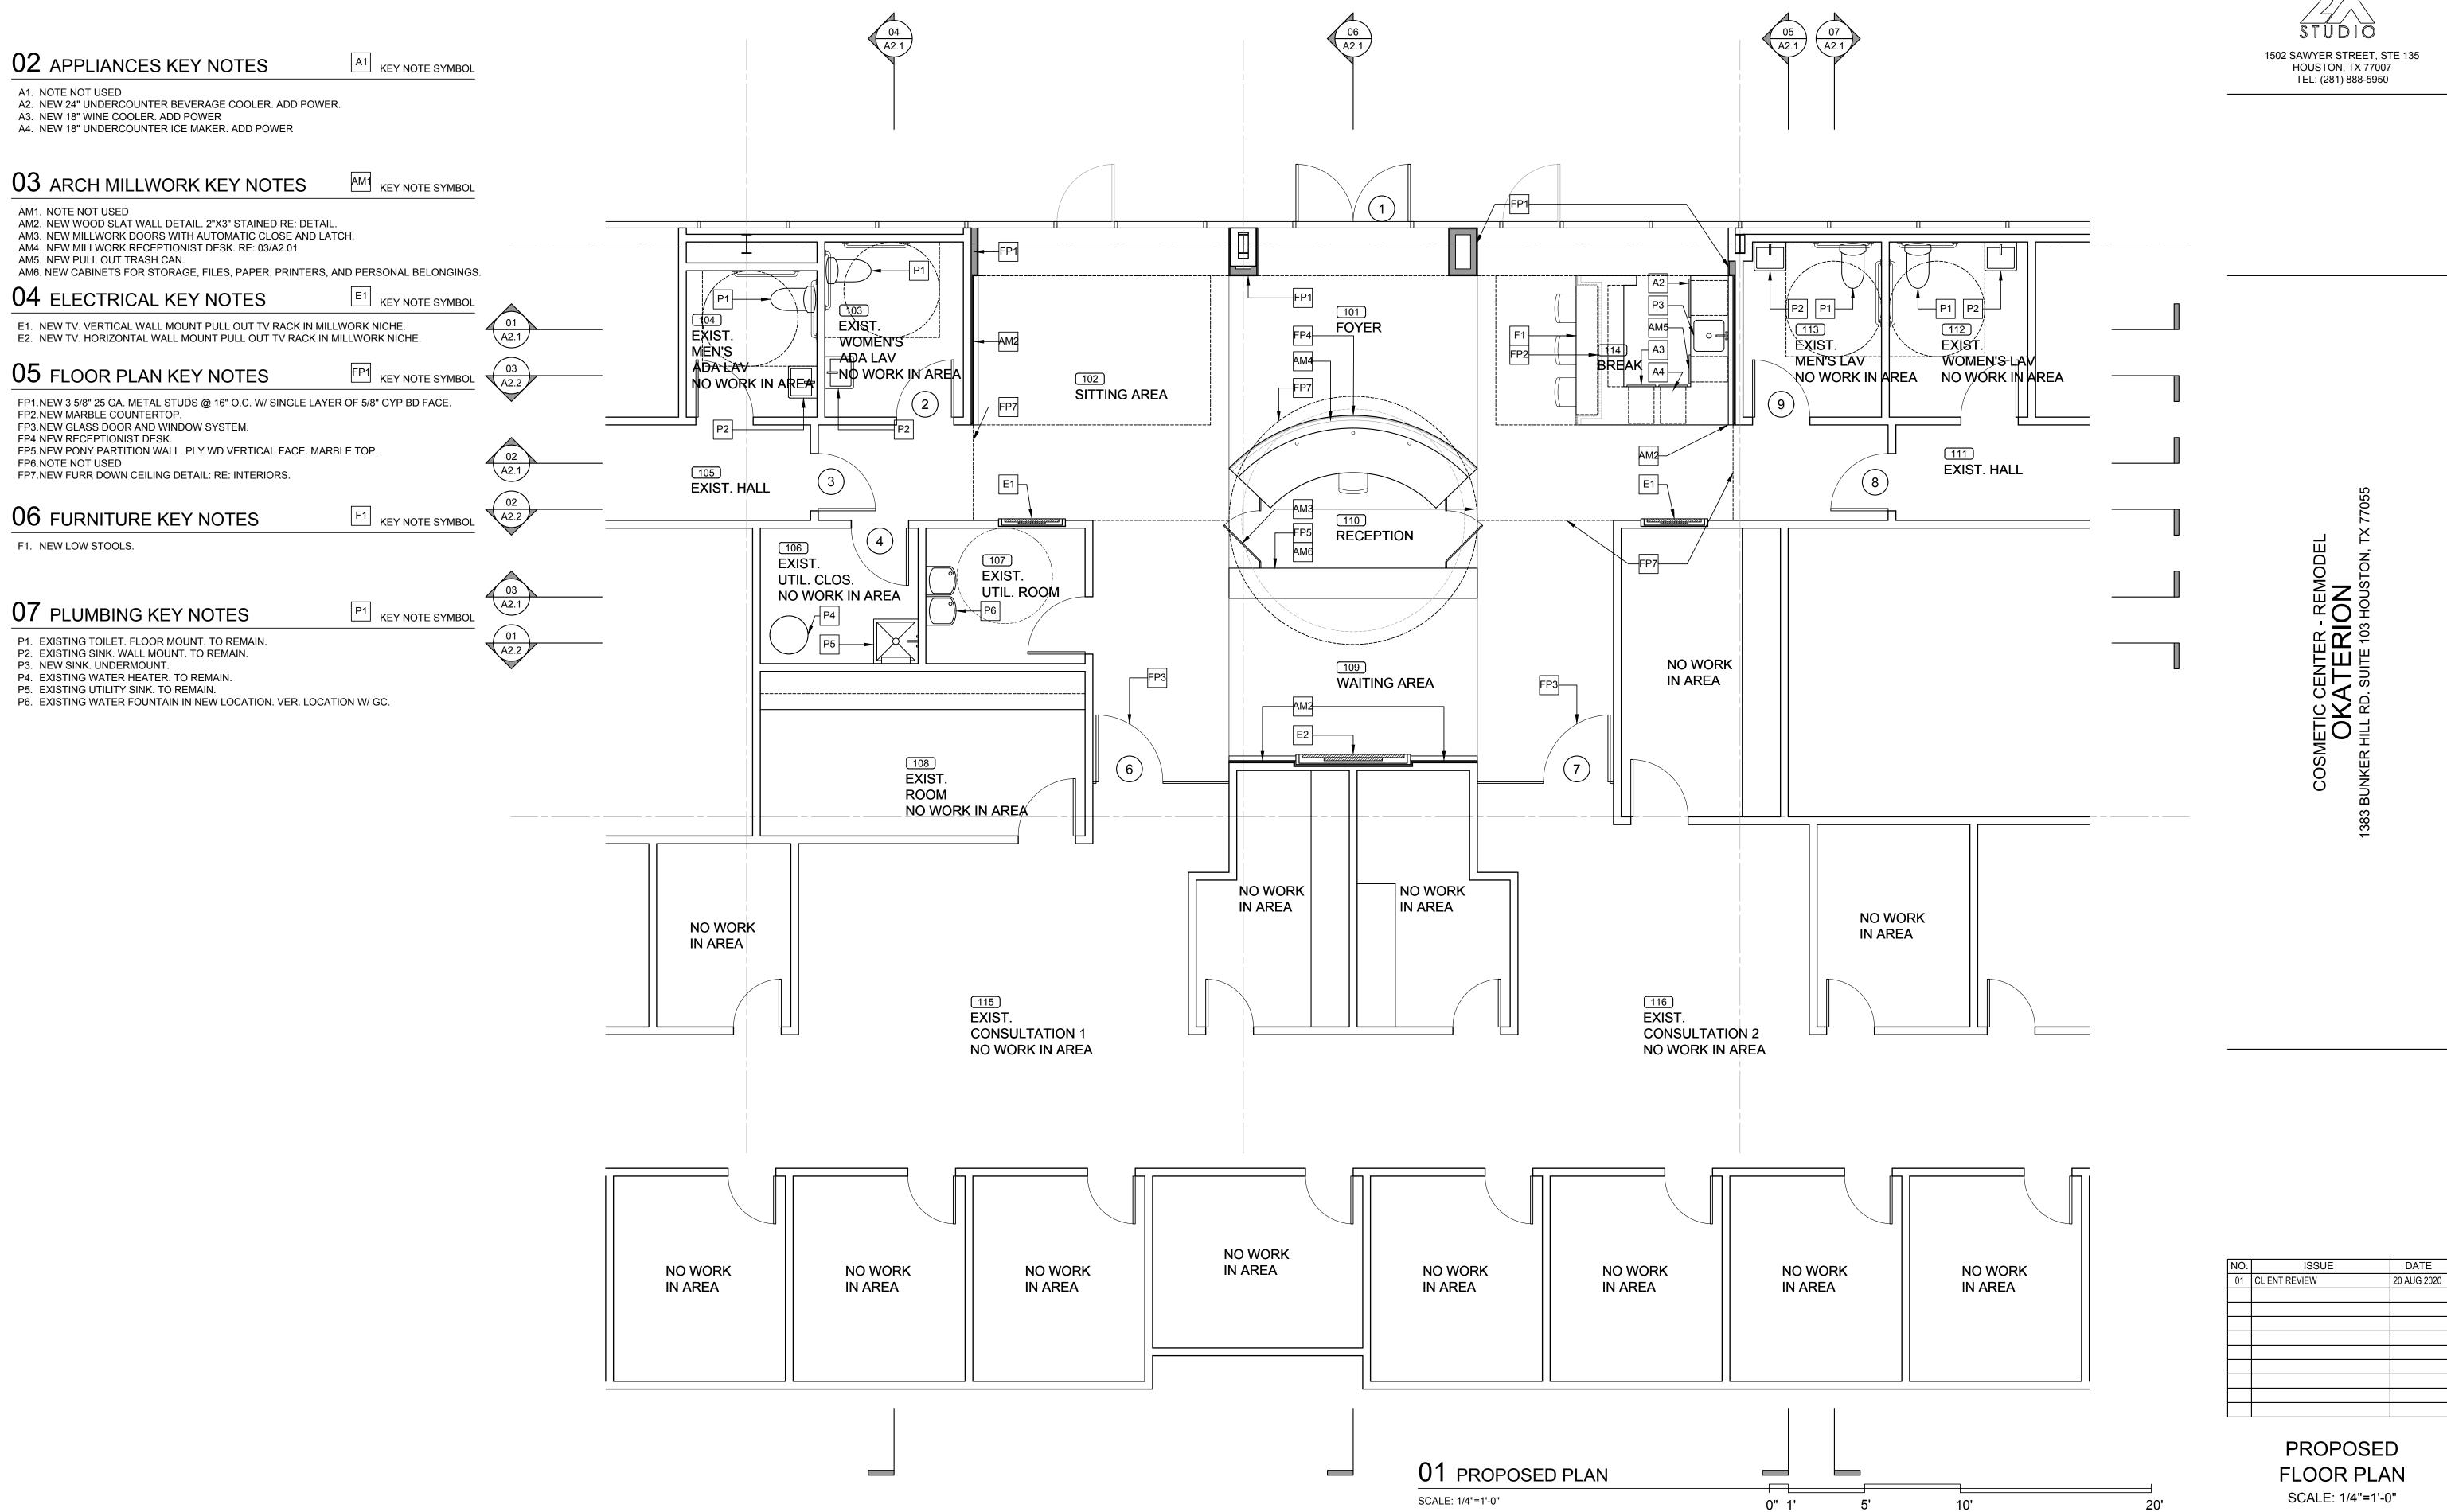**2001** PROJECT NO.

A1.02 SHEET NO.




01 PROPOSED RCP

SCALE: 1/4"=1'-0"

0" 1'

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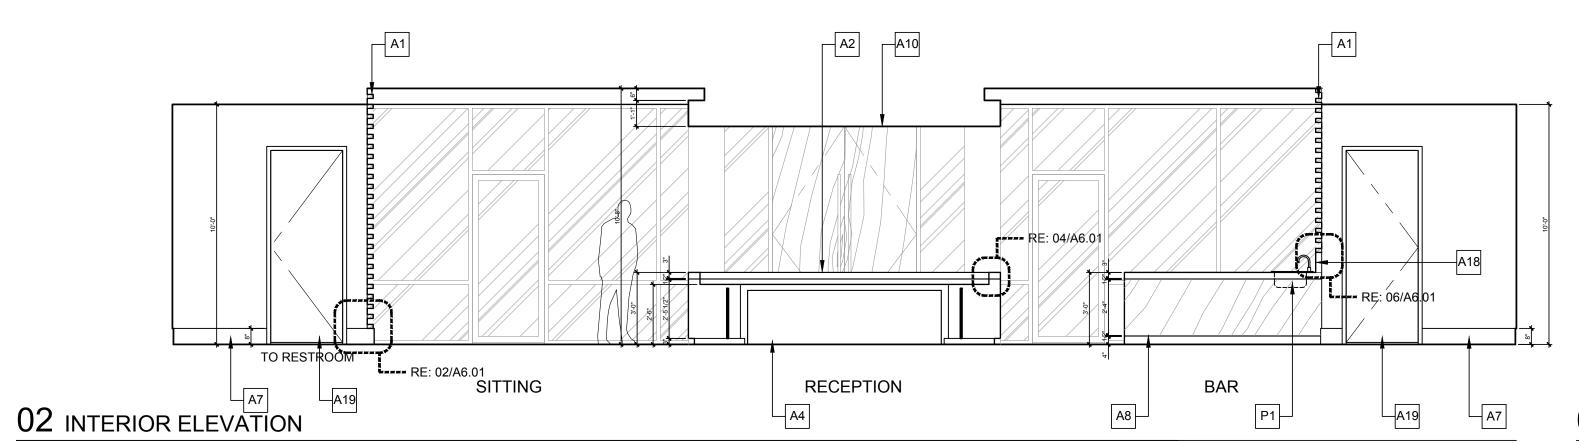


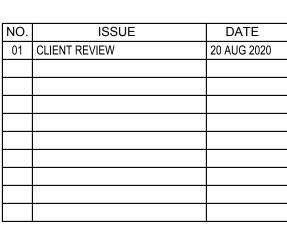PROPOSED RCP SCALE: 1/4"=1'-0"

A1.03 2001 PROJECT NO. SHEET NO.

A1 KEY NOTE SYMBOL E1 KEY NOTE SYMBOL 09 ELECTRICAL KEY NOTES E1. NEW TV. VERTICAL WALL MOUNT PULL OUT RACK IN MILLWORK NICHE. E2. NEW TV. HORIZONTAL WALL MOUNT PULL OUT RACK IN MILLWORK NICHE. 1/2" WD SLATS.

P1 KEY NOTE SYMBOL




KITCHENETTE WAITING


03 INTERIOR ELEVATION SCALE: 1/4" = 1'-0"

SCALE: 1/4" = 1'-0"


SCALE: 1/4" = 1'-0"

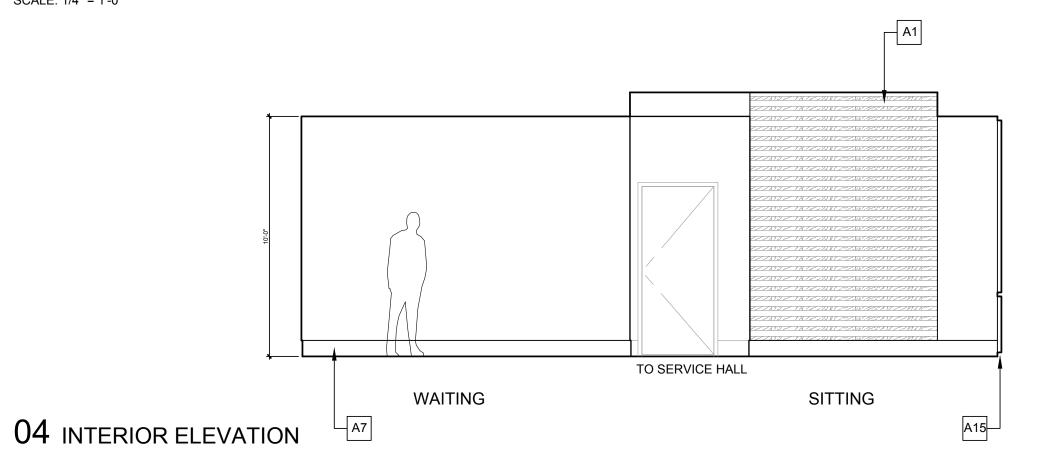

SCALE: 1/4" = 1'-0"

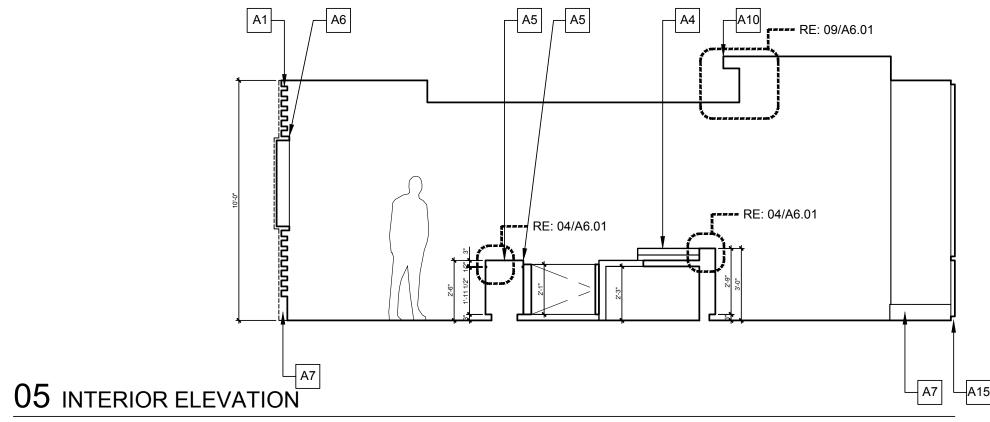


SCALE: 1/4" = 1'-0"

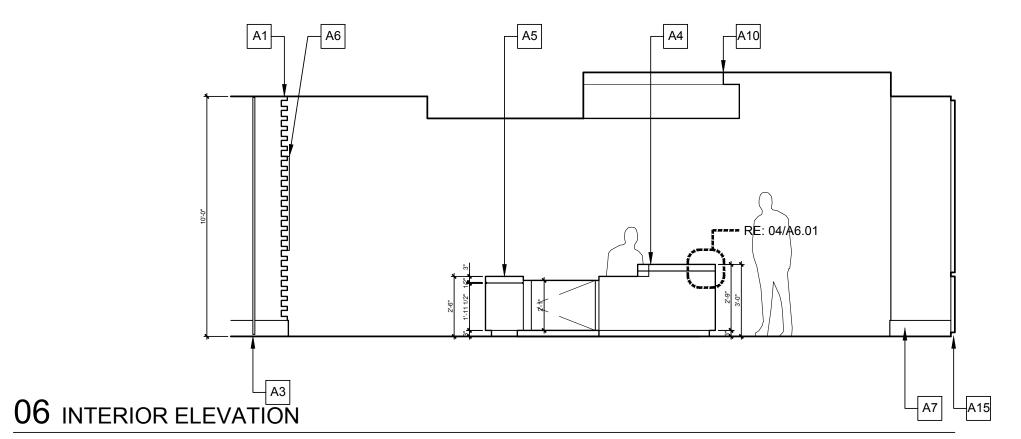


SCALE: 1/4" = 1'-0"

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SCALE: 1/4" = 1'-0"

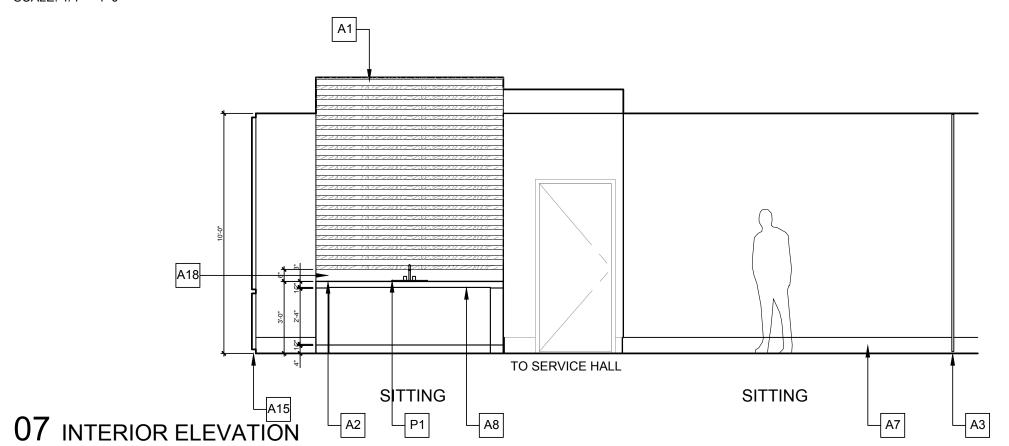



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PROPOSED INTERIOR **ELEVATIONS** SCALE: 1/4" = 1'-0"

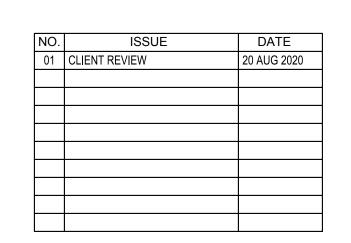2001 PROJECT NO. A2.01 SHEET NO.



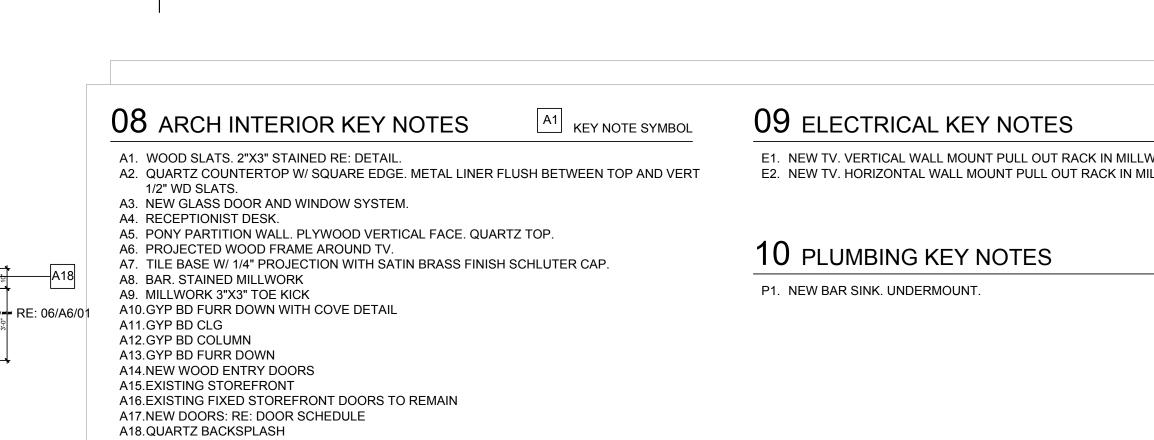

08 ARCH INTERIOR KEY NOTES

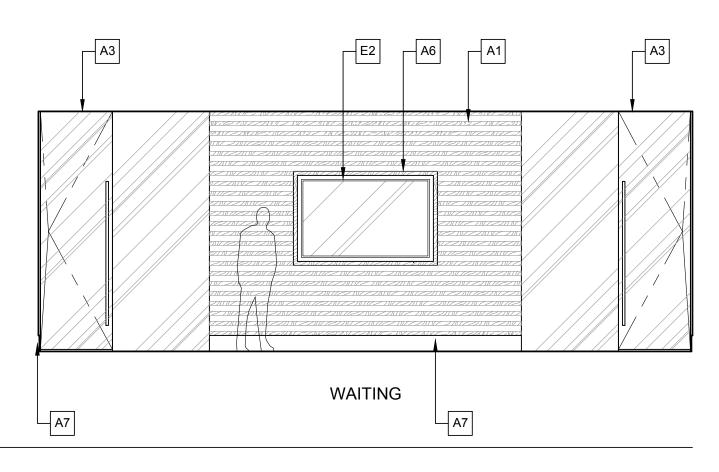A9. MILLWORK 3 X3 TOE KICK
A10.GYP BD FURR DOWN WITH COVE DETAIL
A11.GYP BD CLG
A12.GYP BD COLUMN
A13.GYP BD FURR DOWN
A14.NEW WOOD ENTRY DOORS

A16.EXISTING STOKET KONT
A16.EXISTING FIXED STOREFRONT DOORS TO REMAIN
A17.NEW DOORS: RE: DOOR SCHEDULE
A18.QUARTZ BACKSPLASH
A19.WOOD FRAMED DETAIL

A15.EXISTING STOREFRONT

A4. RECEPTIONIST DESK.
A5. PONY PARTITION WALL. PLYWOOD VERTICAL FACE. QUARTZ TOP.
A6. PROJECTED WOOD FRAME AROUND TV.
A7. TILE BASE W/ 1/4" PROJECTION WITH SATIN BRASS FINISH SCHLUTER CAP.
A8. BAR. STAINED MILLWORK
A9. MILLWORK 3"X3" TOE KICK

A1 KEY NOTE SYMBOL

09 ELECTRICAL KEY NOTES A1. WOOD SLATS. 2"X3" STAINED RE: DETAIL.

A2. QUARTZ COUNTERTOP W/ SQUARE EDGE. METAL LINER FLUSH BETWEEN TOP AND VERT 1/2" WD SLATS.

A3. NEW GLASS DOOR AND WINDOW SYSTEM. RE: DOOR SCHEDULE FOR DOOR HT OPTIONS.

A4. RECEPTIONIST DESK.

E1 KEY NOTE SYMBOL

E1. NEW TV. VERTICAL WALL MOUNT PULL OUT RACK IN MILLWORK NICHE. E2. NEW TV. HORIZONTAL WALL MOUNT PULL OUT RACK IN MILLWORK NICHE.


10 PLUMBING KEY NOTES

P1 KEY NOTE SYMBOL


P1. NEW BAR SINK. UNDERMOUNT.

01 INTERIOR ELEVATION

SCALE: 1/4" = 1'-0"

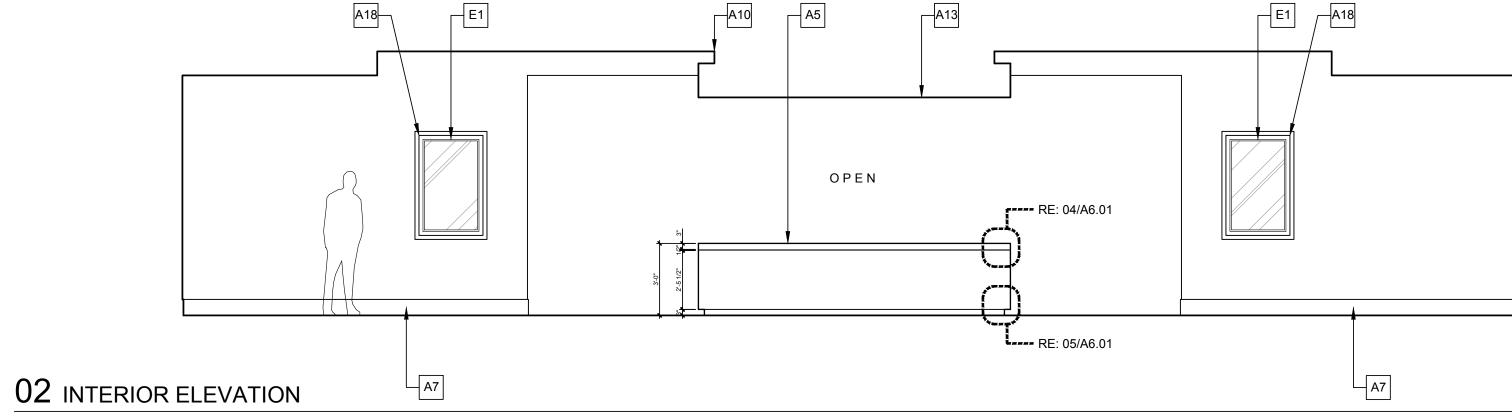

SCALE: 1/4" = 1'-0"

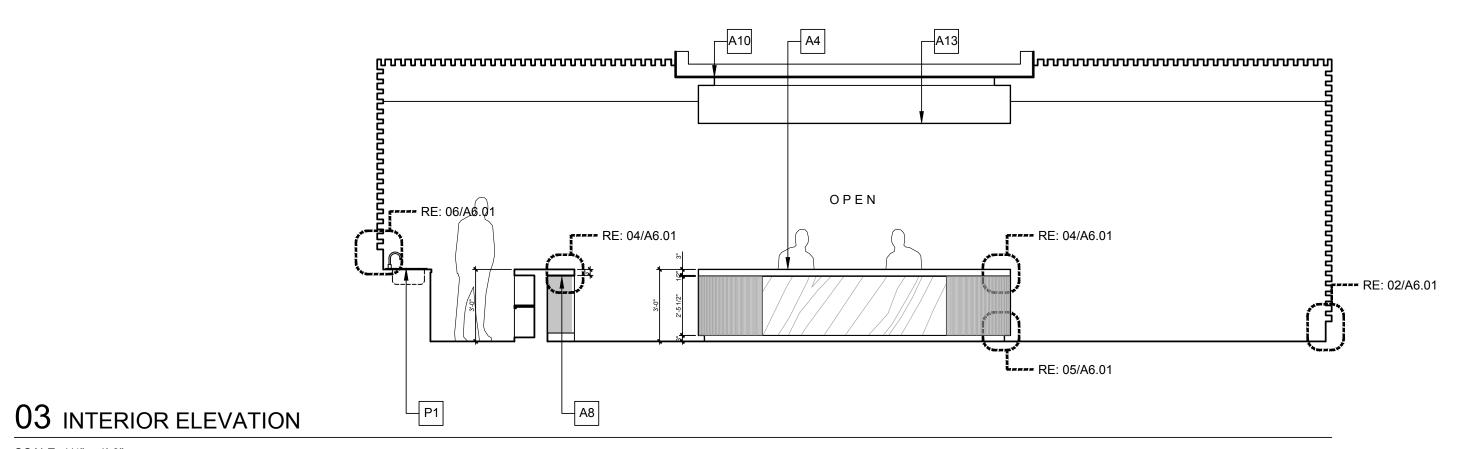

SCALE: 1/4" = 1'-0"

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PROPOSED INTERIOR **ELEVATIONS** 

SCALE: 1/4" = 1'-0"

A2.02 2001 PROJECT NO. SHEET NO.

# 1502 SAWYER STREET, STE 135 HOUSTON, TX 77007 TEL: (281) 888-5950

#### 02 BASE TYPE 'B2' @ WOOD SLAT WALL

SCALE: 3" = 1'-0"

6"

-5/8" OR 3/4" PLYWOOD FACE

— 2X3 WOOD SLATS, STAINED

SCHLUTER CAP
ANODIZED SATIN BRASS
SCHLUTER SCHIENE

—PORCELAIN TILE RE: SPEC FROM INTERIOR DESIGNER

-BLOCKING W/ HARDIE BACKER

PAINTED WHITE

FRAME LINE

-METAL FRAME


VER. SPEC

-MUD BED

-BLOCKING

PLYWOOD FACE ON CURVED SURFACE STAINED RE: CABINET MAKER -CABINET CURVE FRAME -PLYWOOD FACE TOE KICK PAINTED BLACK PER SPEC RE: CABINET MAKER -CABINET CURVE FRAME—

## 03 DETAIL NOT USED SCALE: NTS

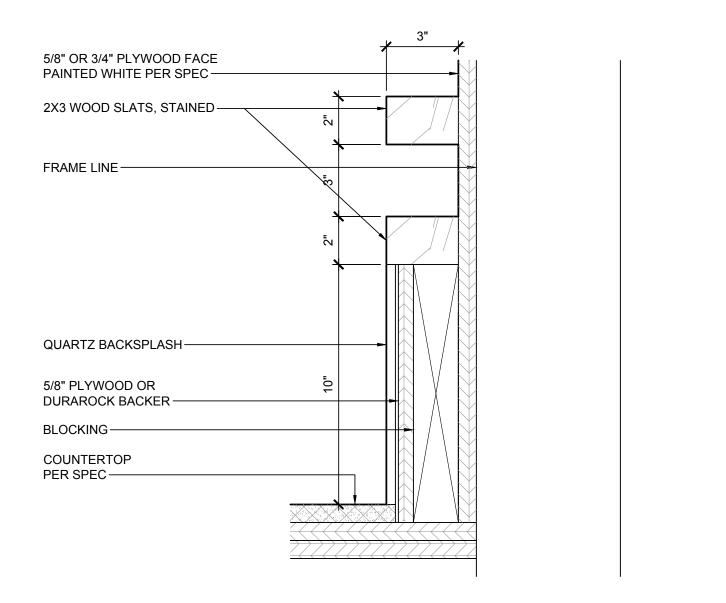


## 06 BACKSPLASH DETAIL @ BREAK COUNTERTOP

SCALE: 3" = 1'-0"


### 01 BASE TYPE 'B1' @ TYPICAL GYP WALL

SCALE: 3" = 1'-0"

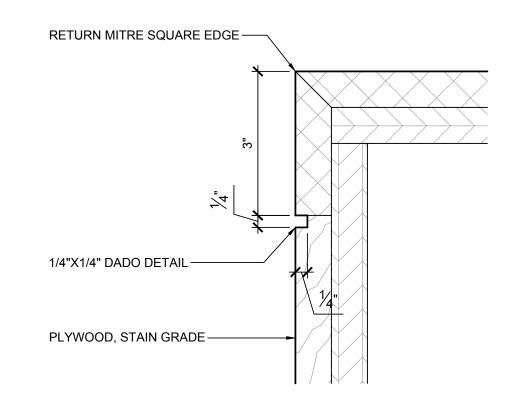


#### 04 COUNTERTOP EDGE DETAIL

SCALE: 1 1/2" = 1'-0"

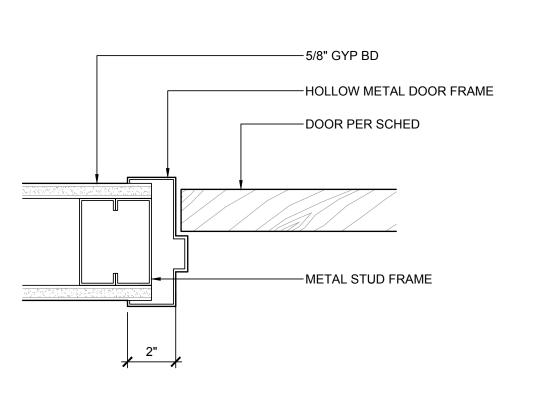

#### 07 DOOR JAMB DETAIL


SCALE: 1 1/2" = 1'-0"

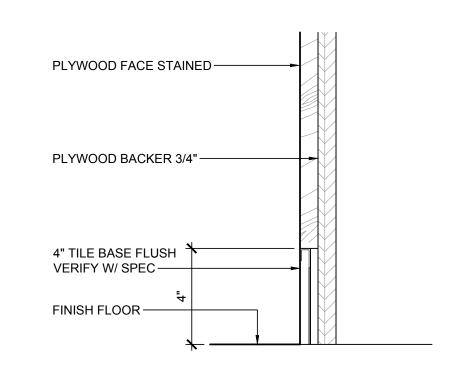

05 TOE KICK DETAIL @ RECEPTION DESK

## 08 BASE DETAIL @ BREAK CABINET

SCALE: 1 1/2" = 1'-0"

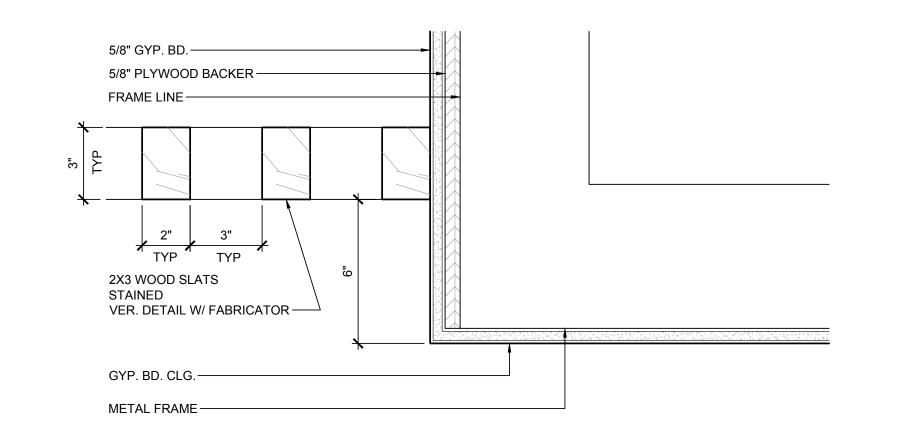

## 09 wood slat ceiling detail @ open plennum

SCALE: 1 1/2" = 1'-0"

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**INTERIOR DETAILS** SCALE: 3"=1'-0" (DETAILS VARY IN SCALE)


2001

A6.01 SHEET NO.

PROJECT NO.





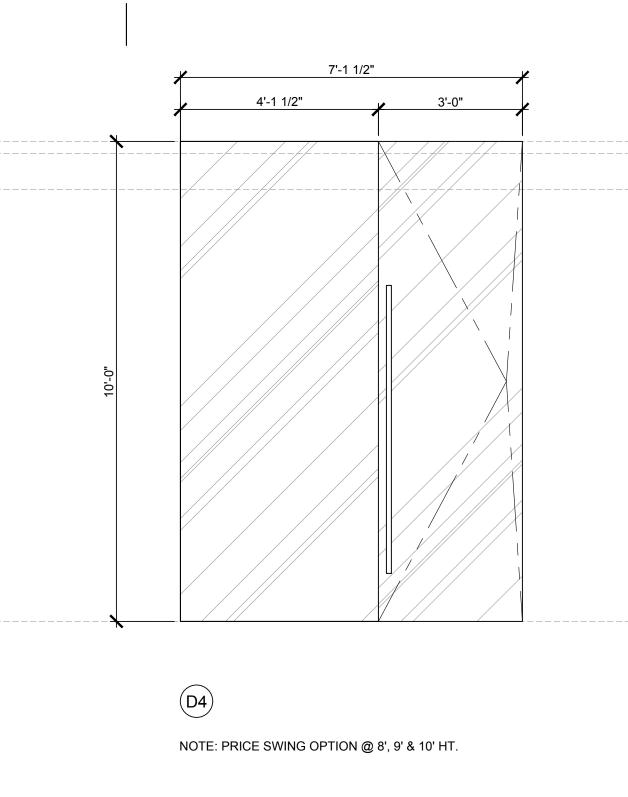

TYPE: EXT DBL SWING
MATERIAL: SOLID WD OR COMPOSITE W/ WD VINYL
MFR: TBD
MODEL & SPEC: TBD

MODEL & SPEC: TBD

O1 DOOR TYPE

SCALE: 1/2" = 1'-0"

D1)

TYPE: INT SWING MATERIAL: POLYCORE W/ LAMINATE MFR: TBD MODEL & SPEC: TBD

D2

TYPE: INT PIVOT OR SWING MATERIAL: TEMPERED GLASS MFR: TBD MODEL & SPEC: TBD

NOTE: PRICE SWING OPTION @ 8', 9' & 10' HT.

(D3)

7'-1 1/2"

4'-1 1/2"

TYPE: INT PIVOT OR SWING MATERIAL: TEMPERED GLASS MFR: TBD MODEL & SPEC: TBD

	DOOR SCHEDULE						
NO.	TYP.	SIZE	DESCRIPTION	LOCATION	HDWR	REMARKS	
1	D1	DOUBLE 3'-0" X 9'-0"	SOLID WD	FRONT ENTRY	H1		
2	D2	3'-0" X 8'-0"	POLYCORE W/ LAMINATE	WOMEN'S ADA LAV	H2		
3	D2	3'-0" X 8'-0"	POLYCORE W/ LAMINATE	HALL	H2		
4	D2	3'-0" X 8'-0"	POLYCORE W/ LAMINATE	LOUNGE	H2		
5		NOT USED					
6	D3	7'-1-1/2" X 10'-0"	TEMPERED GLASS	CONSULTATION ENTRY	H3		
7	D4	7'-1-1/2" X 10'-0"	TEMPERED GLASS	CONSULTATION ENTRY	H3		
8	D2	3'-0" X 8'-0"	POLYCORE W/ LAMINATE	HALL	H2		
9	D2	3'-0" X 8'-0"	POLYCORE W/ LAMINATE	MEN'S LAV	H2		

## 02 DOOR SCHEDULE

10'-0" 9-9"

SCALE: 1/2" = 1'-0"

	'H1' HARDWARE SCHEDULE					
QTY	EA/SET	DEVICE	PRODUCT	FINISH	MFG	
4	SET	HINGE		MATCH		
1	EA	CYLINDER LOCK				
2	EA	PUSH				
2	EA	PULL				
2	EA	GASKET				
2	EA	DOOR BOTTOM				
1	EA	THRESHOLD				
2	EA	CLOSURE				
ANO	ANODIZED BRASS HANDLE PULLS. VER. HANDLE SPEC					

#### 03 HARDWARE GROUP H1

SCALE: 1/2" = 1'-0"

	'H2' HARDWARE SCHEDULE					
QTY	EA/SET	DEVICE	PRODUCT	FINISH	MFG	
2	SET	HINGE		MATCH		
1	EA	PRIVACY SET				
3	EA	SILENCER				
1	EA	CLOSURE				
1	EA	STOP				

#### 04 HARDWARE GROUP H2

SCALE: 1/2" = 1'-0"

	'H3' HARDWARE SCHEDULE					
QTY	EA/SET	DEVICE	PRODUCT	FINISH	MFG	
1	SET	PIVOT OR HINGE		MATCH		
1	EA	CYLINDER LOCK				
2	EA	PULL				
1	EA	STOP				
WOO	WOOD HANDLE PULLS STAINED. VER. HANDLE SPEC					

### 05 HARDWARE GROUP H3

SCALE: 1/2" = 1'-0"

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DOOR SCHEDULE /
HARDWARE TYPES

SCALE: 1/2" = 1'-0"

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