# 11 FANEUIL STREET

BRIGHTON, MA 02135

SEPTEMBER 18, 2020 NOT FOR CONSTRUCTION

# **ABBREVIATIONS**

DIA.

DIM.

DWG.

EL. 🕁

ELEC.

EQ

F.O.

F.O.C.

ABOVE FINISHED FLOOR A.F.F. ACT ACOUSTICAL CEILING TILE ADA AMERICANS W/ DISABILITIES ACT APPROX. APPROXIMATE ARCH. ARCHITECTURAL **AUDIO VISUAL** BLDG. BUILDING BLKG. BLOCKING B.O. BOTTOM OF CABINET CAB.

C.H. CEILING HEIGHT CLEAR CLR. CENTERLINE COL. COLUMN CONT. CONTINUOUS CMU CONCRETE MASONRY UNIT C.J. CONTROL JOINT

> DIAMETER DIMENSION DRAWING existing ELEVATION ELECTRICAL EQUAL FLOOR DRAIN FACE OF FACE OF CONCRETE

F.O.S. FACE OF STUD **GFIC** GROUND FAULT INTERCEPTOR CIRCUIT GSM. GALVANIZED SHEET METAL GWB GYPSUM WALL BOARD HEATING, VENTILATING, AND AIR CONDITIONING H OR HVAC

FACE OF FINISH

H.B. HOSE BIB HOLLOW METAL HM MAX. MAXIMUM M.O. MASONRY OPENING

MECH. MECHANICAL MEP MECHANICAL ELECTRICAL PLUMBING MIN. MINIMUM MISC. MISCELLANEOUS METAL MTL.


NOT IN CONTRACT N.I.C. NO. NUMBER N.T.S. NOT TO SCALE 0/ **OVER** O.C. ON CENTER O.D. OUTSIDE DIAMETER OPNG. **OPENING** OPP. **OPPOSITE** P.G. PAINT GRADE PLYWD. PLYWOOD PTD. PAINTED R.D. ROOF DRAIN REQ'D. REQUIRED ROUGH OPENING

R.O. SCHED. SCHEDULE S.G. STAIN GRADE SIM. SEE LANDSCAPE DRAWINGS S.L.D. SQ. SQUARE SPECIFICATION

SPEC. S.S.D. SEE STRUCTURAL DRAWINGS SSTL. STAINLESS STEEL STL. STEEL STOR. STORAGE STRUCTURAL STRUCT. SYM. SYMMETRICAL TEMPERED T&G TONGUE AND GROOVE THK. T.O. TOP OF

T.S. TUBULAR STEEL TYP. TYPICAL U.O.N UNLESS OTHERWISE NOTED VERIFY IN FIELD V.I.F. W/

W/O WITHOUT WD. WOOD WPM. WATERPROOFING MEMBRANE **SYMBOLS** 

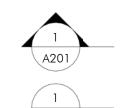

REFERENCE NUMBER DRAWING DRAWING SHEET


REFERENCE NUMBER

DRAWING SHEET

NORTH ARROW

**REVISION TAG** 


INTERIOR ELEVATION

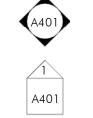

REFERENCE NUMBER **EXTERIOR ELEVATION** DRAWING SHEET



DOOR TAG WALL TYPE TAG APPLIANCE TAG

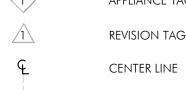

REFERENCE NUMBER **BUILDING SECTION** Drawing sheet REFERENCE NUMBER DRAWING SHEET



# VICINITY MAP



# PROJECT DATA

11 FANEUIL STREET PROJECT ADDRESS: PARCEL 2202607000

ZONING DISTRICT: ALLSTON/BRIGHTON NEIGHBORHOOD ZONING SUBDISTRICT: NS-.5

SUBDISTRICT TYPE: NEIGHBORHOOD SHOPPING (NS)

ARTICLE 51 - TABLE B: NEIGHBORHOOD BUSINESS SUBDISTRICTS AND LOCAL INDUSTRIAL SUBDISTRICTS - USE REGULATIONS

RESIDENTIAL USES INCLUDING MULTI-FAMILY RESIDENDIAL LISTED AS 'CONDITIONAL' USE IN NEIGHBORHOOD SHOPPING PROJECT DESCRIPTION:

NEW CONSTRUCTION OF A MULTI-FAMILY RESIDENTIAL BUILDING WITH FORTY TWO (42) DWELLING UNITS AND FIFTY ONE (51) PARKING

THE PROPOSED STRUCTURE IS 4 STORIES+ROOF ACCESS ABOVE GRADE USE GROUP: **R2** 

CONSTRUCTION TYPE: TYPE-1A (LEVEL 1) TYPE-5A (LEVEL 2 THROUGH LEVEL 4)

# **ZONING REVIEW**

ALLOWABLE/REQ'D	PROPOSED	COMPLIANCE
MFR CONDITIONAL	MFR	NO
NONE	19,530 SF	YES
NONE	100'	YES
NONE	100'	YES
0.5	2.13	NO
35'-0"	64'-0"	NO
2,100 SF / 50 SF PER UNIT	7,755 SF / 184 SF PER UNIT	YES
NONE	6'-0"	YES
NONE (R), 12'-0" (L)	6'-0" (R), 17'-0" (L)	YES/YES
20'-0"	4"	NO
2.0 PER D.U. (82 SPACES)	1.21 PER D.U. (51 SPACES)	NO
	MFR CONDITIONAL NONE  NONE NONE 0.5 35'-0"  2,100 SF / 50 SF PER UNIT  NONE NONE NONE (R), 12'-0" (L) 20'-0"	MFR CONDITIONAL NONE 19,530 SF  NONE 100' 0.5 2.13 35'-0" 64'-0"  2,100 SF / 50 SF PER UNIT 7,755 SF / 184 SF PER UNIT  NONE NONE (R), 12'-0" (L) 6'-0" (R), 17'-0" (L) 4"

GROSS SQUARE FOOTAGE			
GROUND FLOOR SECOND FLOOR THIRD FLOOR FOURTH FLOOR	3,460 13,445 13,340 11,280		
TOTAL	41,525		

A000

SHEET LIST

UTILITY SITE PLAN - EXISTING UTILITY SITE PLAN - PROPOSED

# ARCHITECTURAL

CODE REVIEW A002 EGRESS PLANS A101 FIRST FLOOR PLAN A102 A103 SECOND FLOOR PLAN THIRD FLOOR PLAN A104 FOURTH FLOOR PLAN A105 FIFTH FLOOR PLAN **ROOF PLAN** A106 A200 **ELEVATIONS ELEVATIONS** 

| ARCHITECT

BOSTON, MA 02127 O: 617.766.8330

OWNER

CITY REALTY 320 WASHINGTON ST BROOKLINE, MA 02445

www.embarcstudio.com

CONSULTANTS

BOSTON SURVEY INC. UNIT C-4 SHIPWAY PLACE CHARLESTOWN MA, 02129

STREE<sup>-</sup> ш Z

**NSTRUCTION** 

REVISIONS

MARK ISSUE DATE

# DRAWING INFORMATION

ISSUE: NOT FOR CONSTRUCTION DATE: SEPTEMBER 18, 2020 PROJECT #: 17052

DRAWING TITLE

COVER

SCALE: As indicated

**BOSTON UTILITY SITE PLAN** I CERTIFY THAT THIS PLAN WAS MADE FROM AN INSTRUMENT SURVEY ON THE GROUND ON THE BETWEEN THE DATES OF JULY 5-6, 2017 AND SURVEY, INC. ALL STRUCTURES ARE LOCATED AS SHOWN HEREON. **LOCATED AT UNIT C-4 SHIPWAY PLACE** ABUTTERS' NAMES REFER TO CURRENT CITY OF BOSTON ASSESSOR'S 11 FANEUIL STREET CHARLESTOWN, MA 02129 RECORDS AND/OR CURRENT RECORDS AVAILABLE AT THE REGISTRY OF (617) 242-1313 BRIGHTON, MA **VERTICAL DATUM** SCALE: 1.0 INCH = 20.0 FEET THE ELEVATIONS SHOWN ON THIS PLAN ARE RELATIVE TO BOSTON CITY BASE AND WERE DETERMINED FROM AN INVERT ELEVATION PROVIDED BY BOSTON WATER AND SEWER COMMISSION. BENCHMARK MAG SET IN FOUNDATION; ELEVATION = 34.78' (BOSTON CITY BASE) OPEN BOLT OF HYDRANT; ELEVATION = 34.61' (BOSTON CITY BASE) MAG SET IN UTILITY POLE; ELEVATION = 33.82' (BOSTON CITY BASE) UNDERGROUND UTILITIES ARE BASED UPON AN ACTUAL FIELD SURVEY AND INFORMATION OF RECORD. IT IS NOT WARRANTED THAT THEY ARE EXACTLY LOCATED, NOR THAT ALL UNDERGROUND CONDUITS OR NO. 236 NORTH BEACON STREET N/F DAVID R. ANDELMAN & JOHN M. REED BK 475; PG 199 OTHER STRUCTURES ARE SHOWN ON THIS PLAN. IT IS THE CONTRACTOR'S RESPONSIBILITY TO NOTIFY DIG SAFE PRIOR TO ANY **EXCAVATIONS.** + 34.46 + 36.77 ACCORDING TO THE FEDERAL EMERGENCY MANAGEMENT AGENCY + 36.89 (F.E.M.A.) MAPS, THE MAJOR IMPROVEMENTS ON THIS PROPERTY <u>BENCHMARK:</u> MAG NAIL SET IN FOUNDATION FALL IN AN AREA DESIGNATED AS ELEV = 34.78'COMMUNITY PANEL: 25025C 0057G (BOSTON CITY BASE) EFFECTIVE DATE: SEPTEMBER 25, 2009 No. 240 NORTH BEACON STREET N/F U-HAUL REAL ESTATE COMPANY BK 512; PG 87 159.46 N65°06'19"W PREPARED FOR: CITY REAL ESTATE DEVELOPMENT CORP. 320 WASHINGTON STRET SUITE 3FF BROOKLINE, MA 02445 +33.02 + 32.90 **REFERENCES:** + 32.85 +32.90 LOTS 2 & 3 & LOT 8 AREA = 19,530 SF ±  $\begin{array}{ccc}
DMH \\
RIM &= 33.13'
\end{array}$ OWNER OF RECORD: WE CLOSE THE DEAL, LLC INV = 25.70' $\frac{DMH}{RIM} = 27.24$ INV = 15.111 FANEUIL STREET BRIGHTON, MA 02135 \_\_\_\_\_\_ DEED: C. 134355 20.0' WIDE SEWER EASEMENT LEGEND LCC: 16884-D 16884-C BOUND □ 12262-A BENCHMARK 🕀 20.0' WIDE SEWER EASEMENT CITY OF BOSTON ENGINEERING RECORDS: GAS VALVE 32.39 WOOD FENCE L-7866 FANEUIL STREET HYDRANT 💢 L-7867 FANEUIL STREET WATER SHUTOFF  $\frac{SMH}{RIM} = 32.66'$ INV = 24.5'WATER VALVE 54.87' N62°20'04"W CATCH BASIN 1 STORY + 32.91 DRAIN MANHOLE 1ST FLOOR ELEV. = 33.46' No. 27 FANEUIL STREET N/F TWENTY SEVEN LLC BK 642; PG 198 SEWER MANHOLE  $ROOF\ HEIGHT = 48.4'$ PARCEL ID: ELECTRIC MANHOLE No. 235 MARKET STREET 2202607000 N/F B & D MARKET STREET, LLC BK 653; PG 138 TELEPHONE MANHOLE SIGN — RIM = 32.60'UTILITY POLE 💠 CONCRETE PAD BOLLARD O DRAIN LINE No. 19-21 FANEUIL STREET N/F
ISMAIL CHOWDHURY
BK 561; PG 99 SEWER LINE WATER LINE BENCHMARK:

MAG NAIL SET

IN UTILITY POLE

ELEV = 33.82'
(BOSTON CITY BASE) + 32.25 + 32.30 WOOD FENCE INVERT FOUND N62°33′52″W 25.28′ CONCRETE BOUND CB N62°33'52"W 69.88' N62°33'52"W 178.21' STONE BOUND SB N62°33'52"W  $0 - \frac{DMH}{RIM} = \frac{132.24}{1NV} = \frac{1}{25.9}$ GRANITE CURE 12" DRAIN INV = 25.9' RIM = 33.21' INV = 22.7'FANEUIL STREET 8" CI L.P. 1929 — GAS (PUBLIC ~ 50.0' WIDE) 32.64 32.62 32.67 32.65 32.66 32.70 32.84 32.82 15" SEWER 32.90 33.10 33.42 S SL 12" PCI 1885 (2000) SMH RIM = 33.54' 32.63 GRANITE CURB 32.90 INV = 25.6' SL 12" PCI 1885 (2000)  $\frac{SMH}{RIM = 32.60'}$ INV = 25.6' 32 INV = 21.8'2.28, GRANITE CURB, 32.32  $\begin{array}{c}
DMH \\
RIM = 32.37' \\
INV = NA
\end{array}$ <u>BENCHMARK:</u> OPEN BOLT OF HYDRANT ELEV = 34.61' (BOSTON CITY BASE) FIELD: DRAFT: JJH/SAP CHECK:

DATE: 07/05/17
JOB # 17-00415

**BOSTON UTILITY SITE PLAN** I CERTIFY THAT THIS PLAN WAS MADE FROM AN INSTRUMENT SURVEY ON THE GROUND ON THE BETWEEN THE DATES OF JULY 5-6, 2017 AND SURVEY, INC. ALL STRUCTURES ARE LOCATED AS SHOWN HEREON. **LOCATED AT UNIT C-4 SHIPWAY PLACE** ABUTTERS' NAMES REFER TO CURRENT CITY OF BOSTON ASSESSOR'S 11 FANEUIL STREET CHARLESTOWN, MA 02129 RECORDS AND/OR CURRENT RECORDS AVAILABLE AT THE REGISTRY OF (617) 242-1313 BRIGHTON, MA **VERTICAL DATUM** SCALE: 1.0 INCH = 20.0 FEET THE ELEVATIONS SHOWN ON THIS PLAN ARE RELATIVE TO BOSTON CITY BASE AND WERE DETERMINED FROM AN INVERT ELEVATION PROVIDED BY BOSTON WATER AND SEWER COMMISSION. BENCHMARK MAG SET IN FOUNDATION; ELEVATION = 34.78' (BOSTON CITY BASE) OPEN BOLT OF HYDRANT; ELEVATION = 34.61' (BOSTON CITY BASE) MAG SET IN UTILITY POLE; ELEVATION = 33.82' (BOSTON CITY BASE) UNDERGROUND UTILITIES ARE BASED UPON AN ACTUAL FIELD SURVEY AND INFORMATION OF RECORD. IT IS NOT WARRANTED THAT THEY ARE EXACTLY LOCATED, NOR THAT ALL UNDERGROUND CONDUITS OR NO. 236 NORTH BEACON STREET N/F DAVID R. ANDELMAN & JOHN M. REED BK 475; PG 199 OTHER STRUCTURES ARE SHOWN ON THIS PLAN. IT IS THE CONTRACTOR'S RESPONSIBILITY TO NOTIFY DIG SAFE PRIOR TO ANY **EXCAVATIONS.** + 34.46 + 36.77 ACCORDING TO THE FEDERAL EMERGENCY MANAGEMENT AGENCY + 36.89 (F.E.M.A.) MAPS, THE MAJOR IMPROVEMENTS ON THIS PROPERTY FALL IN AN AREA DESIGNATED AS <u>BENCHMARK:</u> MAG NAIL SET IN FOUNDATION COMMUNITY PANEL: 25025C 0057G ™ N65°06'19"W ELEV = 34.78'EFFECTIVE DATE: SEPTEMBER 25, 2009 No. 240 NORTH BEACON STREET \*(BOSTON CITY BASE) 159.46 N/F U-HAUL REAL ESTATE COMPANY BK 512; PG 87 6.5 PREPARED FOR: CITY REAL ESTATE DEVELOPMENT CORP. 320 WASHINGTON STRET SUITE 3FF BROOKLINE, MA 02445 +33.02 PROPOSED **REFERENCES:** + 32.88  $\frac{DMH}{RIM = 33.13'}$ 5 STORY OWNER OF RECORD: LOTS 2, 3 & LOT 8 WE CLOSE THE DEAL, LLC DWELLING INV = 25.70' $\frac{DMH}{RIM = 27.24}$ AREA 19,530±SF 11 FANEUIL STREET BRIGHTON, MA 02135 . – - – – – – – – – – – – – – – – – . DEED: C. 134355 20.0' WIDE SEWER EASEMENT LEGEND LCC: 16884-D 16884-C BOUND □ 12262-A 32.54 20.0' WIDE SEWER EASEMENT 20.0' WIDE SEWER EASEMENT BENCHMARK - \$\frac{1}{27.4}\text{ninianunc} \frac{\pi}{33.39} CITY OF BOSTON ENGINEERING RECORDS: +32.37 - 16.4' GAS VALVE L-7866 FANEUIL STREET HYDRANT 💢 L-7867 FANEUIL STREET WATER SHUTOFF  $\frac{SMH}{RIM} = 32.66'$ INV = 24.5'WATER VALVE 54.87**'** CATCH BASIN N62°20'04"W EXISTING 1 STORY TO BE RAZED + 32.91 32.36 DRAIN MANHOLE No. 27 FANEUIL STREET N/F TWENTY SEVEN LLC BK 642; PG 198 SEWER MANHOLE PARCEL ID: ELECTRIC MANHOLE No. 235 MARKET STREET 2202607000 N/F B & D MARKET STREET, LLC BK 653; PG 138 TELEPHONE MANHOLE SIGN — +32.67 32.82 UTILITY POLE 💠 BOLLARD O DRAIN LINE No. 19-21 FANEUIL STREET N/F
ISMAIL CHOWDHURY
BK 561; PG 99 WATER LINE <u>BENCHMARK:</u> MAG NAIL SET IN UTILITY POLE + 32.30 WOOD FENCE PROPOSED CURB CUT INVERT ELEV = 33.82'(BOSTON CITY BASE) DMH RIM = 32.23'RELOCATION FOUND (77.3) [mallellana N62°33'52"W -- 25.28' --CONCRETE BOUND CB N62°33'52"W 69.88' N62°33'52"W 178.21' STONE BOUND SB 100.00° N62°33′52"W GRANITE CURE 12" DRAIN 10.0' FANEUIL STREET INV = 22.78" CI L.P. 1929 INV = 25.9' (PUBLIC ~ 50.0' WIDE) \$\frac{32.64}{32.62} \frac{32.65}{32.65} \frac{32.66}{32.70} \frac{32.84}{32.84} \frac{132.82}{32.82} \frac{15" SEWER}{32.80} \frac{32.90}{33.10} \frac{33.42}{33.42} SL 12" PCI 1885 (2000) SMH RIM = 33.54' 32.63 GRANITE CURB 32.90 INV = 25.6' SL 12" PCI 1885 (2000)  $\frac{SMH}{RIM = 32.60'}$ INV = 25.6' 3 INV = 21.8' $\begin{array}{rcl}
DMH \\
RIM &=& 32.37' \\
INV &=& NA
\end{array}$ <u>BENCHMARK:</u> OPEN BOLT OF HYDRANT ELEV = 34.61' (BOSTON CITY BASE) 6" CEM. CONC. FROM FIELD: PLAN VIEW SECTION VIEW — JOINT TO JOINT —— 6" CEM. CONC. \_\_ DRAFT: JJH/SAP (NOT TO SCALE) (NOT TO SCALE) SIDEWALK 2' RADIUS STONE CHECK: TYPE VA-4 ONE PIECE 6" CONCRETE \_ EXPANSION JOINT - ROADWAY SURFACE 6" GRAVEL (MIN.)  $(\frac{3}{8}" PREFORMED FILLER)$ \_\_\_6" GRANITE EDGE DATE: 08/28/20 ----2' GRANITE RAD. CORNER JOB # 17-00415

FIFTY ONE (51) PARKING SPACES AT GRADE.

## PROJECT OVERVIEW:

NEW CONSTRUCTION OF A MULTI-FAMILY RESIDENTIAL BUILDING WITH OF FORTY TWO (42) DWELLING UNITS AND

BUILDING WILL BE FULLY SPRINKLED IN ACCORDANCE WITH NFPA 13.

### APPLICABLE CODES

BUILDING

ELEVATOR

(2015 INTERNATIONAL BUILDING CODE, PROPOSED AMMENDMENTS) ACCESSIBILITY 521 CMR 12.00: MASSACHUSETTS ARCHITECTURAL ACCESS BOARD REGULATIONS FAIR HOUSING ACT (FHA), 2006 IBC SAFE HARBOR ADA: AMERICANS WITH DISABILITIES ACT, 2010 ADAAG 248 CMR: MASSACHUSETTS PLUMBING CODE (2014) PLUMBING FIRE PREVENTION 527 CMR: MASSACHUSETTS FIRE PREVENTION REGULATIONS (2015 NFPA-1, AMENDED) NFPA 10 FOR PLACEMENT OF FIRE EXTINGUISHERS NFPA 13 FOR FIRE PROTECTION SYSTEMS Sanitary 105 CMR 400: MASSACHUSETTS STATE SANITARY CODE (1998) MECHANICAL 2015 INTERNATIONAL MECHANICAL CODE ENERGY

780 CMR: MASSACHUSETTS BUILDING CODE (9TH EDITION)

2015 ENERGY CONSERVATION CODE (IECC) AS AMENDED BY THE "STRETCH CODE" ELECTRICAL 527 CMR 12.00: MASSACHUSETTS ELECTRICAL CODE (2017 NATIONAL ELECTRICAL CODE, AMENDED)

GROUP S-2 (PARKING) OCCUPANCY

OCCUPANCI	GROUP R-2 (MULTI-FAMILY DWELLING)
CONSTRUCTION TYPE	TYPE 1A (LEVEL 1); TYPE-5A (LEVELS 2 THROUGH LEVEL 4)
HEIGHT AREA	4 STORIES + ROOF ACCESS; 64'-0" 51,255 SF (IBC)

MASSACHUSETTS BOARD OF ELEVATOR REGULATIONS 524 CMR

HEIGHT AND AREA LIMITATIONS	HEIGHT: TABLES 504.3   504.4	AREA: TABLE 506.2
LEVEL 1: CONSTRUCTION TYPE 1-A	UL	UL
LEVELS 2-4: CONSTRUCTION TYPE 5-A	4 STORIES, 70 FT	36,000 SQ. FT.
TOTAL ALLOWED 5 STORIES, 70 FT (IBC 2015; 510.2) 36,000 SQ. I		36,000 SQ. FT.
ACTUAL	4 STORIES+ROOF ACCESS, 64 FT	13,445 SQ. FT.

## IBC 2015 SECTION 510.2 HORIZONTAL BUILDING SEPARATION ALLOWANCE

- A BUILDING SHALL BE CONSIDERED AS SEPARATE AND DISTINCT BUILDINGS FOR THE PURPOSE OF DETERMINING AREA LIMITATIONS, CONTINUITY OF FIRE WALLS, LIMITATION OF NUMBER OF STORIES AND TYPE OF CONSTRUCTION WHERE ALL OF THE FOLLOWING CONDITIONS ARE MET:
- 1. THE BUILDINGS ARE SEPARATED WITH A HORIZONTAL ASSEMBLY HAVING A FIRE RESISTANCE RATING OF
- 2. THE BUILDING BELOW THE HORIZONTAL ASSEMBLY IS OF TYPE 1A CONSTRUCTION
- 3. SHAFT, STAIRWAY, RAMP AND ESCALATOR ENCLOSURES THROUGH THE HORIZONTAL ASSEMBLY SHALL HAVE NOT LESS THAN A 2-HOUR FIRE-RESISTANCE RATING WITH OPENING PROTECTIVES IN ACCORDANCE WITH
- 4. THE BUILDING OR BUILDINGS ABOVE THE HORIZONTAL ASSEMBLY SHALL BE PERMITTED TO HAVE MULTIPLE GROUP A OCCUPANCY USES, EACH WITH OCCUPANT LOAD OF LESS 300, OR GROUP B, M, R, OR S
- 5. THE BUILDING BELOW THE HORIZONTAL ASSEMBLY SHALL BE PROTECTED THROUGHOUT BY AN APPROVED AUTOMATIC SPRINKLER SYSTEM IN ACCORDANCE WITH SECTION 903.3.1.1, AND SHALL BE PERMITTED TO BE ANY OCCUPANCY ALLOWED BY THIS CODE EXCEPT GROUP H.
- 6. THE MAXIMUM BUILDING HEIGHT IN FEET (MM) SHALL NOT EXCEED THE LIMITS SET FORTH IN SECTION 504.3 FOR THE BUILDING HAVING THE SMALLER ALLOWABLE HEIGHT AS MEASURED FROM THE GRADE PLANE

## PRIMARY STRUCTURAL FRAME FIRE RESISTANCE RATING: 780 CMR 602.1 (TABLE 601)

BUILDING ELEMENT	TYPE 1-A	TYPE 5-A
STRUCTURAL FRAME INCLUDING COLUMNS, GIRDERS, TRUSSES	3 HOURS	1 HOUR
BEARING WALLS, EXTERIOR	3 HOURS (NOTE A, B)	1 HOUR (NOTE A)
BEARING WALL, INTERIOR	3 HOURS	1 HOUR
non-bearing walls and partitions, exterior	1 HOUR (NOTE D)	1 HOUR (NOTE A)
non-bearing walls and partitions, interior	0 HOURS (NOTE C)	0 HOURS
FLOOR CONSTRUCTION INCLUDING SUPPORTING BEAMS AND JOIST	2 HOURS	1 HOUR
ROOF CONSTRUCTION INCLUDING SUPPORTING BEAMS AND JOISTS	1.5 HOURS	1 HOUR

- A. NOT LESS THAN THE FIRE-RESISTANCE RATING BASED ON FIRE SEPARATION DISTANCE (TABLE 602) B. NOT LESS THAN THE FIRE-RESISTANCE RATING AS REFERENCED IN SECTION 704.10
- C. NOT LESS THAN THE FIRE-RESISTANCE RATING REQUIRED BY OTHER SECTIONS OF THIS CODE
- D. IF FIRE-SEPARATION DISTANCE IS GREATER THAN 30 FEET, NO RATING REQUIRED. E. ALL INTERIOR WOOD BEARING WALLS CARRY 1HR. MIN. FIRE RATING BY PROPERTIES OF CONSTRUCTION;
- REFER TO PARTITION SCHEDULE F. ALL FLOOR ASSEMBLIES BETWEEN UNITS CARRY A 1HR. MIN. FIRE RATING

FIRE RESISTANCE ASSEMBLIES: SECTIONS 710 & 712			OPENING	
BUILDING ELEMENT	WALL TYPE	rating	PROTECTIVE RATING	
Shaft enclosures	FIRE BARRIER	2 HRS (NOTE 1)	90 MIN	
STAIR AND HOISTWAY ENCLOSURE	FIRE BARRIER	2 HRS	90 MIN	
DWELLING UNIT SEPARATIONS	FIRE PARTITION	1 HR	N/A	
DWELLING UNIT / OTHER OCC. SEPARATIONS	FIRE PARTITION	1 HR	N/A	
COMMON AREA CORRIDORS SERVING UNITS	FIRE PARTITION	1 HR	20 MIN (NOTE 2)	
TENANT SEPARATION	N/A	0	N/A	
ELECTRICAL/TELECOM CLOSETS	N/A	N/A	N/A	
ELEVATOR MACHINE ROOM	FIRE BARRIER	2 HRS	90 MIN	

1. REDUCED TO 1HR WITH SPRINKER HEADS INSIDE SHAFT 2. DOORS MUST BE SMOKE AND DRAFT CONTROL DOORS (780 CMR 715.4.3.1)

# INTERIOR FINISH REQUIREMENTS (780 CMR 803)

a. VERTICAL EXISTS AND EXIT PASSAGEWAY EXITWAYS b. EXIT ACCESSWAY CORRIDORS AND OTHER EXITWAYS (780 CMR 803)

# c. ROOMS AND ENCLOSED SPACES (780 CMR 803)

FIRE PROTECTION REQUIREMENTS

1. FIRE SPRINKLER SYSTEM (903.0) 2. STANDPIPE SYSTEM (905.0)

3. FIRE DEPARTMENT CONNECTIONS (912.0) 4. FIRE ALARM AND DETECTION SYSTEMS (907.0)

5. AUTOMATIC FIRE DETECTION SYSTEM

6. PORTABLE FIRE EXTINGUISHERS (906.6) 7. FIRE STOPPING REQUIREMENTS (720.7)

8. ROOF STRUCTURES / SKYLIGHTS (1506.1.3) 9. SMOKE DETECTORS (907.2.11.2)

EGRESS REQUIREMENTS (SEE EGRESS PLANS) 1. OCCUPANT LOAD (780 CMR 1004.1.1)

2. MAX TRAVEL DISTANCE TO EXIST (780 CMR 1016.1) 3. MAX DEAD END CORRIDORS (780 CMR 1018.4) 4. MIN CORRIDOR WIDTHS (780 CMR 1018.2)

**ENERGY CODE** 

BOSTON IS A STRETCH CODE COMMUNITY.

LEVEL 1 : IECC 2015 C402 (TABLE C402.1.3)

BUILDING ELEMENT	CLIMATE ZONE 5
WALLS ABOVE GRADE (METAL FRAMED)	R-13 + R-7.5ci
unheated slabs	R-10 FOR 24"

# LEVEL 2 THROUGH LEVEL 5 : IECC 2015 R402 (TABLE R402.1.2) = 780 CMR N1102 (TABLE N1102.1.2)

BUILDING ELEMENT	CLIMATE ZONE 5
FENESTRATION U-FACTOR	0.30 (STRETCH CODE)
CEILING R-VALUE	R-49
WOOD FRAME WALL R-VALUE	R-20 or R13+R-5ci
FLOOR R-VALUE	R-30 (NOTE 1)
SLAB R-VALUE & DEPTH	R-10, 2'-0"

1. OR INSULATION SUFFICIENT TO FILL THE FRAMING CAVITY, R-19 MINIMUM.

### **ACCESSIBILITY**

THE BUILDING MUST COMPLY WITH REQUIREMENTS OF 521 CMR AND, FOR PUBLIC SPACES ONLY, THE ADA 2010 AND THE FAIR HOUSING ACT.

521 CMR 9 ADDRESSES THE REQUIREMENTS FOR WITHIN THE DWELLING UNITS, AND 521 CMR 10 ADDRESS COMMON AREAS.


GROUP 1 DWELLING UNITS ARE REQUIRED (PER 521 CMR 9.3)


GROUP 2 DWELLING UNITS ARE NOT REQUIRED (PER 521 CMR 9.4) AS THIS BUILDING IS TO BE A CONDOMINIUM

ALL PUBLIC AND COMMON USE AREAS MUST BE ACCESSIBLE (521 CMR SECTION 10)

ALL HALLWAYS, AND OTHER COMMON USE AREAS, OF THE RESIDENTIAL AREAS MUST BE FULLY ACCESSIBLE, INCLUDING STORAGE ROOMS, TRASH ROOMS, THE BUILDING MANAGMENT OFFICE AND THE LIKE.

RESIDENTIAL PARKING. ACCESSIBLE PARKING SPACE MUST BE CAPABLE OF BEING PROVIDED IN ACCORDANCE WITH 521 CMR 23, ONE OF WHICH MUST BE A VAN SPACE.

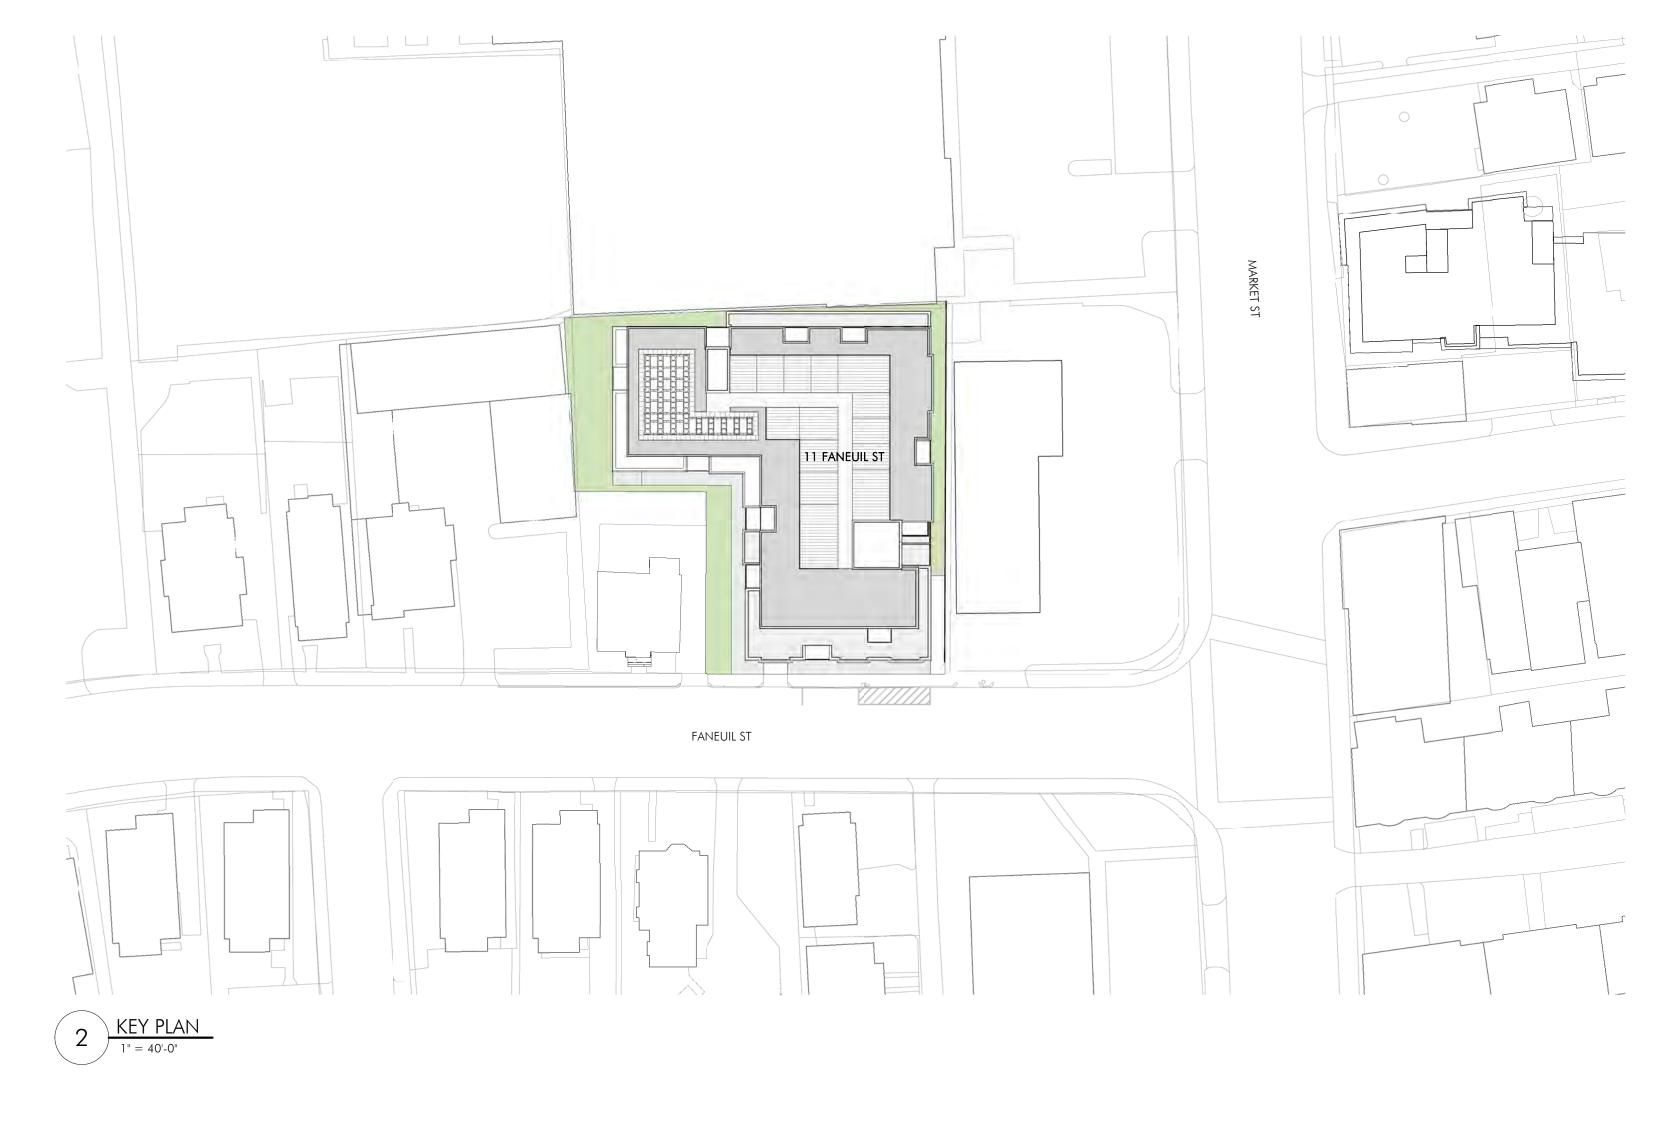

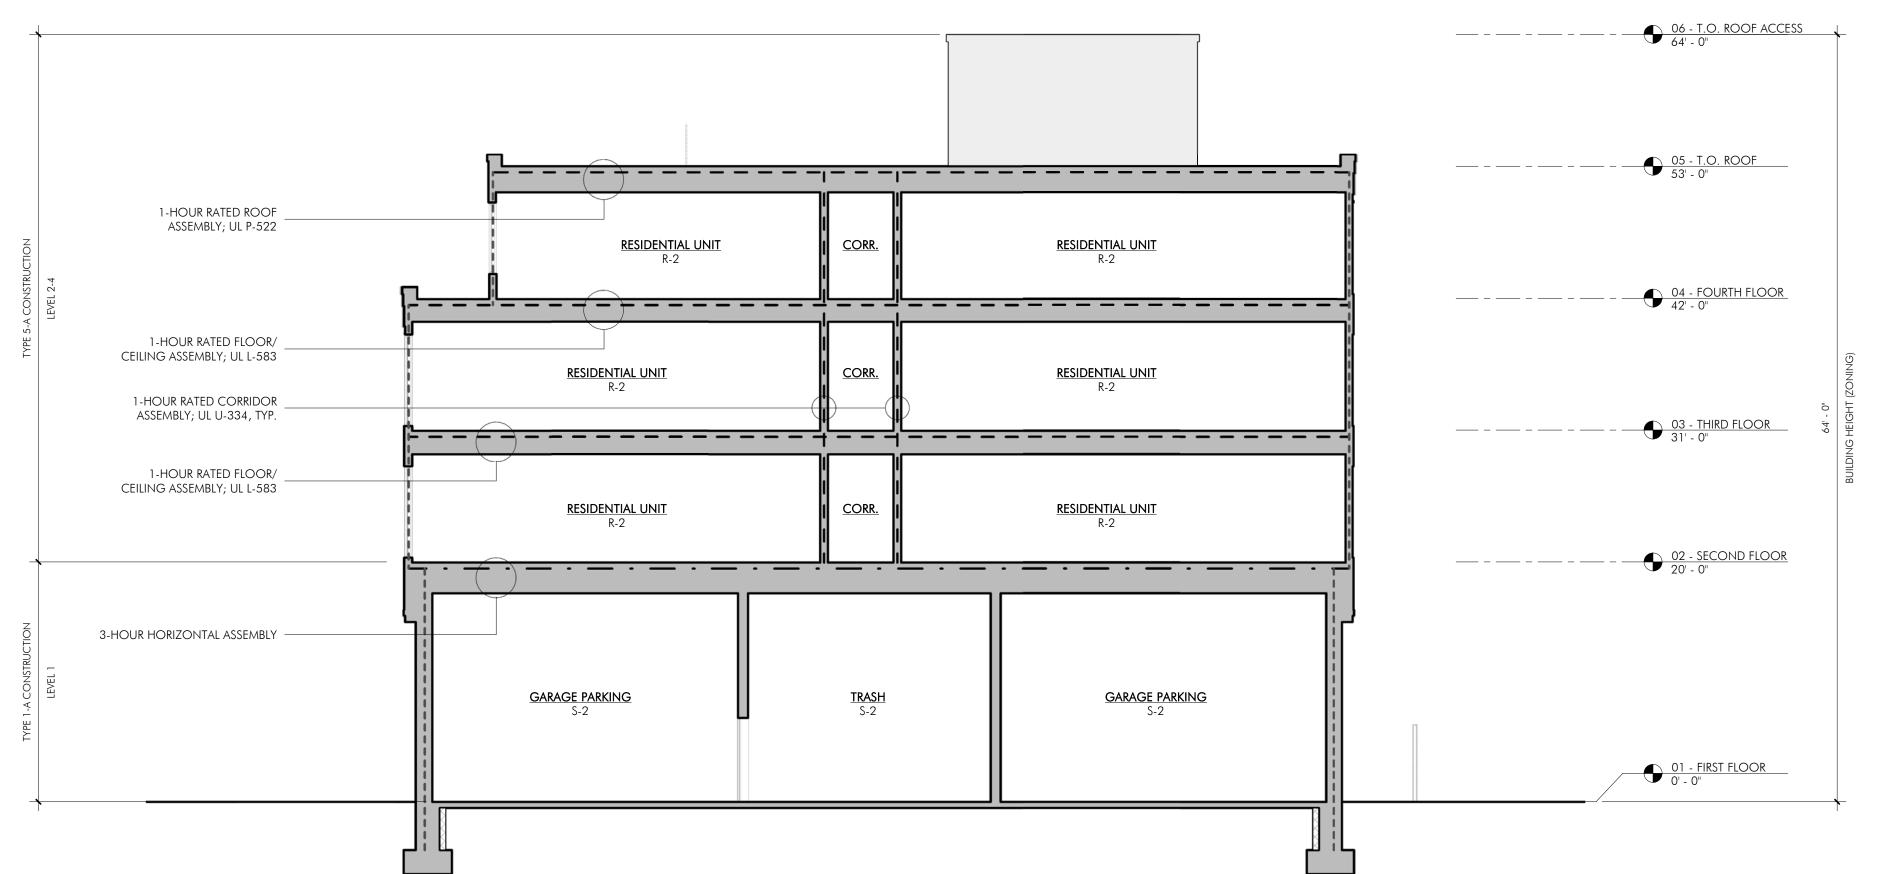



BOSTON, MA 02127

OWNER

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CONSULTANTS

SURVEYOR BOSTON SURVEY INC. UNIT C-4 SHIPWAY PLACE CHARLESTOWN MA, 02129


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ISSUE: NOT FOR CONSTRUCTION SEPTEMBER 18, 2020 PROJECT #: 17052

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| ARCHITECT BOSTON, MA 02127

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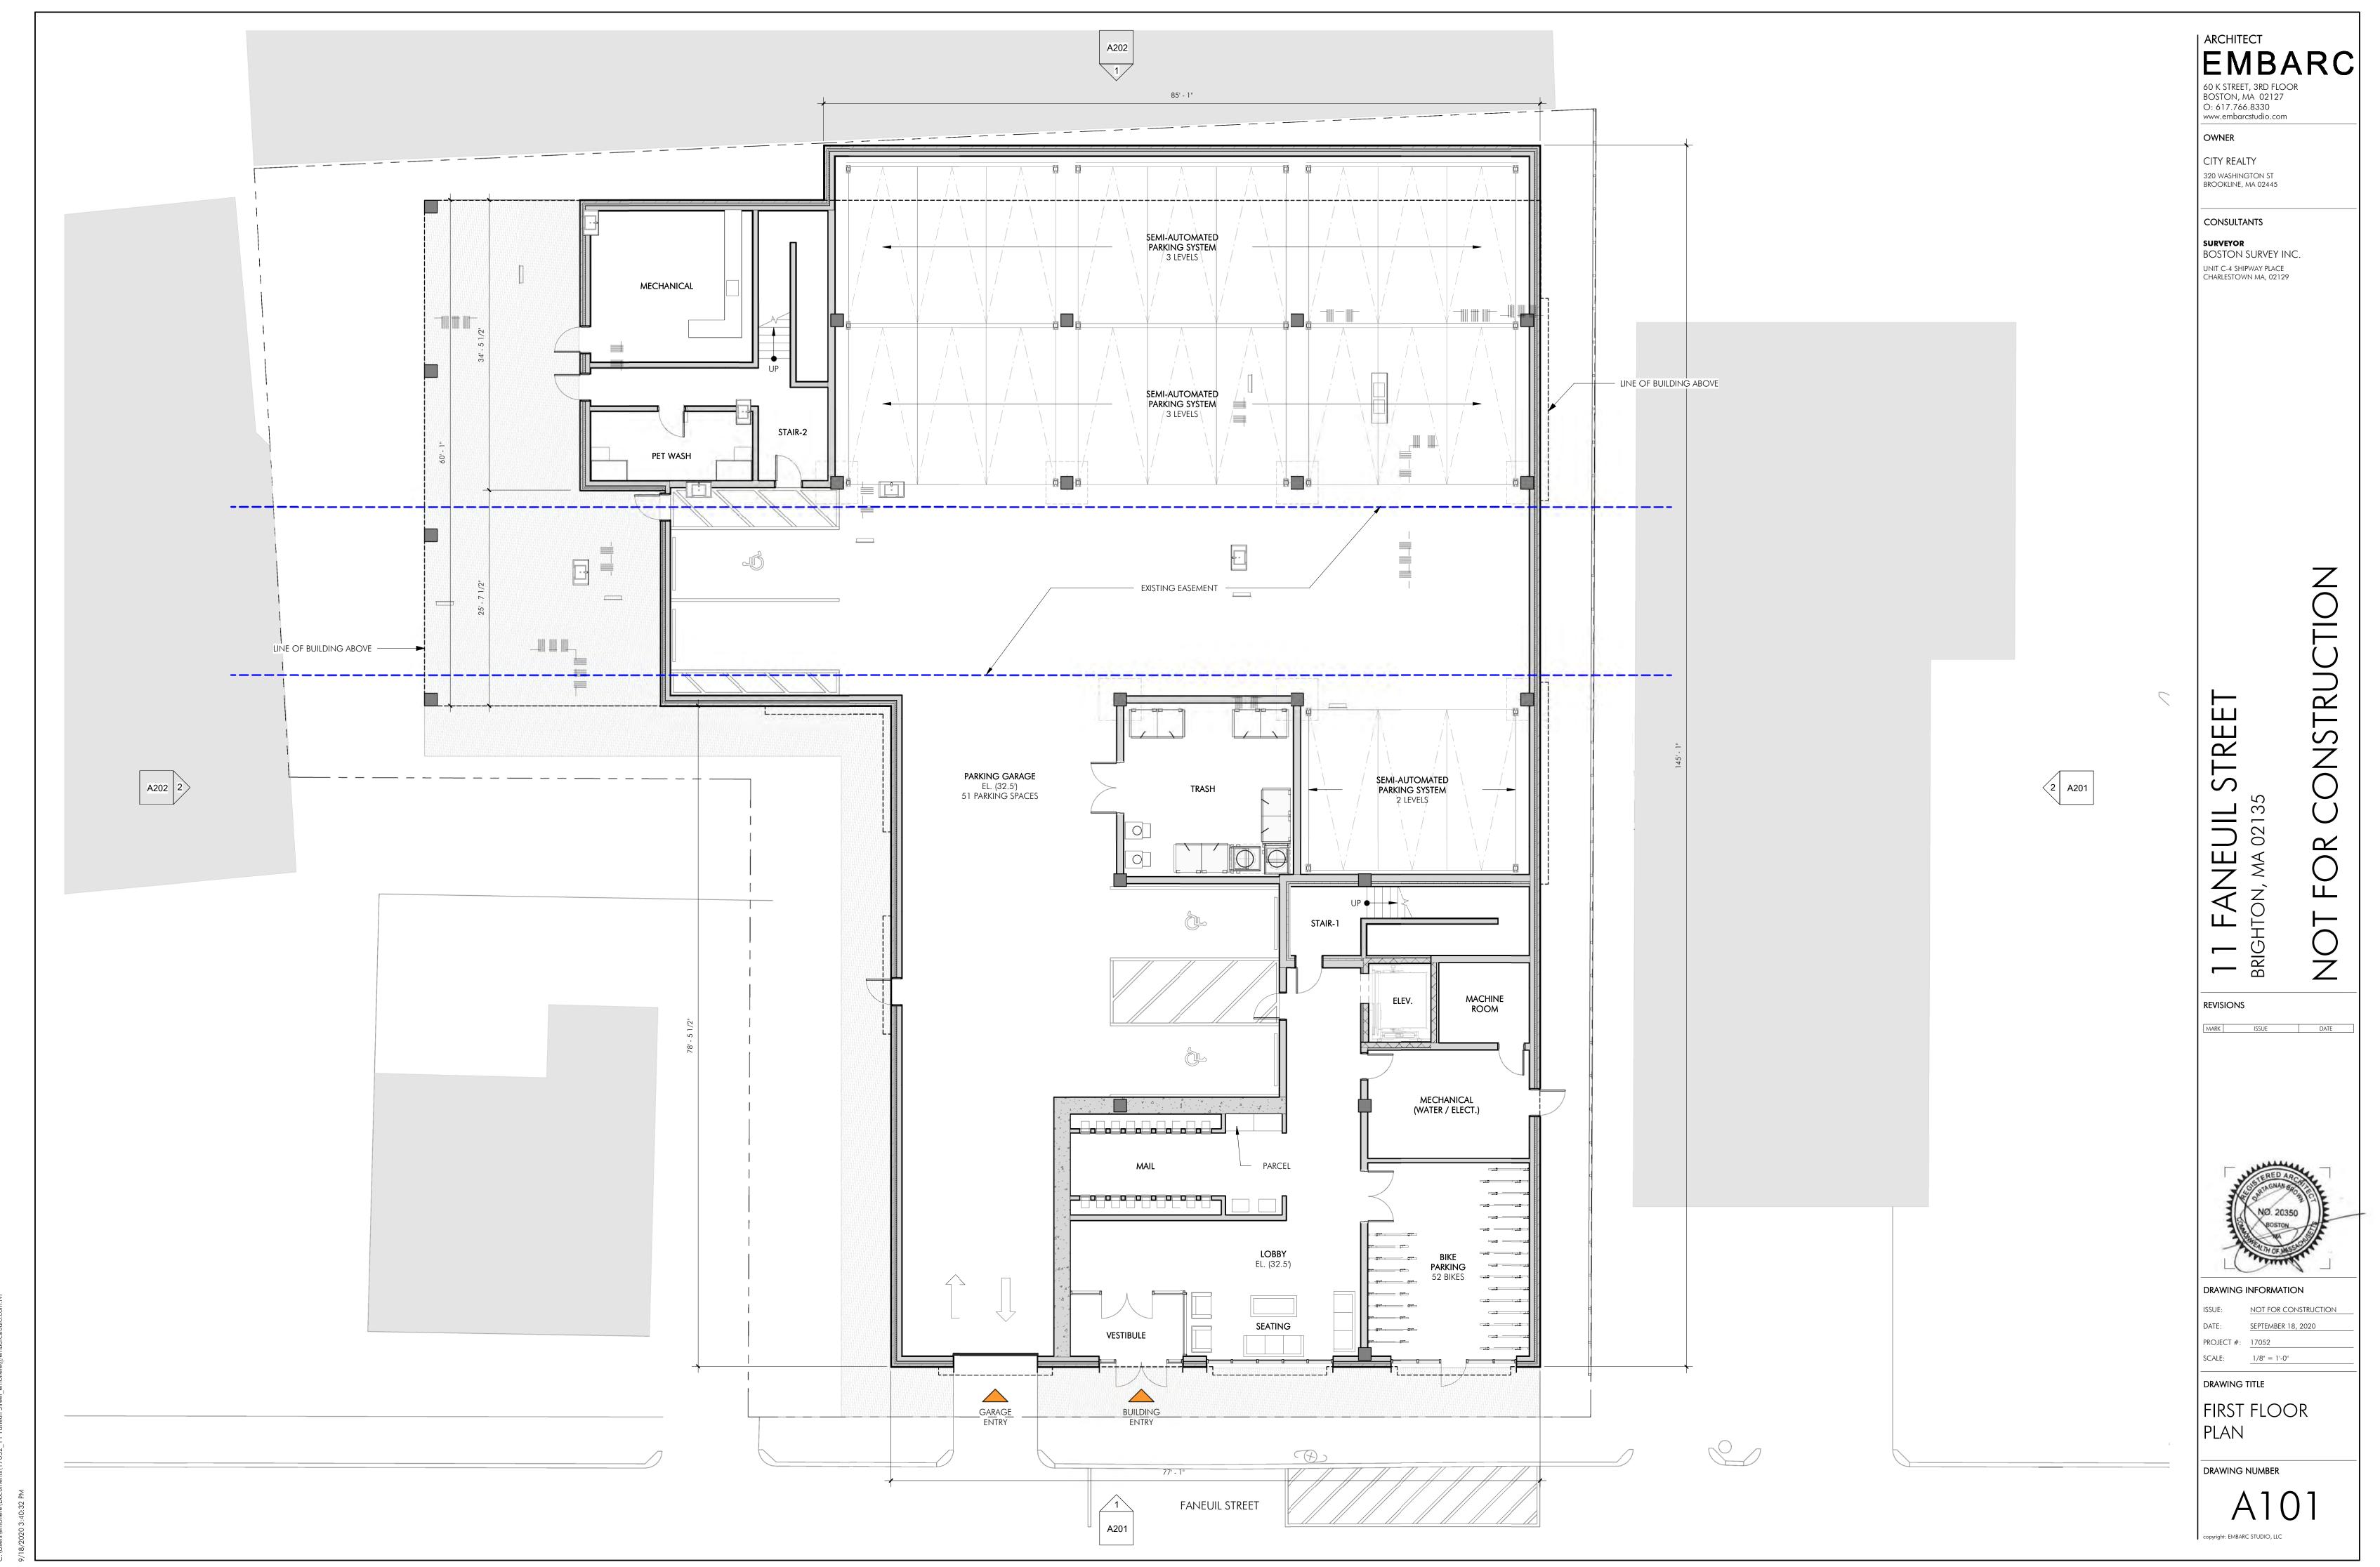
ISSUE: NOT FOR CONSTRUCTION SEPTEMBER 18, 2020


PROJECT #: 17052 1/16" = 1'-0"

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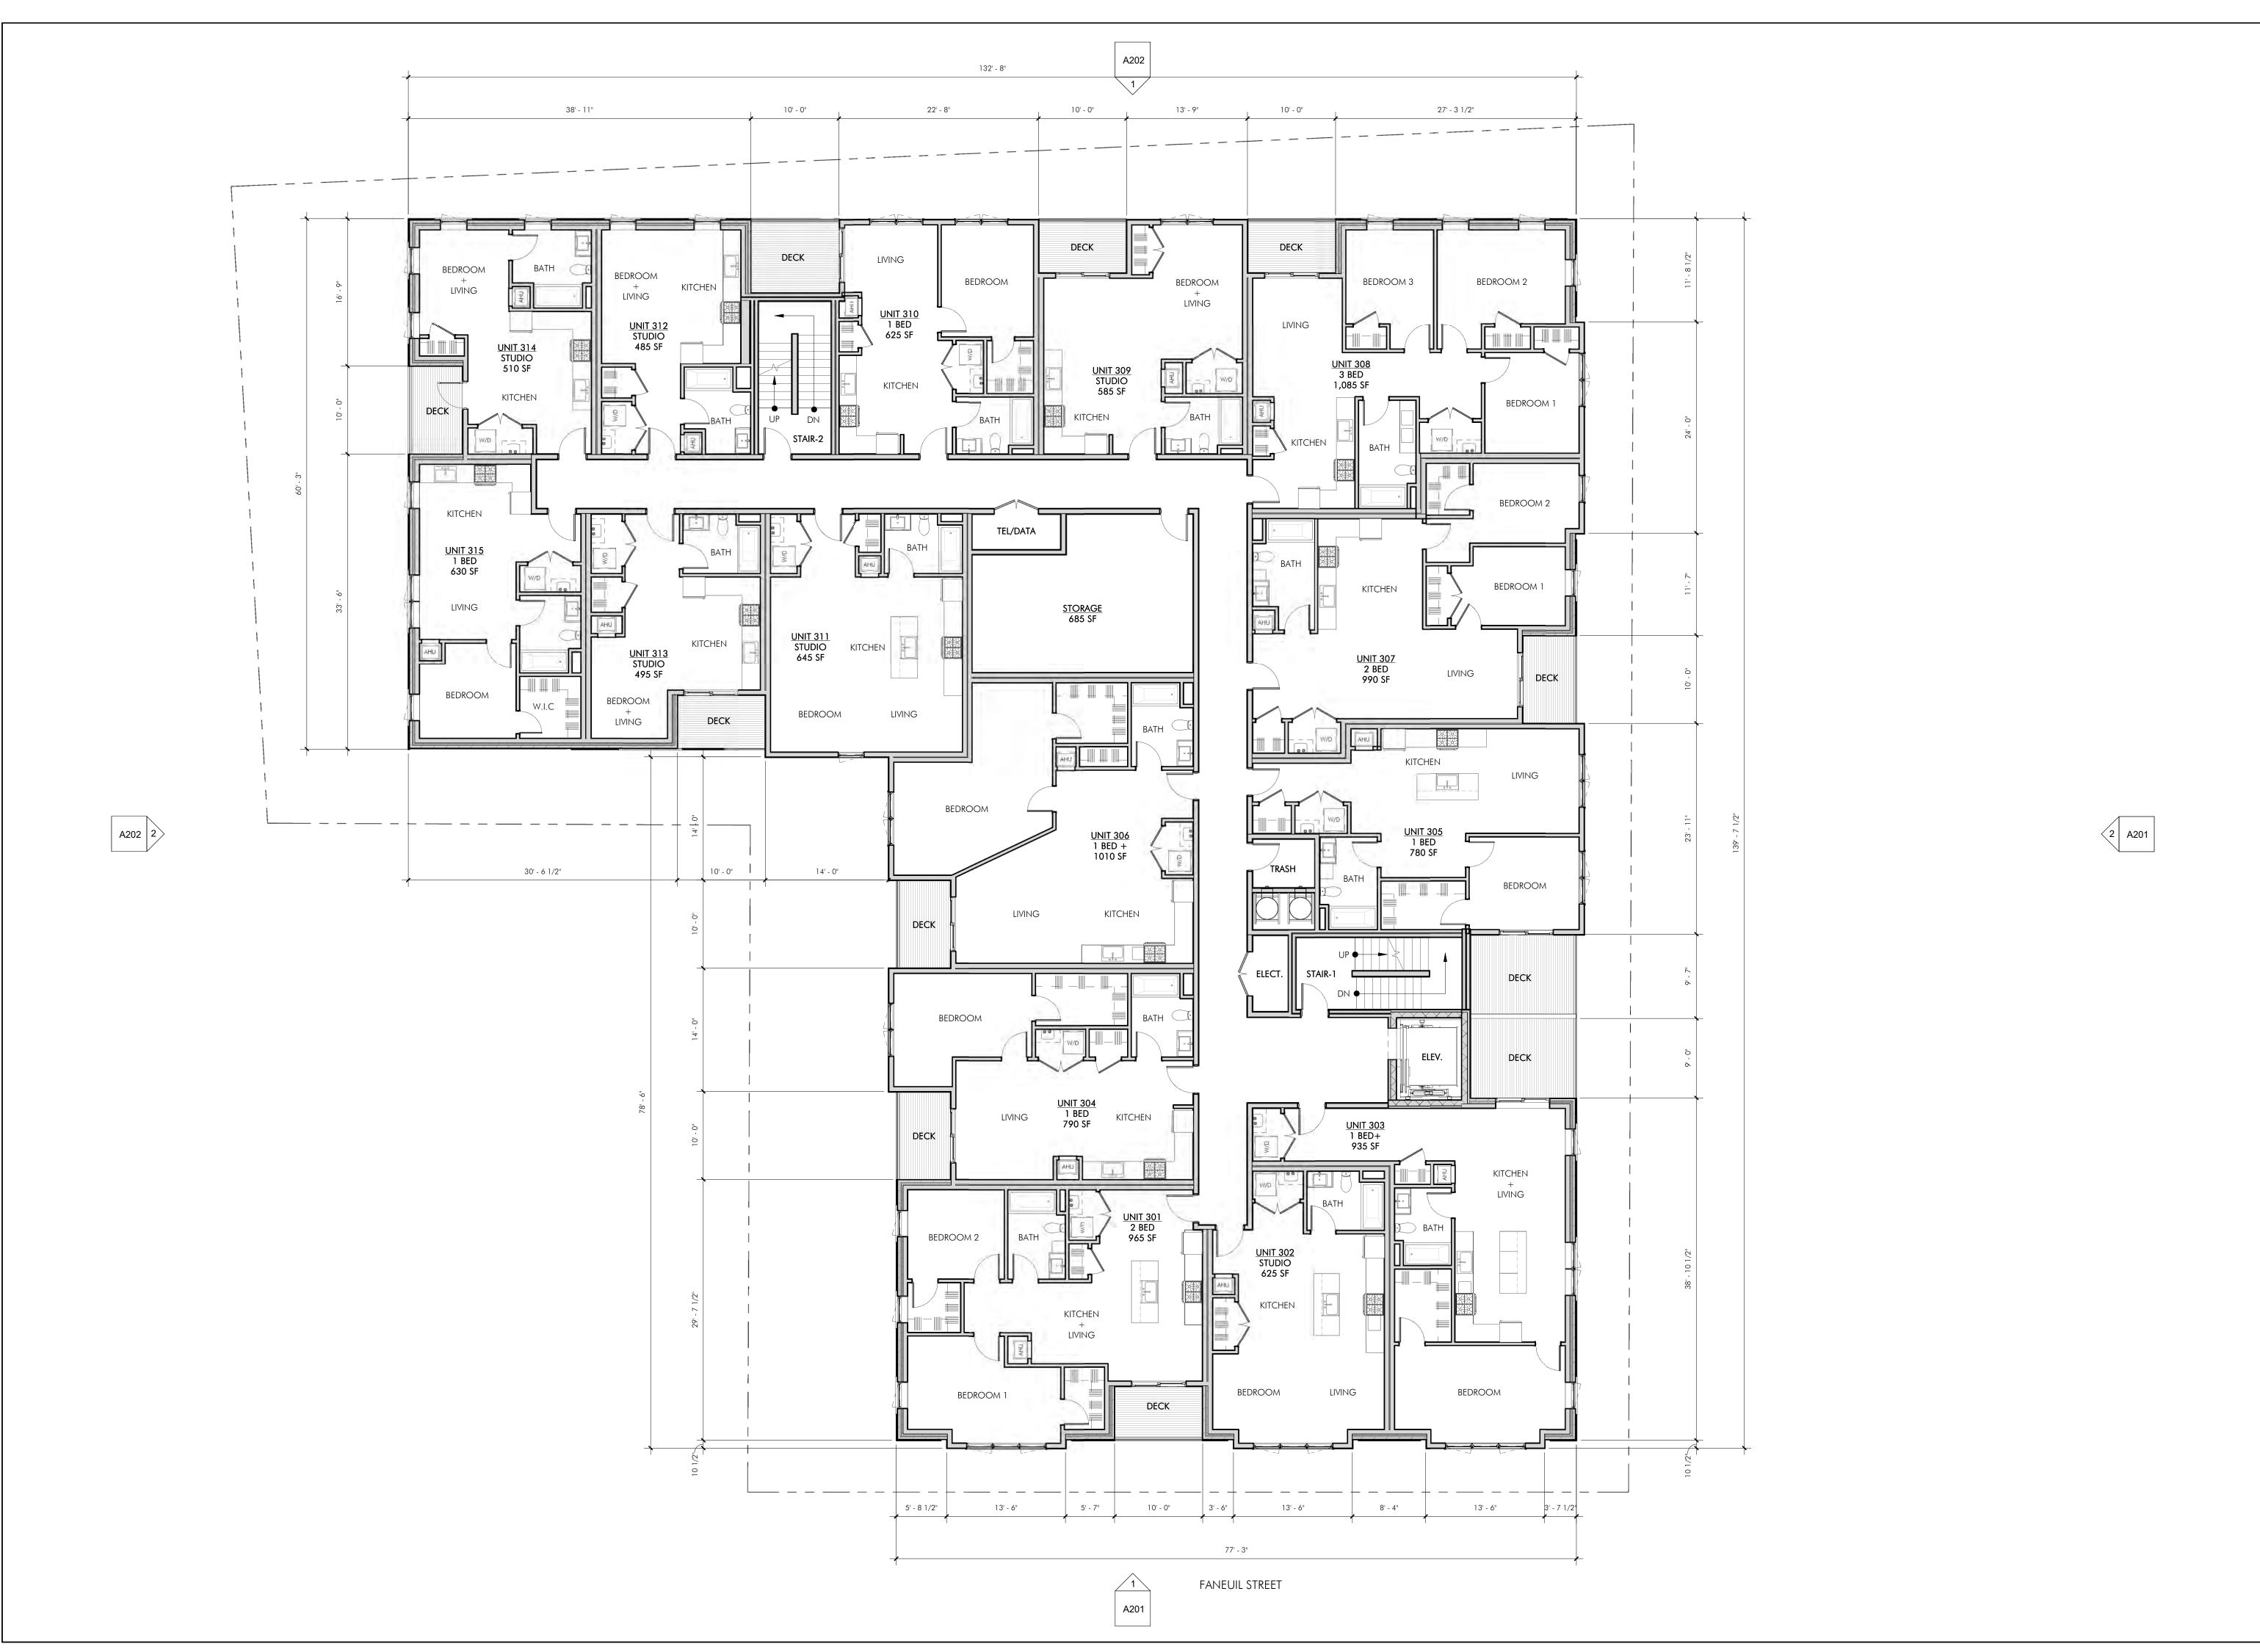
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SCALE: 1/8" = 1'-0"DRAWING TITLE

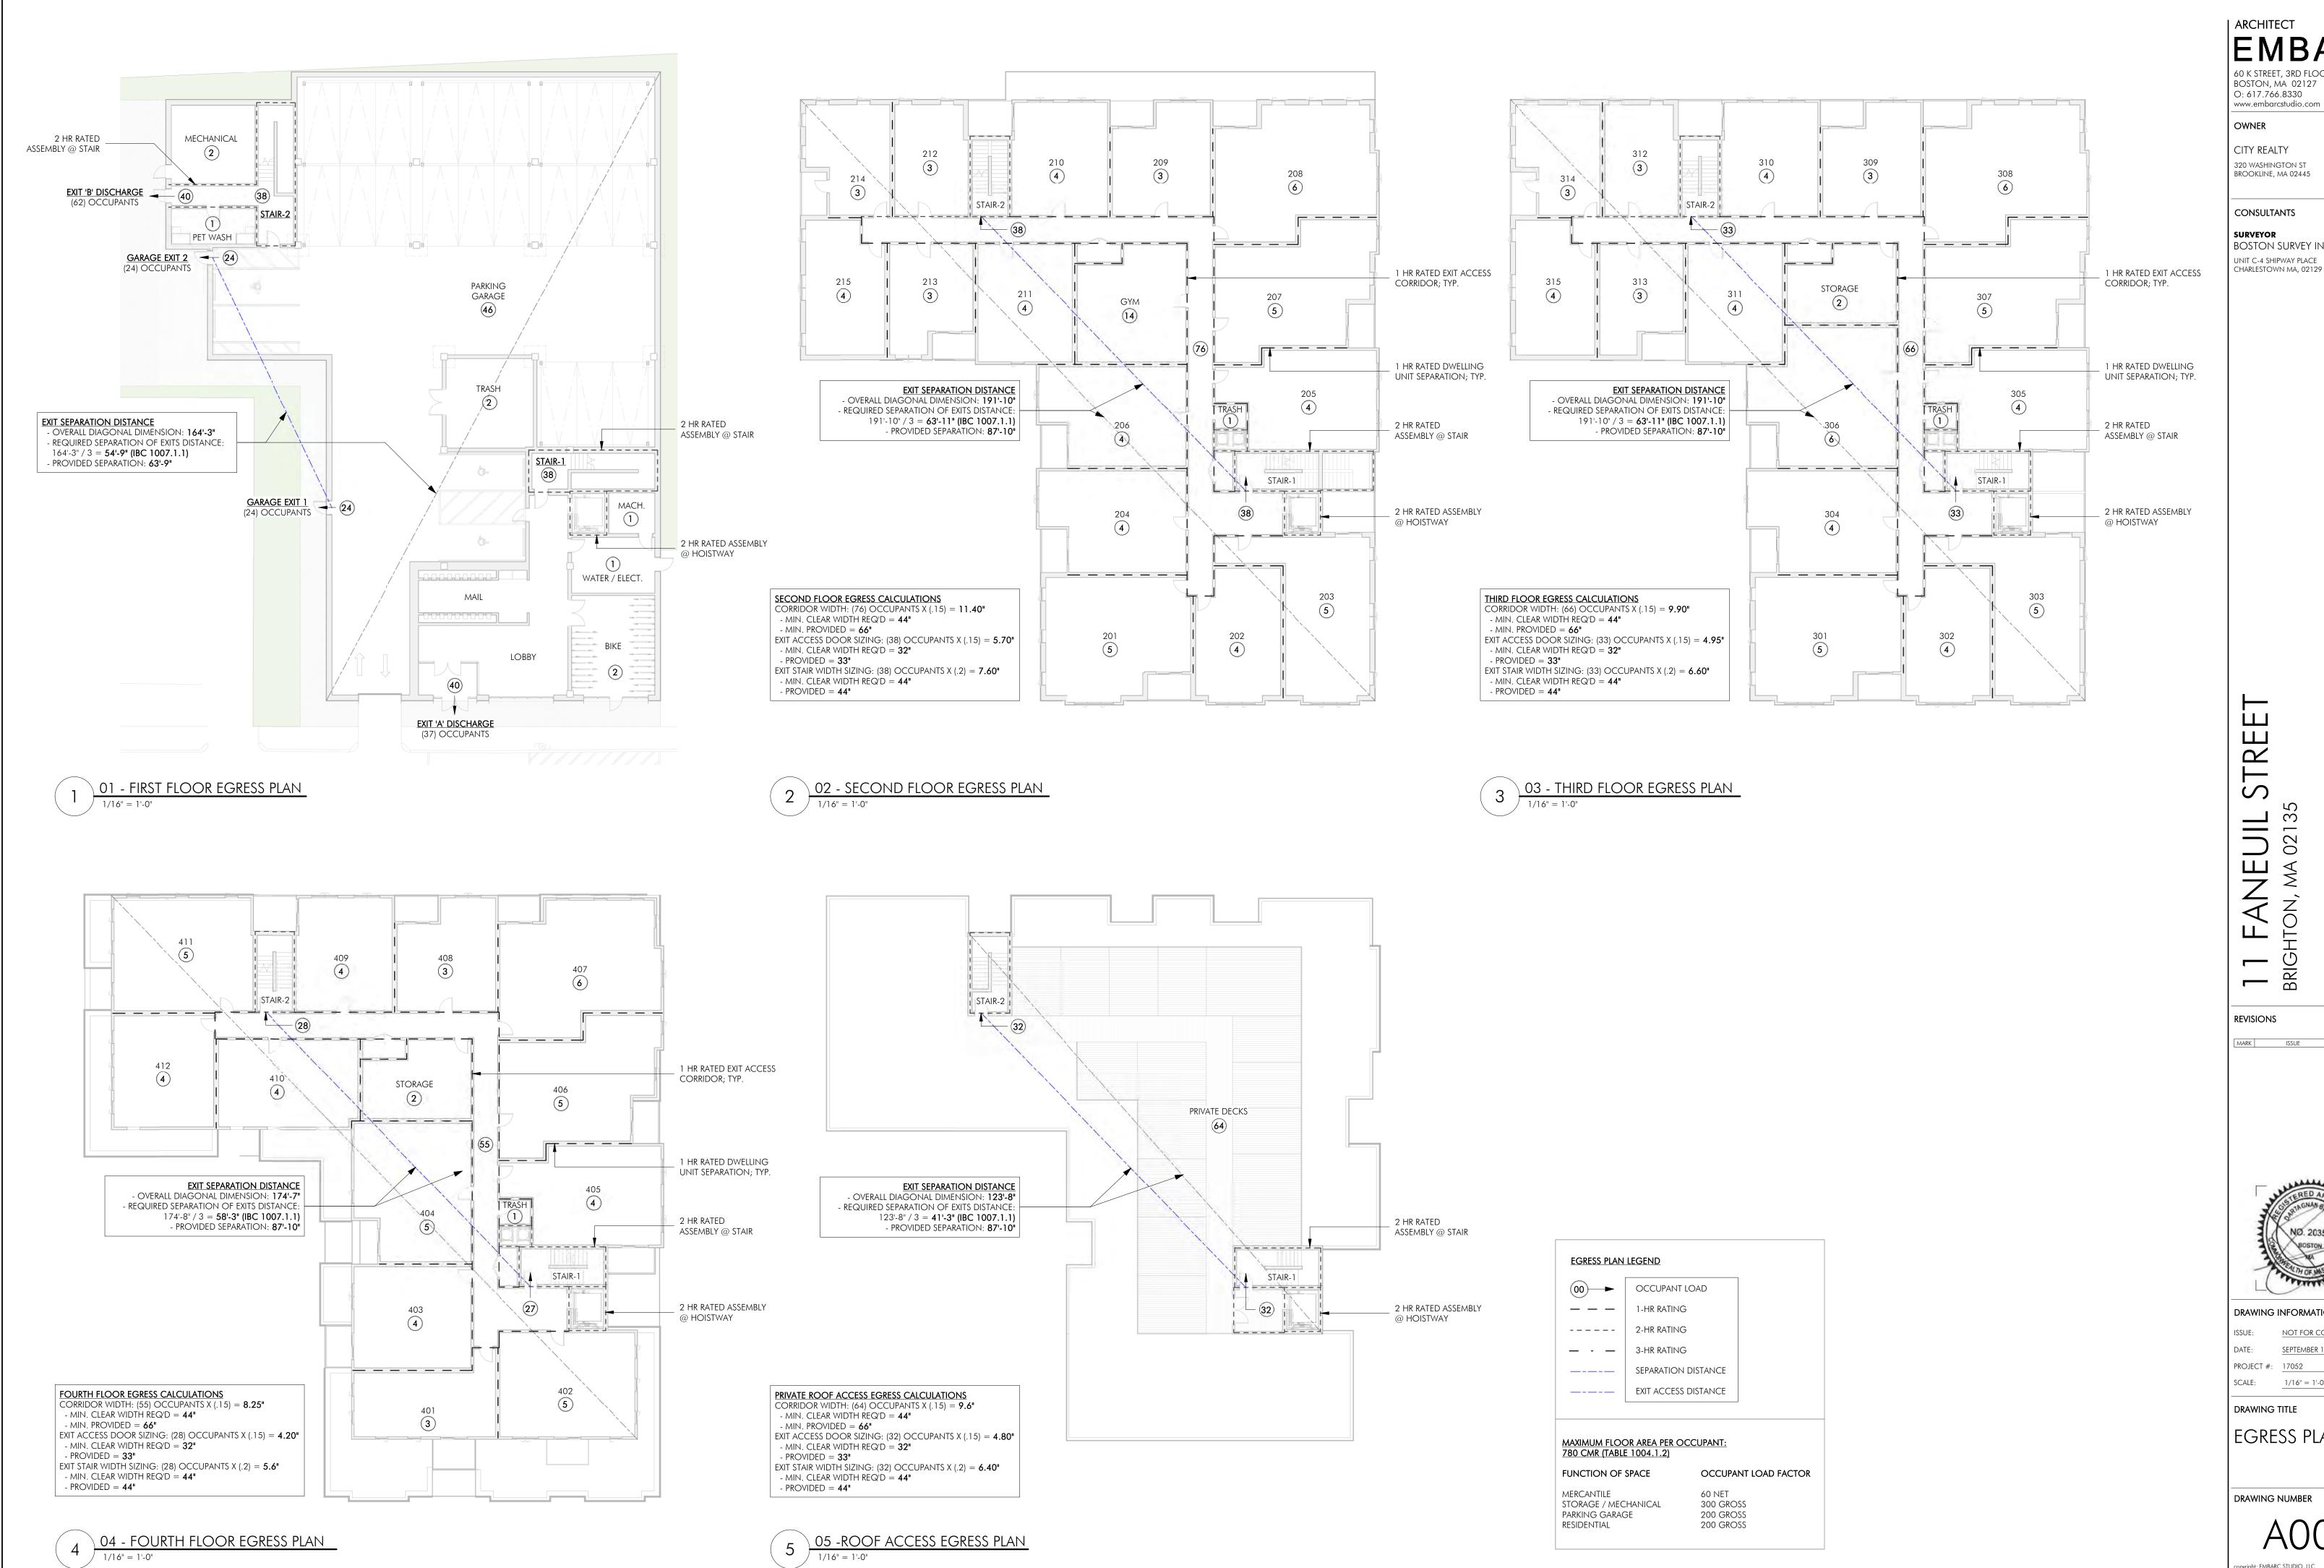SECOND FLOOR PLAN



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UNIT C-4 SHIPWAY PLACE
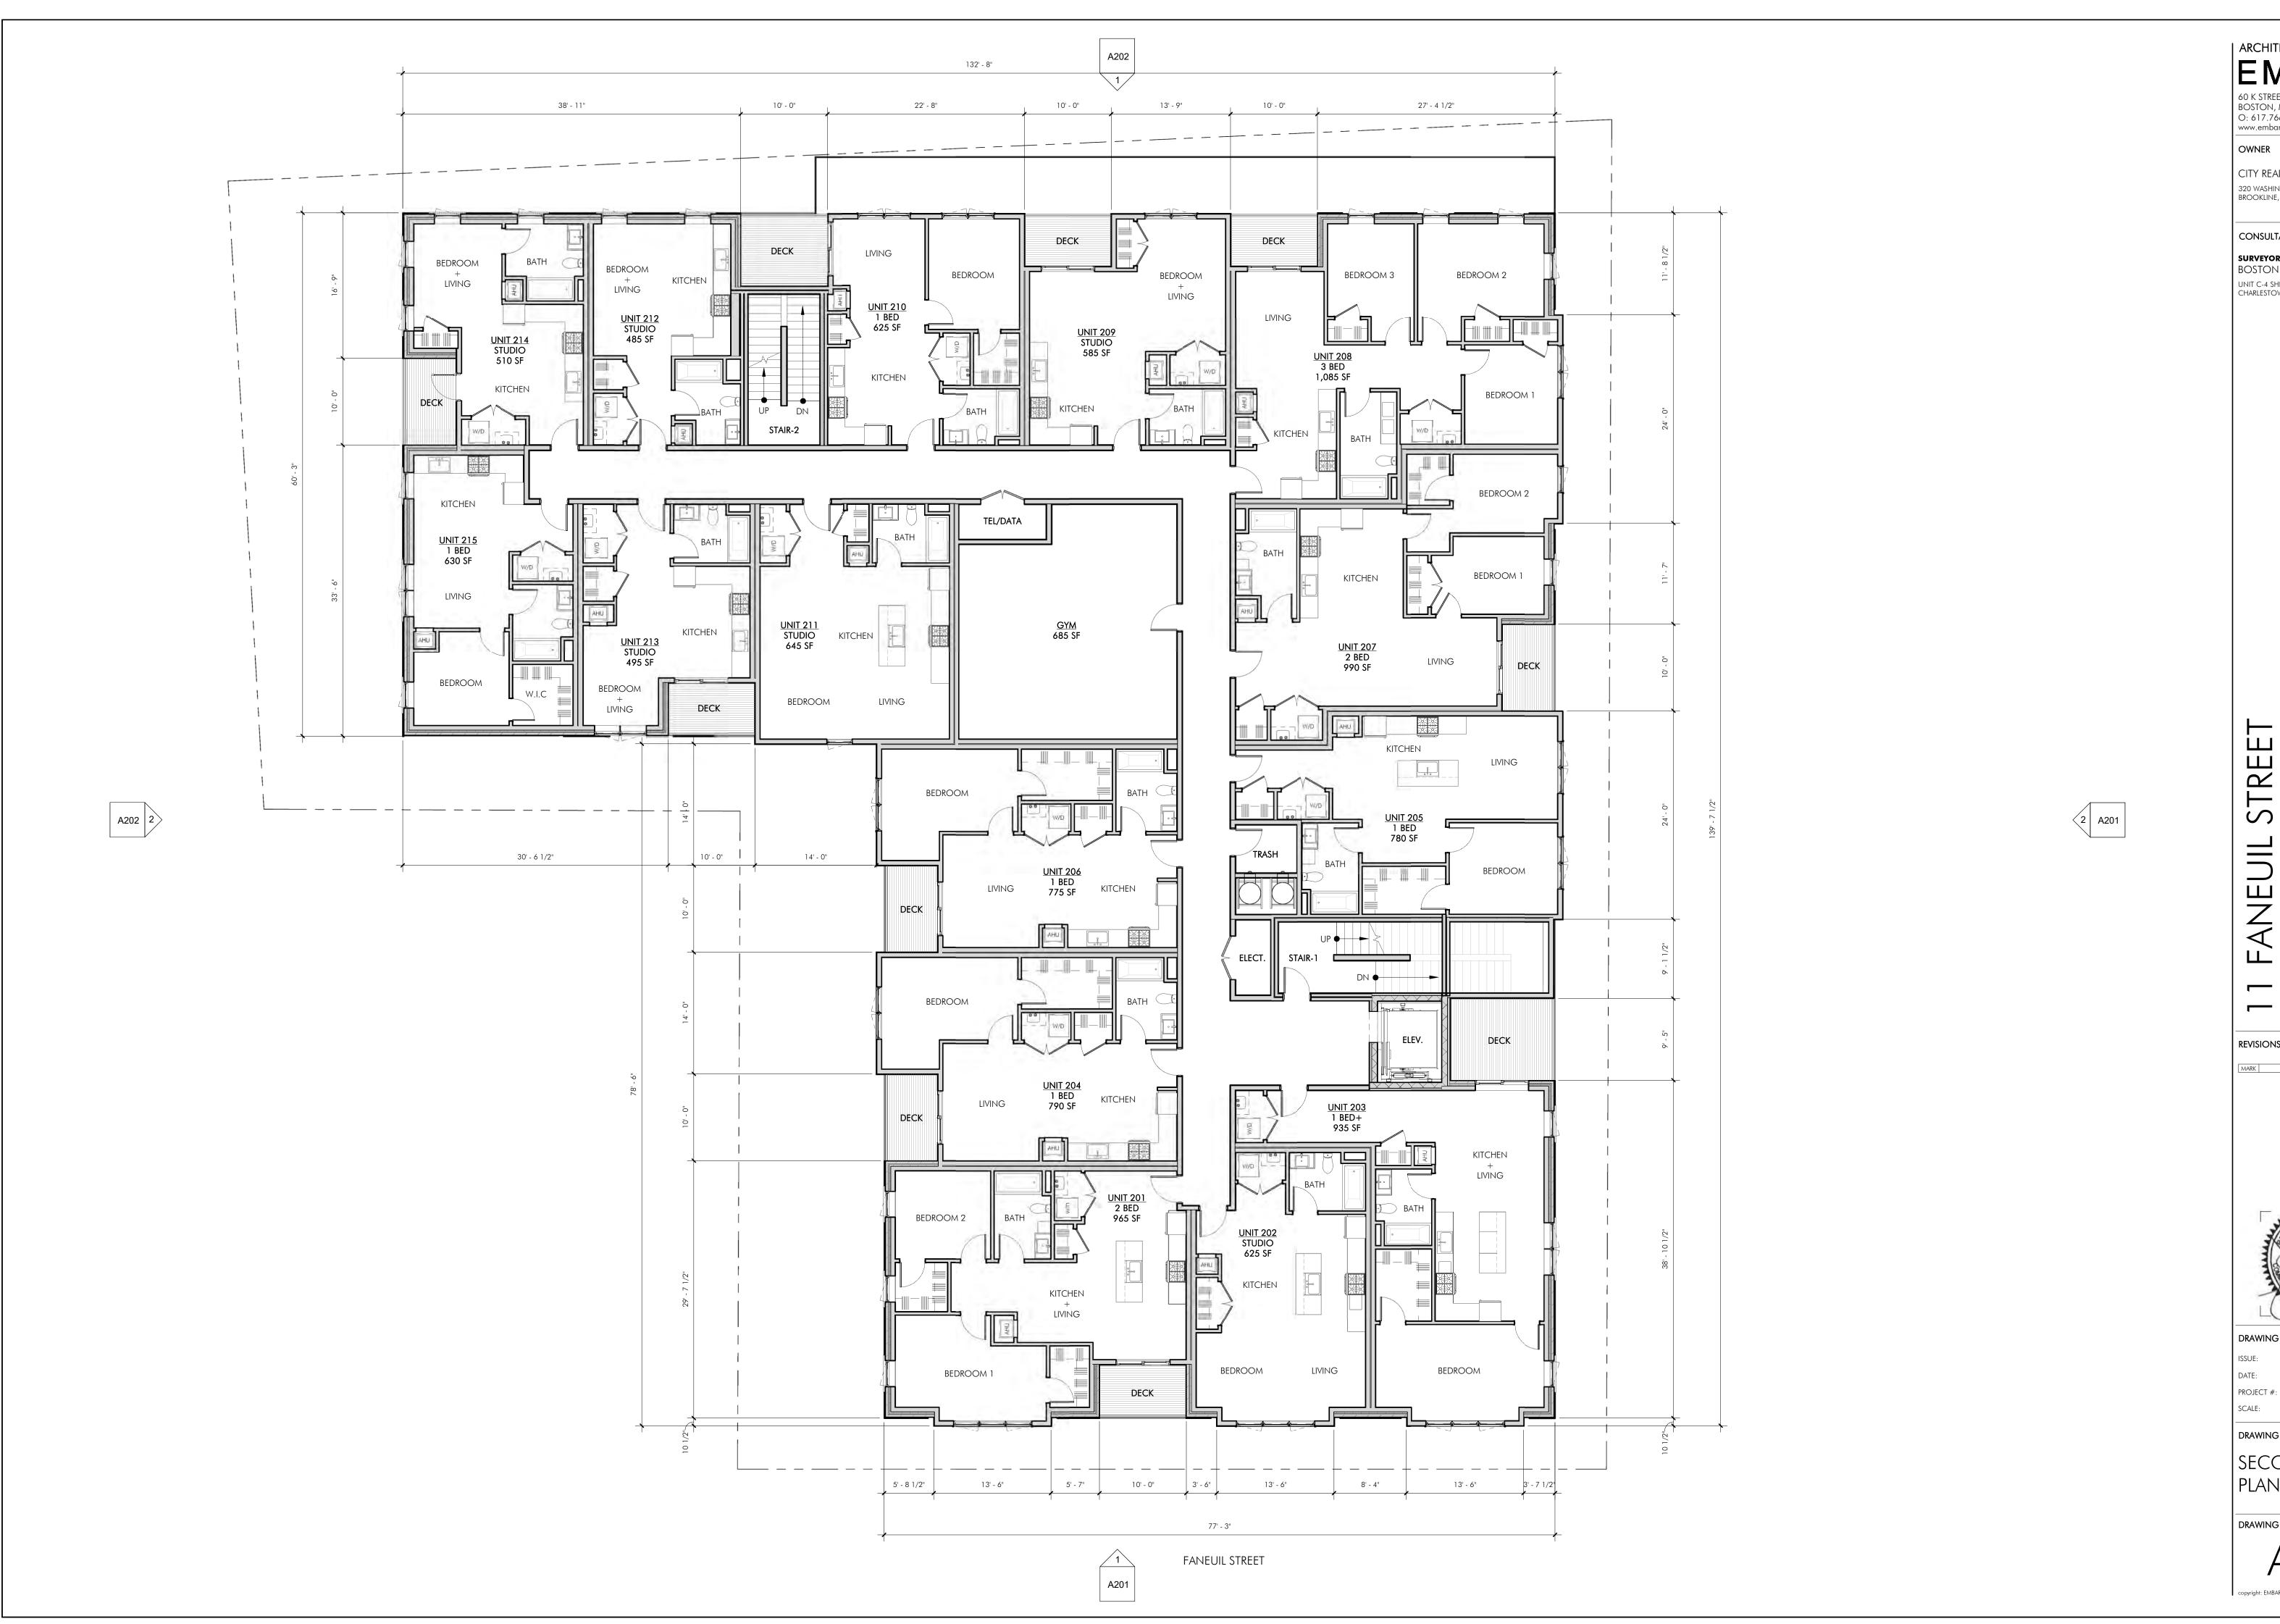
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 DATE:
 SEPTEMBER 18, 2020

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 17052


DRAWING TITLE
THIRD FLOOR

SCALE: 1/8" = 1'-0"

PLAN

DRAWING NUMBER

A103

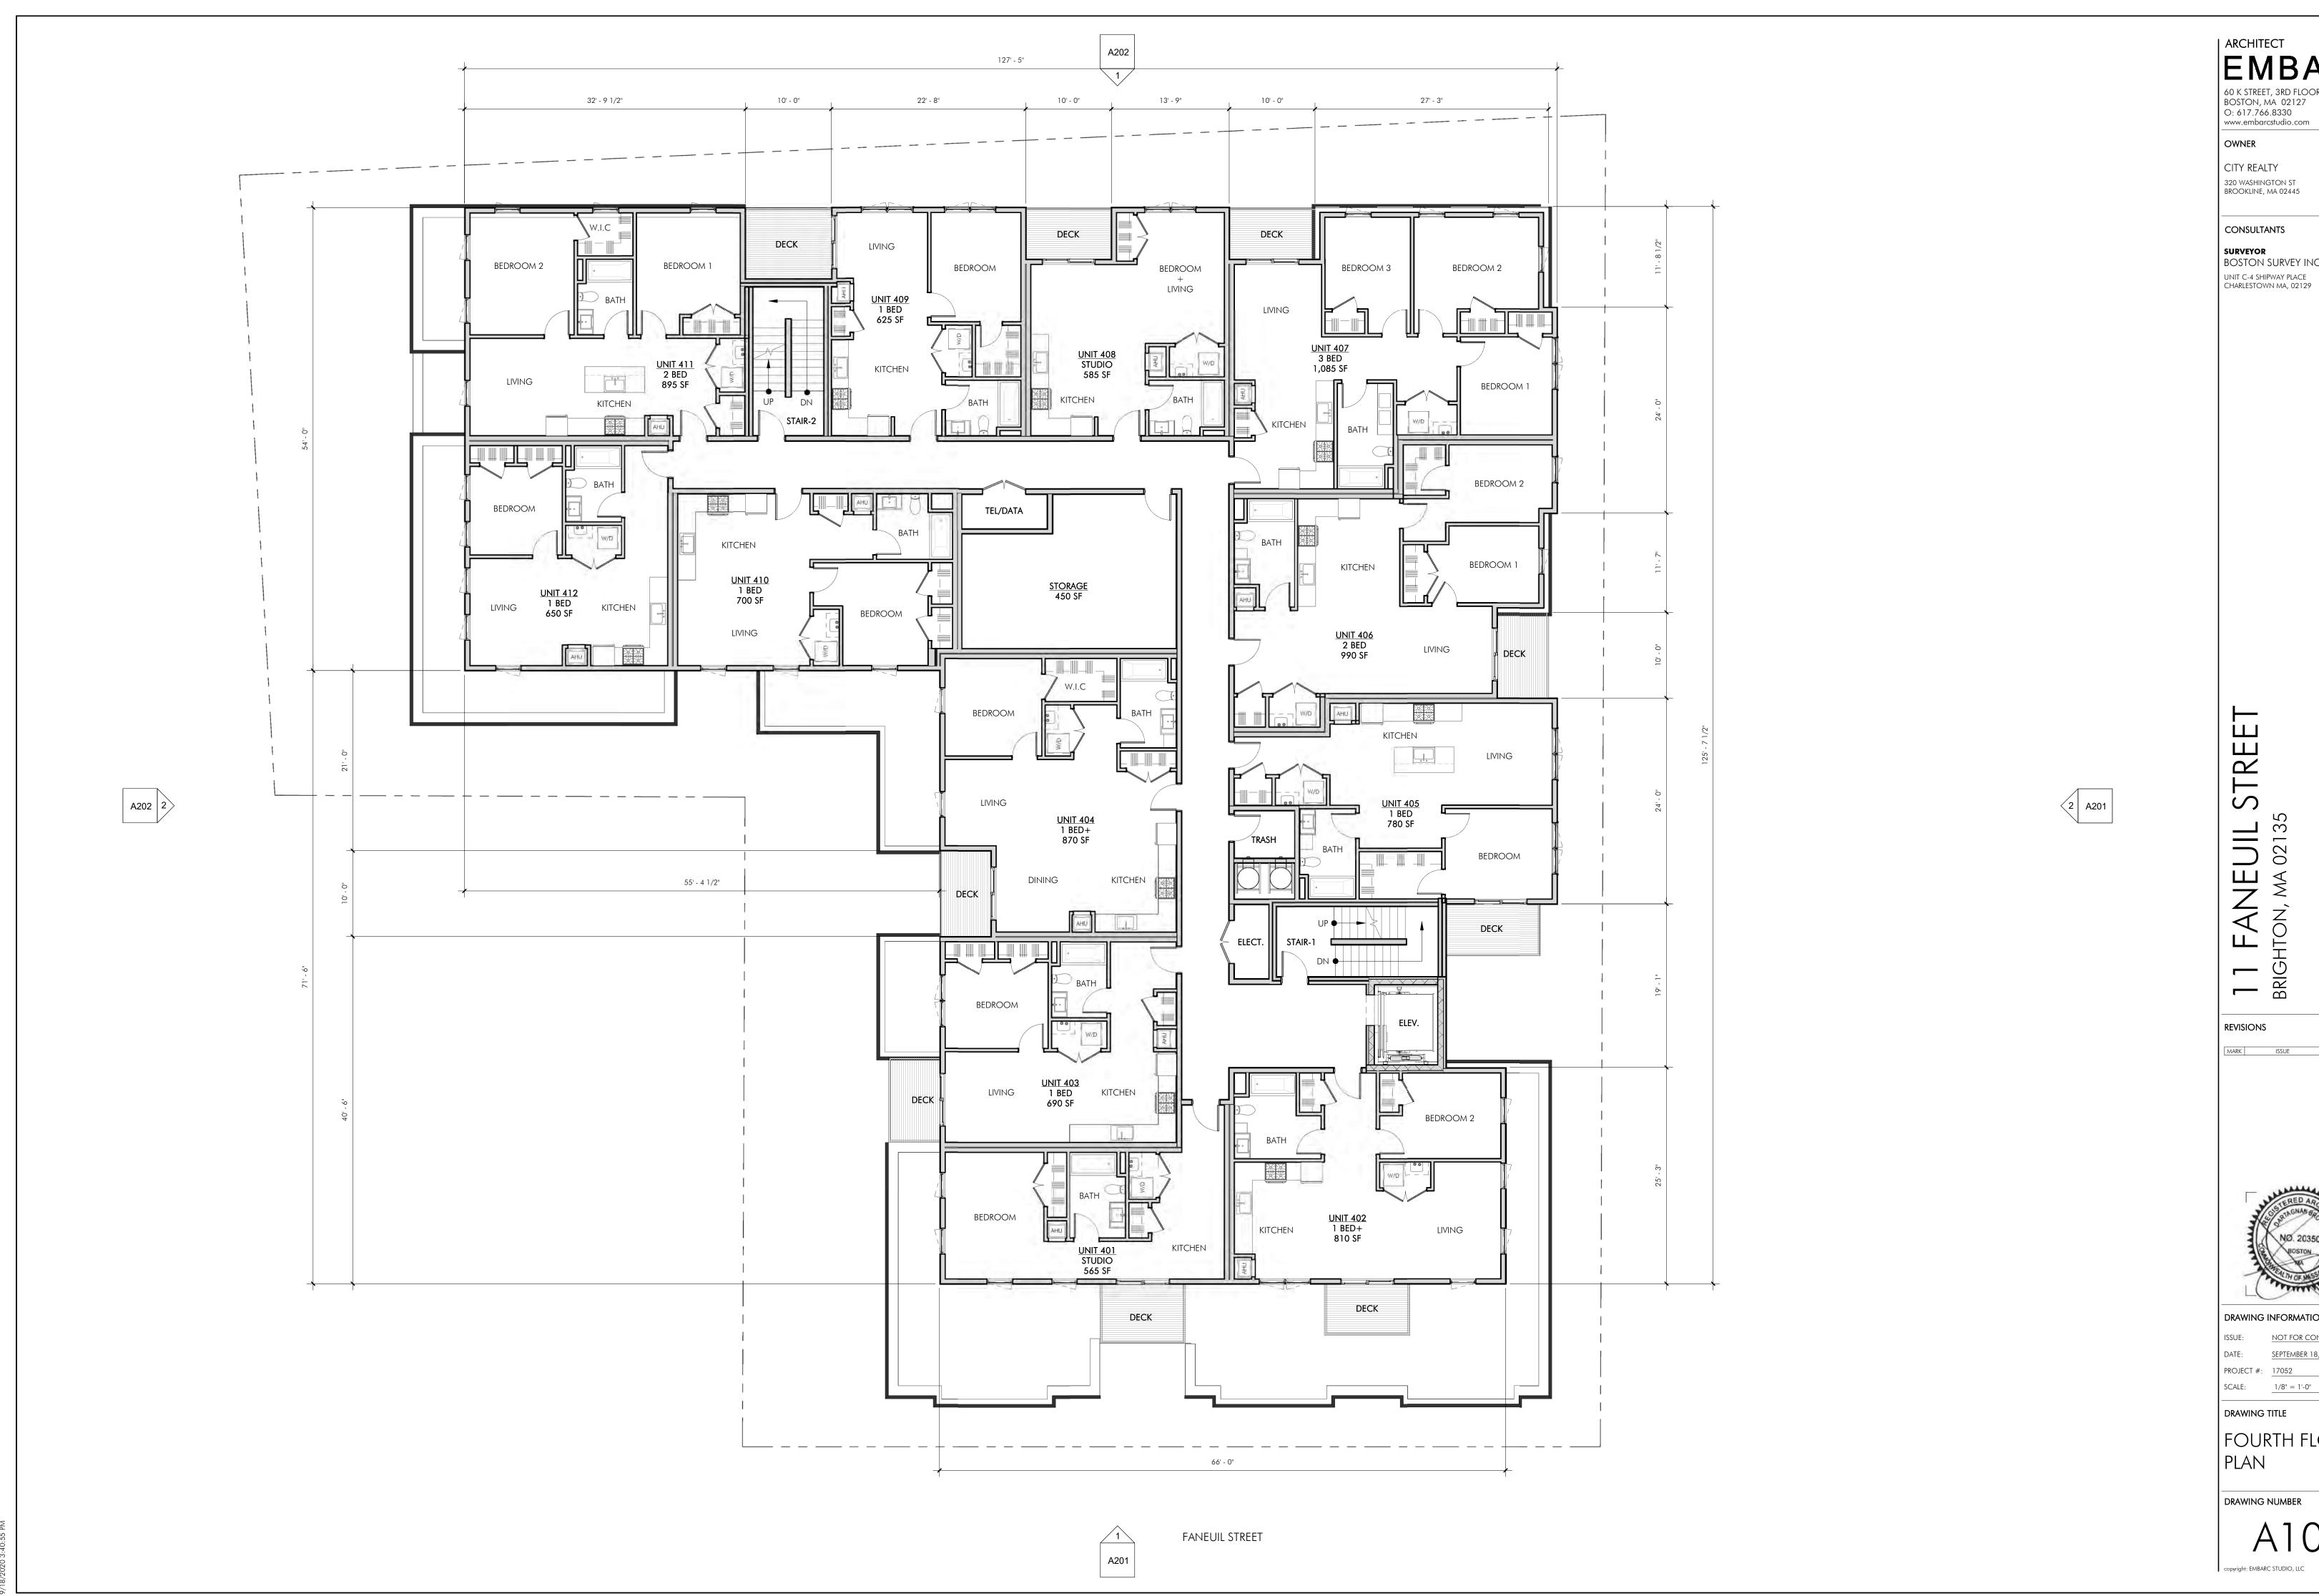

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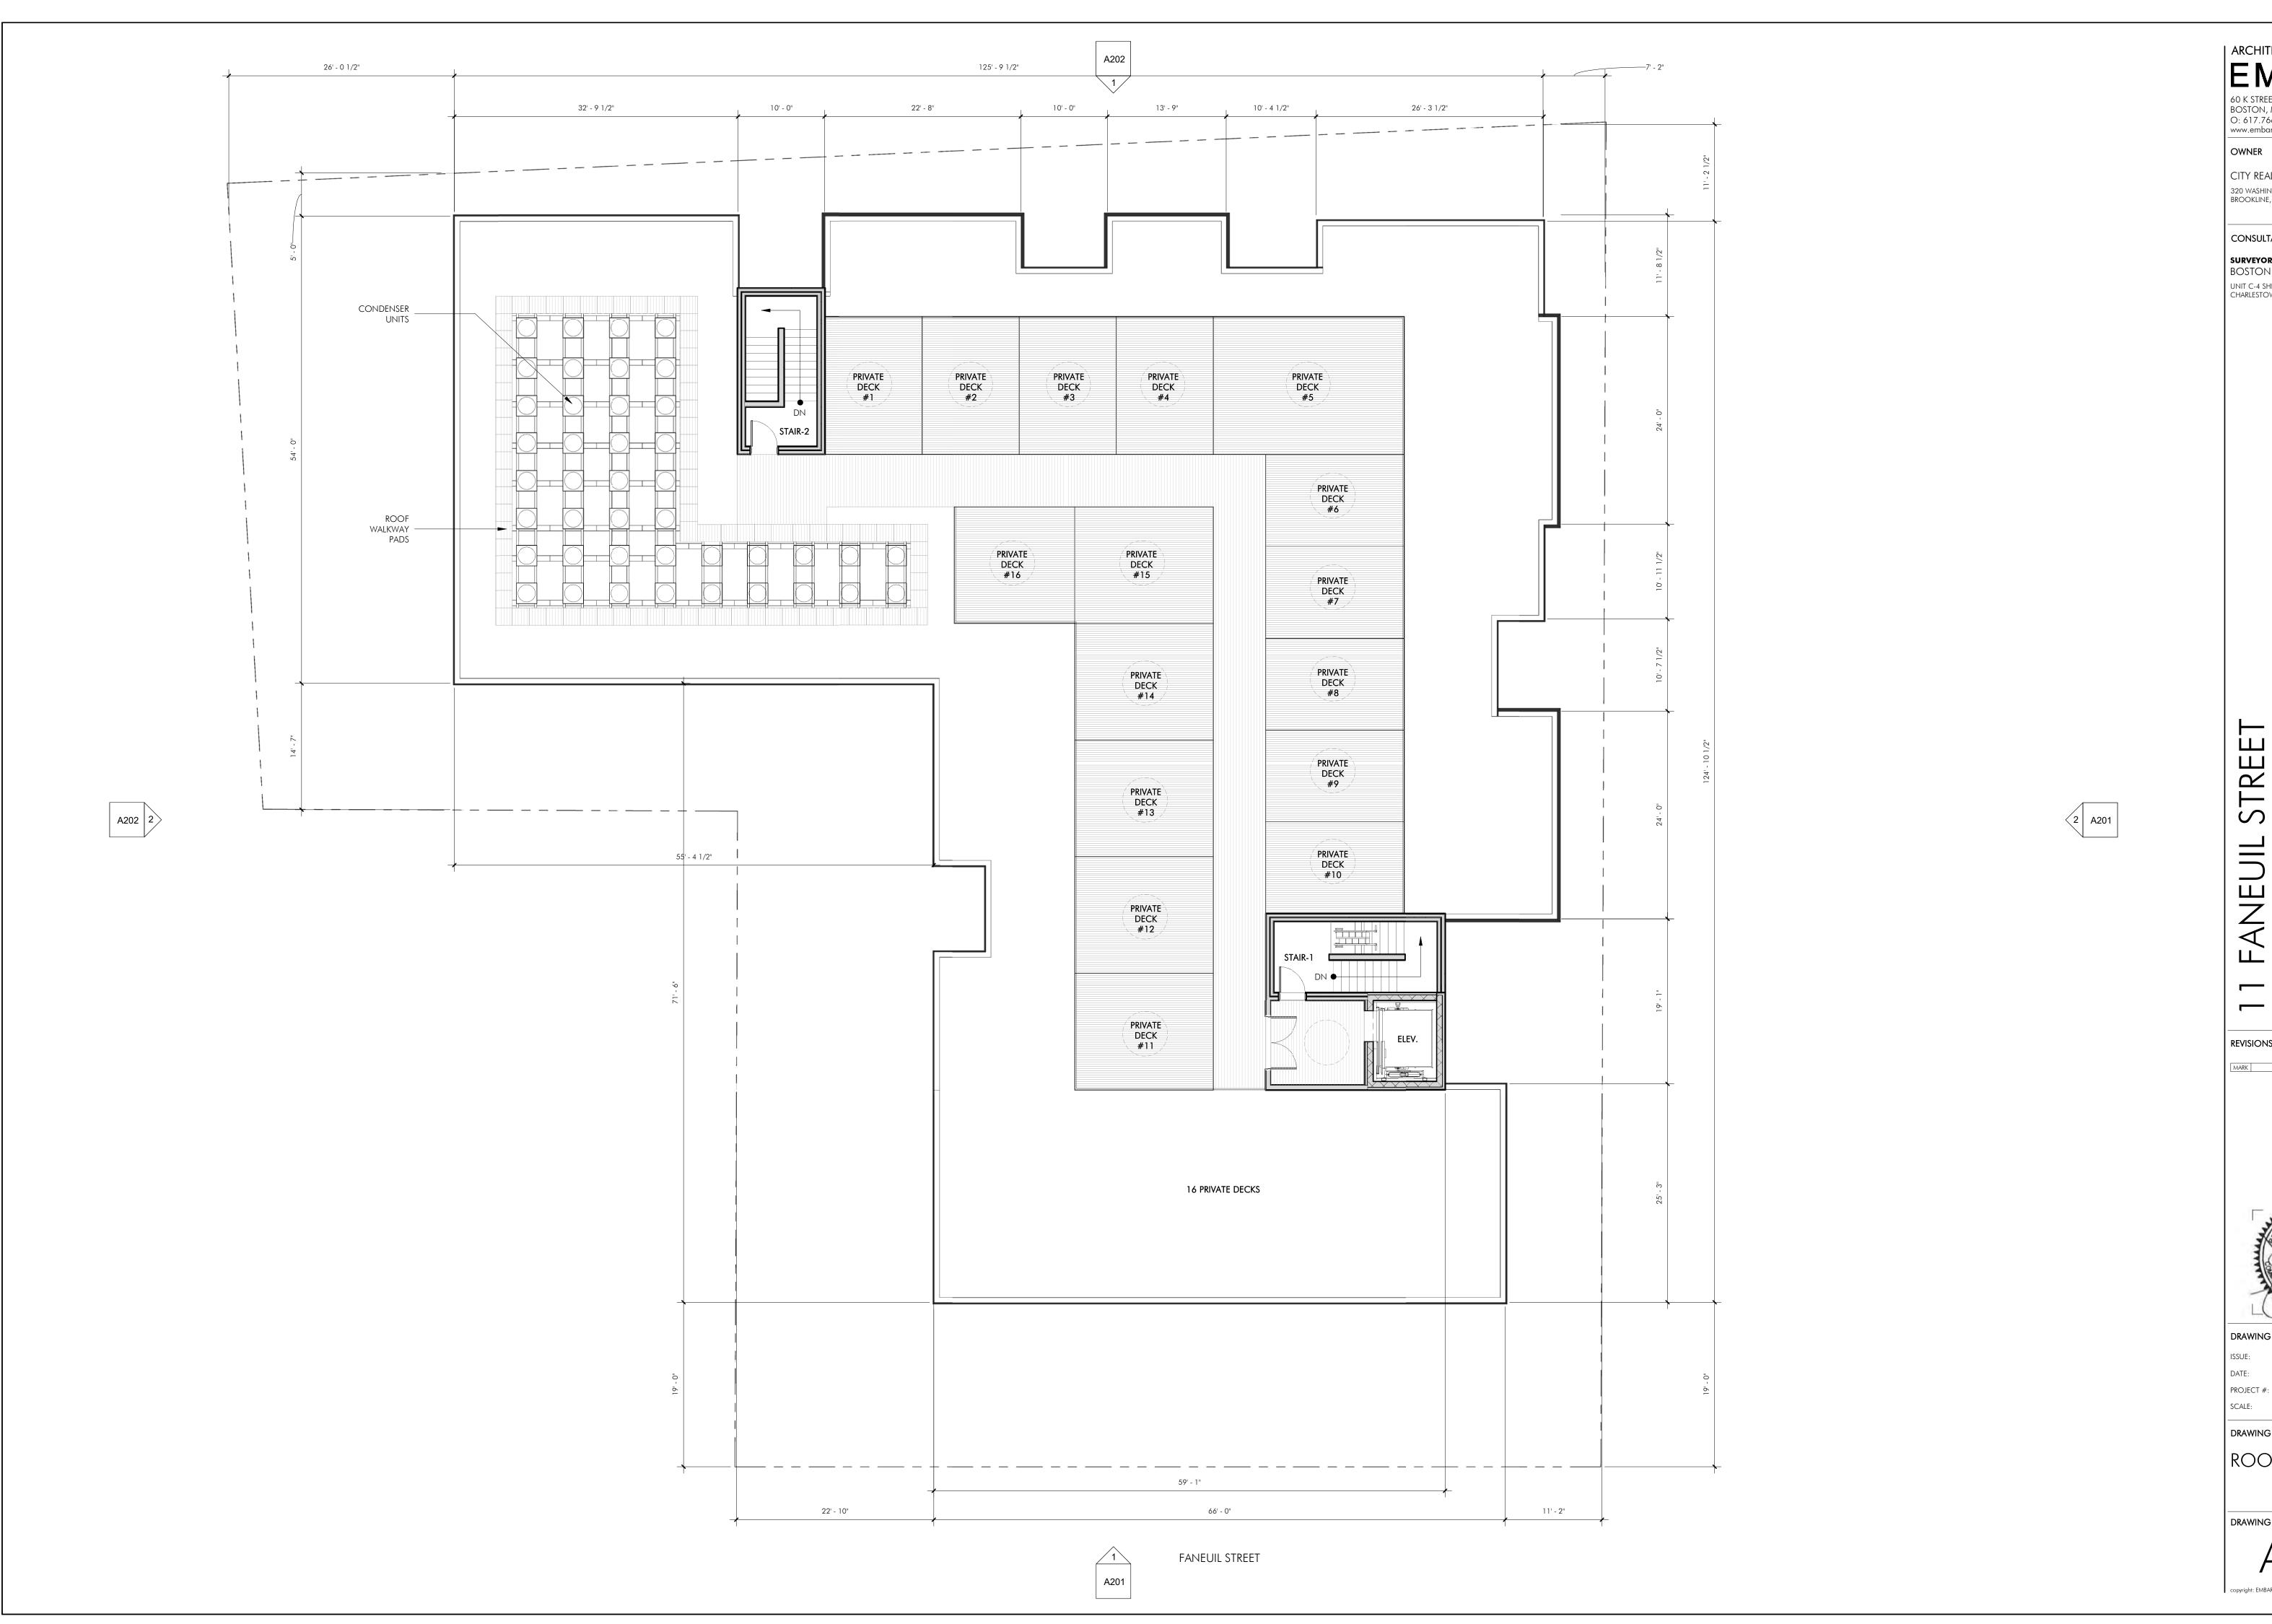
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DRAWING TITLE

FOURTH FLOOR PLAN



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PROJECT #: <u>17052</u> SCALE: 1/8" = 1'-0"

DRAWING TITLE ROOF PLAN

1 02 - SOUTH ELEVATION (FANEUIL ST)



2 03 - EAST ELEVATION (MARKET ST)

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DRAWING TITLE EXTERIOR ELEVATIONS





2 04 - WEST ELEVATION

1/8" = 1'-0"

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ECT #: 17052 E: 1/8" = 1'-0"

EXTERIOR
ELEVATIONS

DRAWING NUMBER

A202