



O'SULLIVAN ARCHITECTS, INC.

ARCHITECTURE | DESIGN | PLANNING 580 MAIN STREET, SUITE 204 READING, MASSACHUSETTS 01867

Tel: (781) 439-6166 Fax: (781) 439-6170 www.osullivanarchitects.com

These drawings and specifications were prepare for use at the location indicated. Publication and use is expressly limited to the identified location. But it is expressly limited to the identified location. But is prohibited without the written permission of OSullivan Architects, Inc. © 2021 O'Sullivan Architects, Inc.

The Bob House

Lodging House

6 Windsor Street Andover, MA

First Floor Plan First Floor RCP



SCALE: As Noted ISSUED / DRAWN BY


2021-05-05 © OSuBvan Architecta Inc.

REVISED / REVISED BY 2021-05-05 - FINAL SET

JOB NO: 20234

SHEET NUMBER

A1.⁻

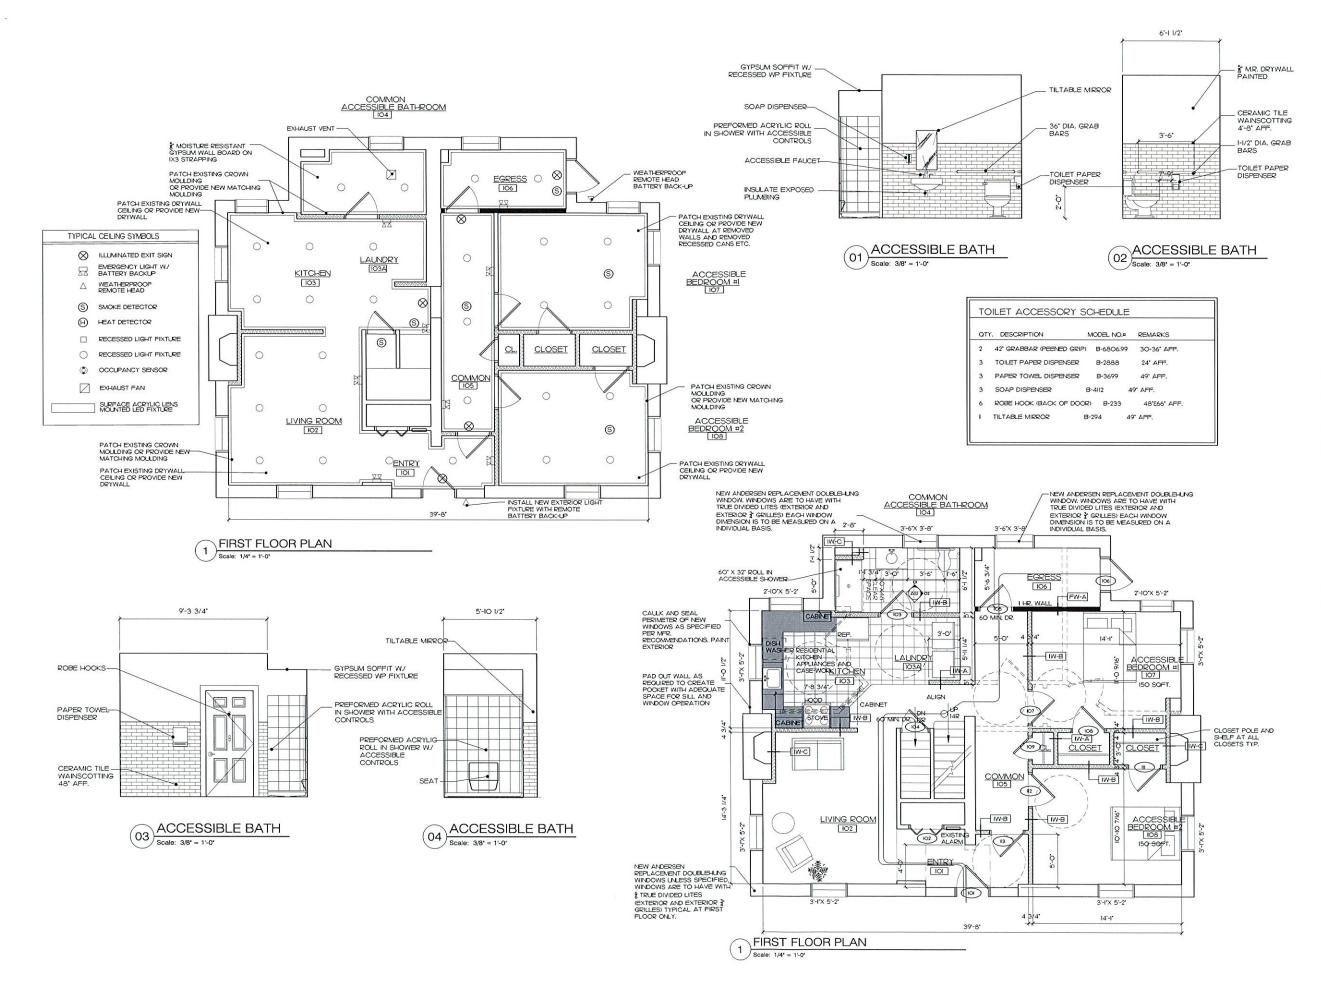



O'SULLIVAN ARCHITECTS, INC.

ARCHITECTURE • DESIGN • PLANNING 580 MAIN STREET, SUITE 204 READING, MASSACHUSETTS 01867

Tel: (781) 439-6166 Fax: (781) 439-6170 www.osullivanarchitects.com

frees crawings and specifications will epidentee for use at the location indicated. Publication are use is expressly limited to the identified location Reuse or reproduction by any method, in whole or in part, is prohibited without the written permission of O'Sullivan Architects, Inc.

© 2021 O'Sullivan Architects Inc.

The Bob House Lodging House

6 Windsor Street Andover, MA

First Floor Plan First Floor RCP



SCALE: As Noted


ISSUED / DRAWN BY 2021-05-05

REVISED / REVISED BY 2021-05-05 - FINAL SET

JOB NO: 20234

SHEET NUMBER


 $A1.^{-1}$

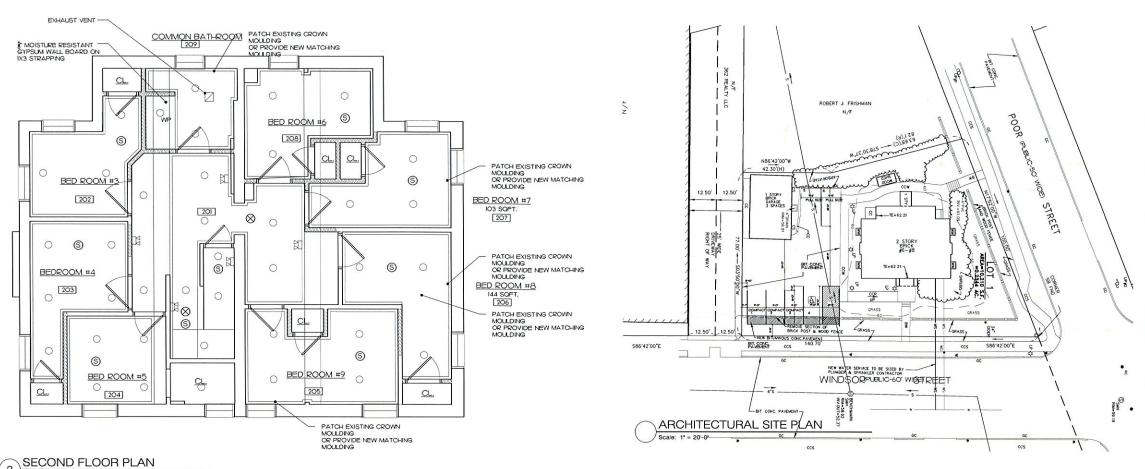

SECOND FLOOR PLAN
Scale: 1/4' = 1'-0'

FINISH SCHEDULE ROOM ROOM NAME VINYL TREADS AND RISERS ACCESSBLE BEDROOM #3
ACCESSBLE BEDROOM #4
COMMON
BEDROOM #5
BEDROOM #5
BEDROOM #6
BEDROOM #7
BEDROOM #7
BEDROOM #9
BEDROOM #10
BEDROOM #10 208 BEDROOM #II
209 BATHROOM
301 NOT IN SCOPE

- FINSHES AND MATERIALS ARE PLEXIBLE TO BE REVIEWED BY CLIENT.
 ALL EXISTING HARDWOOD TO BE PROTECTED THRU-OUT DEMO AND CONSTRUCTION HARDWOOD TO BE PATCHED AS NEEDED WITH LIKE SPECIES.
 HARDWOOD TO BE FINSHED PRICE TO CERTIFICATE OF OCCUPANCY.
 MATCH ADJACERY WOOD BASES IN EACH ROOM.
 EXISTING BASEMENT FLOOR AND CELLING FINISHES TO BE REMAIN.
 EXISTING BASEMENT FLOOR AND CELLING FINISHES TO BE REMAIN.
 EXISTING DRIWHALL TO REMAIN IS TO BE PATCHED AND PAINTED.
 DRYWALL SHALL HAWE I COAT PRIMER AND 2 COATS FINISH.
 PAINT TO BE BENJAMIN MOORE EGGS-BLL ON WALLS AND SEMI-GLOSS ON TRIM.
 ALL CLOSETS TO BE FINISH TO BE APPROVED BY OWNER.
 CARPET TILES TO BE INSISH TO DIE APPROVED BY OWNER.
 CARPET TILES TO BE INSISH TO DIE APPROVED BY OWNER.
 ALL FLOOR FINISH TO BE INSTALLED PER MANUFACTURES RECOMMEDIATIONS.
 LAY-IN CELLING GRID AND PIXTURES INSTALLATION PER MER AND BUILDING COOES REQUIREMENTS.

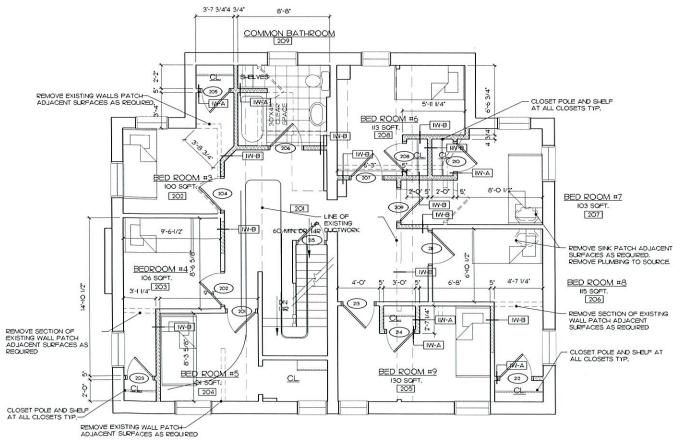



O'SULLIVAN ARCHITECTS, INC.

ARCHITECTURE DESIGN PLANNING 580 MAIN STREET, SUITE 204 READING, MASSACHUSETTS 01867

Tel: (781) 439-6166 Fax: (781) 439-6170 www.osullivanarchitects.com

2021 O'Sullivan Architects Inc.

The Bob House Lodging House

6 Windsor Street Andover, MA

Second Floor Plan Second Floor RCP Finish Schedule Arch. Site Plan



SCALE: As Noted

ISSUED / DRAWN BY

2021-05-05

REVISED / REVISED BY 2021-05-05 - FINAL SET

JOB NO: 20234


SHEET NUMBER

DOOR	DOOR SIZE WXHXT	DOOR			FRAME		FIRE RATED	CI OSER	DOOR	HARDWARE	REMARKS
		TYPE	MATL	GLAZING	TYPE	MATL	TIRL RATED	CLOSER	11	HARDITARL	REMARKS
воі	3'-O" X 6'-8" X 1-3/4"	3	MTL/INSUL		В	METAL	I HOUR	0	BOI	PB, BB, S	MAXIMIZE DOOR WIDTH IN EXIST. WALL
BO2	3'-0' X 6'-8' X 1-3/4'	EXIST	MTL/INSUL		EXIST.	WOOD		0	BO2	PB, BB, W, T	REVIEW CONDITION IN FIELD
101	3'-O' X 6'-8' X I-3/4"	1	WOOD		В	WOOD		0	IOI	LO, BB, W, T, KP	
102	3'-O" X 6'-8" X 1-3/4"	EXIST	MDF		EXIST.	WOOD			102	EXISTING	
103	3'-O" X 6'-8" X 1-3/4"	1	MDF		Α	WOOD		00-04-0-0-0-	103	LO, BB, S,	
104	2-6" × 6"-8" × 1-3/4"	3	WOOD		В	METAL	I HOUR	0	104	LA, BB, S,	
105	3'-O" X 6'-8" X 1-3/4"	3	WOOD		В	METAL	I HOUR	0	105	LA, BB, S,	
106	3'-O" X 6'-8" X 1-3/4"	EXIST	WOOD		Α	WOOD		0	106	LS, BB, S,	
107	3'-O* X 6'-8* X 1-3/4*	1	MOF		Α	WOOD			107	LO, BB, S,	
108	3'-O" X 6'-8" X 1-3/4"	1	MDF		Α	WOOD			108	LA, BB, S,	
109	2-0" X 6'-8" X 1-3/4"	1	MDF		Α	WOOD			109	LO, BB, S,	
110	3'-0" X 6'-8" X I-3/4"	1	MDF		Α	WOOD			110	LO, BB, S.	
111	3'-O" X 6'-8" X I-3/4"	1	MDF		Α	WOOD			111	LA, BB, S,	
112	3'-O" X 6'-8" X I-3/4"	1	MDF		Α	WOOD			112	LO, BB, S,	
113	3'-O" X 6'-8" X 1-3/4"	1	MDF		Α	WOOD			113	LA, BB, S,	
201	3'-O' X 6'-8' X 1-3/4'	1	MDF		A	WOOD			201	LO, BB, S,	
202	3'-O' X 6'-8' X 1-3/4"	1	MDF		Α	WOOD			202	LO, BB, S,	
203	2-6" X 6'-8" X I-3/4"	1	MDF		Α	WOOD			203	LA, BB, S,	
204	3'-O' X 6'-8' X 1-3/4"	1	MDF		Α	WOOD	server on reverse		204	LO, BB, S,	
205	3'-O" X 6'-8" X 1-3/4"	1	MDF		Α	WOOD			205	LO, BB, S,	
206	3'-0" X 6'-8" X I-3/4"	1	MDF		Α	WOOD			206	LO, BB, S,	
207	3'-O' X 6'-8' X I-3/4"	1	MDF		Α	WOOD			207	LO, BB, S,	
208	2'-6" X 6'-8" X I-3/4"	1	MDF		Α	WOOD			208	LA, BB, S,	
209	3'-O' X 6'-8' X I-3/4"	1	MDF		Α	WOOD			209	LO, BB, S,	
210	2-8" X 6'-8" X 1-3/4"	1	MOF		Α	WOOD			210	LA, BB, S,	
211	3'-O" X 6'-8" X I-3/4"	1	MOF		Α	WOOD			211	LO, BB, S,	
212	3'-0" X 6'-8" X 1-3/4"	1	MDF		Α	WOOD			212	LO, BB, S,	
213	3'-0" × 6'-8" × 1-3/4"	1	MDF		Α	WOOD			213	LO, BB, S,	
214	2-6" X 6'-8" X I-3/4"	1	MDF		Α	WOOD	L.,		214	LA, BB, S,	
	2-6" X 6'-8" X I-3/4"	3	WOOD		В	METAL	I HOUR	0	215	LS, BB, S,	







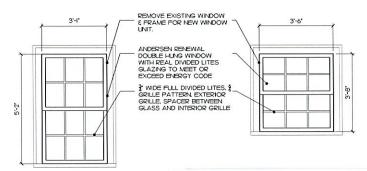


TYPICAL 6/6 UNITS

REAR UNIT 6/6

FIRST FLOOR WINDOW REPLACEMENT

NOTE: ALL WINDOW CASINS, SILLS, APRONS, ETC. SHALL BE TESTED FOR LEAD PAINT PER ALL APPLICABLE CODES, ALL NON-LEAD CASINSS ETC WAY BE REWOKED. ALL CONTAMINATED TRIM SHALL BE REMOVED OFF SITE PER ALL FEDERAL, STATE AND LOCAL CODES. NEW TRIM SHALL BE REPLICATED TO MATCH THE EXISTING.

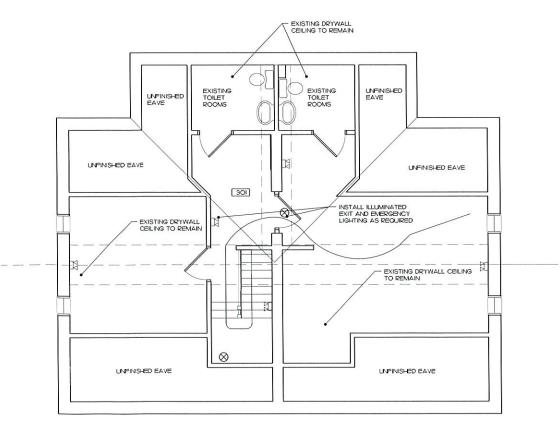

ATTIC FLOOR PLAN (NOT IN SCOPE) (3)






CONTRACTOR TO SALVAGE AND REUSE DOOR AND FRAMES TO MAXIMUM EXTENT POSSIBLE



DOOR TYPES

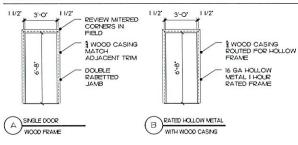

FRAME TYPES

HARDWARE NOTES

- I. G.C. SHALL PREPARE AND SUBMIT COMPLETE AND DETAILED DOOR AND FRAME SCHEDULE AND SHOP DRAWINGS FOR ACCEPTANCE.
- GC. SHALL PREPARE AND SUBMIT COMPLETE AND DETAILED HARDWARE SCHEDLLE AND CATALOG CUTS FOR ACCEPTANCE BY ARCHITECT AND APPROVAL BY OWNER, ALL PRODUCTS SUBMITTED SHALL REPLECT THE INTENT OF THE DRAWINSS, BE COORDINATED WITH ASSOCIATED EQUIPMENT AND MEET ALL APPLICABLE COOES.
- 2. ALL HARDWARE SETS SHALL BE AS MANUFACTURED BY, (UNO.)
 MANUF: SCHLAGE L SERIES
 LEYER DESIGN NEPTLME (MATCH EXISTING) W/ A-WROUGHT ROSE ESCUTCHEON
 FINISH US4 (PUBLIC) AND FINISHSTAINLESS STEEL (EMPLOYEE AREAS) ALL LOCKSETS SHALL HAVE FULL SIZE INTERCHANGABLE CORE CYLINDERS. MATCH EXISTING SMC CHAPEL CORES.
- 4. DOOR CLOSERS SHALL BE LCN 1460. FINISHES ALUMINUM.
- 5. ALL DOOR TO HAVE LEVER HANDLED HARDWARE UNLESS NOTED OTHERWISE.
- 6. GC TO WORK WITH THE OWNERS AND THEIR SECURITY CONSULTANT.

PREFERRED MANUFACTURERS

HINGES - STANLEY BALL BEARING DOOR CLOSERS - HEAVY DUTY LCN CYLINDER LOCKS & DEADBOLTS - SCHLAGE SCI CONSTRUCTION CORES



- ALUM ALUMINUM STOREFRONT FRAME
- B 11/2 PAIR OF BALL BEARING BUTT HINGE (STEEL AT INT.) (STAINLESS AT EXT.)
- BB 2 PAIR OF STAINLESS STEEL BALL BEARING BUTT HINGES (STEEL AT INT.) (STAINLESS AT EXT.)
- CH COAT HOOK (MOUNTED ON BACK OF DOOR) DB - DEAD BOLT (KEYED BOTH SIDES)
- DH . DUMMY HANDLES
- DS . DOOR STOP (FLOOR OR WALL MOUNTED). FB . FLUSH BOLTS TOP AND BOTTOM
- HM 16G. HOLLOW WELDED METAL FRAME HM/WD • 16G. HOLLOW WELDED METAL FRAME WITH WOOD TRIM • PUBLIC SIDES
- HO HOLD OPEN FUNCTION ON CLOSER
- KP . KICK PLATE
- LA . LATCHSET (PASSAGE FUNCTION) LP . LOCKSET (PRIVACY FUNCTION)
- LO . LOCKSET (OFFICE DOORS KEYED OUTSIDE PUSH BUTTON INSIDE) (VESTIBULE DOORS KEYED CYLINDER DEABOLTS . BOTH SIDES)
- LS LOCKSET STOREROOM ALWAYS LOCKED (KEYED) OUTSIDE -ALWAYS UNLOCKED INSIDE
- MH . MAGNETIC HOLD
- OI OCCUPANCY INDICATOR DEADBOLT
- PB PANIC BAR (EGRESS ONLY)
- PP PUSH/PULL S - SILENCERS - HAGER
- T . 1/2" HIGH MAX ACCESSIBLE THRESHOLD
- W WEATHER STRIPPING AT PERIMETER



O'SULLIVAN ARCHITECTS, INC.

ARCHITECTURE *DESIGN * PLANNING 580 MAIN STREET, SUITE 204 READING, MASSACHUSETTS 01867

Tel: (781) 439-6166 Fax: (781) 439-6170 www.osullivanarchitects.com

© 2021 O'Sullivan Architects Inc

The Bob House Lodging House

6 Windsor Street Andover, MA

Attic Floor Plan Door Schedule Window Replacement



SCALE: As Noted

ISSUED / DRAWN BY 2021-05-05

REVISED / REVISED BY 2021-05-05 - FINAL SET

JOB NO: 20234

SHEET NUMBER