

SCALE: 1/4"=1'-0"

**GENERAL NOTES:** 

-PASS THROUGH BETWEEN LAB AND RESTROOMS.

-ALL OFFICES AND EXAM ROOM DOORS MUST BE SECURE WITH LOCK.

-WALL CABINETS ABOVE COUNTERTOPS IN EXAM ROOMS AIN IN LABORATORY AREA.

-GLASS DOORS IN FOYER TO REMAIN. -GLASS WALL: THE WALL IN THE WAITING ROOM BETWEEN THE ADMINISTRATIVE AREAS (CHECK IN, CHECK OUT, AND CLINIC ADMINISTRATORS OFFICE) AND THE WAITING ROOM WILL BE GLASS.

GLASS STARTS 4 FOOT OFF THE GROUND AND GOES ALL THE WAY TO THE CEILING. -PRIVATE CHECK IN ROOM WILL BE GLASS WALLS STATING AT 4 FLOOR OFF

-COUNTER TOP WITH DRAWER STAND AT EACH END (CENTER OPEN FOR LEG SPACE) ADMIN AREAS AND LAB REQUIRES ADDITIONAL CABINETS ON BASE AND WALLS AND COUNTERTOP SHOULD BE AT WRITING LEVEL IN ADMINISTRATIVE AREAS. EACH EXAM ROOM NEEDS ONE LOCKING WALL CABINET. CABINETS UNDER SINKS, EITHER DO NO HAVE DOORS OR DOORS MUST BE SCREWED CLOSED.

-FLOORING: ANY AREA WITH SINK WILL BE TILE FLOOR. ALL HALLWAYS, OFFICES, WAITING AREAS AND ANY ROOM WITHOUT A SINK WILL BE CARPETED. EXCEPTION: WAITING ROOM WILL BE CARPETED EXCEPT AREA IMMEDIATELY IN FRONT OF COFFEE AREA WILL BE TILED.

-FIRE EXTINGUISHERS MUST BE RECESSED INTO WALL INSIDE A WALL CABINET.

-RECESSED CABINET IN WALL FOR AED (AUTOMATIC EXTERNAL DEFIBRILLATOR).

-CHAIR RAIL IN WAITING ROOMS AND GROUP THERAPY.

-FRONT ENTRANCE DOORS AND ATRIUM DOORS MUST HAVE HANDICAP ACCESS DOOR OPENER BUTTONS INSTALLED.

-THE DOORS IN BATHROOMS, STORAGE ROOMS, AND BREAK AREAS NEED AUTOMATIC DOOR CLOSER'S INSTALLED.

-DOORS ARE TO OPEN INTO THE ROOM AND NOT OPEN INTO THE HALLWAYS.

-NO DOORS ARE NEEDED FOR: LABORATORY AREA.

-THE BUILDOUT MUST MEET LOCAL, STATE, AND NATIONAL FIRE SAFETY CODES (I.E., EMERGENCY LIGHTING MUST BE INSTALLED).

-KEYS TO ALL ROOMS TO BE ON A MASTER KEY SYSTEM.

-FULL SIZED REFRIGERATOR WITH FREEZER COMPARTMENT LOCATED IN LABORATORY, MEDICATION AREA, AND EMPLOYEE BREAK ROOM. THE REFRIGERATOR IN MEDICATION MUST HAVE A PADLOCK INSTALLED ON BOTH THE FREEZER AND THE REFRIGERATOR SECTION.

-IT IS IMPORTANT THAT THERE BE AUDITORY PRIVACY IN THE CLINIC AREA (EXAM ROOMS, PROVIDER OFFICES, AND MENTAL HEALTH AREA (THERAPIST OFFICES AND GROUP THERAPY ROOM). INTERIOR WALLS AND/OR CEILING MAY NEED ADDITIONAL INSULATION.

-EACH EXAM ROOM NEEDS A SHELF MOUNTED UNDER COUNTER TOP ON THE SIDE OF THE CABINET. THIS SHELF WILL HOLD A COMPUTER. -X-RAY ROOMS FOUR OUTER WALL MUST USE LEAD LINED SHEETROCK FROM GROUND TO 8FOOT

-X-RAY ROOM TO BE DESIGNED BY PHYSICIST PROVIDED BY VALOR HEALTHCARE, INC.

-X-RAY PROCESSOR ROOM WILL HAVE A LEADED GLASS VIEW WINDOW. -X-RAY PROCESSOR ROOM WILL NEED SPECIAL ELECTRICAL PIGTAIL DETERMINED BY X-RAY UNIT

INSTALLER. -X-RAY DOOR MUST BE METAL DOOR WITH MINIMUM OF 1 HOUR FIRE RATING

-REFRIGERATOR IN BREAK ROOM MUST HAVE ICE MACHINE BUILT IN.

-ALL STORAGE ROOMS MUST HAVE STORE ROOM FUNCTION LOCK'S.

-EVERY SINK IS TO HAVE EMOTION TOWEL DISPENSER INSTALLED GP ENMOTION TOWL DISPENSER-BLUE (PH2990) \$82 EACH ORDERED FROM U-CLEAN AT WWW.UCLEAN.COM/CATALOG/PRODUCTINFO/ PAPER\_PRODUCST/DIPENSERS/ENMOTION\_TOWEL\_DISPENSER\_BLUE.HTML?SESSID= A01AD7D2EE053850CB8CA6DF50089E60.

-THERMOSTAT-THE COMMUTATE CEM 24 SUPER WILL BE INSTALLED ALL AC/HEATING UNITS. -USE FIRE TAPE/CAULK TO COVER ALL PENITRATIONS IN WALLS.

-CONFERENCE ROOM, RIGHT SIDE CLOSET: INSTALL FIRE BOARD AND TAPE SPLICE IN WALL. KEY SCHEDULE

MASTER KEY: OPEN EVERY DOOR

TALL.

KEY\*1: OPENS DOOR A(1) (MAIN ENTRANCE DOOR)

KEY \*2: OPENS DOORS H,P,R,T,Z (X-RAY ROOM,MULTIPURPOSE ROOM, VAHANNY STAFF OFFICE, OFFICE \*3)

KEY \*3: OPENS DOOR E,F,O,K,Q (CLINIC ADMINISTRATION, CHECK-IN/OUT, MEDICAL PROVIDER 1 AND 2, PHARMACY STORAGE, AND STORAGE #2)

KEY \*4: OPENS DOORS U,X,N (CONFERENCE ROOM, CONFERENCE ROOM CLOSET, AND BIO-HAZARD ROOM. GENERAL NOTE:

ALL OF THE FOLLOWING ROOMS ARE TO RECEIVE STORAGE LOCKS SETS: BIO-HAZARD ROOM, UTILITY ROOM, PHARMACY, AND STORAGE ROOMS

CONTRACTOR SHALL VERIFY ALL

FABRICATING ANY WORK.

CONDITIONS AND DIMENSIONS AT THE JOB SITE AND NOTIFY THE ARCHITECT OF ANY


DIMENSIONAL ERRORS, OMISSIONS OR DISCREPANCIES BEFORE BEGINNING OR

Date



PROJECT: \\David-vxhl7gduw\projects on rich-2006\VA CLINIC\VA LAYOUT.layout


DATE Friday, August 22, 2008

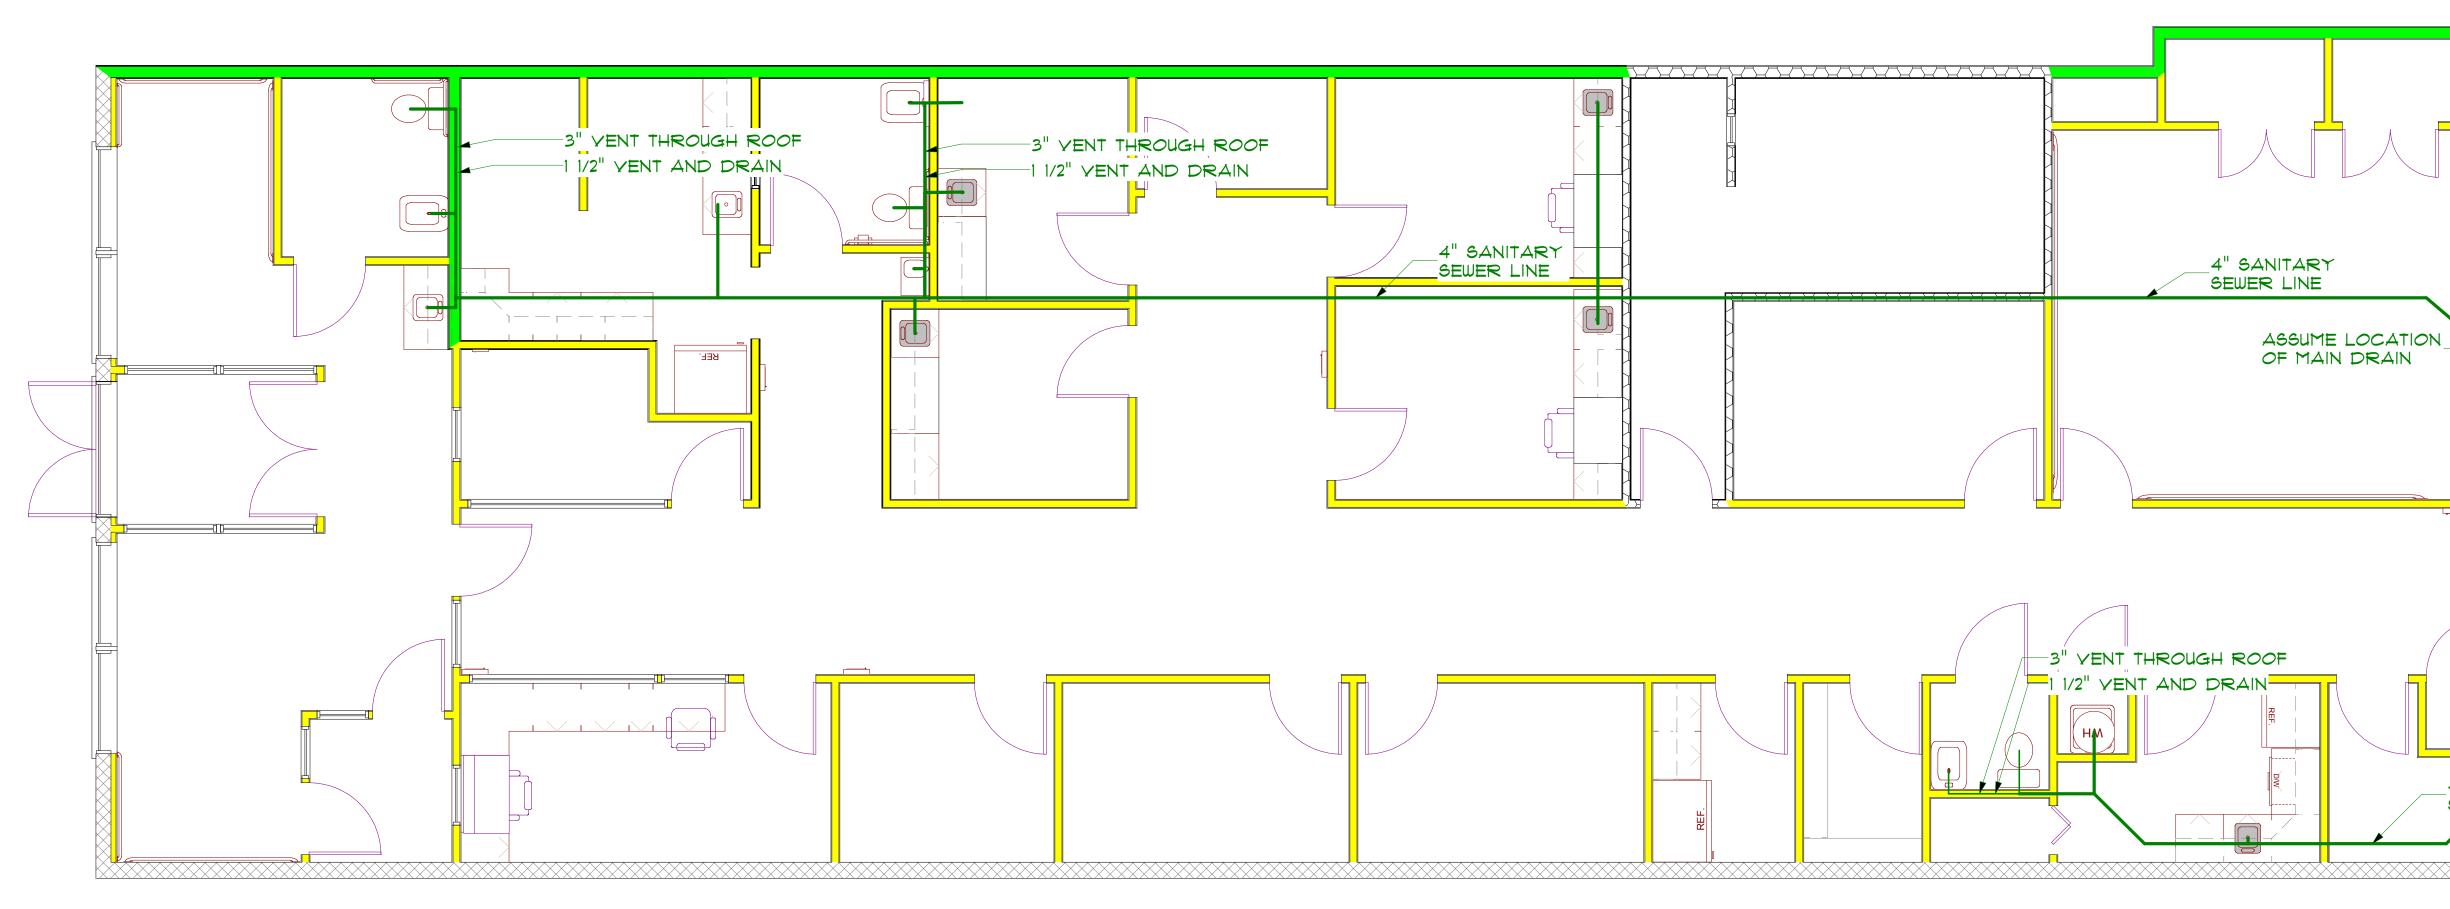





## SANITARY SEWER

SCALE: 1/4"=1'-0"

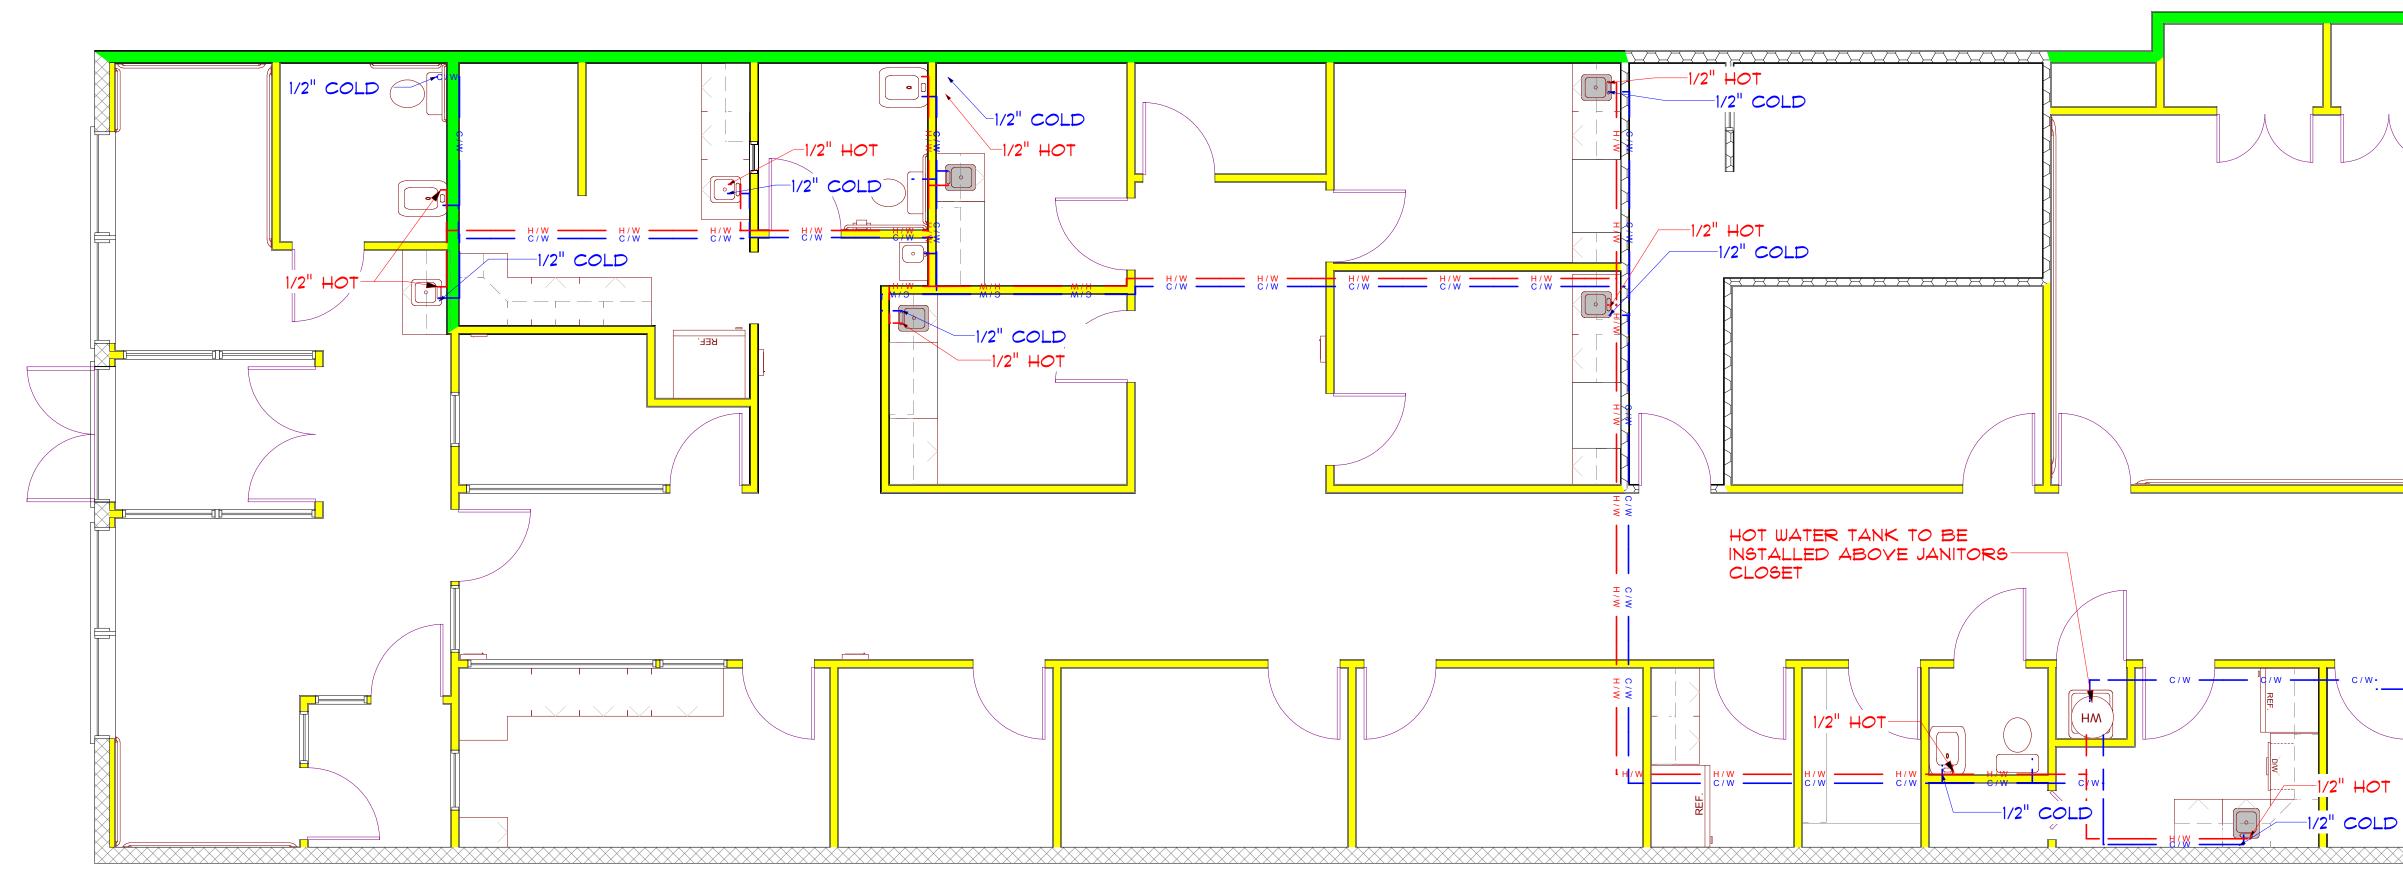



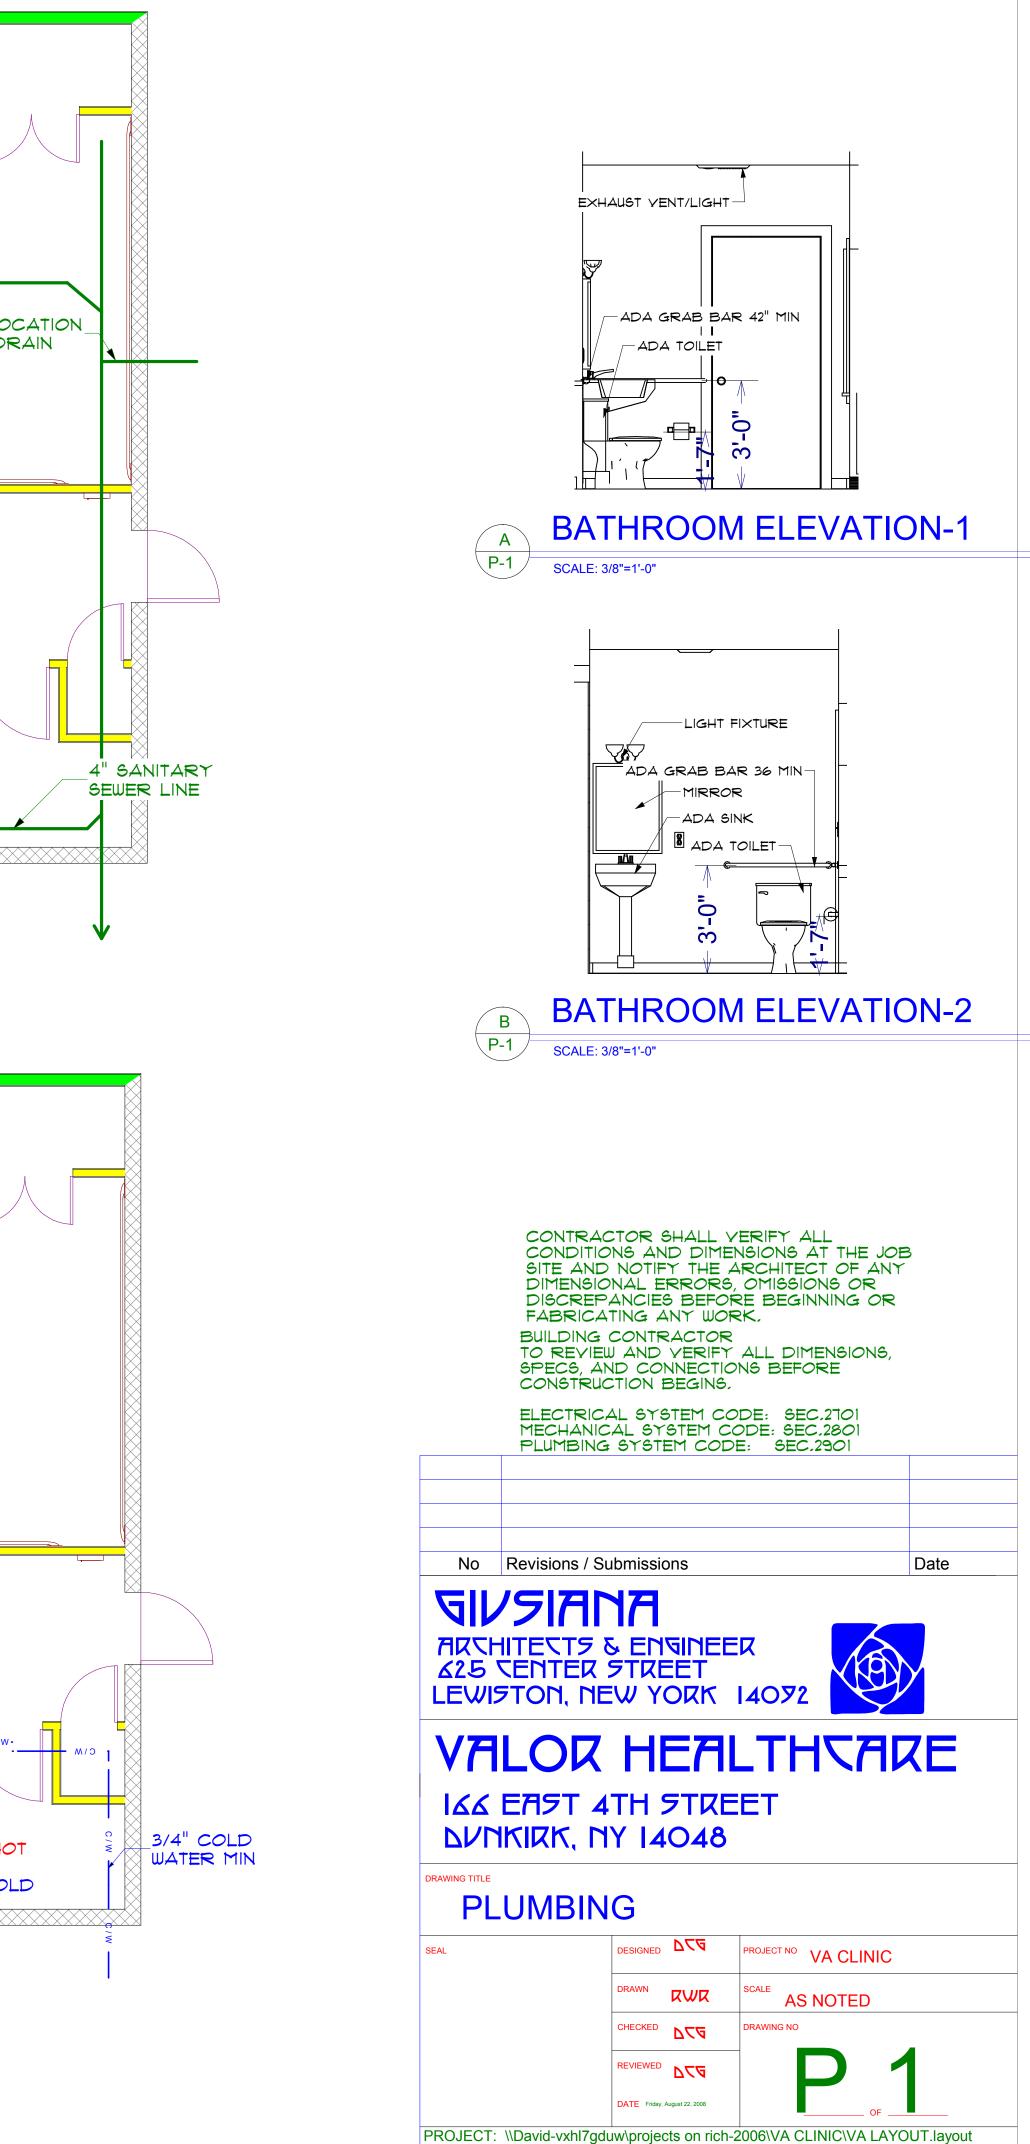

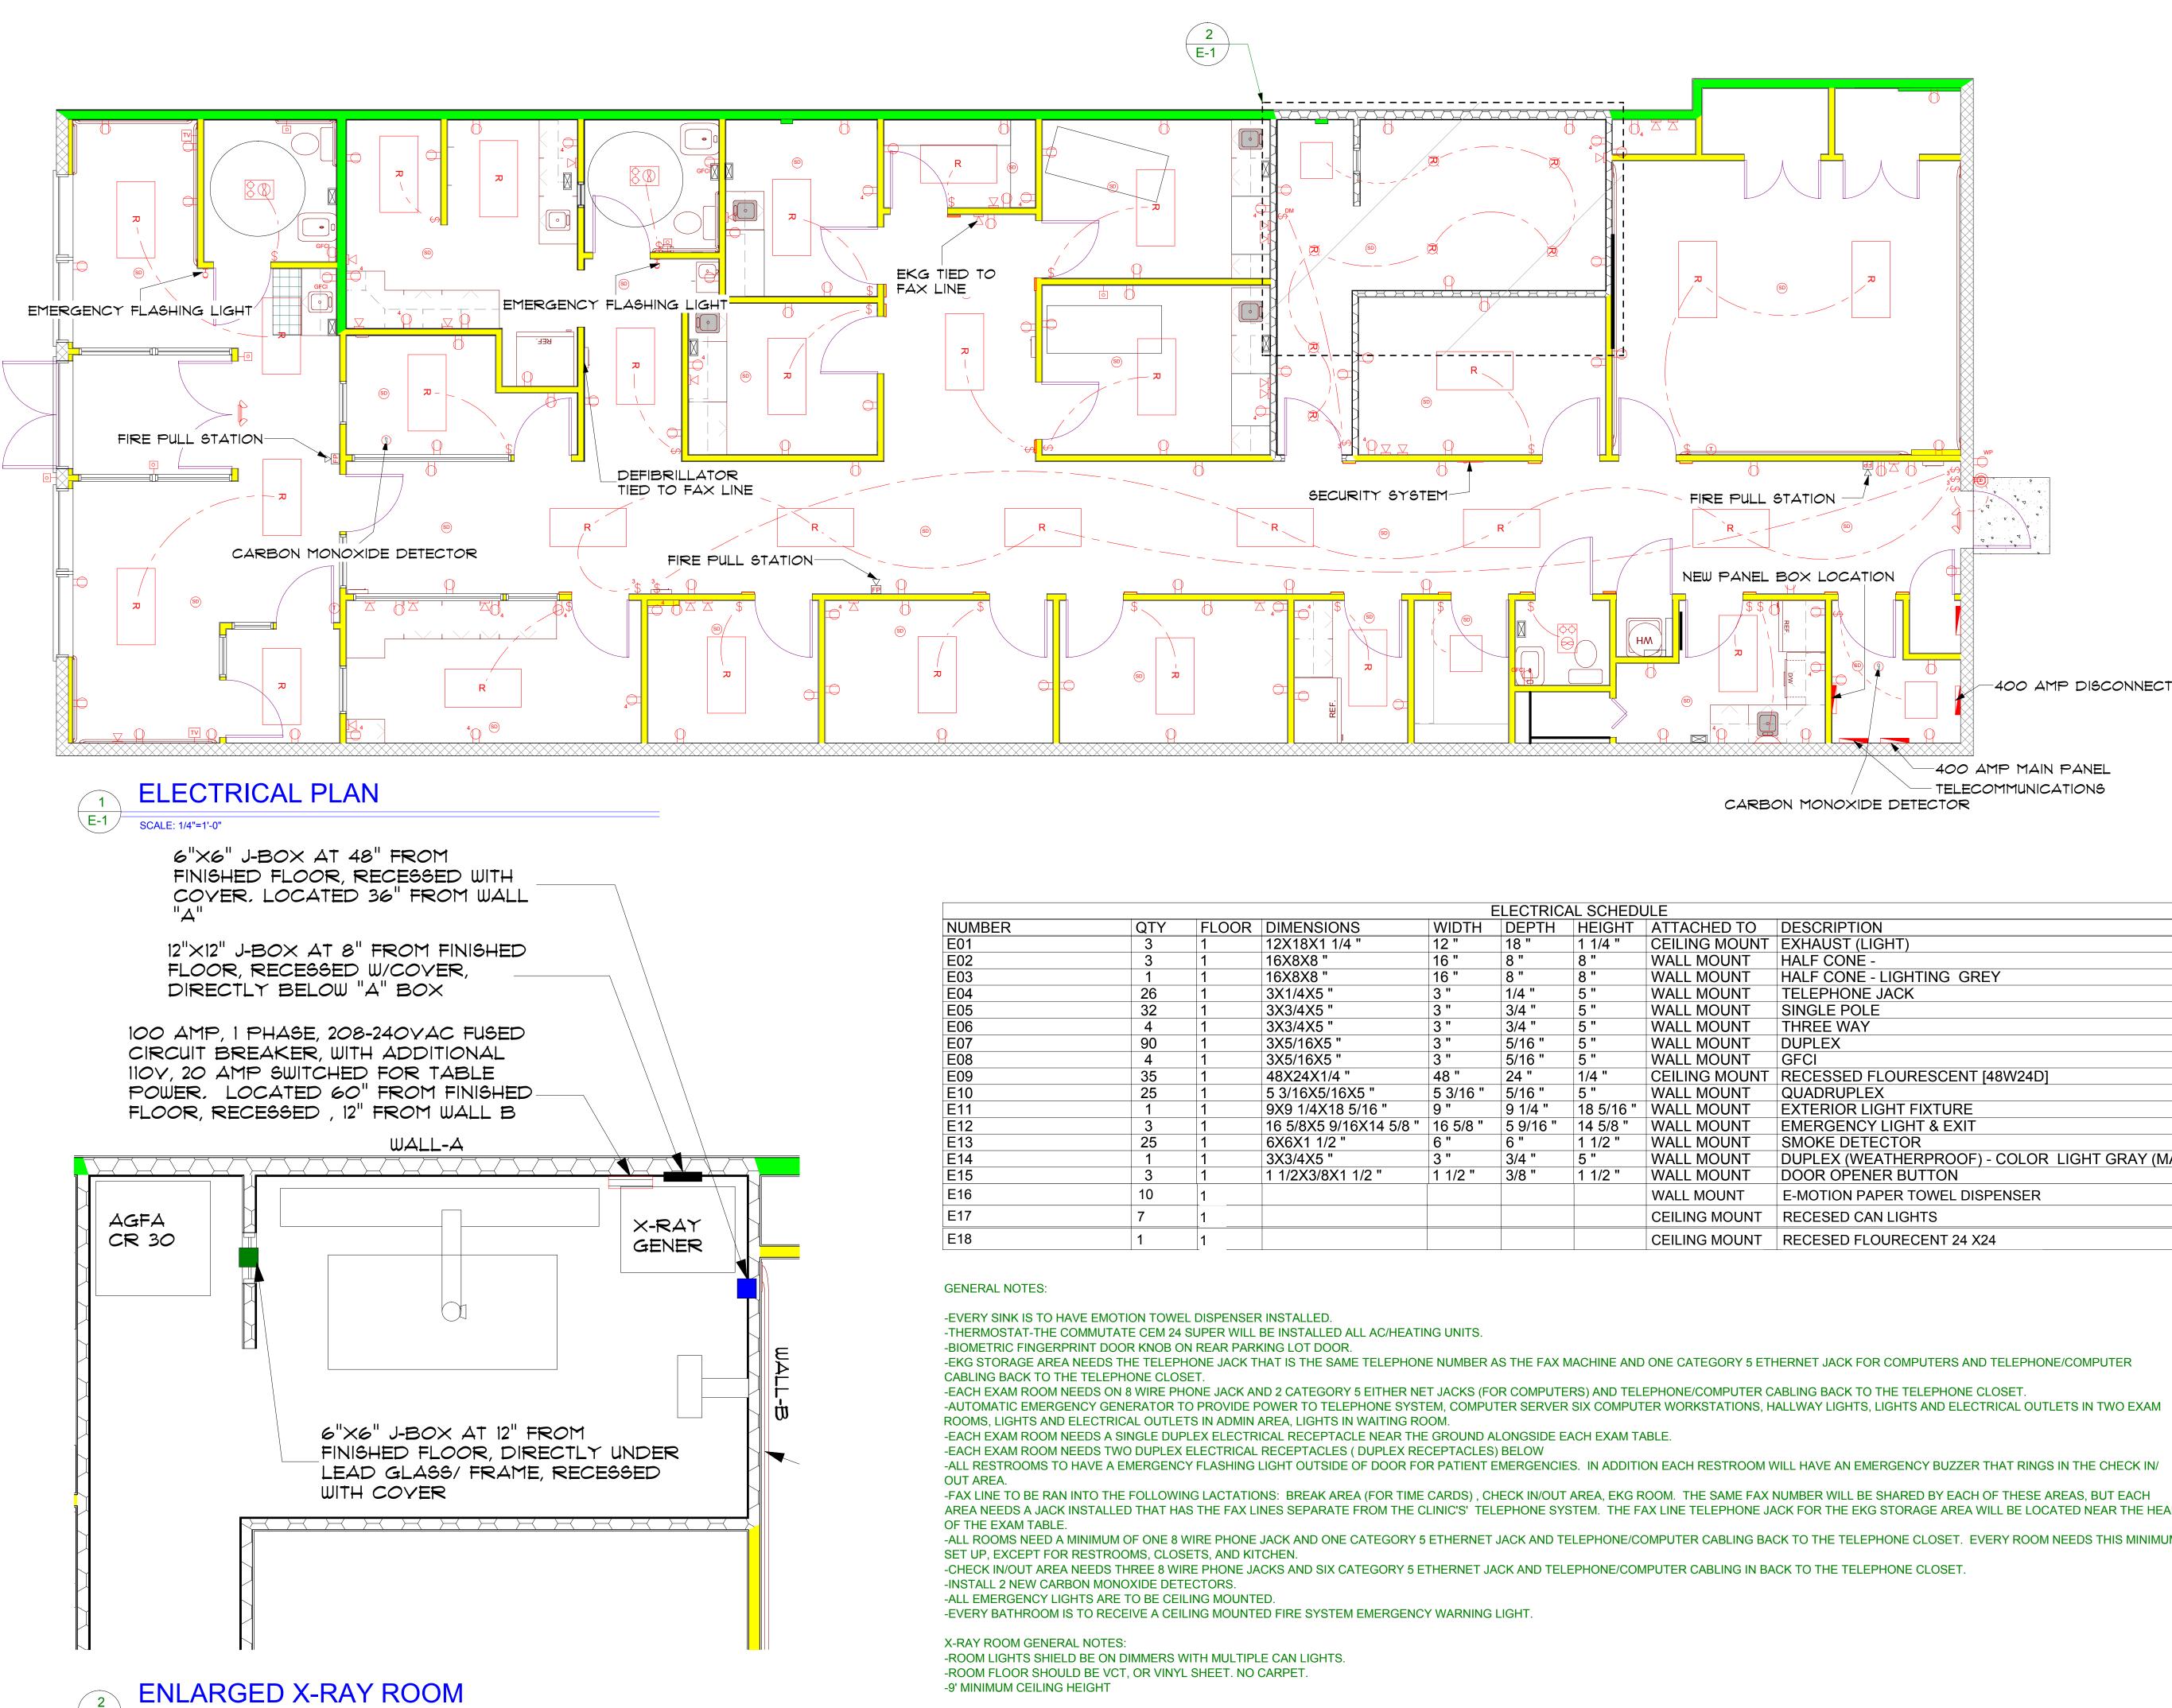

SCALE: 1/2"=1'-0"

E-1

ELECTRICAL SCHEDULE									
NUMBER	QTY	FLOOR	DIMENSIONS	WIDTH	DEPTH	HEIGHT	ATTACHED TO	DESCRIPTION	
E01	3	1	12X18X1 1/4 "	12 "	18 "	1 1/4 "	CEILING MOUNT	EXHAUST (LIGHT)	
E02	3	1	16X8X8 "	16 "	8 "	8 "	WALL MOUNT	HALF CONE -	
E03	1	1	16X8X8 "	16 "	8 "	8 "	WALL MOUNT	HALF CONE - LIGHTING GREY	
E04	26	1	3X1/4X5 "	3 "	1/4 "	5 "	WALL MOUNT	TELEPHONE JACK	
E05	32	1	3X3/4X5 "	3 "	3/4 "	5 "	WALL MOUNT	SINGLE POLE	
E06	4	1	3X3/4X5 "	3 "	3/4 "	5 "	WALL MOUNT	THREE WAY	
E07	90	1	3X5/16X5 "	3 "	5/16 "	5 "	WALL MOUNT	DUPLEX	
E08	4	1	3X5/16X5 "	3 "	5/16 "	5 "	WALL MOUNT	GFCI	
E09	35	1	48X24X1/4 "	48 "	24 "	1/4 "	CEILING MOUNT	RECESSED FLOURESCENT [48W24D]	
E10	25	1	5 3/16X5/16X5 "	5 3/16 "	5/16 "	5 "	WALL MOUNT	QUADRUPLEX	
E11	1	1	9X9 1/4X18 5/16 "	9 "	9 1/4 "	18 5/16 "	WALL MOUNT	EXTERIOR LIGHT FIXTURE	
E12	3	1	16 5/8X5 9/16X14 5/8 "	16 5/8 "	5 9/16 "	14 5/8 "	WALL MOUNT	EMERGENCY LIGHT & EXIT	
E13	25	1	6X6X1 1/2 "	6 "	6 "	1 1/2 "	WALL MOUNT	SMOKE DETECTOR	
E14	1	1	3X3/4X5 "	3 "	3/4 "	5 "	WALL MOUNT	DUPLEX (WEATHERPROOF) - COLOR LIGHT GRAY (MATTE)	
E15	3	1	1 1/2X3/8X1 1/2 "	1 1/2 "	3/8 "	1 1/2 "	WALL MOUNT	DOOR OPENER BUTTON	
E16	10	1					WALL MOUNT	E-MOTION PAPER TOWEL DISPENSER	
E17	7	1					CEILING MOUNT	RECESED CAN LIGHTS	
E18	1	1					CEILING MOUNT	RECESED FLOURECENT 24 X24	

-EKG STORAGE AREA NEEDS THE TELEPHONE JACK THAT IS THE SAME TELEPHONE NUMBER AS THE FAX MACHINE AND ONE CATEGORY 5 ETHERNET JACK FOR COMPUTERS AND TELEPHONE/COMPUTER

-AUTOMATIC EMERGENCY GENERATOR TO PROVIDE POWER TO TELEPHONE SYSTEM, COMPUTER SERVER SIX COMPUTER WORKSTATIONS, HALLWAY LIGHTS, LIGHTS AND ELECTRICAL OUTLETS IN TWO EXAM

-ALL RESTROOMS TO HAVE A EMERGENCY FLASHING LIGHT OUTSIDE OF DOOR FOR PATIENT EMERGENCIES. IN ADDITION EACH RESTROOM WILL HAVE AN EMERGENCY BUZZER THAT RINGS IN THE CHECK IN/

-FAX LINE TO BE RAN INTO THE FOLLOWING LACTATIONS: BREAK AREA (FOR TIME CARDS), CHECK IN/OUT AREA, EKG ROOM. THE SAME FAX NUMBER WILL BE SHARED BY EACH OF THESE AREAS, BUT EACH AREA NEEDS A JACK INSTALLED THAT HAS THE FAX LINES SEPARATE FROM THE CLINIC'S' TELEPHONE SYSTEM. THE FAX LINE TELEPHONE JACK FOR THE EKG STORAGE AREA WILL BE LOCATED NEAR THE HEAD

-ALL ROOMS NEED A MINIMUM OF ONE 8 WIRE PHONE JACK AND ONE CATEGORY 5 ETHERNET JACK AND TELEPHONE/COMPUTER CABLING BACK TO THE TELEPHONE CLOSET. EVERY ROOM NEEDS THIS MINIMUM

ELECTRICAL LEGEND					
SYMBOL	DESCRIPTION				
	METER SOCKET				
	PANEL BOX				
R	2X4 RECESSED FLUORESCENT LIGHT FIXTURE				
	E-MOTION TOWEL DISPENSER				
<del>-U1</del>	SINGLE POLE SWITCH				
+ <b>∫</b> , <sup>3</sup>	THREE WAY SWITCH				
<sup>4</sup>	FOUR WAY SWITCH				
-O	110V DUPLEX RECEPTACLE				
GFI	110V DUPLEX RECEPTACLE GROUND FAULT INTERRUPTED				
WP WP	110V DUPLEX RECEPTACLE W/ WEATHERPROOF COVER				
÷	220V RECEPTACLE				
K	ETHERNET & TELEPHONE OUTLET				
SD	SMOKE DETECTOR				
$\circ \otimes$	EXHAUST FAN WITH LIGHT				
	EMERGENCY/EXIT LIGHT				
<b>⊢</b> ∘	EMERGENCY FLASHING LIGHT				
-0	HANDICAP BUZZER				

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ELECTRICAL SYSTEM CODE: SEC.2701 MECHANICAL SYSTEM CODE: SEC.2801 PLUMBING SYSTEM CODE: SEC.2901

### No Revisions / Submissions





Date


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### IGG EART 4TH STREET DUNKIRK, NY 14048


### DRAWING TITLE **ELECTRICAL PLAN**

DESIGNED DCG PROJECT NO VA CLINIC RAWN RWR AS NOTED REVIEWED DCG DATE Friday, August 22, 2008

PROJECT: \\David-vxhl7gduw\projects on rich-2006\VA CLINIC\VA LAYOUT.layout



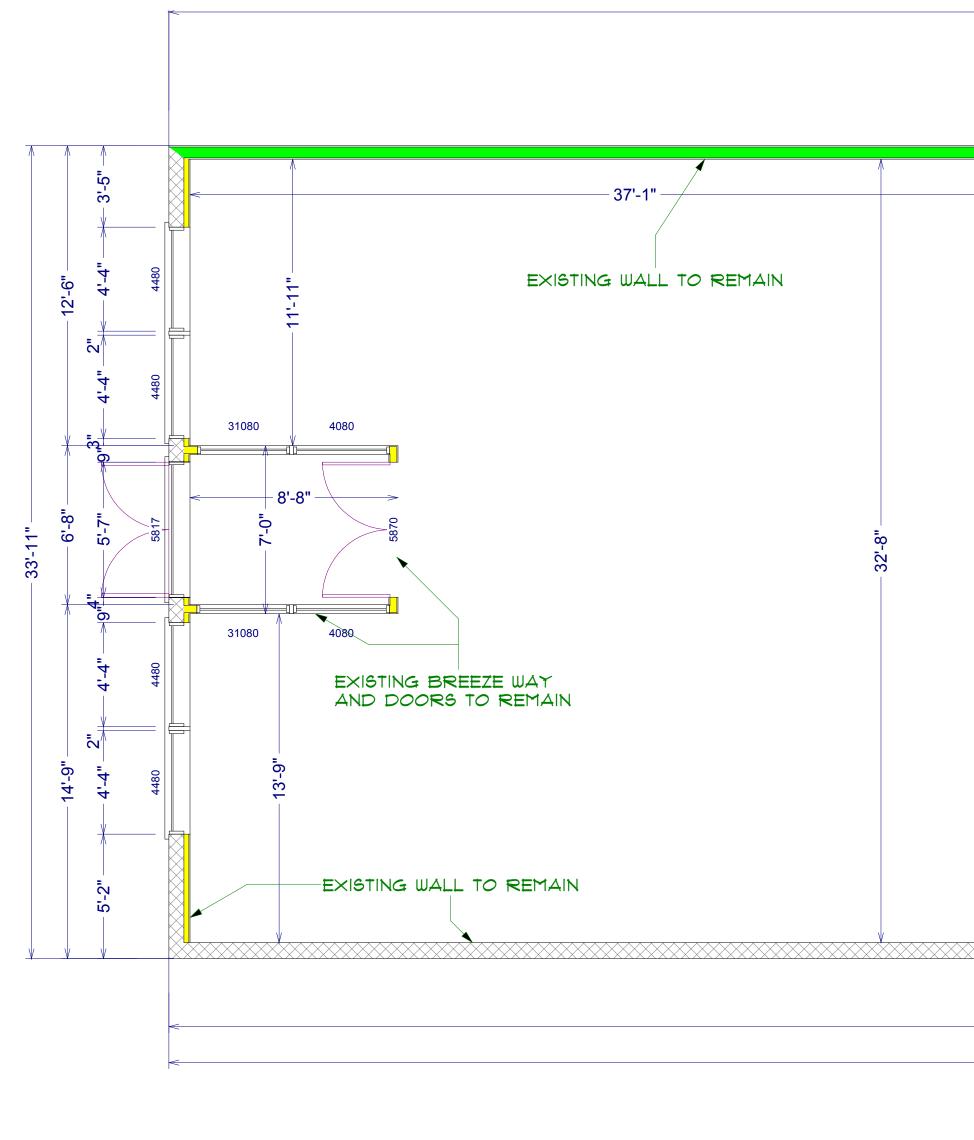

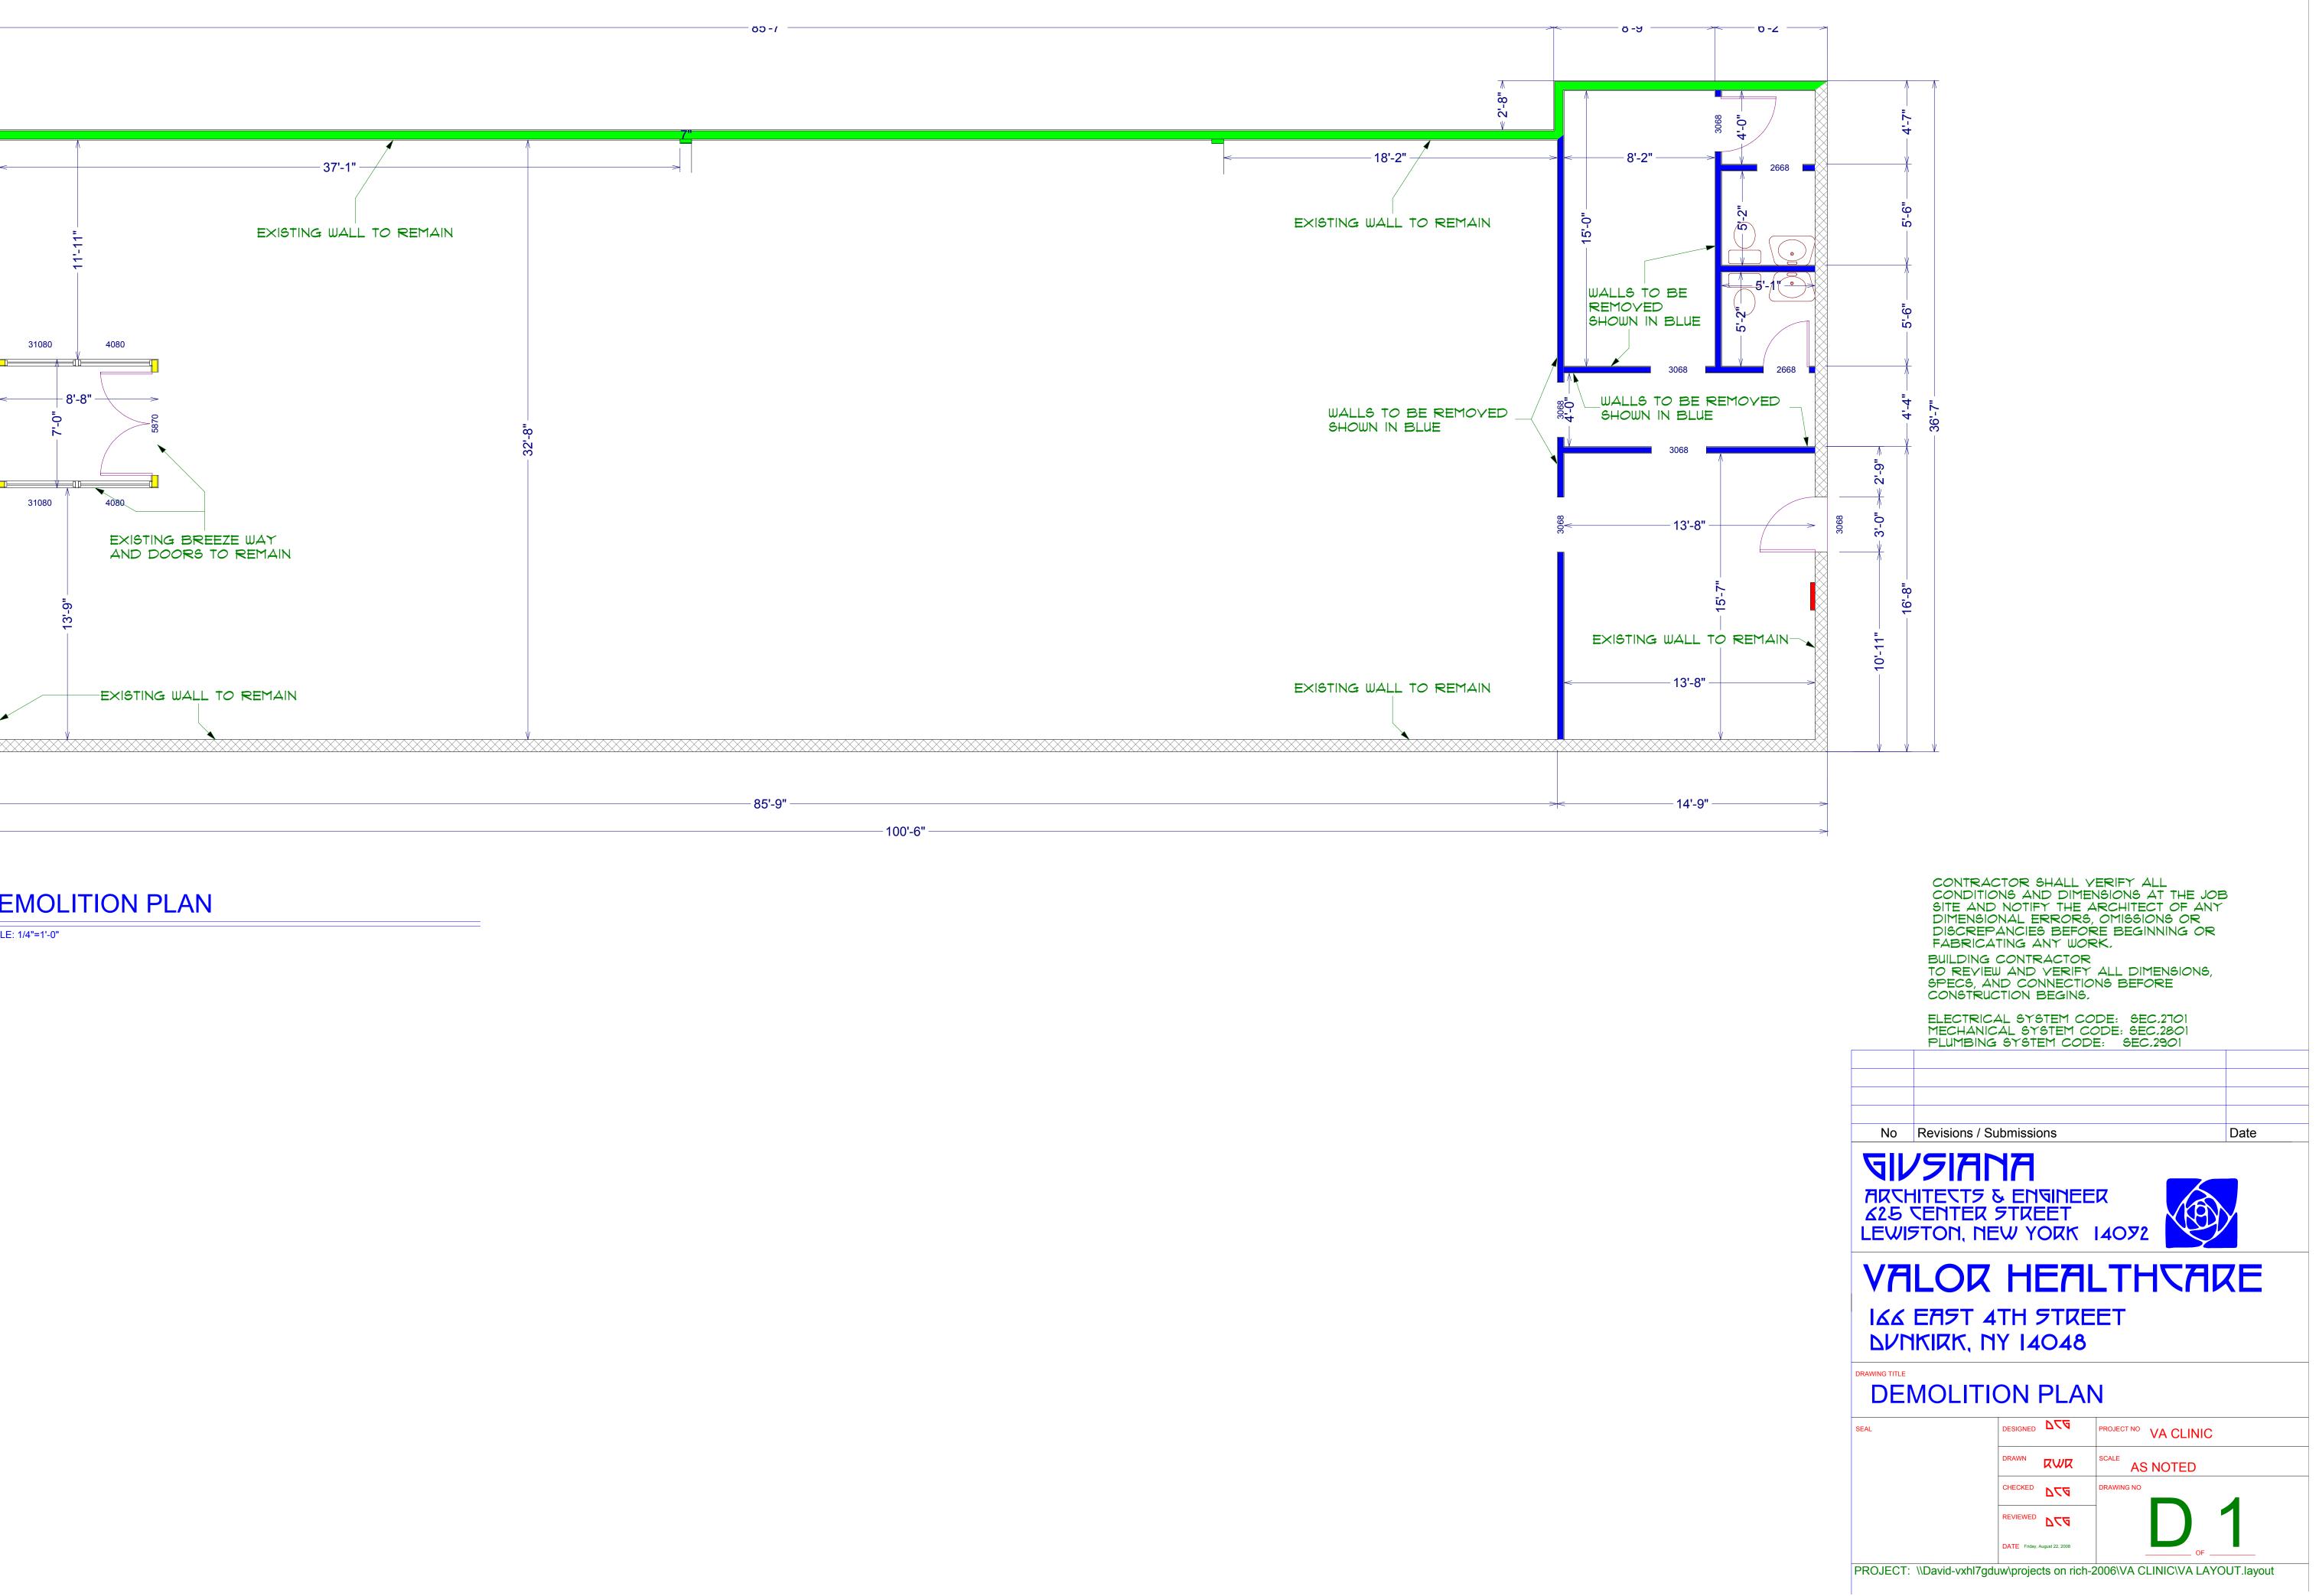


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NEW 2X4 METAL STUD WALL 1'-4" O.C. EXISTING STOREFRONT WALL EXISTING WALL TO BE REMOVED EXISTING MASONRY BLOCK WALL EXISTING WALL WITH 1 LAYER OF 5/8 GWB ON EACH SIDE <b>DETRIL NO.</b> WIERE SUT OR TRIKEN TYPICAL SECTION SECTION / DETRIL NO. WIERE SUT SECTION / DETRIL NO. WIERE SUT SECTION / DETRIL NO. WIERE SUT			
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PHOTOGRAPH OF FACILITY




# MANUEL E. TARACIDO: DIRECTOR AND EXECUTIVE VICE PRESIDENT JOSE FLORES: VICE PRESIDENT -PATIENT CARE




# COMMUNITY BASED **OUTPATIENT CLINIC 166 EAST FOURTH STREET** DUNKIRK, NY 14048
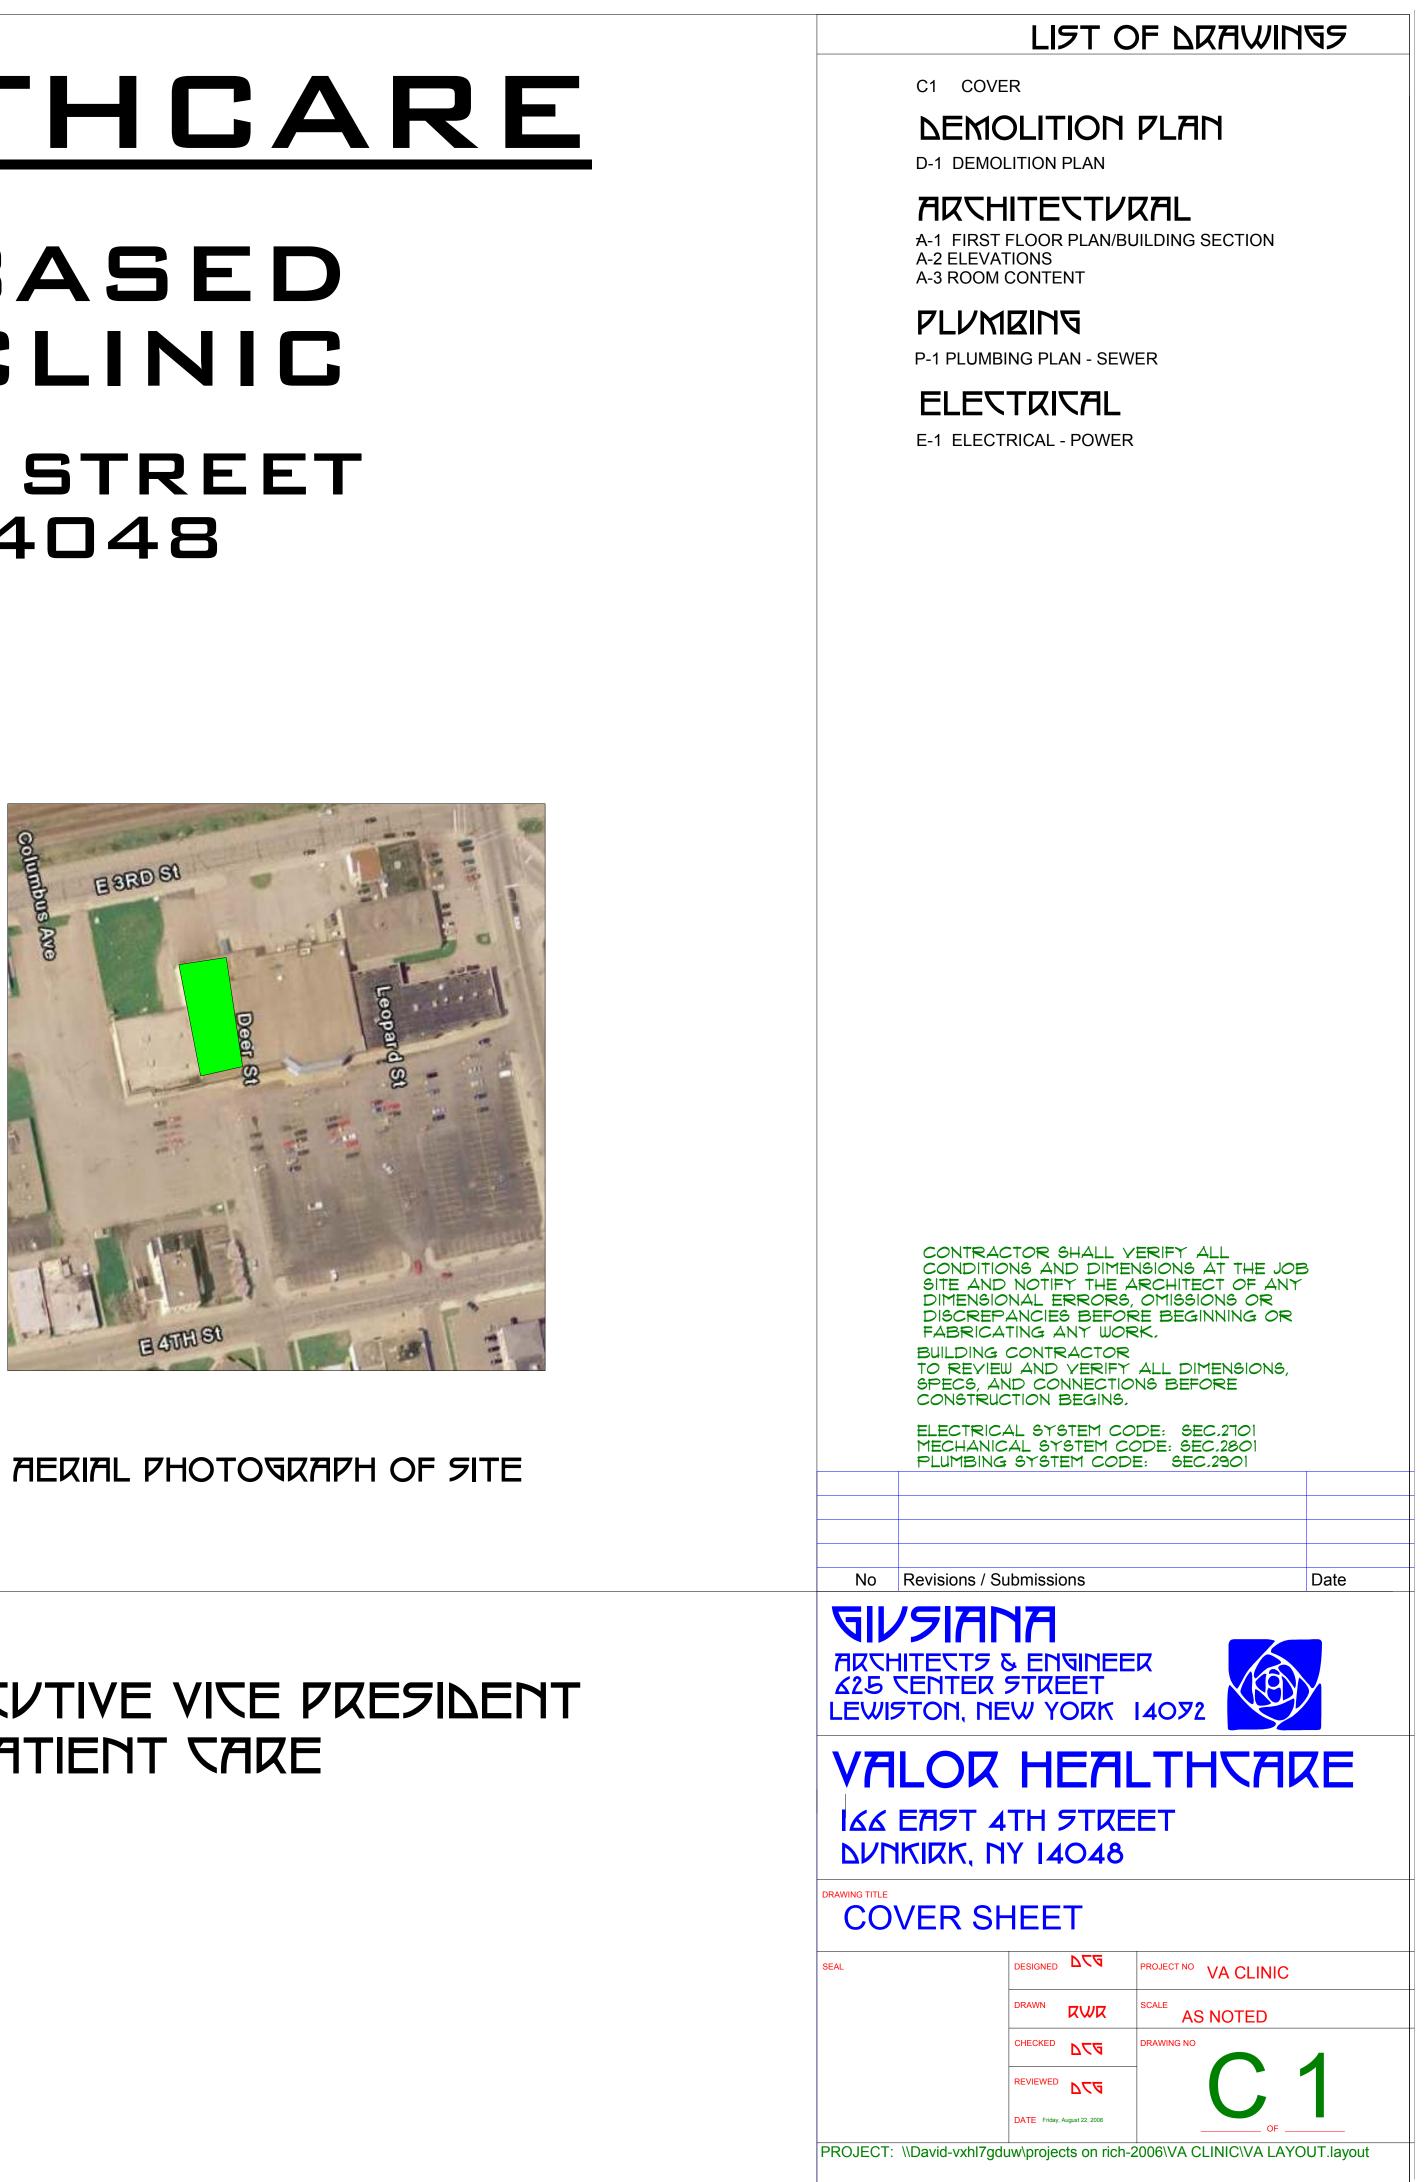
# VALOR HEALTHCARE

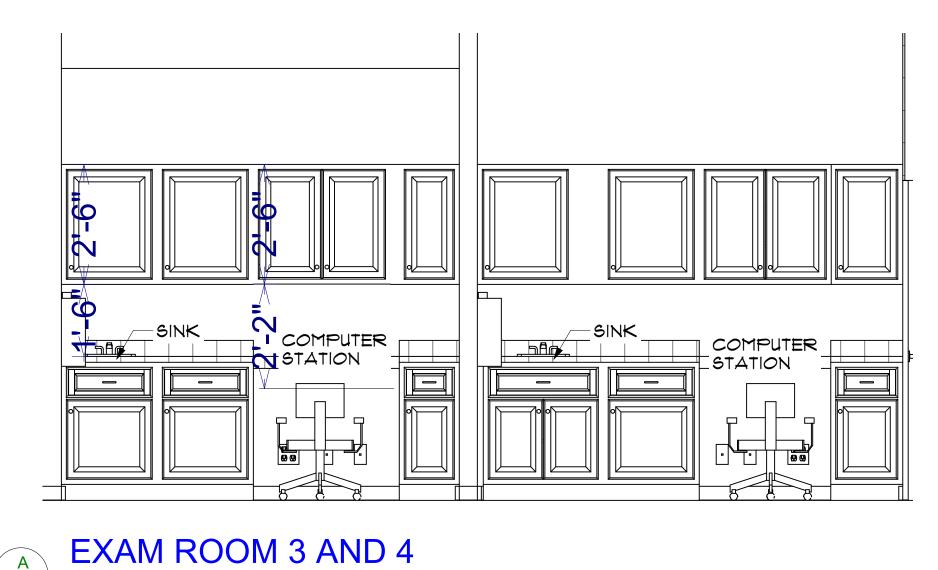





SCALE: 1/2"=1'-0"

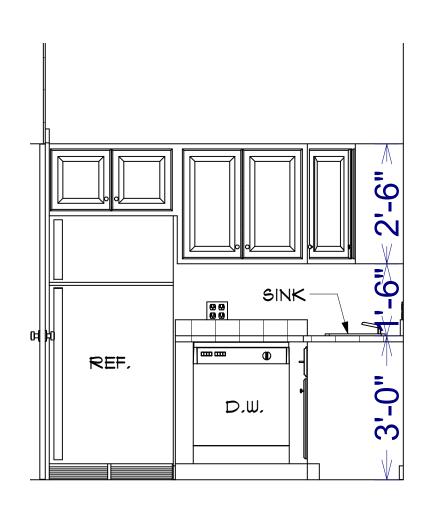





### BREAK ROOM-1 SCALE: 1/2"=1'-0"

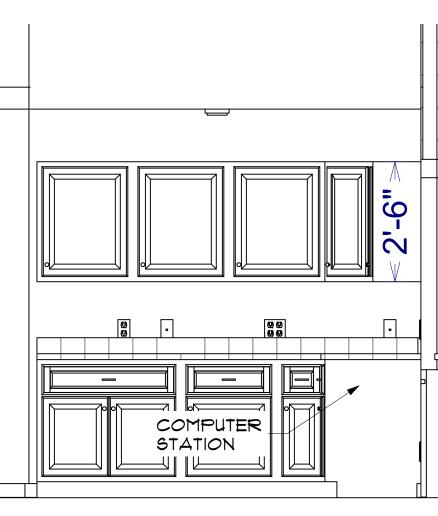

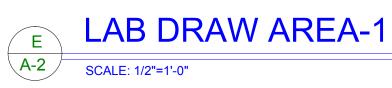

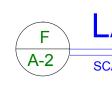


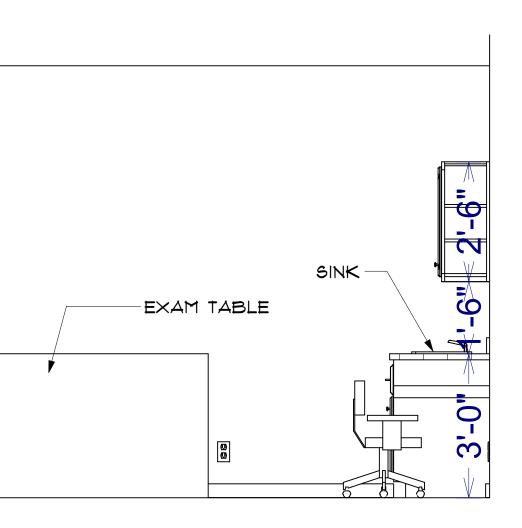

## EXAM ROOM 3 AND 4

SCALE: 1/2"=1'-0"


B A-2

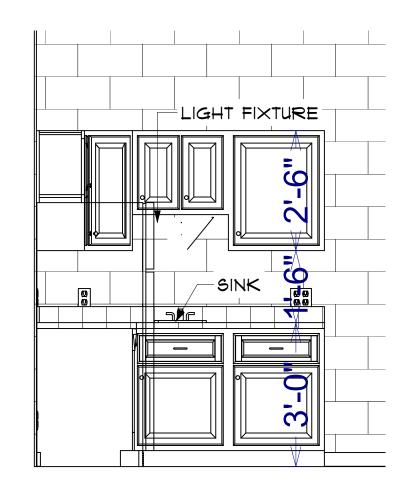

## BREAK ROOM-2

SCALE: 1/2"=1'-0"

D A-2

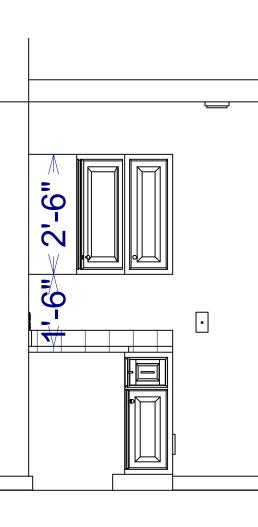

LAB DRAW AREA-2





SCALE: 1/2"=1'-0"

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No Revisions / Submissions





Date

VALOR HEALTHCARE

IGG ERIST ATH STREET DUNKIRK, NY 14048

## ELEVATIONS

 SEAL
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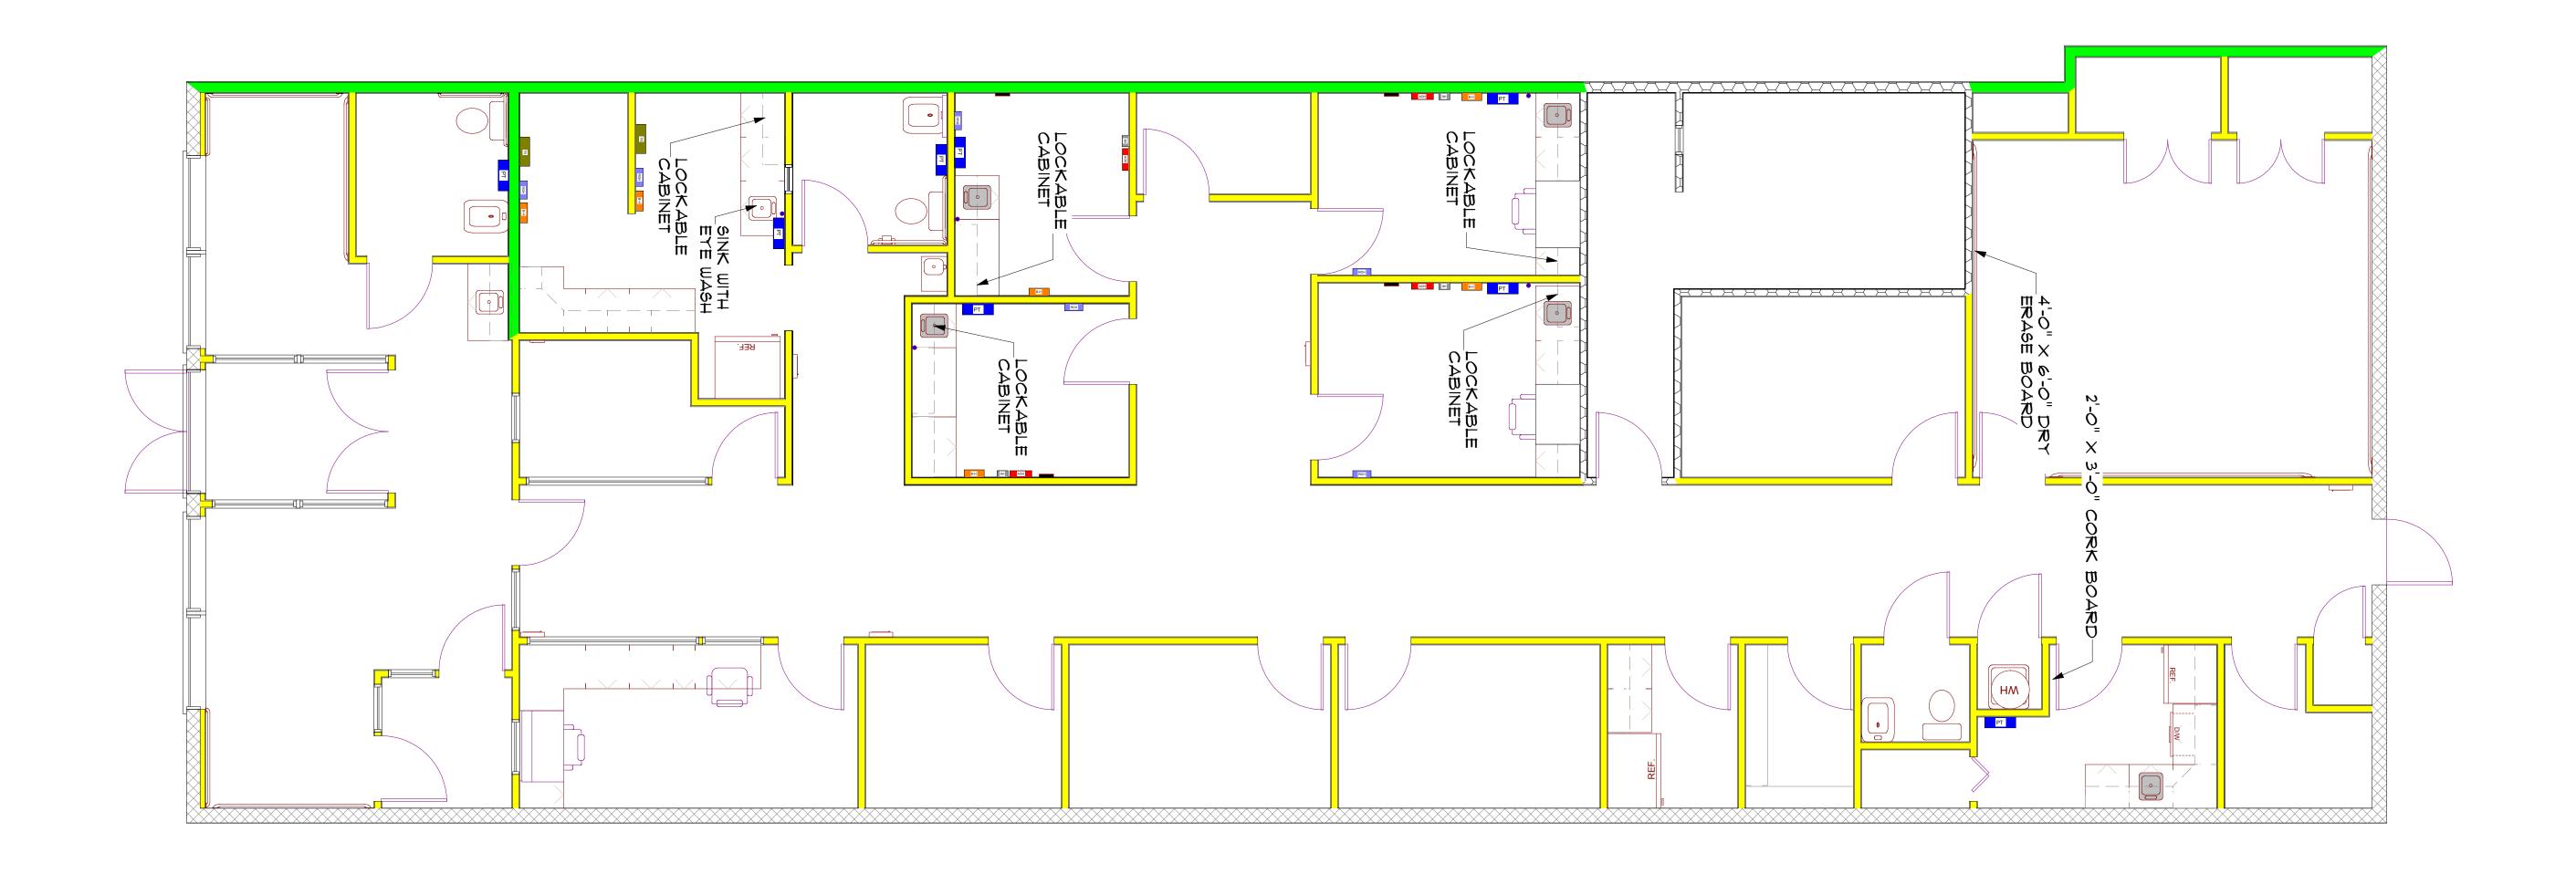
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 SCALE
 AS NOTED

 CHECKED
 DTT
 DRAWING NO

 REVIEWED
 DTT
 PROJECT NO
 VA CLINIC

 DATE
 Friday, August 22, 2008
 PROJECT NO
 VA CLINIC

PROJECT: \\David-vxhl7gduw\projects on rich-2006\VA CLINIC\VA LAYOUT.layout





ALCOHOL BASED SOAP DISPENSER• $3" \times 9"$ ANIT-BACTERIAL SOAP DISPENSER• $3" \times 9"$ E-MOTION PAPER TOWEL DISPENSER• $1'-2" \times 1'-5"$ BIO-HAZARD CONTAINER••AUTO OTOPTHALMOSCOPE HOLDER• $4" \times 1'-0"$ SPECULAR HOLDER••BLOOD PRESSURE ISTRUMENT• $8" \times 8"$ RUBBER GLOVE HOLDER••TUBE RACK••	ITEM DESCRIPTION	ITEM SYMBOL	DIMENSIONS
E-MOTION PAPER TOWEL DISPENSERPT1'-2" × 1'-5"BIO-HAZARD CONTAINERIII" × 1'-0"AUTO OTOPTHALMOSCOPE HOLDERIII" × 1'-0"SPECULAR HOLDERIII" × 1'-0"BLOOD PRESSURE ISTRUMENTIII" × 8"RUBBER GLOVE HOLDERIII" × 1'-0"TUBE RACKIII" × 1'-0"	ALCOHOL BASED SOAP DISPENSER	•	3"× 9"
BIO-HAZARD CONTAINER       III" × 1'-0"         AUTO OTOPTHALMOSCOPE HOLDER       III" × 1'-0"         SPECULAR HOLDER       III" × 1'-0"         BLOOD PRESSURE ISTRUMENT       III" × 1'-0"         RUBBER GLOVE HOLDER       III" × 1'-0"         TUBE RACK       III" × 1'-0"	ANIT-BACTERIAL SOAP DISPENSER	•	3" × 9"
AUTO OTOPTHALMOSCOPE HOLDERImage: Constraint of the constr	E-MOTION PAPER TOWEL DISPENSER	PT	1'-2" × 1'-5"
SPECULAR HOLDERSH $6" \times 9"$ BLOOD PRESSURE ISTRUMENT $\blacksquare$ $8" \times 8"$ RUBBER GLOVE HOLDER $\blacksquare$ $10" \times 1'-8"$ TUBE RACK $\blacksquare$ $1'-4" \times 1'-0"$	BIO-HAZARD CONTAINER	В-Н	$11'' \times 1'-O''$
BLOOD PRESSURE ISTRUMENT $\blacksquare$ $\$'' \times \$''$ RUBBER GLOVE HOLDER $\blacksquare$ $10'' \times 1'-\$''$ TUBE RACK $\blacksquare$ $1'-4'' \times 1'-0''$	AUTO OTOPTHALMOSCOPE HOLDER	АОН	$4" \times 1'-O"$
RUBBER GLOVE HOLDERIO" $\times$ 1'-8"TUBE RACKIIO" $\times$ 1'-0"	SPECULAR HOLDER	SH	$e''  imes \vartheta''$
TUBE RACK         I'-4" × 1'-0"	BLOOD PRESSURE ISTRUMENT		$8" \times 8"$
	RUBBER GLOVE HOLDER	RGH	$10^{"} \times 1^{'}$ -8"
	TUBE RACK	TR	$1'-4'' \times 1'-0''$
ROOM LABEL PLACK GIZE VARIES	ROOM LABEL PLACK		SIZE VARIES

ROOM CONTENT KEY

 $(\text{HEIGHT} \times \text{WIDTH})$ 

No Revisions / Submissions Date ARCHITECTS & ENGINEER 625 CENTER STREET LEWIFTON, NEW YORK 14092 VALOR HEALTHCARE IGG EAST 4TH STREET DVNKIRK, NY 14048 DRAWING TITLE **ROOM CONTENT** DESIGNED DCG PROJECT NO VA CLINIC DRAWN ิกพิน SCALE AS NOTED WING NO 2 REVIEWED DCG DATE Friday, August 22, 2008

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