

15. EXITING PLAN

SCALE: 1/8"=1'-0"

LEGEND DIRECTION OF EGRESS / NO. OF OCCUPANTS (OCC SUMMARY) ACCESSORY USE (DOES NOT ADD TO OCCUPANT LOAD) ROOM OCCUPANCY CONTENT B • OCCUPANCY CLASSIFICATION 2,500 SQUARE FOOTAGE (SF) 1:100 OCCUPANT LOAD FACTOR # NUMBER OF OCCUPANTS CEILING MOUNTED EXIT SIGN W/ BACK-UP BATTER POWER. MATCH EXISTING BUILDING STANDARDS MNDICATES NEW EXIT SIGN WITH BACK-UP BATTERY POWER CEILING MOUNTED EXIT SIGN W/ BACK-UP BATTER POWER, DOUBLE SIDED; MATCH EXISTING BUILDING STANDARDS.

NDICATES WALL MOUNTED SIGN EXIT SIGN W/ BACK-UP BATTERY POWER

SEMI-RECESSED FIRE EXTINGUISHER & CABINET PER LOCAL FIRE DEPT REQUIREMENT, PAINT CABINET TO MATCH ADJACENT WALL FINISH (U.O.N.). EXACT LOCATION SHALL BE COORDINATE IN FIELD & VERIFIED WITH FIRE DEPT & ARCH

FIRE EXTINGUISHER PER LOCAL FIRE DEPT REQUIREMENT, EXACT LOCATION SHALL BE COORDINATE IN FIELD & VERIFIED WITH FIRE DEPT \$ ARCH PRIOR TO FINAL INSTALL.

TACTILE EXIT SIGNAGE, GREY WITH WHITE LETTERS, SEE TACTILE EXIT SIGN DETAIL.

ALL AREAS SHOWN HATCHED ARE EXISTING \$ NOT IN SCOPE OF WORK.

KEYNOTES Indicated by $(X) \longrightarrow$ on the plan.

(E) SPRINKLERS TO BE RETAINED \$ TO REMAIN FUNCTIONAL DURING RENOVATION. ANY SPRINKLER MODIFICATIONS SHALL BE DESIGNED \$ SUBMITTED TO LOCAL JURISDICTION FOR REVIEW \$ APPROVAL BY LICENSED FIRE CONSULTANT UNDER SEPARATE

. ALL EXISTING EXIT DOORS \$ HARDWARE TO REMAIN. CONTRACTOR TO FIELD VERIFY FOR PROPER OPERATING CONDITION AND CURRENT CODE COMPLIANT. REPAIR AND/OR REPLACE AS REQUIRED, MATCHING EXISTING.

SUBMITTAL - SEE DEFERRED SUBMITTAL ON SHEET AO.O.

3. (N) SURFACE MOUNTED TACTILE EXIT SIGN TO MATCH (E) BUILDING STANDARDS. PROVIDE WHITE VINYL BACKING IF MOUNTED ON GLASS TO COMPLETELY CONCEAL ADHESIVE. SEE DETAIL 3/-. 4. (E) TACTILE SIGN TO REMAIN. CONTRACTOR TO FIELD VERIFY AND PROVIDE NEW IF ONE DOES NOT EXIST. NEW SIGN SHALL MATCH

(E) BUILDING STANDARDS. PROVIDE WHITE VINYL BACKING IF MOUNTED ON GLASS TO COMPLETELY CONCEAL ADHESIVE FROM

BEHIND. SEE DETAIL 3/-. 5. (E) EXIT SIGN TO REMAIN. CONTRACTOR TO FIELD VERIFY FOR PROPER OPERATION CONDITION; REPAIR AND/OR REPLACE AS NEEDED, MATCHING (E) OR APPROVED EQUAL.

ADDITIONAL INFO. IF ADJACENT TO WALL, SIGN SHALL BE WALL MOUNTED, HEIGHT TO MATCH (E) BUILDING STANDARDS. SIGNS SHALL BE CENTERED WITHIN SIZE OF ACOUSTICAL CEILING TILE IF CEILING MOUNTED. EXACT LOCATION SHALL BE FINALIZED IN COORDINATION WITH LOCAL FIRE DEPARTMENT IN THE FIELD \$ CONTRACTOR TO COORDINATE LOCATION WITH ARCHITECT FOR FINAL REVIEW PRIOR TO INSTALL.

. (N) SEMI-RECESSED FIRE EXTINGUISHER & CABINET & SIGN IF AVAILABLE. IF MOUNTED ON (E) FIRE RATED CONSTRUCTION SURFACES, ATTACHMENTS SHALL NOT HINDER THE FIRE RATING INTEGRITY. FIRE SEAL/CAULK AS REQUIRED. EXACT LOCATION SHALL BE FINALIZED IN COORDINATION WITH LOCAL FIRE DEPARTMENT IN THE FIELD \$ CONTRACTOR TO COORDINATE LOCATION WITH ARCHITECT FOR FINAL REVIEW PRIOR TO INSTALL. SEE DETAIL 1/-.


AND CURRENT CODE COMPLIANT. REPAIR AND/OR REPLACE AS REQUIRED, MATCHING EXISTING. 9. NEW EXIT DOORS \$ HARDWARE SHALL MATCH EXISTING TYPE \$ FINISH OR APPROVED BETTER, U.O.N..

8. (E) SEMI-RECESSED FIRE EXTINGUISHER & CABINET & SIGN. CONTRACTOR TO FIELD VERIFY FOR PROPER OPERATING CONDITION

EXIT CALCULATION

EXIT #1 (DOUBLE DOOR - 66" CLR): 39 PERSONS EXIT #2 (SINGLE DOOR - 32" CLR): 38 PERSONS **TOTAL**

77 PERSONS

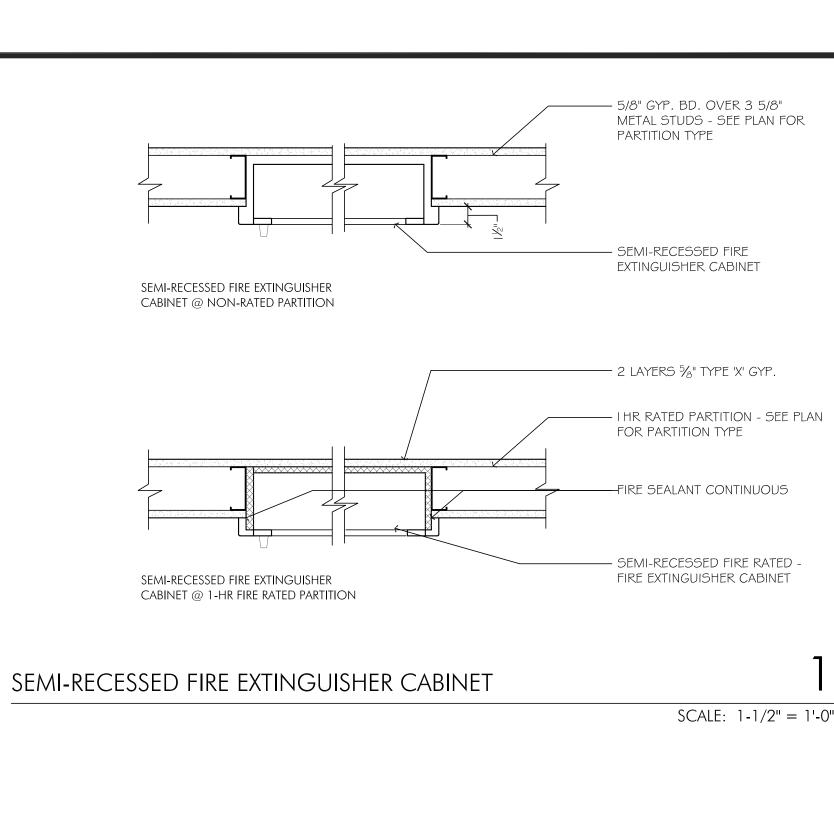

TACTILE EXIT SIGNS SHALL BE REQ'D AT EA. EXIT DOOR COMPLYING W/ C.B.C. 1011.1, 1011.4 \$ 11B-703.2-4 AT THE FOLLOWING LOCATIONS:

EA. GRADE LEVEL EXTERIOR EA. EXIT DOOR THAT LEADS EXIT EXIT ROUTE EXIT DOOR SHALL BE DIRECTLY TO A GRADE LEVEL IDENTIFIED BY A TACTILE EXIT EXTERIOR EXIT BY MEANS OF AN SIGN WITH THE WORD "EXIT" EXIT ENCLOSURE OR AN EXIT PASSAGEWAY SHALL BE IDENTIFIED BY A TACTILE EXIT EA. EXIT DOOR THAT LEADS SIGN WITH THE WORDS "EXIT EXIT STAIR DOWN DIRECTLY TO A GRADE LEVEL ROUTE". EXTERIOR EXIT BY MEANS OF A STAIRWAY OR RAMP SHALL EA. EXIT ACCESS DOOR FROM AN EXIT ROUTE BE IDENTIFIED BY A TACTILE INTERIOR ROOM OR AREA TO A EXIT RAMP DOWN EXIT SIGN WITH THE CORRIDOR OR HALLWAY THAT IS FOLLOWING WORDS AS REQUIRED TO HAVE A VISUAL APPROPRIATE: EXIT SIGN, SHALL BE IDENTIFIED "EXIT STAIR DOWN" OR BY A TACTILE EXIT SIGN WITH THE "EXIT RAMP DOWN" OR WORDS, "EXIT ROUTE". "EXIT STAIR UP" OR "EXIT RAMP UP". EA. EXIT DOOR THROUGH A EXIT RAMP UP HORIZONTAL EXIT SHALL BE IDENTIFIED BY A SIGN WITH THE WORDS,"TO EXIT"

SHALL BE RAISED 1/32" MIN., UPPER CASE, SANS SERIF OR SIMPLE SERIF TYPE & SHALL BE ACCOMPANIED W/ GRADE II BRAILLE. RAISED CHARACTERS SHALL BE MIN. 5/8", MAX. 2" HIGH LITERARY BRAILLE.

DOT DIAMETER: 0.059" MIN., 0.063" MAX. INTER-DOT SPACING: 0.025 MIN., 0.037 MAX DOT HEIGHT: HORIZONTAL SEPARATION BETWEEN CELLS: 0.3" VERTICAL SEPARATION BETWEEN CELLS: 0.395" MIN., 0.4" MAX.

CHARACTERS, SYMBOLS & THEIR BACKGROUNDS SHALL HAVE A NON-GLARE FINISH. CHARACTERS & SYMBOLS SHALL CONTRAST W/ THEIR BACKGROUND.

CHARACTERS ON SIGNS SHALL HAVE A WIDTH TO HEIGHT RATIO OF BETWEEN 3.5 \$ 1.1, \$ A STROKE WIDTH TO HEIGHT RATIO OF BETWEEN 1.5 \$ 1:10.

CHARACTERS AND BACKGROUND OF SIGN SHALL BE——— BLACK-WITE EGGSHELL, MATTE, OR OTHER NON-GLARE FINISH. COLOR & CONTRAST OF SIGN SHALL DISTINCTIVELY CONTRAST WITH COLOR & CONTRAST OF WALL. <u>LETTERING:</u> HEIGHT SHALL BE BRUSHED ALUM. 5/8" MIN. TO 2" MAX., \longrightarrow 1/32" RAISED, UPPERCASE, SANS-SERIF FONT, W/ WIDTH-TO-HEIGHT RATIO BETWEEN 3:5 \$ 1:1 AND A STROKE WIDTH-TO-HEIGHT RATIO BETWEEN 1:5 \$ 1:10.

CHARACTERS, SYMBOLS AND BACKGROUND ▲

5 POINTED STAR SHALL BE LOCATED TO THE LEFT OF THE IDENTIFYING NO. AT THE EXIT LEVEL, W/ THE SAME HEIGHT OF


THE RAISED CHARACTERS. WALL-MOUNTED SIGNAGE AT EXIT LEVEL A

SIGNAGE TO BE MOUNTED ON WALL ADJACENT TO LATCH SIDE OF DOOR TO FACE PERSON -ENTERING (PREFERABLY RIGHT SIDE). MOUNTING LOCATION MUST ALLOW PERSON TO APPROACH WITHOUT ENCOUNTERING PROTRUDING OBJECTS OR BEING WITHIN SWING PATH OF DOOR. SIGNAGE MOUNTING REQUIREMENTS A

TACTILE EXIT SIGNS

TYPICAL 3'-0" WIDE DOOR X(.2) = 32X = 32/.2X = 160 OCCUPANTSPERMITTED TO EXIT THROUGH ONE 3'-O" WIDE DOOR.

A TYPICAL 3'-0" WIDE DOOR PROVIDES 32" CLEAR EXIT WIDTH THAT WILL ALLOW 160 OCCUPANTS TO EGRESS IN A FULLY SPRINKLERED BUILDING PER CBC SECTION 1005.1.

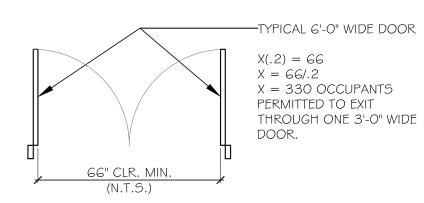

A TYPICAL 6'-0" WIDE DOUBLE DOOR PROVIDES 66" CLEAR EXIT WIDTH THAT WILL ALLOW 330 OCCUPANTS TO EGRESS IN A FULLY SPRINKLERED BUILDING PER CBC SECTION 1005.1.

TYPICAL STAIR WIDTH

X(.3) = 36X = 36/.3

X = 120 OCCUPANTS PERMITTED TO EXIT THROUGH 3'-0" WIDE STAIR

* 48" STAIR WIDTH = 160 OCCUPANTS * 60" STAIR WIDTH = 200 OCCUPANTS

EXITING DOOR & STAIR WIDTH REQUIREMENTS




PROJECT ADDRESS

2500 FONTAINE ROAD SAN JOSE, CA 95121

MARKET READY IMPROVEMENTS for

2500 FONTAINE ROAD

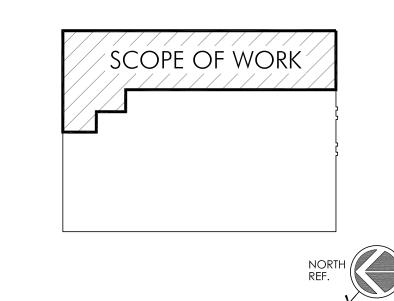



— CORRESPONDING GRADE II BRAILLE LOCATED CENTERED OR

ON TACTILE

CHARACTERS LI'-6" MIN

MIN -48" MIN TO BOTTOM OF

BRAILLE, 60" MAX TO BOTTOM CHARACTERS

SCALE: NTS

FLUSH LEFT OF SIGN. BRAILLE

DOTS ARE RAISED A MINIMUM OF

1/40" ABOVE THE BACKGROUND.

ALL DESIGNS, DRAWINGS AND WRITTEN MATERIALS INDICATED HEREIN ARE THE WORK AND PROPERTY OF STUDIO:G ARCHITECTS. THIS DOCUMENT MAY NOT BE DUPLICATED, REUSED OR DISCLOSED BY ANY METHOD WITHOUT THE WRITTEN CONSENT OF STUDIO:G ARCHITECTS. ALL RIGHTS RESERVED.

revisions	
DATE	DESCRIPTION
08.03.2021	PERMIT ADJUSTMENT SUBMITTAL
DATE	07.30.202
SCALE	AS SHOWN
PROJECT ID	2020.92


EXITING PLAN


SHEET TITLE

Drawn by

SHEET NO.

JURISDICTION APPROVAL STAMP

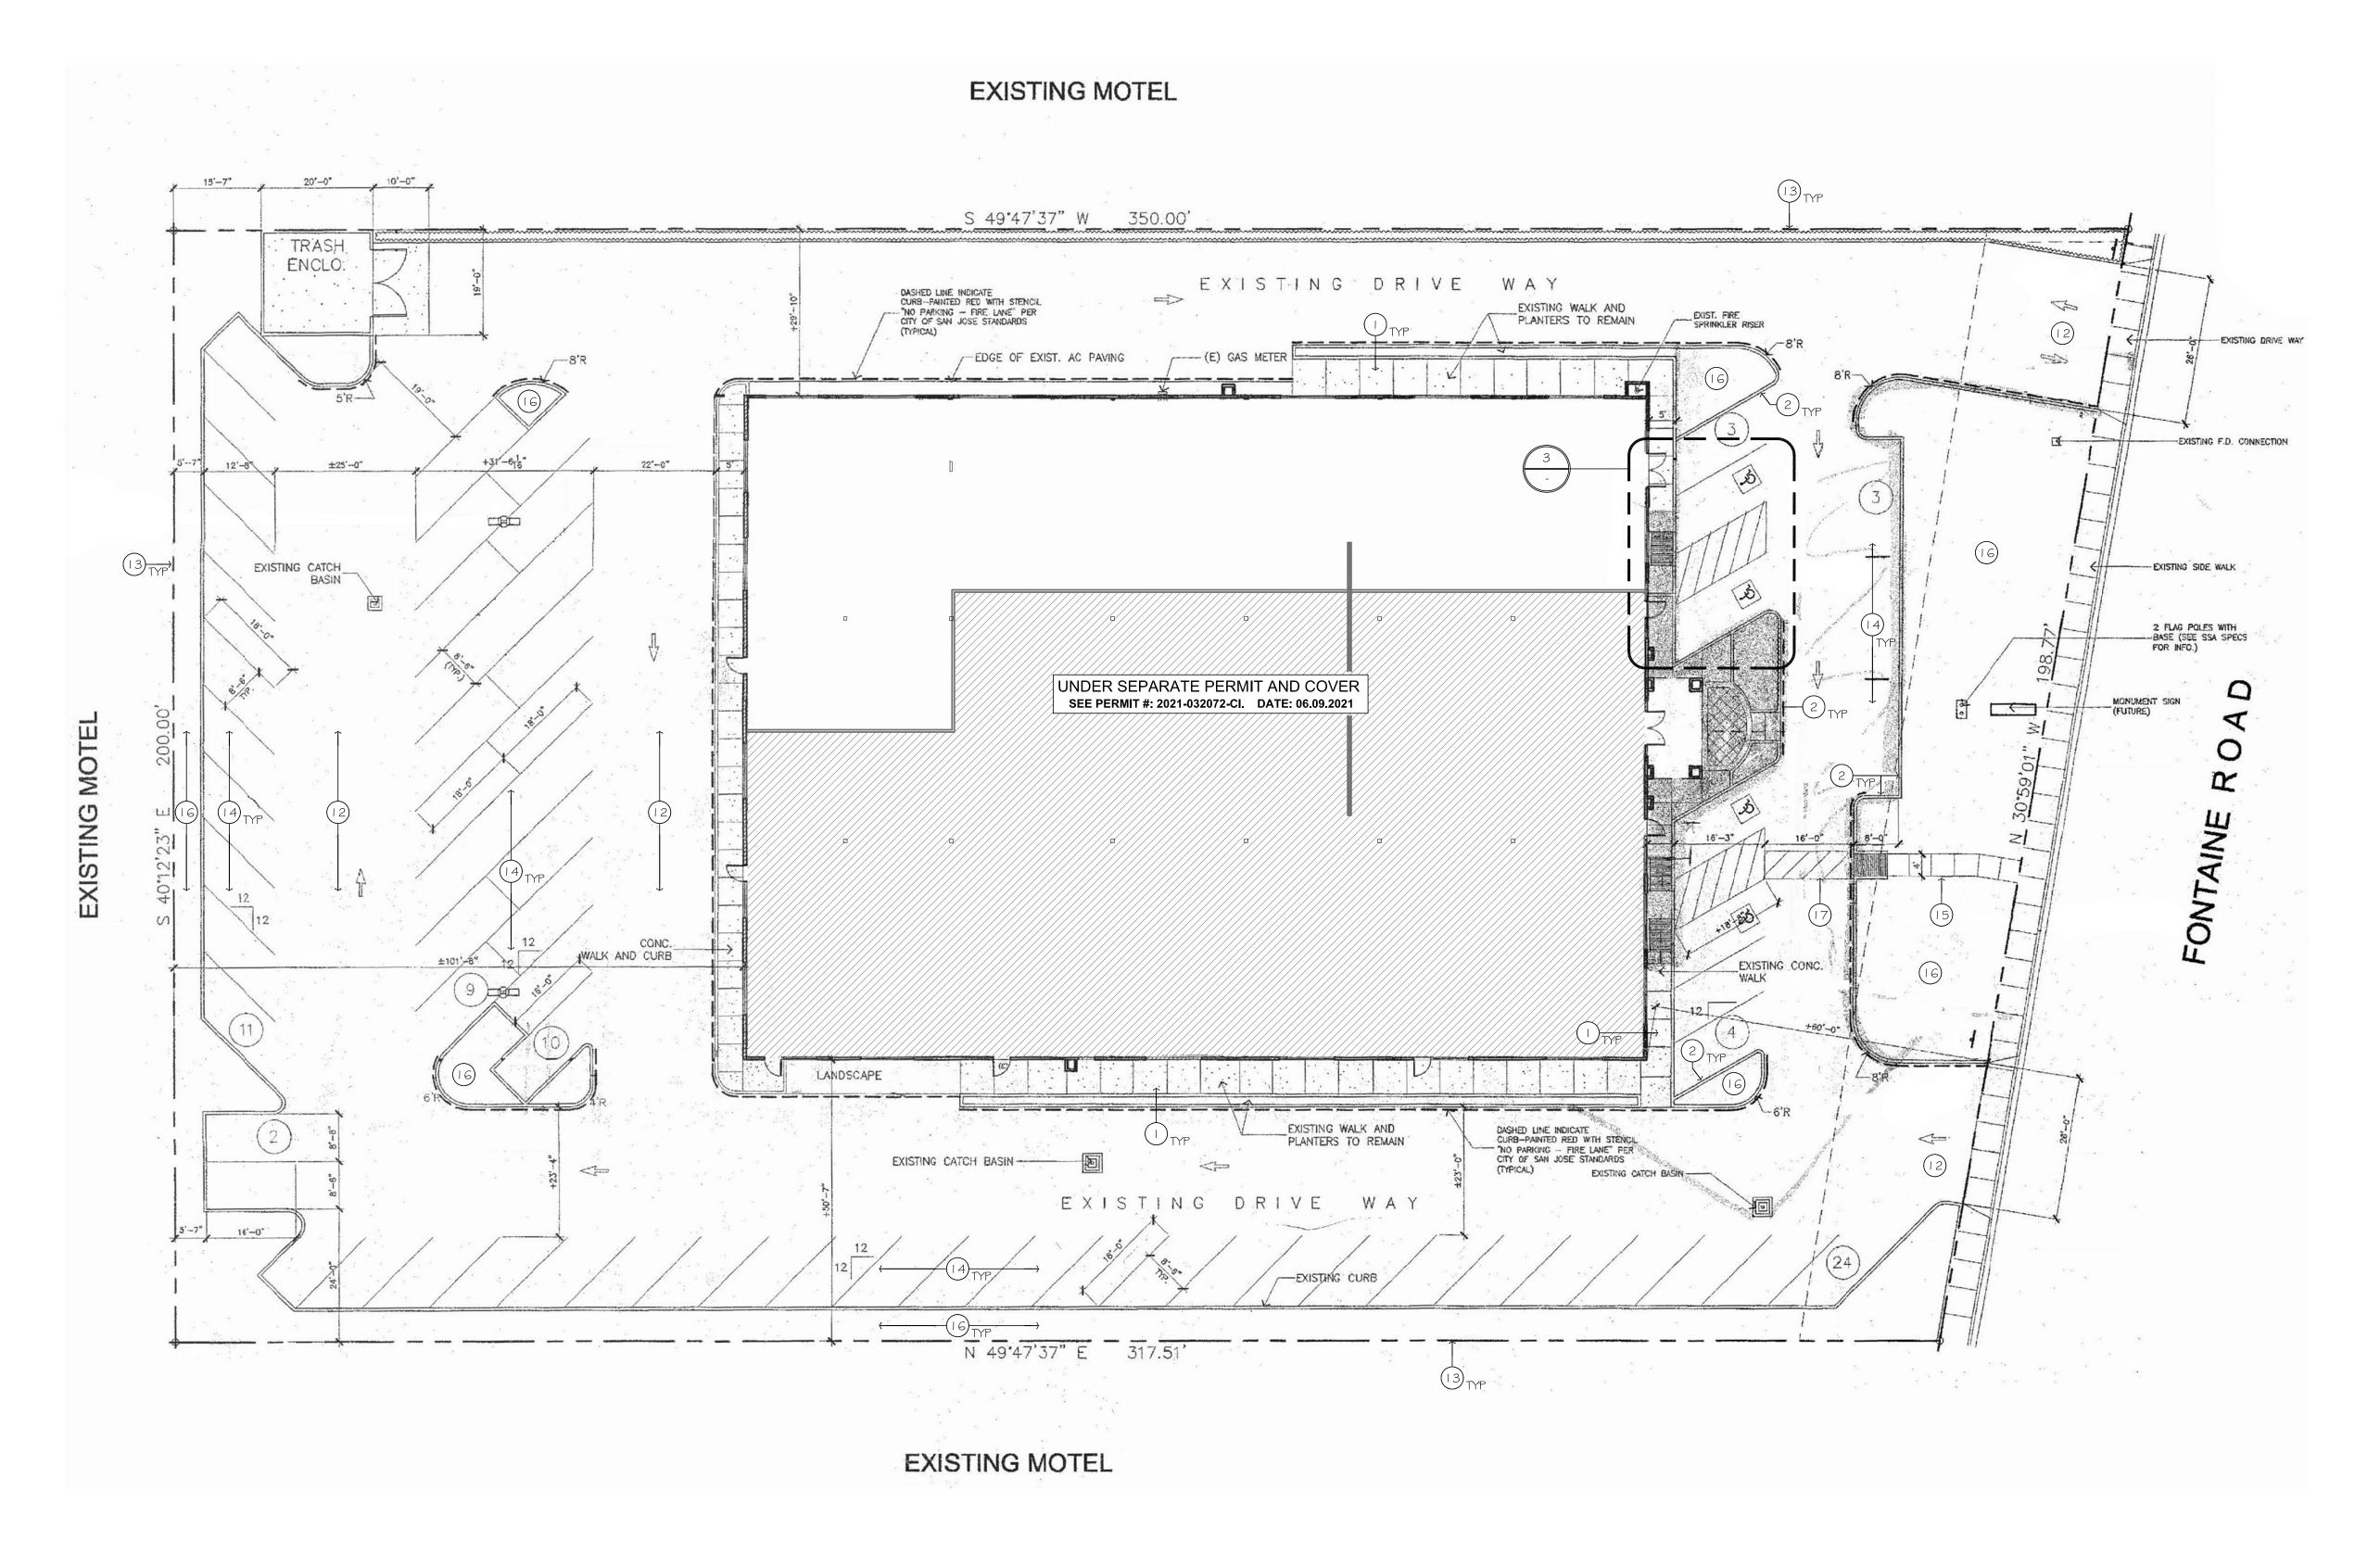

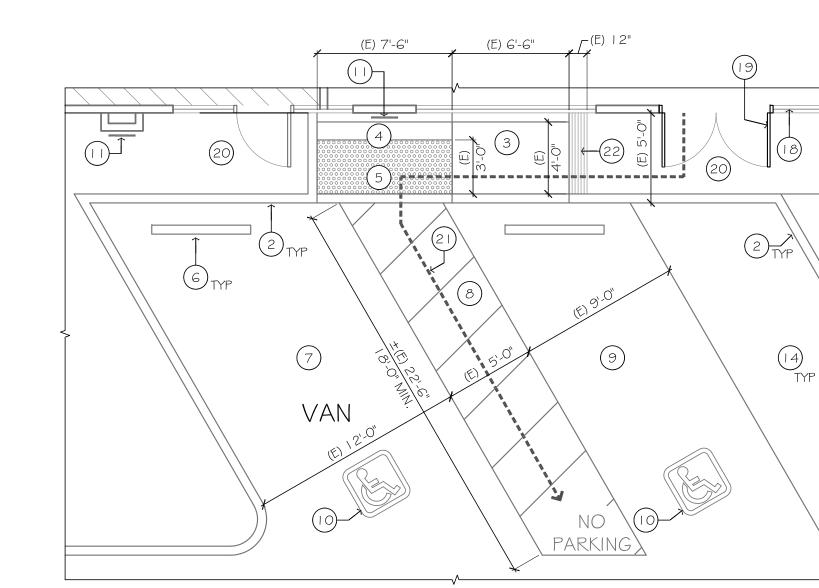

15. OVERALL SITE PLAN

A. ALL ACCESSIBLE PARKING STALLS SHALL BE ADA COMPLIANT.

F. ALL SITE CONDITIONS ARE EXISTING TO REMAIN, UON.

AS REQUIRED. SEE SITE DETAILS FOR REFERENCE TO SIRE SIGN DETAILS.

E. SEE "AS" SHEETS FOR REFERENCES FOR ALL REFERENCES TO ALL SITE ADA DETAILS.

ALL AREAS SHOWN HATCHED ARE EXISTING \$ NOT IN SCOPE OF WORK.

THE ACCESSIBLE PARKING STALLS SHALL HAVE A MAX. OF 2% SLOPE IN ANY DIRECTION.

B. CONTRACTOR TO FIELD VERIFY EXISTING TOW-AWAY SIGN AT THE PARKING ENTRANCE(S) DRIVE FOR COMPLIANCE. PROVIDE NEW

G. CONTRACTOR TO SUBMIT SHOP DRAWINGS & FINISH MATERIAL & SAMPLES TO ARCHITECT FOR REVIEW. PROVIDE MIN 3'-0" X

3'-0" MOCK UP SAMPLES OF ALL CONCRETE \$ PAINT FINISH \$ ALL OTHER FINISHES DEEMED NECESSARY FOR ARCHITECT REVIEW

D. PATCH AND REPAIR ALL AREA DAMAGED DUE TO ANY NEW CONSTRUCTION AS REQUIRED TO MATCH EXISTING OR BETTER.

SCALE: 1/16"=1'-0"

LEGEND


GENERAL SITE PLAN NOTES

PRIOR TO PURCHASE/FABRICATION.

ACCESSIBLE PATH OF TRAVEL

KEYNOTES Indicated by (X) on the plan.

- I. (E) WALKWAY TO REMAIN, TYP.
- 2. (E) CONC. CURB TO REMAIN. 3. (E) ACCESSIBLE CONCRETE CURB RAMP TO REMAIN.
- 4. (E) ACCESSIBLE LANDING TO REMAIN. SEE REF. DETAIL 7/AS.3. 5. (E) DETECTABLE WARNING DOMES TO REMAIN. SEE REF. DETAIL 8/AS.3.
- 6. (E) CONC. WHEEL STOP. SEE REF. DETAIL 9/AS.3.
- 7. (E) VAN ACCESSIBLE PARKING STALLS. SEE REF. DETAIL 2/AS.3.
- 8. (E) ACCESSIBLE STRIPING WITH LETTERS READING "NO PARKING" TO REMAIN, SEE REF. DETAIL 2/AS.3.
- 9. (E) STANDARD ACCESSIBLE PARKING STALL. SEE REF. DETAIL 2/AS.3.
- IO. (E) INTERNATIONAL SYMBOL OF ACCESSIBILITY PARKING STALL MARKING. SEE REF DETAIL 4/AS.3.
- I. (E) WALL-MOUNTED ACCESSIBLE PARKING SIGNAGE. SEE SIMILAR DETAIL 5/AS.3.
- I 2. (E) DRIVEWAY TO REMAIN. 13. PROPERTY LINE.
- 14. (E) PARKING STALLS TO REMAIN THROUGHOUT.
- 15. (E) 4'-0"W MIN. ACCESSIBLE CONC. WALK TO REMAIN. SEE SIMILAR DETAIL 2/AS.3. I G. (E) LANDSCAPING TO REMAIN.
- 17. (E) 4'-0"W MIN. ACCESSIBLE STRIPING TO REMAIN. SEE REF. DETAIL 2/AS.3. 18. (N) INTERNATIONAL SYMBOL OF ACCESSIBILITY SIGNAGE AT MAIN ENTRY, MATCHING (E) BUILDING STANDARDS. SEE DETAIL 3/AS.3.
- PROVIDE WHITE VINYL BACKING IF MOUNTED ON GLASS TO COMPLETELY CONCEAL ADHESIVE FROM BEHIND. 19. (N) ENTRANCE DOOR. SEE PROPOSED FLOOR PLAN AND DOOR SCHEDULE FOR MORE INFO.
- 20. (E) ACCESSIBLE LANDING: MAX 2% IN ALL DIRECTIONS, MAX 5%IN DIRECTION OF TRAVEL AT WALKWAYS WITH MAX OF 2% CROSS
- 21. (E) ACCESSIBLE PATH OF TRAVEL.
- 22. (E) CONCRETE GROOVES AT TOP OF LANDING. SEE REF. DETAIL 10/AS.3.

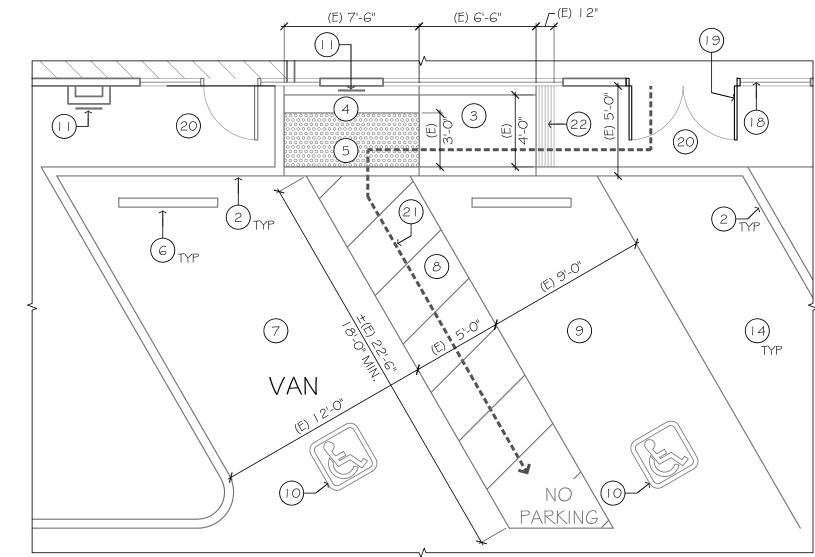

3. EXISTING ACCESSIBLE PARKING

SCALE: 3/16"=1'-0"

NORTH

PARKING ANALYSIS (Existing to Remain) PARKING REQUIRED: RATIO PARKING REQUIRED 19,427 SF 16,513 SF TOTAL 66 STALLS 66 STALLS ACCESSIBLE PARKING REQUIRED:

PARKING REQUIRED ADA STALLS REQUIRED ADA STALLS PROVIDED SOCIAL SERVICE 44 STALLS I VAN, I REGULAR I VAN, I REGULAR BUSINESS (VACANT) 22 STALLS I VAN, I REGULAR I VAN 66 STALLS 2 VAN, 1 REGULAR 2 VAN, 2 REGULAR





PROJECT ADDRESS

2500 FONTAINE ROAD SAN JOSE, CA 95121

MARKET READY IMPROVEMENTS for

2500 FONTAINE ROAD

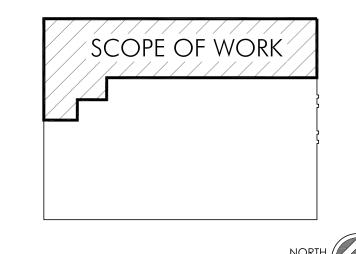

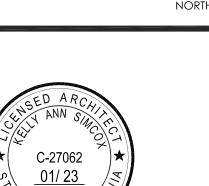



ALL DESIGNS, DRAWINGS AND WRITTEN MATERIALS INDICATED HEREIN ARE THE WORK AND PROPERTY OF STUDIO:G ARCHITECTS. THIS DOCUMENT MAY NOT BE DUPLICATED, REUSED OR DISCLOSED BY ANY METHOD WITHOUT THE WRITTEN CONSENT OF STUDIO:G ARCHITECTS. ALL RIGHTS RESERVED.

DATE	DESCRIPTIO
.03.2021	PERMIT ADJUSTMENT SUBMITT

DATE	07.30.2021
SCALE	AS SHOWN
PROJECT ID	2020.92
DRAWN BY	KL

SITE PLANS

SHEET TITLE

SHEET NO.

JURISDICTION APPROVAL STAMP