

BENCH MARK TABLE			
BM NO.	DESCRIPTION	LOCATION	ELEVATION
BM #1	Paint Dot	Lift Station	934.21'
BM #2	RR Spike	Power Pole	934.45'

DELTA 3
ENGINEERING INC.


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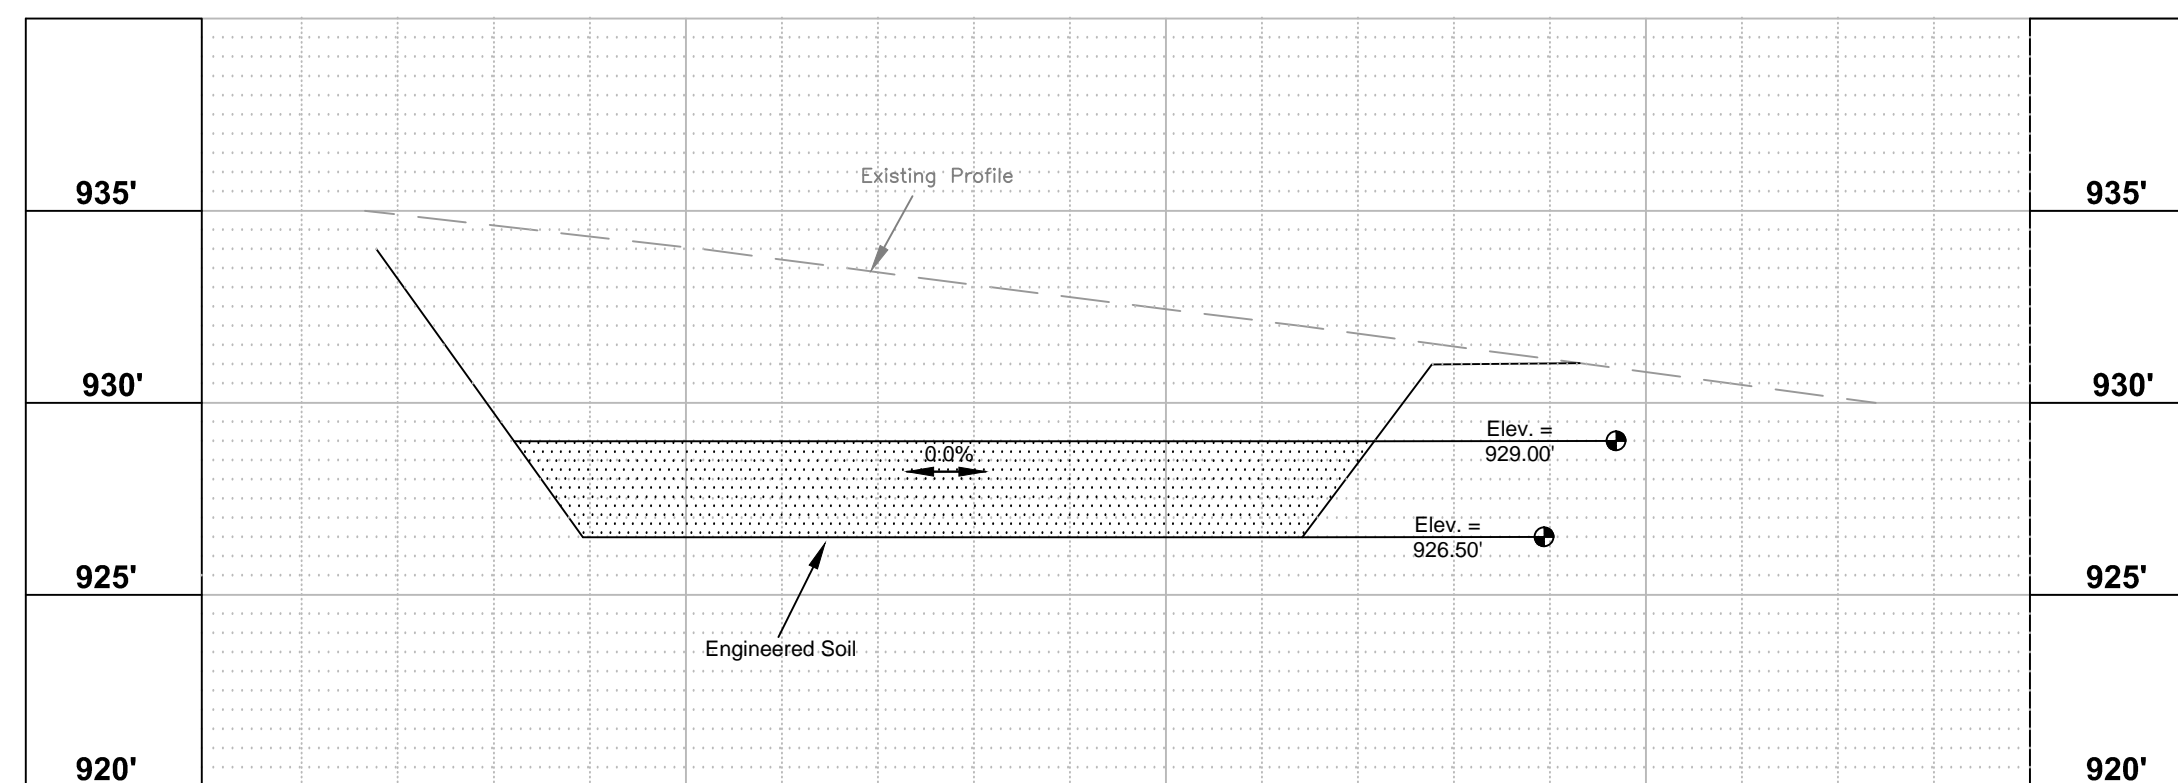
3681 PRISM LANE, KIELER, WI 53812

REVISIONS:		
NO.	DATE	DESCRIPTION
1	8/14/14	WDNR NOI SUB.
2	9/15/14	ADDED SIDEWALK ON NORTH SIDE
3	11/6/14	DOWNSPOUT #13 ADDED


For Construction	
PROJECT NUMBER	D14-041
SHEET SCALE	1" = 20'
DRAWN BY	C.Coyier
DATE ISSUED	November 6, 2014
SHEET NUMBER	C102 Proposed Site




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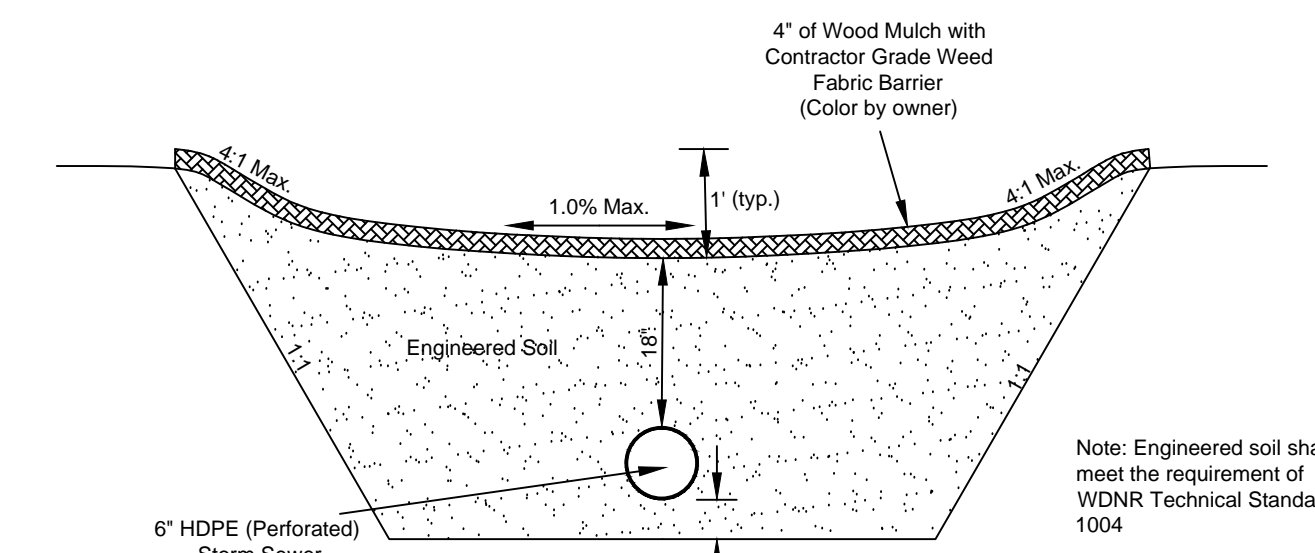
CROSS-SECTION A-A

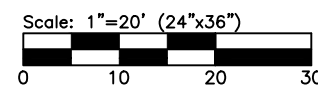

CROSS-SECTION C-C


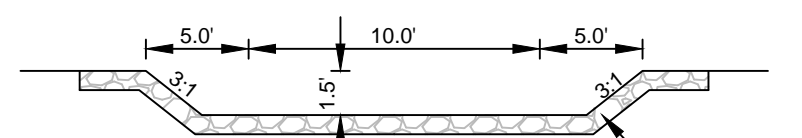


CROSS-SECTION B-B

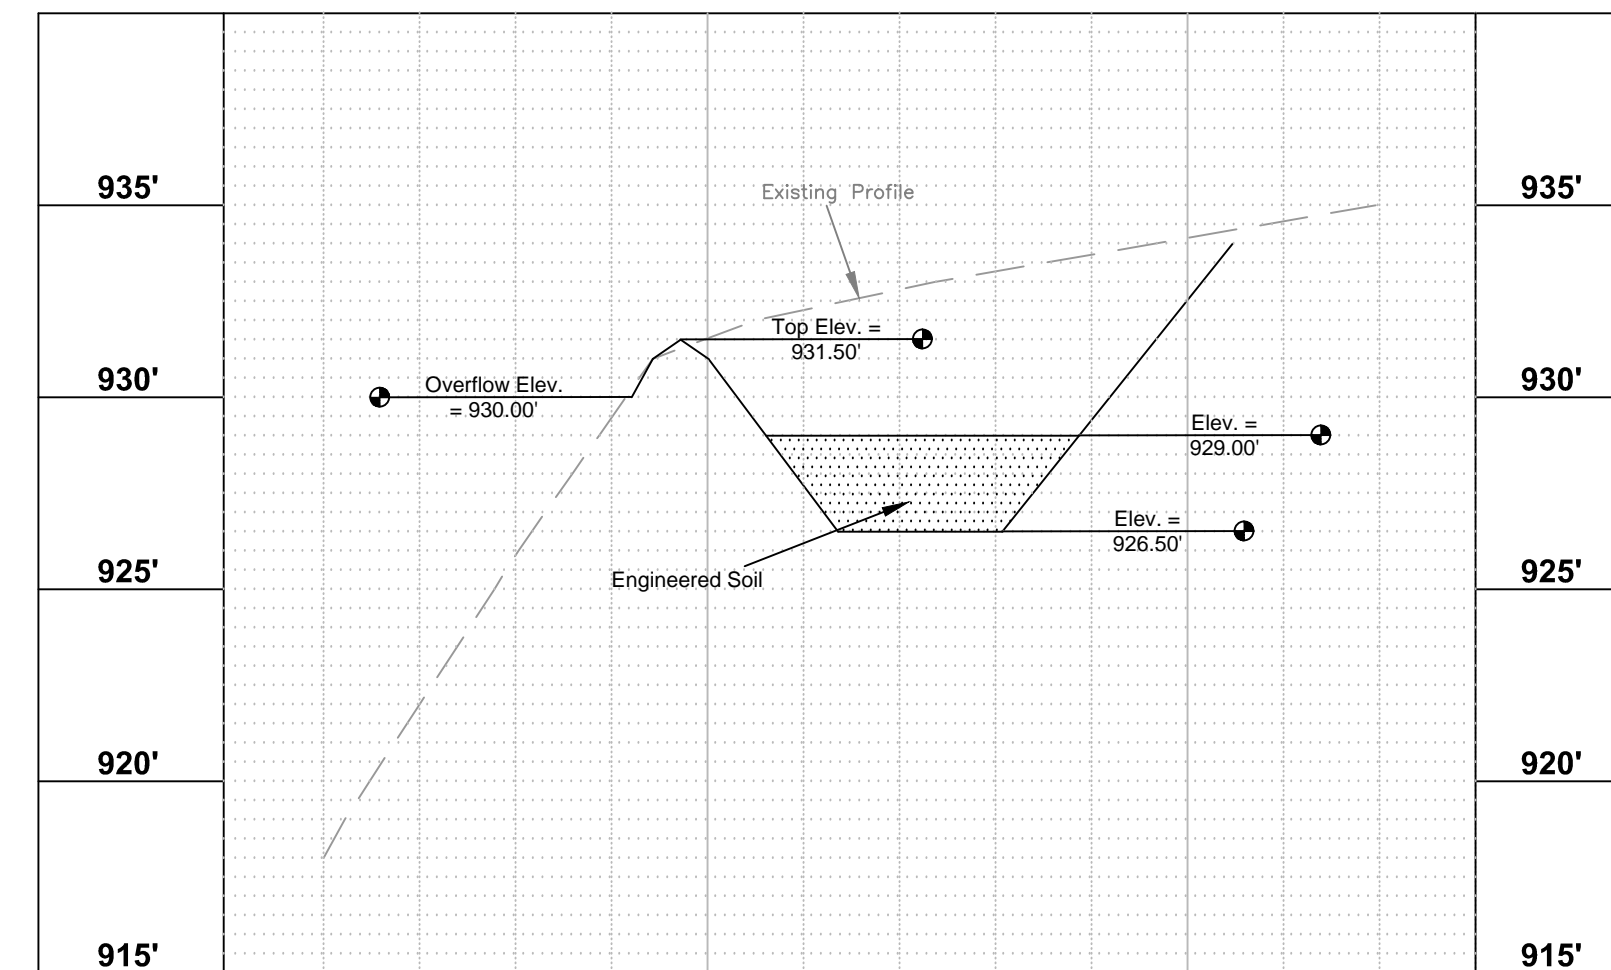

BIORETENTION DETAIL

Scale: N.T.S.

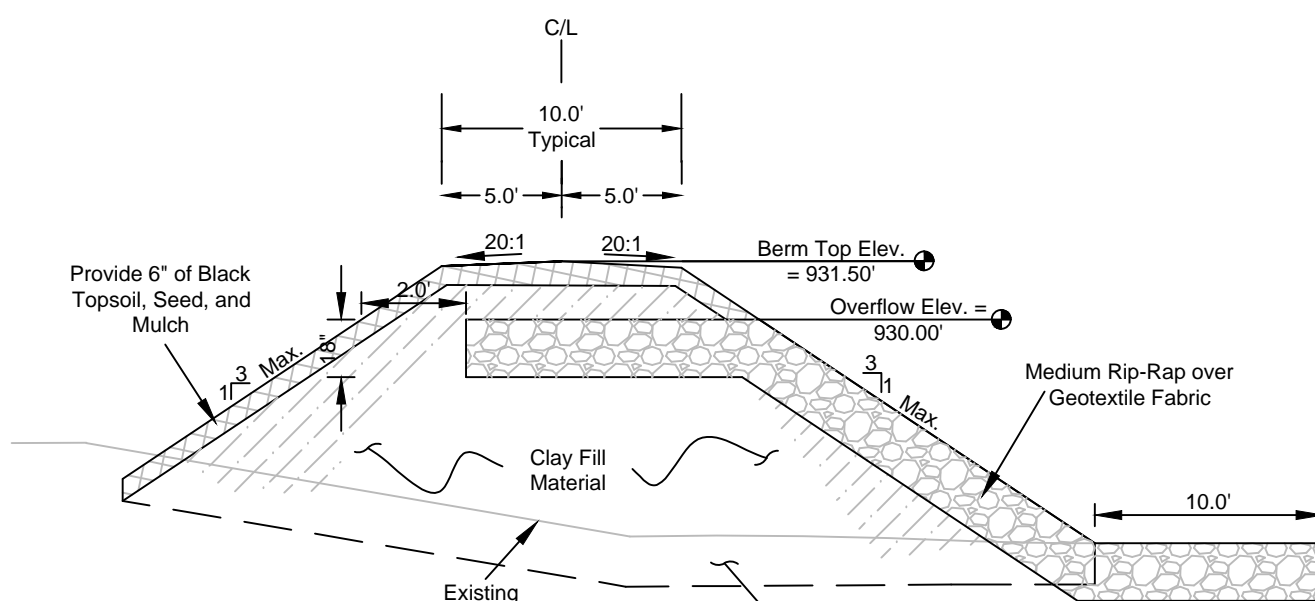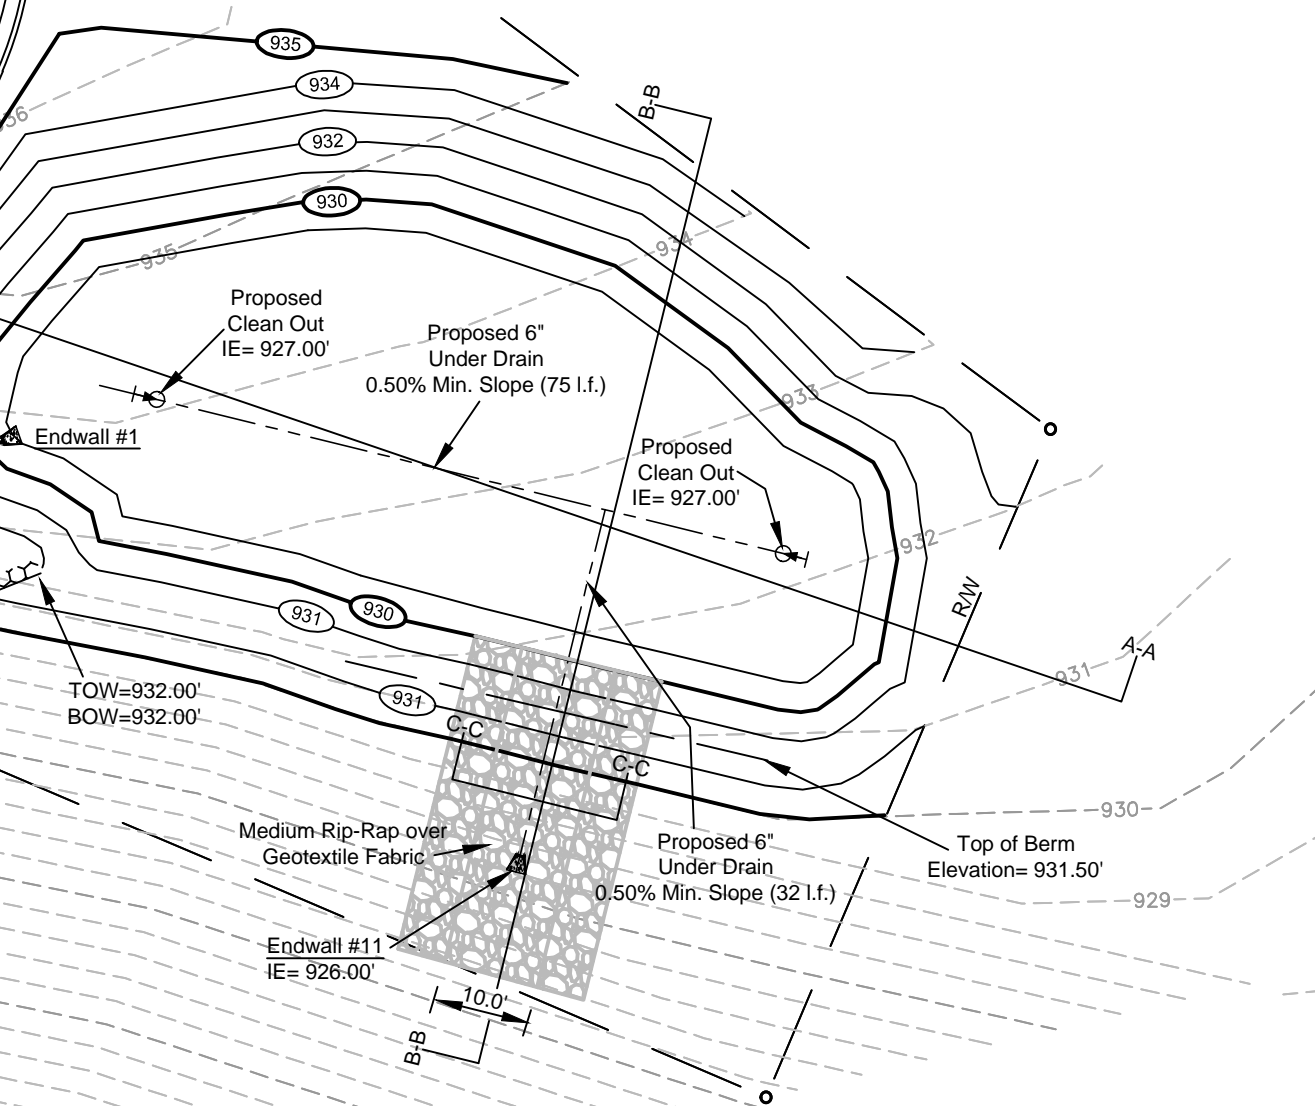



BIORETENTION OVERFLOW

CROSS-SECTION

Scale: N.T.S.

[illegible]


For Construction	
PROJECT NUMBER	D14-041
SHEET SCALE	1" = 20'
DRAWN BY	K.Kobbervig
DATE ISSUED	November 6, 2014
SHEET NUMBER	C103

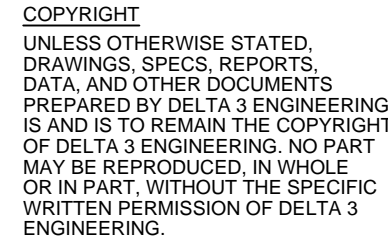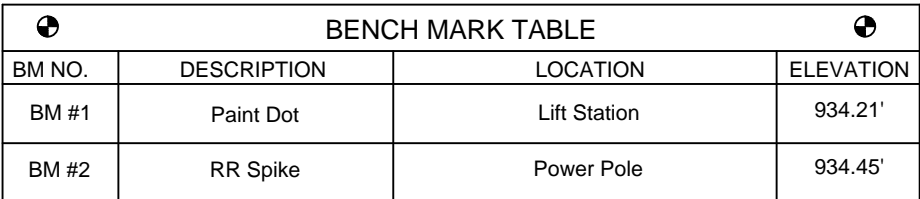

3681 PRISM LANE, KIELER, WI 53812







For Construction	
PROJECT NUMBER	D14-041
SHEET SCALE	1" = 20'
DRAWN BY	L. Rupp
DATE ISSUED	November 6, 2014
SHEET NUMBER	C104 Landscaping & Erosion Control Plan

- | | |
|-------------------|--|
| PROJECT
NUMBER | D14-041 |
| SHEET
SCALE | 1" = N.T.S. |
| DRAWN
BY | C.Coyler |
| DATE
ISSUED | November 6, 2014 |
| SHEET
NUMBER | C105
Details - Erosion Control |

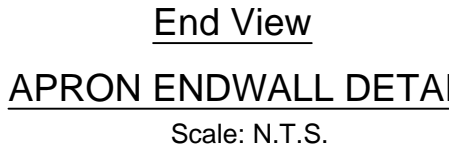




MINIMUM LENGTH OF APRON (FEET)												
PIPE DIAMETER												
	12"	15"	18"	21"	24"	27"	30"	36"	42"	48"	54"	60"
3cfs	8											
5cfs	8											
8cfs	11	10										
10cfs	14	12	10									
15cfs	18	16	14	12								
20cfs		18	18	16	12							
30cfs			22	20	18	16						
40cfs			26	24	24	20	18					
50cfs				26	24	22	18					
70cfs					30	28	25					
100cfs						36	36	33	27			
150cfs						42	42	42	38	33	28	
200cfs								48	45	42	37	32

From USDA Soil Conservation Service

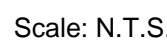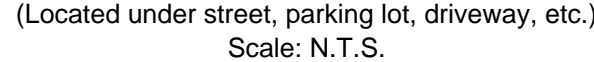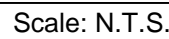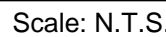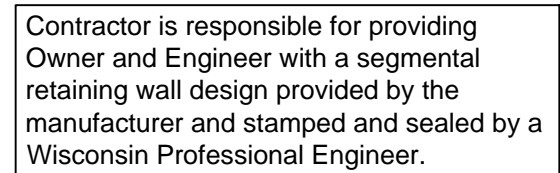
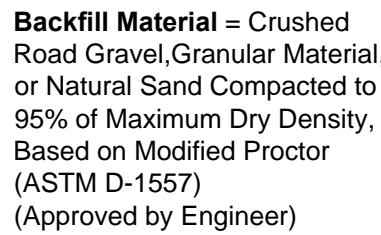


Scale: N.T.S


2. Contractor will be responsible for replacement of all disturbed project area components including, but not limited to, existing concrete, bituminous pavement, gravel, culverts, water and sanitary sewer components, storm sewer system components, mailboxes, lawn ornaments, and landscaping that are not specifically noted for removal.

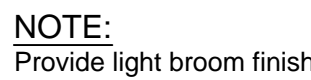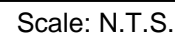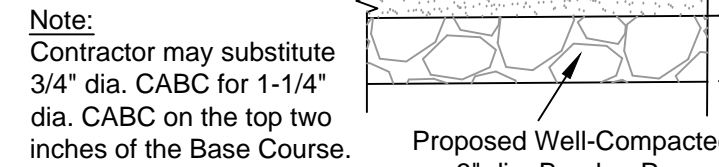

Scale: N.T.S.

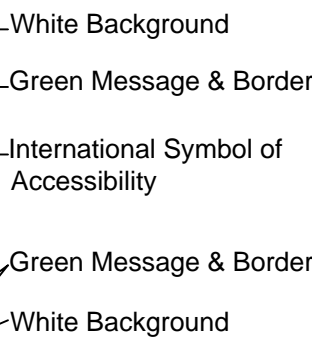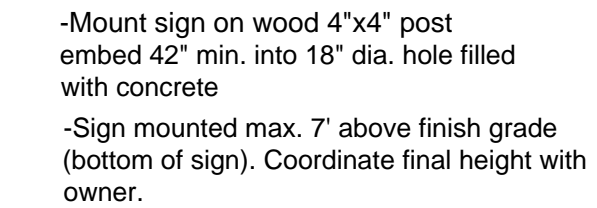


Scale: N.T.S.

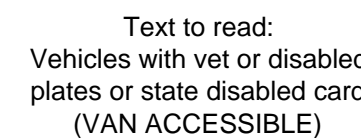


Scale: N.T.S.


- Ramps shall be built at 12H:1V or flatter. When necessary, the sidewalk elevation may be lowered to meet the high point on the ramp.

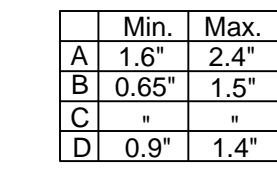

Scale: N.T.S.

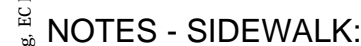

1. All joints shall be hand tooled; no sawcutting will be permitted.
2. Score all new concrete to match adjacent work.
3. Provide #4 epoxy-coated, smooth dowel bars between new and existing concrete sidewalk.
4. Provide light broom finish.

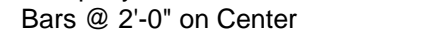

Scale: N.T.S.

[illegible]

PROJECT NUMBER	D14-041
SHEET SCALE	1" = N.T.S.
DRAWN BY	L. Rupp
DATE ISSUED	August 31, 201
SHEET NUMBER	C106