Existing Building Renovation for

KeyStone Fireworks

651 Carey Avenue
Wilkes-Barre, Hanover Township, PA 18706
Luzern County



Architectural
G-101 LIFE SAFETY PLANS
A-101 LEVEL 1 FLOOR PLAN
A-201 EXTERIOR ELEVATIONS

GENERAL CONSTRUCTION NOTES

1. WORK OF THIS PROJECT INVOLVES MODIFICATIONS TO AN EXISTING BUILDING. CONTRACT DOCUMENTS ARE BASED ON ORIGINAL BUILDING CONSTRUCTION DOCUMENTS TO THE EXTENT THEY ARE AVAILABLE, WITH ADDITIONAL FIELD OBSERVATION AND MEASUREMENT WHERE FEASIBLE.

FIELD ENGINEERING AND LAYOUT IS THE RESPONSIBILITY OF CONTRACTOR. CONTRACTOR SHALL VISIT THE SITE AND VERIFY EXISTING CONDITIONS BY SURVEY AND MEASUREMENT PRIOR TO STARTING WORK. CONTRACTOR SHALL MAKE FIELD MEASUREMENTS AS REQUIRED TO FIT WORK PROPERLY. WHERE PORTIONS OF THE WORK ARE INDICATED TO FIT WITH EXISTING CONDITIONS, VERIFY DIMENSIONS, SIZES AND CONFIGURATIONS OF EXISTING CONDITIONS BY FIELD MEASUREMENT BEFORE BEGINNING FABRICATION. COORDINATE FABRICATION SCHEDULE WITH CONSTRUCTION PROGRESS TO AVOID DELAYING THE WORK. IMMEDIATELY UPON DISCOVERY OF THE NEED FOR CLARIFICATION OF THE CONTRACT DOCUMENTS, SUBMIT A REQUEST FOR INTERPRETATION TO PROFESSIONAL. INCLUDE A DETAILED DESCRIPTION OF NEW CONSTRUCTION

ALL WORK, CONSTRUCTION AND MATERIALS SHALL COMPLY WITH THE PROVISIONS OF THE INTERNATIONAL BUILDING CODE 2009 AND SUPPLEMENTARY MODIFICATIONS MADE BY THE LOCAL MUNICIPALITY. IT IS THE RESPONSIBILITY OF EACH CONTRACTOR SUPPLYING LABOR AND/OR MATERIAL TO BRING TO THE ATTENTION OF THE PROFESSIONAL ANY DISCREPANCIES OR CONFLICTS BETWEEN THE REQUIREMENTS OF THE CODE AND THE DRAWINGS, SHOULD SUCH BE DISCOVERED. THE APPLICABLE CODES SHALL INCLUDE, BUT SHALL NOT BE LIMITED TO: INTERNATIONAL BUILDING CODE, INTERNATIONAL PLUMBING CODE, NATIONAL ELECTRICAL CODE, INTERNATIONAL MECHANICAL CODE, INTERNATIONAL FIRE CODE ALL AS AUTHORIZED AND MODIFIED

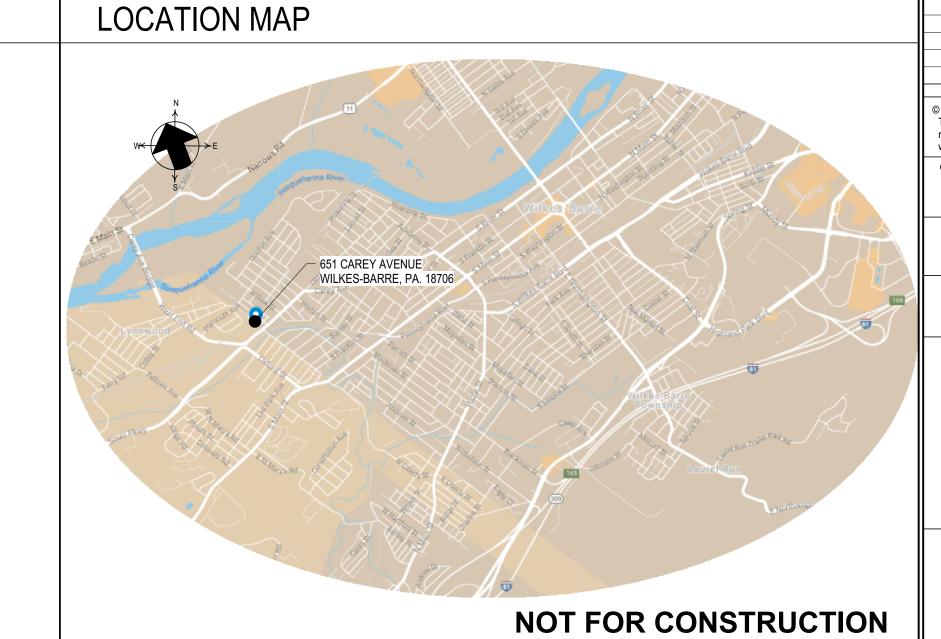
4. CONTRACTOR (S) SHALL BE RESPONSIBLE FOR OBTAINING ALL REQUIRED PERMITS.

TO COORDINATE WITH EXISTING CONDITIONS.

BY THE LOCAL MUNICIPALITY.

- 5. DO NOT SCALE DRAWINGS. DRAWINGS INCLUDE GRAPHIC DIMENSIONS FOR THE CONTRACTORS USE. IF DIMENSIONAL INFORMATION NOT SHOWN IS REQUIRED, CONTACT THE PROFESSIONAL.
- 6. CONTRACTOR (S) SHALL FIELD VERIFY ALL DIMENSIONAL INFORMATION PROVIDED IN THESE DRAWINGS. DIMENSIONAL CONFLICT BETWEEN DRAWINGS AND ACTUAL FIELD CONDITIONS ARE TO BE BROUGHT TO THE ATTENTION OF THE PROFESSIONAL BEFORE PROCEEDING WITH THE WORK.
- 7. ANY DISPREPANCIES BETWEEN DRAWINGS AND SPECIFICATIONS AND/OR AMONG DRAWINGS ARE TO BE BROUGHT TO THE ATTENTION OF THE PROFESSIONAL FOR IMMEDIATE CORRECTION BEFORE PROCEEDING WITH WORK.

8. CLEAN WORK AREA DAILY. MAINTAIN PROJECT SITE FREE OF WASTE MATERIAL AND DEBRIS. HAND WIPE ALL PIPING, CONDUIT, EXPOSED SYSTEMS, GLAZING, ETC. PROVIDE FINAL CLEANING PRIOR TO USING AGENCY OCCUPANCY.



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works

KeyStone Firev

revisions

NO. date description

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date
drawn by Author
Issue Date
checked by Checker

project number 77249-00
drawing set

rowing title

COVER SHEET

sheet no.

G-001

KEYSTONE FIRWORKS BUILDING CODE INFORMATION SUMMARY WILKES-BARRE, PA, HANOVER TOWNSHIP, LUZERN COUNTY

PENNSYLVANIA CODES IN FORCE 2009 INTERNATIONAL EXISTING BUILDING CODE - LEVEL 2 RENOVATION 2009 INTERNATIONAL BUILDING CODE 2009 INTERNATIONAL FIRE CODE NFPA 101 LIFE SAFETY CODE IN NOT IN FORCE, EXCEPT AS SPECIFICALLY REFERENCED 2009 INTERNATIONAL MECHANICAL CODE 2009 INTERNATIONAL PLUMBING CODE 2008 NFPA 70 NATIONAL ELECTRIC CODE 2009 INTERNATIONAL ENERGY CONSERVATION CODE OR 2007 ASHRAE 90-1 2009 INTERNATIONAL FUEL GAS CODE

GENERAL BUILDING INFORMATION

EXISTING TOTAL EGRESS WIDTH = 102"

ADDITIONAL INFORMATION

MAX TO THE OPERATING BUTTONS OR UNITS

DISTANCE TO NEAREST GAS PUMP = 250'-0"

ALL OPERATING COMPONENTS LOCATED ON WALLS SHALL BE MOUNTED AT 48"

2006 ANSI A117.1 ACCESSIBLE AND USABLE BUILDINGS AND FACILITIES

(IBC CHAPTER 7) FIRE SAFETY SYSTEM: NEW SPRINKLER SYSTEM TO BE PROVIDED THROUGHOUT USE AND OCCUPANCY CLASSIFICATION: (IBC SECTION 508.4) (IBC SECTION 306.3) H-3 - HIGH HAZARD (CONSUMER FIREWORK SALES) (IBC SECTIONS 304.1, 307.6 & 311.3) **CONSTRUCTION TYPE:** (IBC SECTION 602) (IBC TABLE 601) CONSTRUCTION TYPE: TYPE IIIb (IBC SECTION 1016) MAXIMUM EXIT ACCESS TRAVEL DISTANCE = 150' w/ AUTOMATIC SPRINKLER SYSTEM THROUGH OUT (IBC SECTION 1005) EGRESS WIDTH (IBC SECTION 1014.3) COMMON PATH OF EGRESS TRAVEL - 25' COMMON PATH OF EGRESS TRAVEL DOES NOT APPLY TO STORIES OR SPACES WITH ONLY ONE EXIT (IBC SECTION 1015.1) TRAVEL DISTANCE FOR "H-3" OCCUPANCY - 150FT WITH SPRINKLER SYSTEM (IBC TABLE 1016.1)

REQUIRED EGRESS WIDTH @ .2" PER OCCUPANT X 194 = 32" [(194x.2" =3.88")< 32"] MINIMUM REQUIREMENT IS 32" (IBC SECTION 1005.1)

EXISTING BUILDING RENOVATION KEYSTONE FIREWORKS INTERNATIONAL EXISTING BUILDING CODE - LEVEL 2 ALTERATIONS IBC HEIGHT & AREA COMPUTATIONS (Chapter 3 and 5 and Table 503) Use Group Classification (Section 302) "H-3 HIGH HAZARD Allowable Building Height Actual Building Height (Feet/Stories) (Feet/Stories) (Table 503, Section 504.0) 18'-8"/2 (EXISITING) AREA INCREASES FOR FRONTAGE AND SPRINKLER (506.1) Aa=(At + [At x lf] + [At x ls])Aa = Allowable area per story (sqft) At = Tabular area per story in accordance with Table 503 (sqft) If = Area increase factor due to frontage in accordance with Section 506.2 Is = Area increase factor due to sprinkler protection in accordance with Section 506.3 FRONTAGE INCREASE (506.2) If = (F / P - 0.25) W / 30 If = Area increase due to frontage F = Building perimeter that fronts on a public way or open space having 20ft open minimum width (ft) P = Perimeter of entire building (ft) W = Width of public way or open space (ft) in accordance with Section 506.2.1 Construction Type = IIIB Tabular Area (At) 60' - 0" ft. Frontage (F) 440' - 0" ft Perimeter (P) 60' - 0" _{ft} Width (W) If = (60' - 0" / 440' - 0" - .25) 60' - 0" / 30

Allowable Area (Aa) = (9,745 + (9,745 * -0.227273) + (9,745 * 2))

If = -0.227273

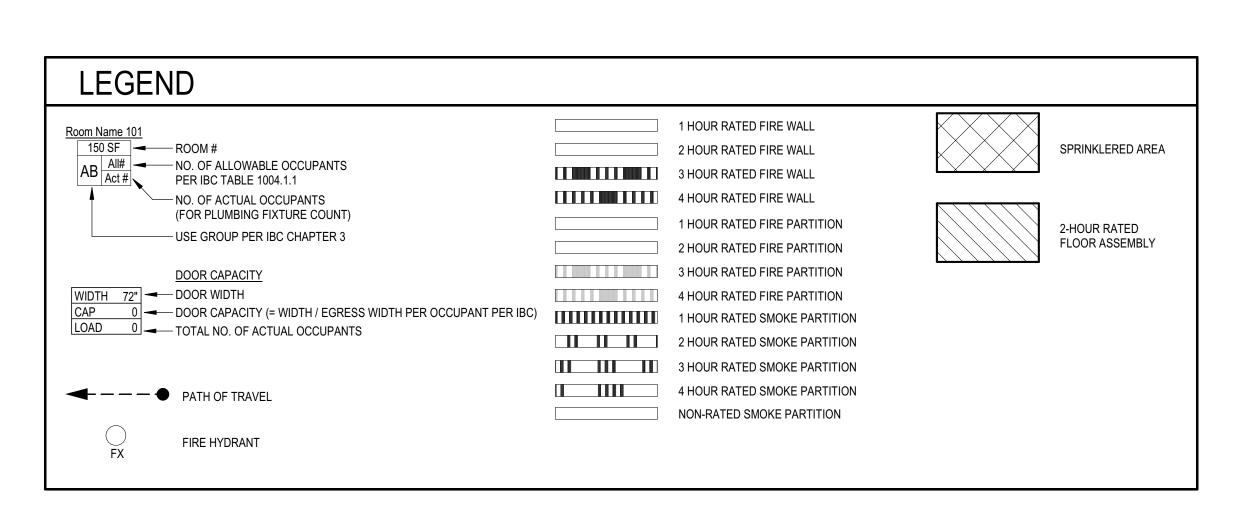
(ICC A117.1-2009)

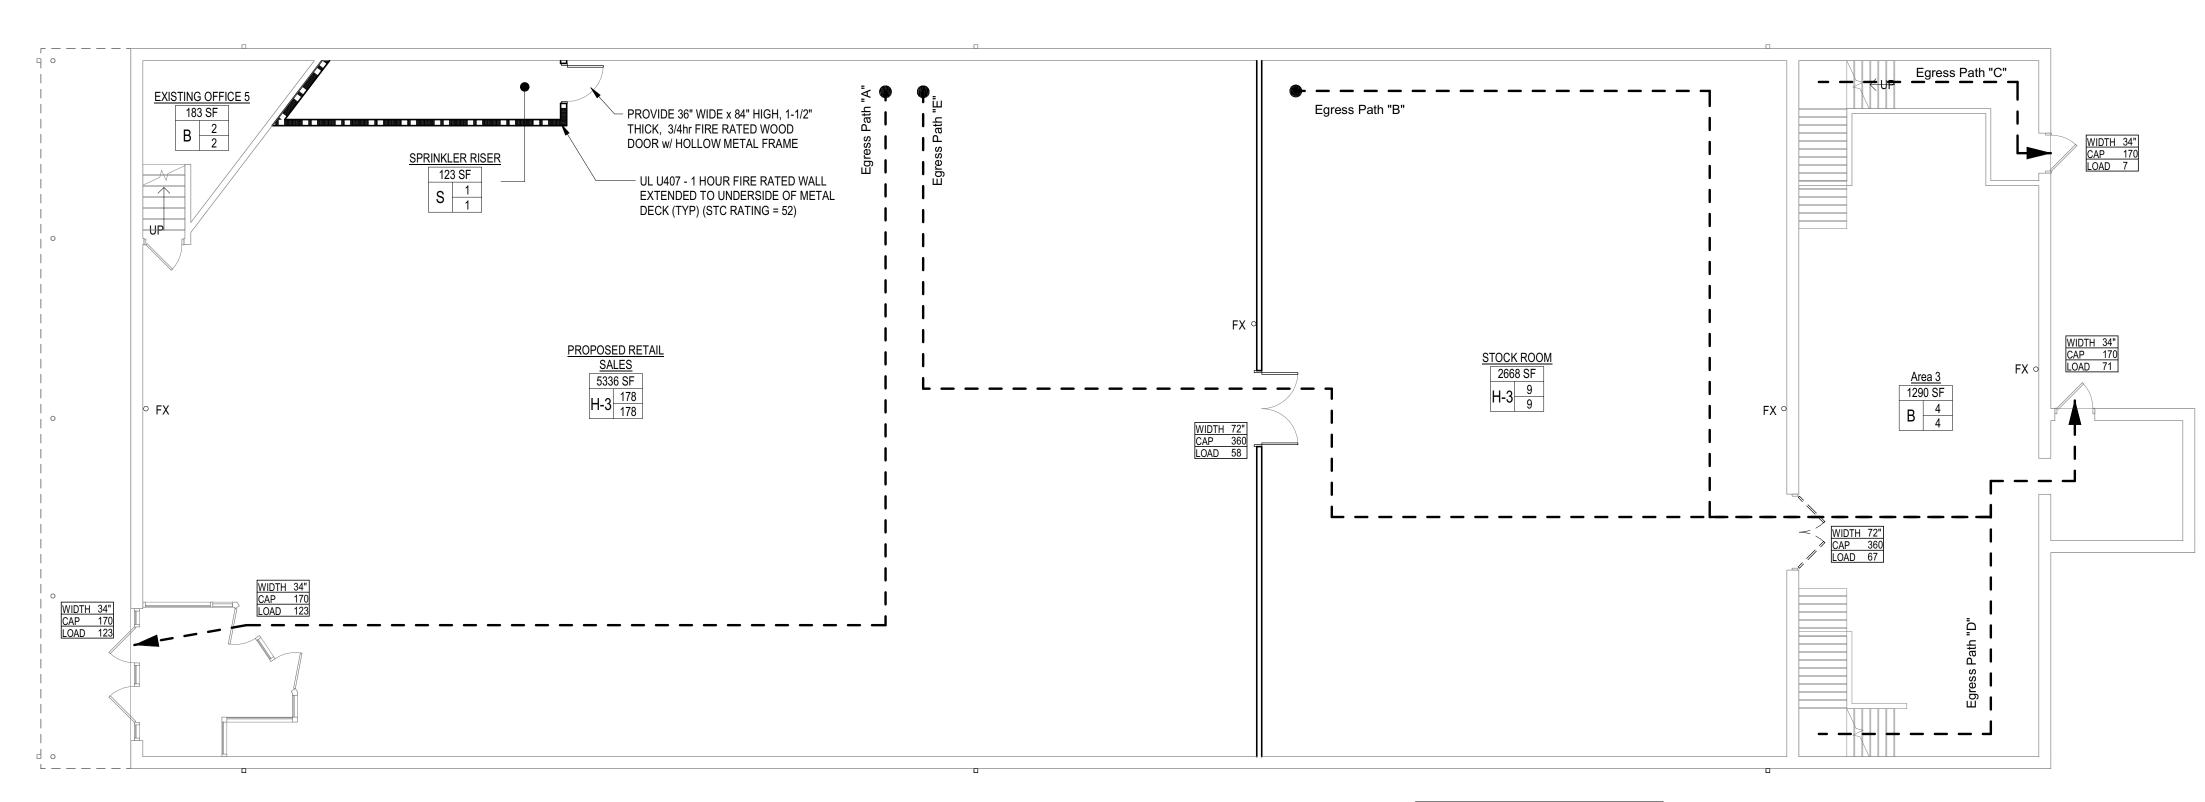
LIFE SAFETY PLAN - LEVEL 1

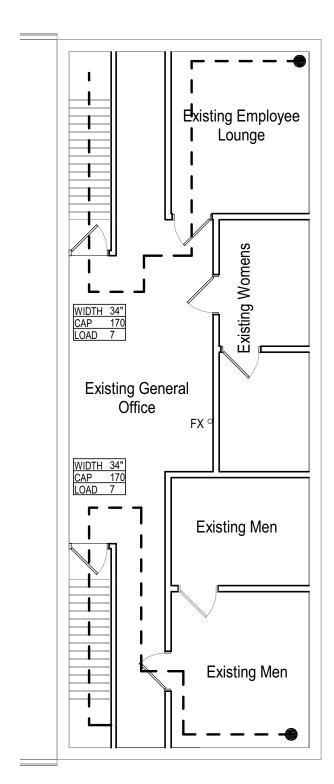
SCALE: 1/8" = 1'-0"

(ICC A117.1-2009 - SECTION 308)

Allowable Area (Aa) = 27,020 sqftProposed Area = 9745 sqft








2 LIFE SAFTEY PLAN - LEVEL 2 (NO WORK)

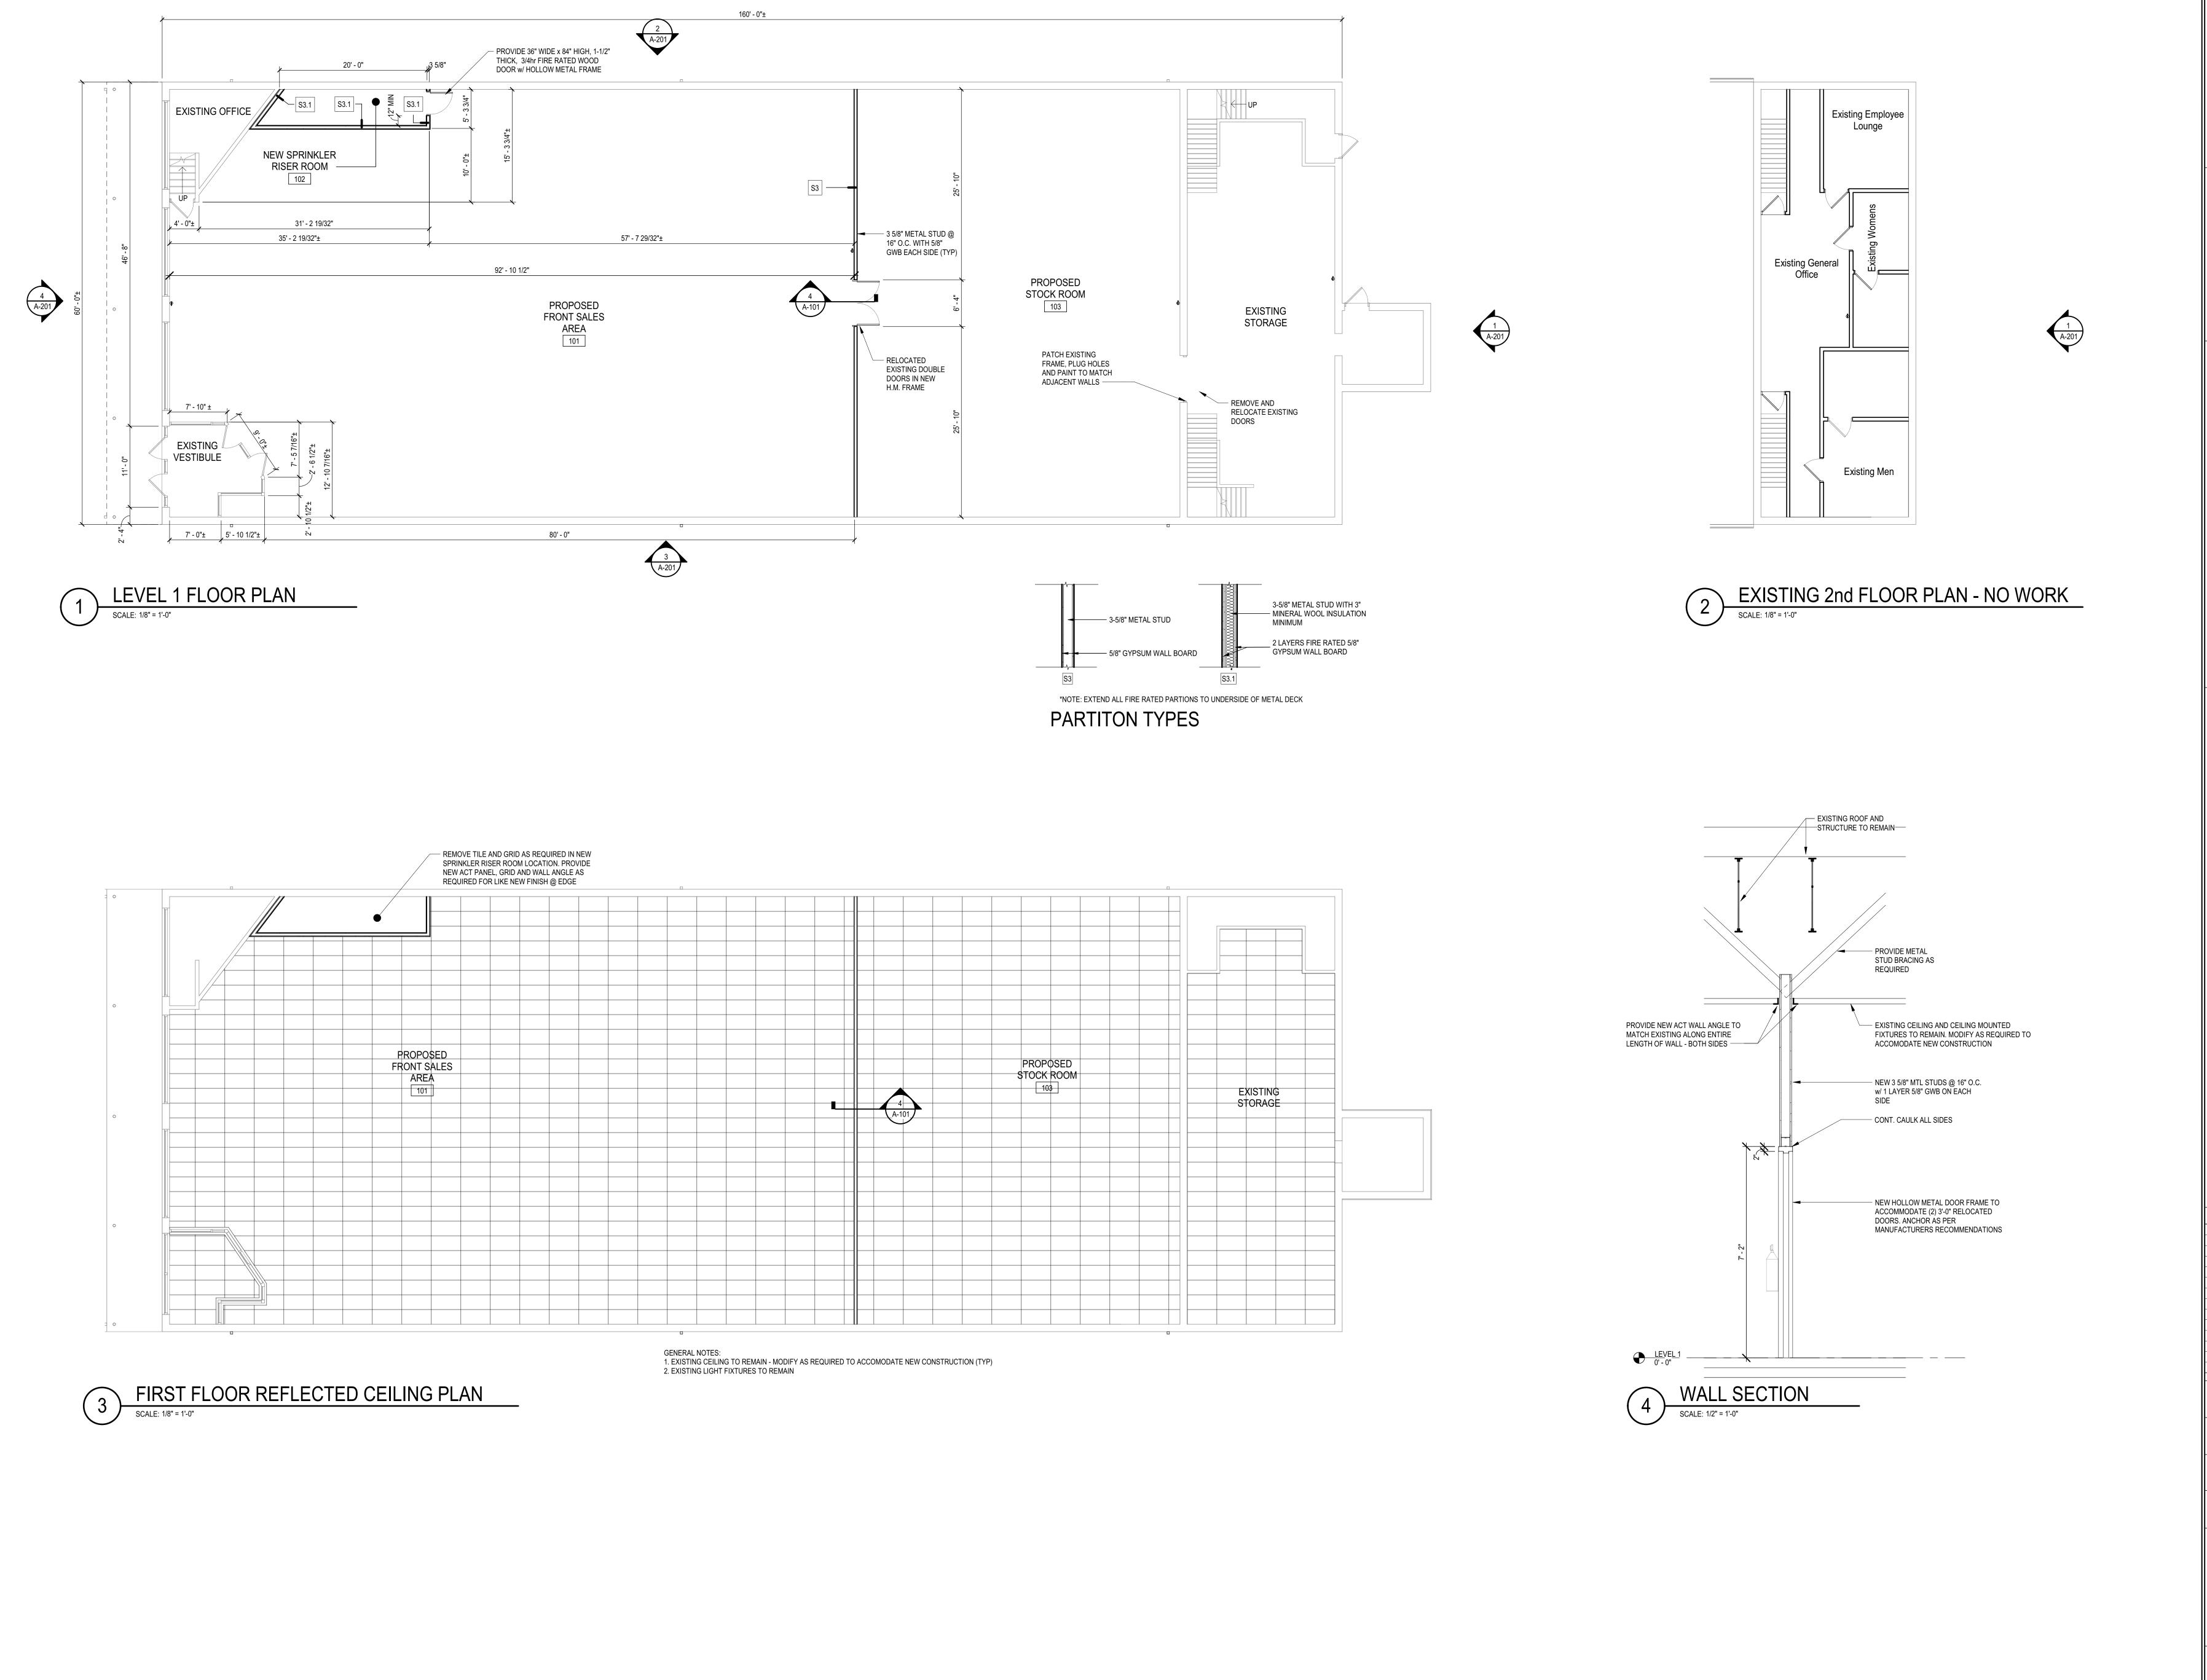SCALE: 1/8" = 1'-0"

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