Nacogdoches Office / Warehouse Facility

15709 NACOGDOCHES ROAD SAN ANTONIO, TX 78247

GENERAL NOTES

THE CONTRACT DOCUMENTS ARE COMPLIMENTARY, AND WHAT IS REQUIRED BY ONE REQUIRED BY ALL. CONTRACTOR SHALL USE ONLY COMPLETE SETS OF CONTRACT

CONTRACTOR AGREES THAT, IN ACCORDANCE WITH GENERALLY ACCEPTED CONSTRUCTION PRACTICES, CONTRACTOR CONSTRUCTION OF THE PROJECT, INCLUDING FURTHER AGREES TO DEFEND, INDEMNIFY, AND HOLD DESIGN PROFESSIONAL HARMLESS

ALL WORK SHALL COMPLY WITH ALL APPLICABLE CODE, ORDINANCE, A.D.A., T.A.S AND

ALL WORK SHALL BE DONE IN ACCORDANCE WITH THE APPLICABLE CODES, ORDINANCES AND STANDARD SPECIFICATIONS OF ALL AGENCIES THAT HAVE THE RESPONSIBILITY OF REVIEWING PLANS AND SPECIFICATIONS FOR CONSTRUCTION OF ALL

THE CONTRACTOR SHALL OBTAIN ALL THE NECESSARY PERMITS AS REQUIRED FOR

THERE SHALL BE NO CLAIM MADE BY THE CONTRACTOR AND ANY COSTS CAUSED BY DELAYS

IN WORKMANSHIP AND MATERIALS AND IN CONFORMANCE WITH THE APPROVED PLANS AND SPECIFICATIONS, AND THAT THE CONTRACTOR SHALL REPLACE OR REPAIR ANY WORK OR

CONTRACTOR SHALL VERIFY THAT THE PLANS AND SPECIFICATIONS THAT HE IS USING ARE THE VERY LATEST PLANS AND SPECIFICATIONS.

THE CONTRACTOR IS REQUIRED TO TAKE DUE PRECAUTIONARY MEASURES TO PROTECT THE UTILITIES OR STRUCTURE AT THE SITE. IT SHALL BE THE CONTRACTOR'S RESPONSIBILITY TO NOTIFY THE OWNER OF UTILITIES OR STRUCTURES CONCERNED BEFORE STARTING WORK. THE CONTRACTOR SHALL NOTIFY THE PROPER UTILITY IMMEDIATELY UPON BREAK OR DAMAGE TO ANY UTILITY LINE OR APPURTENANCE, OR THE INTERRUPTION OF THEIR SERVICE. HE SHALL NOTIFY THE PROPER UTILITY INVOLVED, IF EXISTING UTILITY CONSTRUCTION CONFLICTS WITH REQUIREMENTS, THE C ONTRACTOR SHALL NOTIFY THE ENGINEER SO THAT THE CONFLICT MAY BE RESOLVED.

INSTALL ALL MANUFACTURED ITEMS, MATERIALS, AND EQUIPMENT IN STRICT ACCORDANCE WITH MANUFACTURER'S WRITTEN INSTRUCTIONS EXCEPT THAT THE SPECIFICATIONS, WHERE MORE STRINGENT, SHALL GOVERN.

12. THE CONTRACTOR SHALL BE RESPONSIBLE FOR PROVIDING ALL TAPS, EXTENSIONS, WATER AND ELECTRICITY FOR ALL PROJECT FUNCTIONS, OFFICE, STORAGE, ETC.

13. THE CONTRACTOR SHALL BE RESPONSIBLE FOR PROVIDING HIS OWN TELEPHONE, FAX MACHINE, TOILET, VALVES, OR OTHER DEVICES NECESSARY TO RUN POWER TOOLS AND EQUIPMENT. SUCH MODIFICATIONS TO EXISTING UTILITIES SHALL BE REMOVED AT COMPLETION

15. THE GENERAL CONTRACTOR SHALL PROVIDE STREET NUMBERING ON THE BUILDING INCOMPLIANCE WITH LOCAL AUTHORITY.

16. ALL PENETRATIONS THRU WALLS SHALL BE SEALED AIR/WATER TIGHT AND CAULKED WITH TWO PART SEALANT EACH SIDE.

17. THE GENERAL CONTACTOR SHALL PROVIDE ONE COPY OF AS-BUILT DRAWINGS TO THE OWNER AT THE COMPLETION OF THE PROJECT. AS-BUILT DRAWINGS SHALL BE KEPT ON THE JOB AT ALL TIMES AND UPDATED THROUGHOUT THE CONSTRUCTION PHASE.

UNLESS NOTED OTHERWISE, SITE PLAN DIMENSIONS, ARE TO FACE OF CURB. FLOOR PLAN DIMENSIONS ARE TO FACE OF STUDS, FRAMING, MASONRY, CONCRETE WALL PANELS, OR

SPECIAL INSTRUCTIONS NOTE:


AT THE COMPLETION OF CONSTRUCTION, A FINAL REPORT OF REQUIRED SPECIAL INSPECTIONS PREPARED BY THE REGISTERED DESIGN PROFESSION IN RESPONSIBLE CHARGE THAT CONFIRMS THAT THE LISTED REQUIRED SPECIAL INSPECTIONS HAVE BEEN CONDUCTED AND COMPLETED WILL BE SUBMITTED TO THE BUILDING OFFICIAL, VIA THE OWNER. IT IS OUR UNDERSTANDING THAT A CERTIFICATE OF OCCUPANCY WILL NOT BE ISSUED BY THE CITY OF SAN ANTONIO UNTIL THIS FINAL REPORT IS RECEIVED. REFER TO DOCUMENT LABELED "DETERMINATION OF REQUIRED SPECIAL INSPECTIONS" AS WELL AS STRUCTURAL SHEET OR REQUIRED INSPECTIONS. IT IS THE CONTRACTOR'S RESPONSIBILITY TO PROVIDE DOCUMENTATION THAT ALL REQUIRED INSPECTIONS HAVE BEEN CONDUCTED AND ALL REPORTED NON-COMPLYINGITEMS HAVE BEEN RESOLVED.


GOVERNING CODE AND FIRE DEPARTMENT, FIELD INSPECTORS SHALL DICTATE SIZE, TYPE, QUANTITY AND LOCATIONS OF BOTH TEMPORARY AND PERMANENT PORTABLE FIRE

21. ALL EXPOSED ELECTRICAL EQUIPMENT, CONDUITS, PLUMBING LINES, ETC. SHALL BE PAINTED W/MIN (2) COATS OF PAINT TO MATCH ADJACENT SURFACES.

KNOX BOX-LOCATE PER LOCAL FIRE DEPARTMENT REQUIREMENTS.



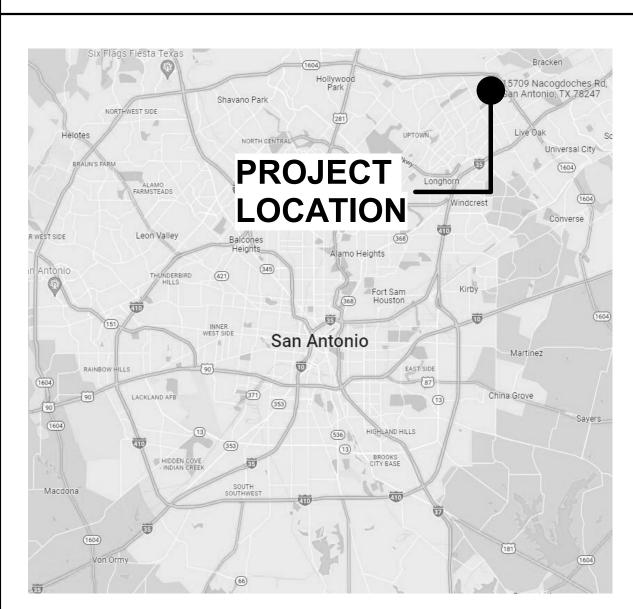

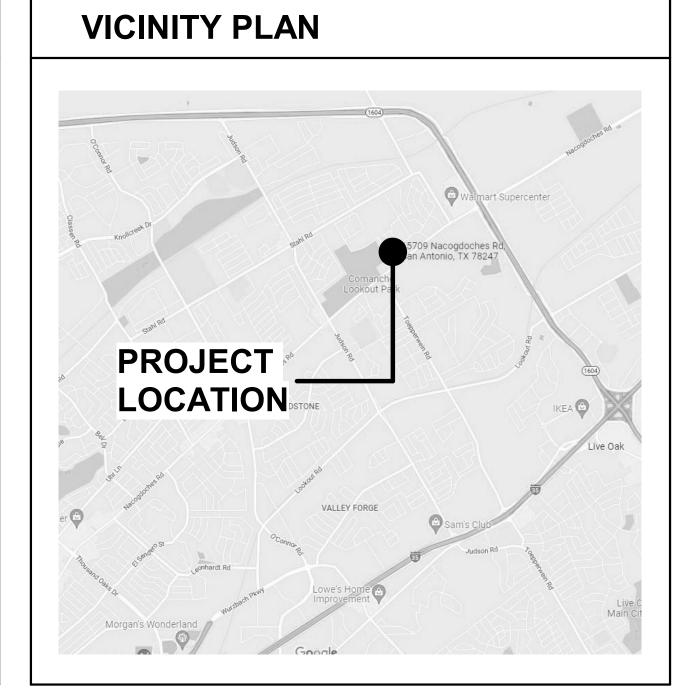

PROJECT INFORMATION

FIRE CODE

ENERGY CODE

FUEL GAS CODE

PLUMBING CODE

ELECTRICAL CODE

MECHANICAL CODE

SCOPE OF WORK: NEW OFFICE / WAREHOUSE FACILITY

OFFICE / WAREHOUSE	31,000 S.F.					
OCCUPANCY	OFFICE / WAREHOUSE					
FIRE ALARM SYSTEM	N/A					
FIRE SPRINKLER	N/A					
BUILDING CODE CRITERIA						
BUILDING CODE	2018 INTERNATIONAL BUILDING CODE					
LOCAL AMENDMENTS	2018 CHAPTER 10 BUILDING RELATED CODES & CHAPTER 11 IFC					

2018 INTERNATIONAL FIRE CODE

2018 INTERNATIONAL MECHANICAL CODE

2018 INTERNATIONAL FUEL GAS CODE

2018 INTERNATIONAL PLUMBING CODE

2017 INTERNATIONAL ELECTRICAL CODE

2018 INTERNATIONAL ENERGY & CONSERVATION CODE

INDEX OF DRAWINGS

CODE COMPLIANCE

EXTERIOR ELEVATIONS - RIGHT WING **EXTERIOR ELEVATIONS - LEFT WING**

OVERALL FLOOR PLAN

FIRST FLOOR PLAN RIGHT WING

FIRST FLOOR PLAN LEFT WING REFLECTED CEILING PLANS

SECTIONS & DETAILS

SECTIONS & DETAILS

WALL SECTIONS, SCHEDULES & DETAILS

DESIGN TEAM

ARCHITECT

Raul Acosta San Antonio, TX 78201 Contact: Fernando De Leon EMAIL: fdeleon@onestopcode.net

STRUCTURAL ENGINEER


Structural Engineer Name

M.E.P. ENGINEER

MEP Engineer Name

modifications to or use of thi drawing file that is inconsistent with the digital media may be altered

NO. DESCRIPTION DATE

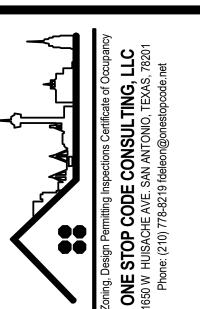

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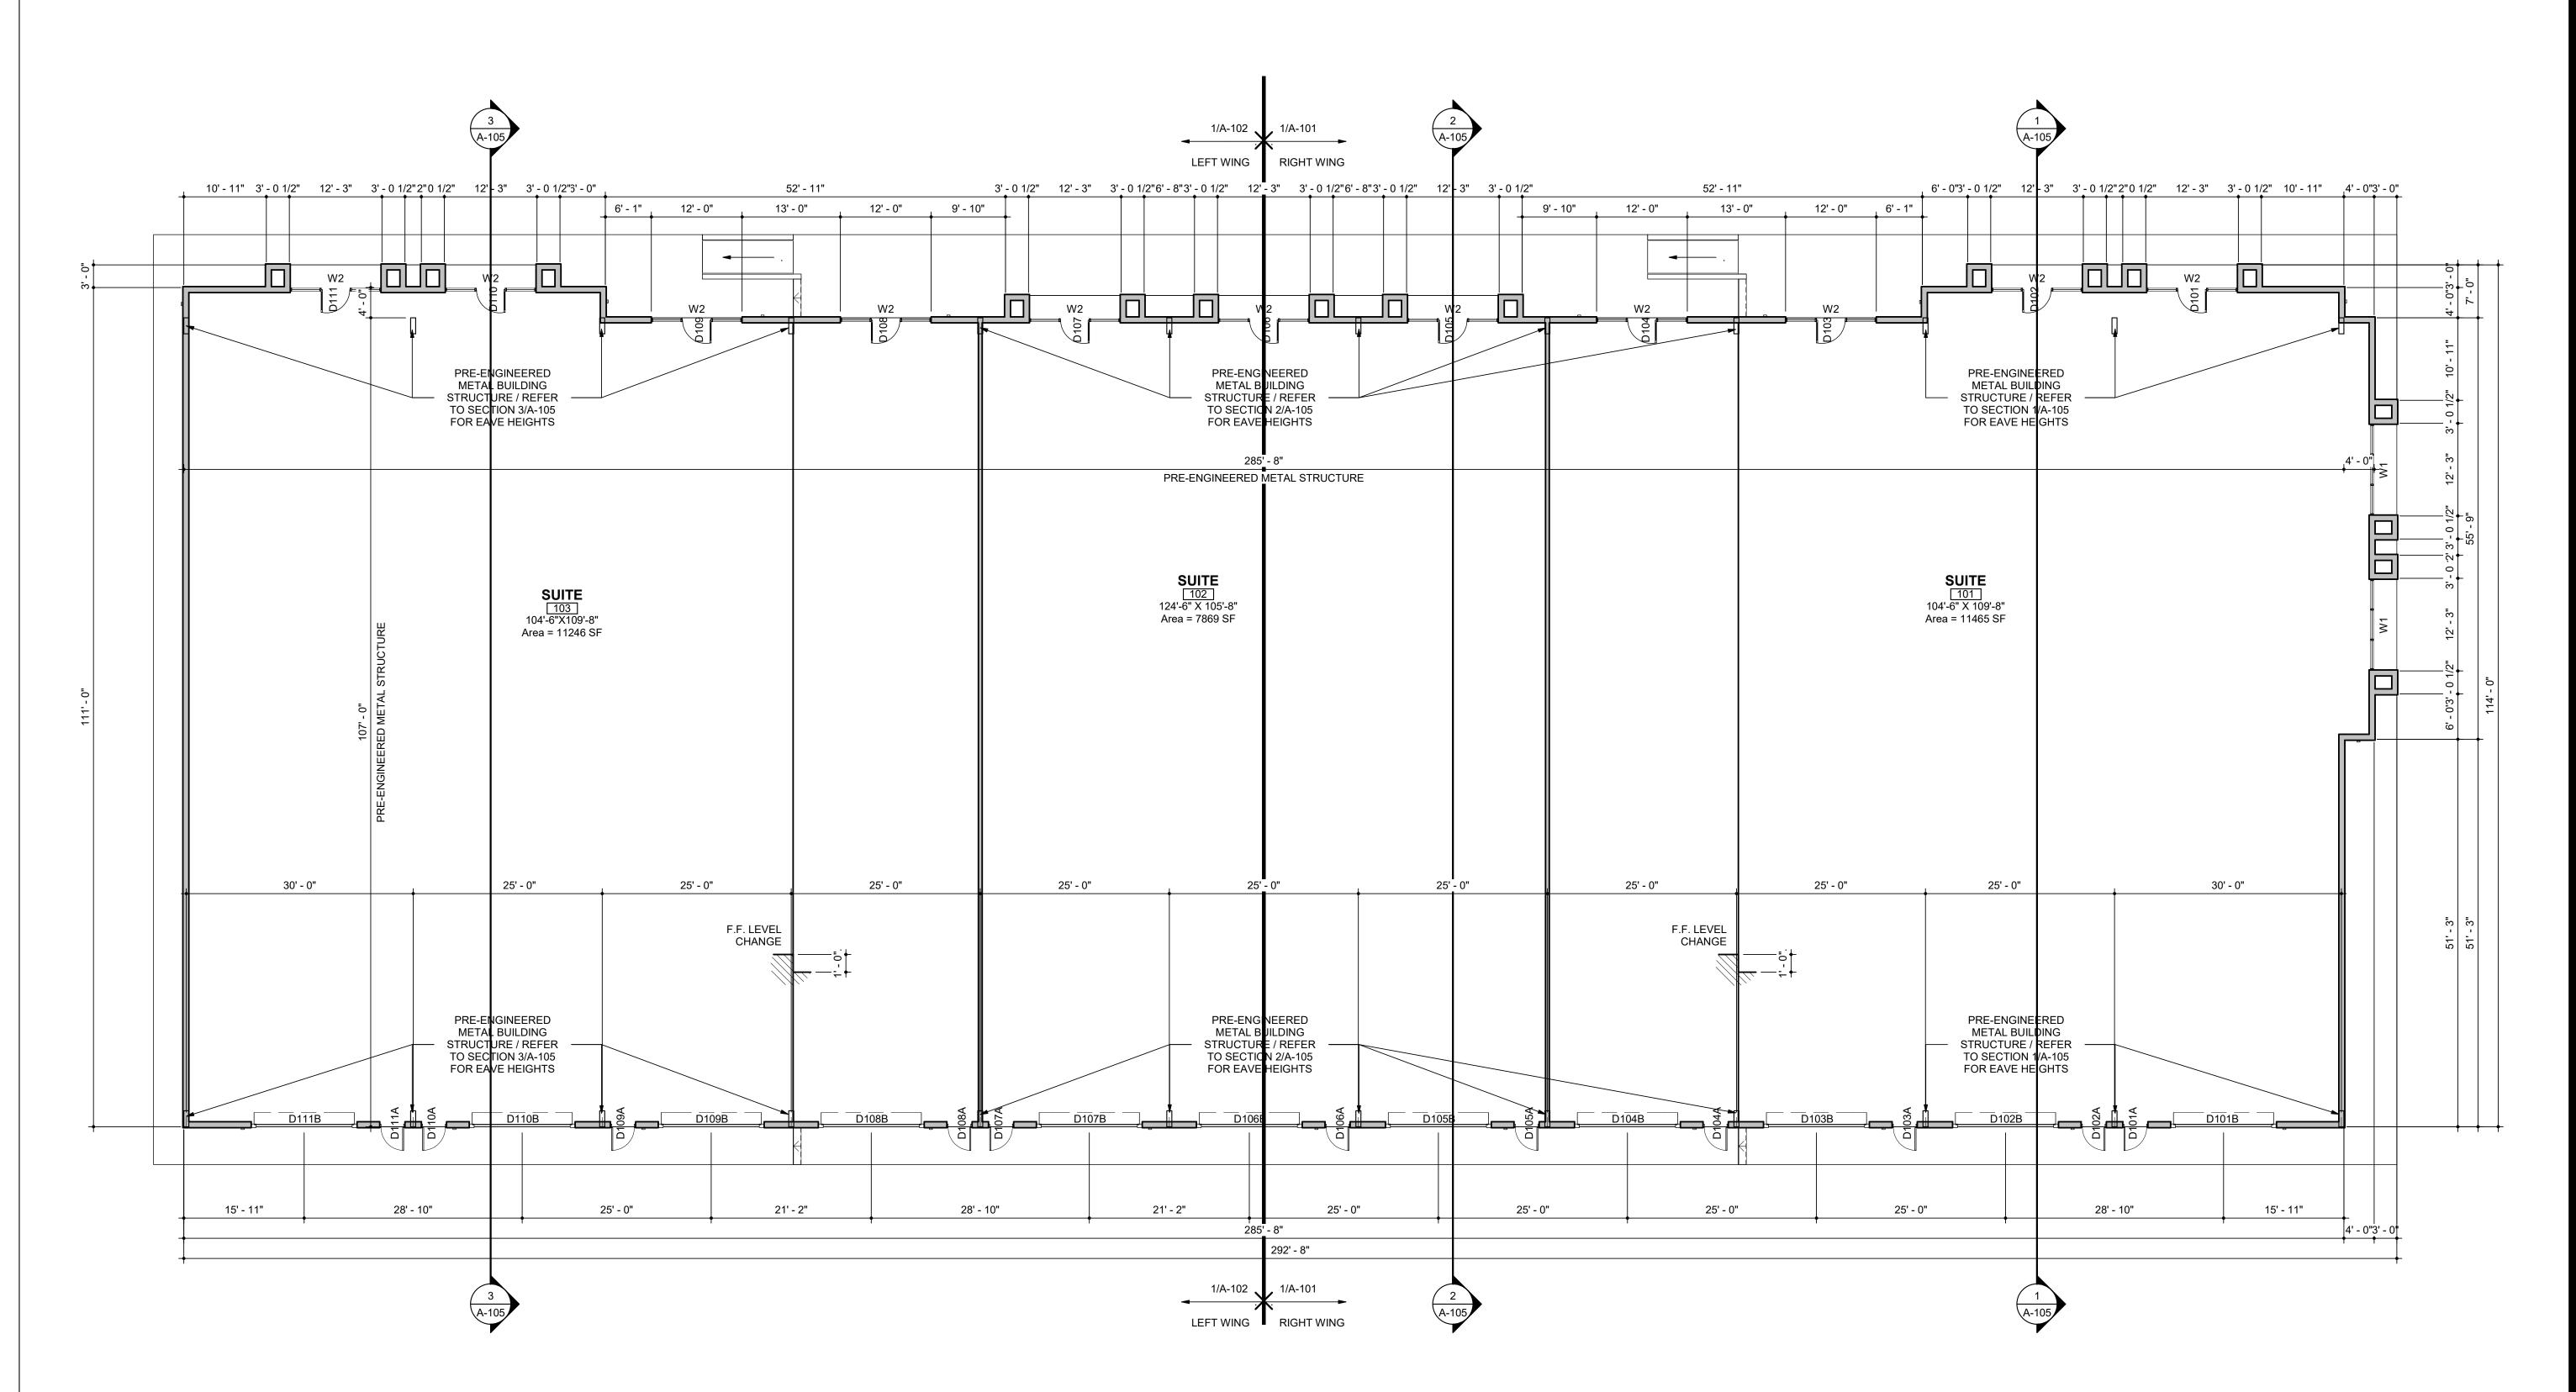
5

10/20/22

drawn by:

drawing title:

number:



1 OVERALL FLOOR PLAN
3/32" = 1'-0"



date 10/2

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NO. DESCRIPTION DATE

Zoning, Design Permitting Inspections Certificate of Occupancy

ONE STOP CODE CONSULTING, LLC

1650 W HUISACHE AVE. SAN ANTONIO, TEXAS, 78201

Phone: (210) 778-8219 fdeleon@onestopcode.net

15709 Nacogdoches

15709 NACOGDOCHES. SAN ANTONIO, TEXAS 78247

date: 10/2


10/20/ drawn by:

drawing title:

OVERALL FLOOR PLAN

drawn number:


A-100

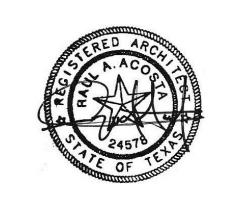

date 10/2

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NO. DESCRIPTION DATE

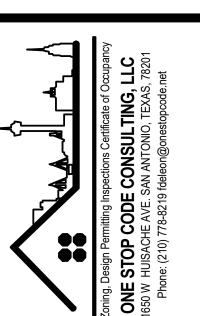

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late: 10/20/2

drawn by:

drawing title:
FIRST FLOOR PLAN RIGHT
WING

drawn number:

A-101


FINISH FLOOR PLAN
1/8" = 1'-0"



date 10/2

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NO. DESCRIPTION DATE

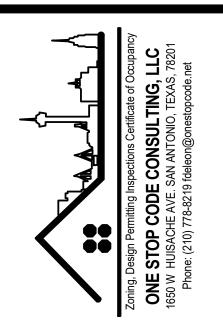

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date:

drawn by:

Author
drawing title:

drawn number:

A-102

FIRST FLOOR PLAN LEFT

A 2X4 LIGHT FIXTURE, RE: ELEC.

A 2X2 LIGHT FIXTURE, RE: ELEC.

B CIRCULAR FLUORESCENT PENDANT LIGHT

C 5" COMP. FLUORESCENT DOWNLIGHT RECESS

D LINEAR STRIP LIGHT SYSTEM, RE: ELEC.

X1 EXIT LIGHT

AIR SUPPLY GRILLE, RE: MECH

AIR RETURN GRILLE, RE: MECH


EF EXHAUST FAN

SD) SMOKE DETECTOR

SUSPENSION SYSTEM DETAILS


NOTE: SHADED SYMBOL INDICATES REQUIREMENTS FOR THIS PROJECT.

LOW SEISMIC ZONE

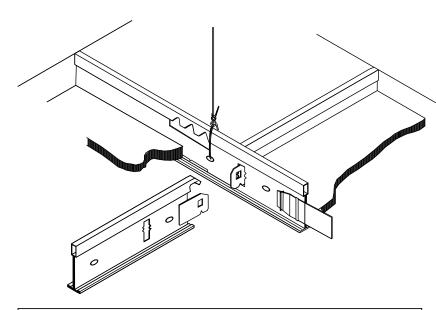

NOTE: THESE TWO DETAILS ARE EXAMPLES OF CEILING SUSPENSION SYSTMES BASED ON LOW AND HIGH SEISMIC DESIGN.

NOTE: BRACING WIRES ARE INCLUDED ON GRID SPACING OF 12 FT x 12 FT. WIRES ARE NOT SHOWN HERE FOR CLARITY. POST IS MADE UP OF 3/4" STEEL TUBING WITH .049" WALL THICKNESS. MAXIMUM UNSUPPORTED LENGTH IS 5'-2". IF MORE THAN 5'-2" IS REQUIRED, NOTIFY ARCHITECT. POST TO HAVE SPRING AND CONNECTION FITTINGS AT TOP AND BOTTOM. (APPROXIMATE ALLOWANCE VERTICAL MOVEMENT IS 1/2" UNDER SEISMIC ACTION.) INSTALL ACCORDING TO MANUFACTURER'S DIRECTIONS. POST ASSEMBLIES ARE AVAILABLE FROM DOWN CORPORATION OR EQUAL.

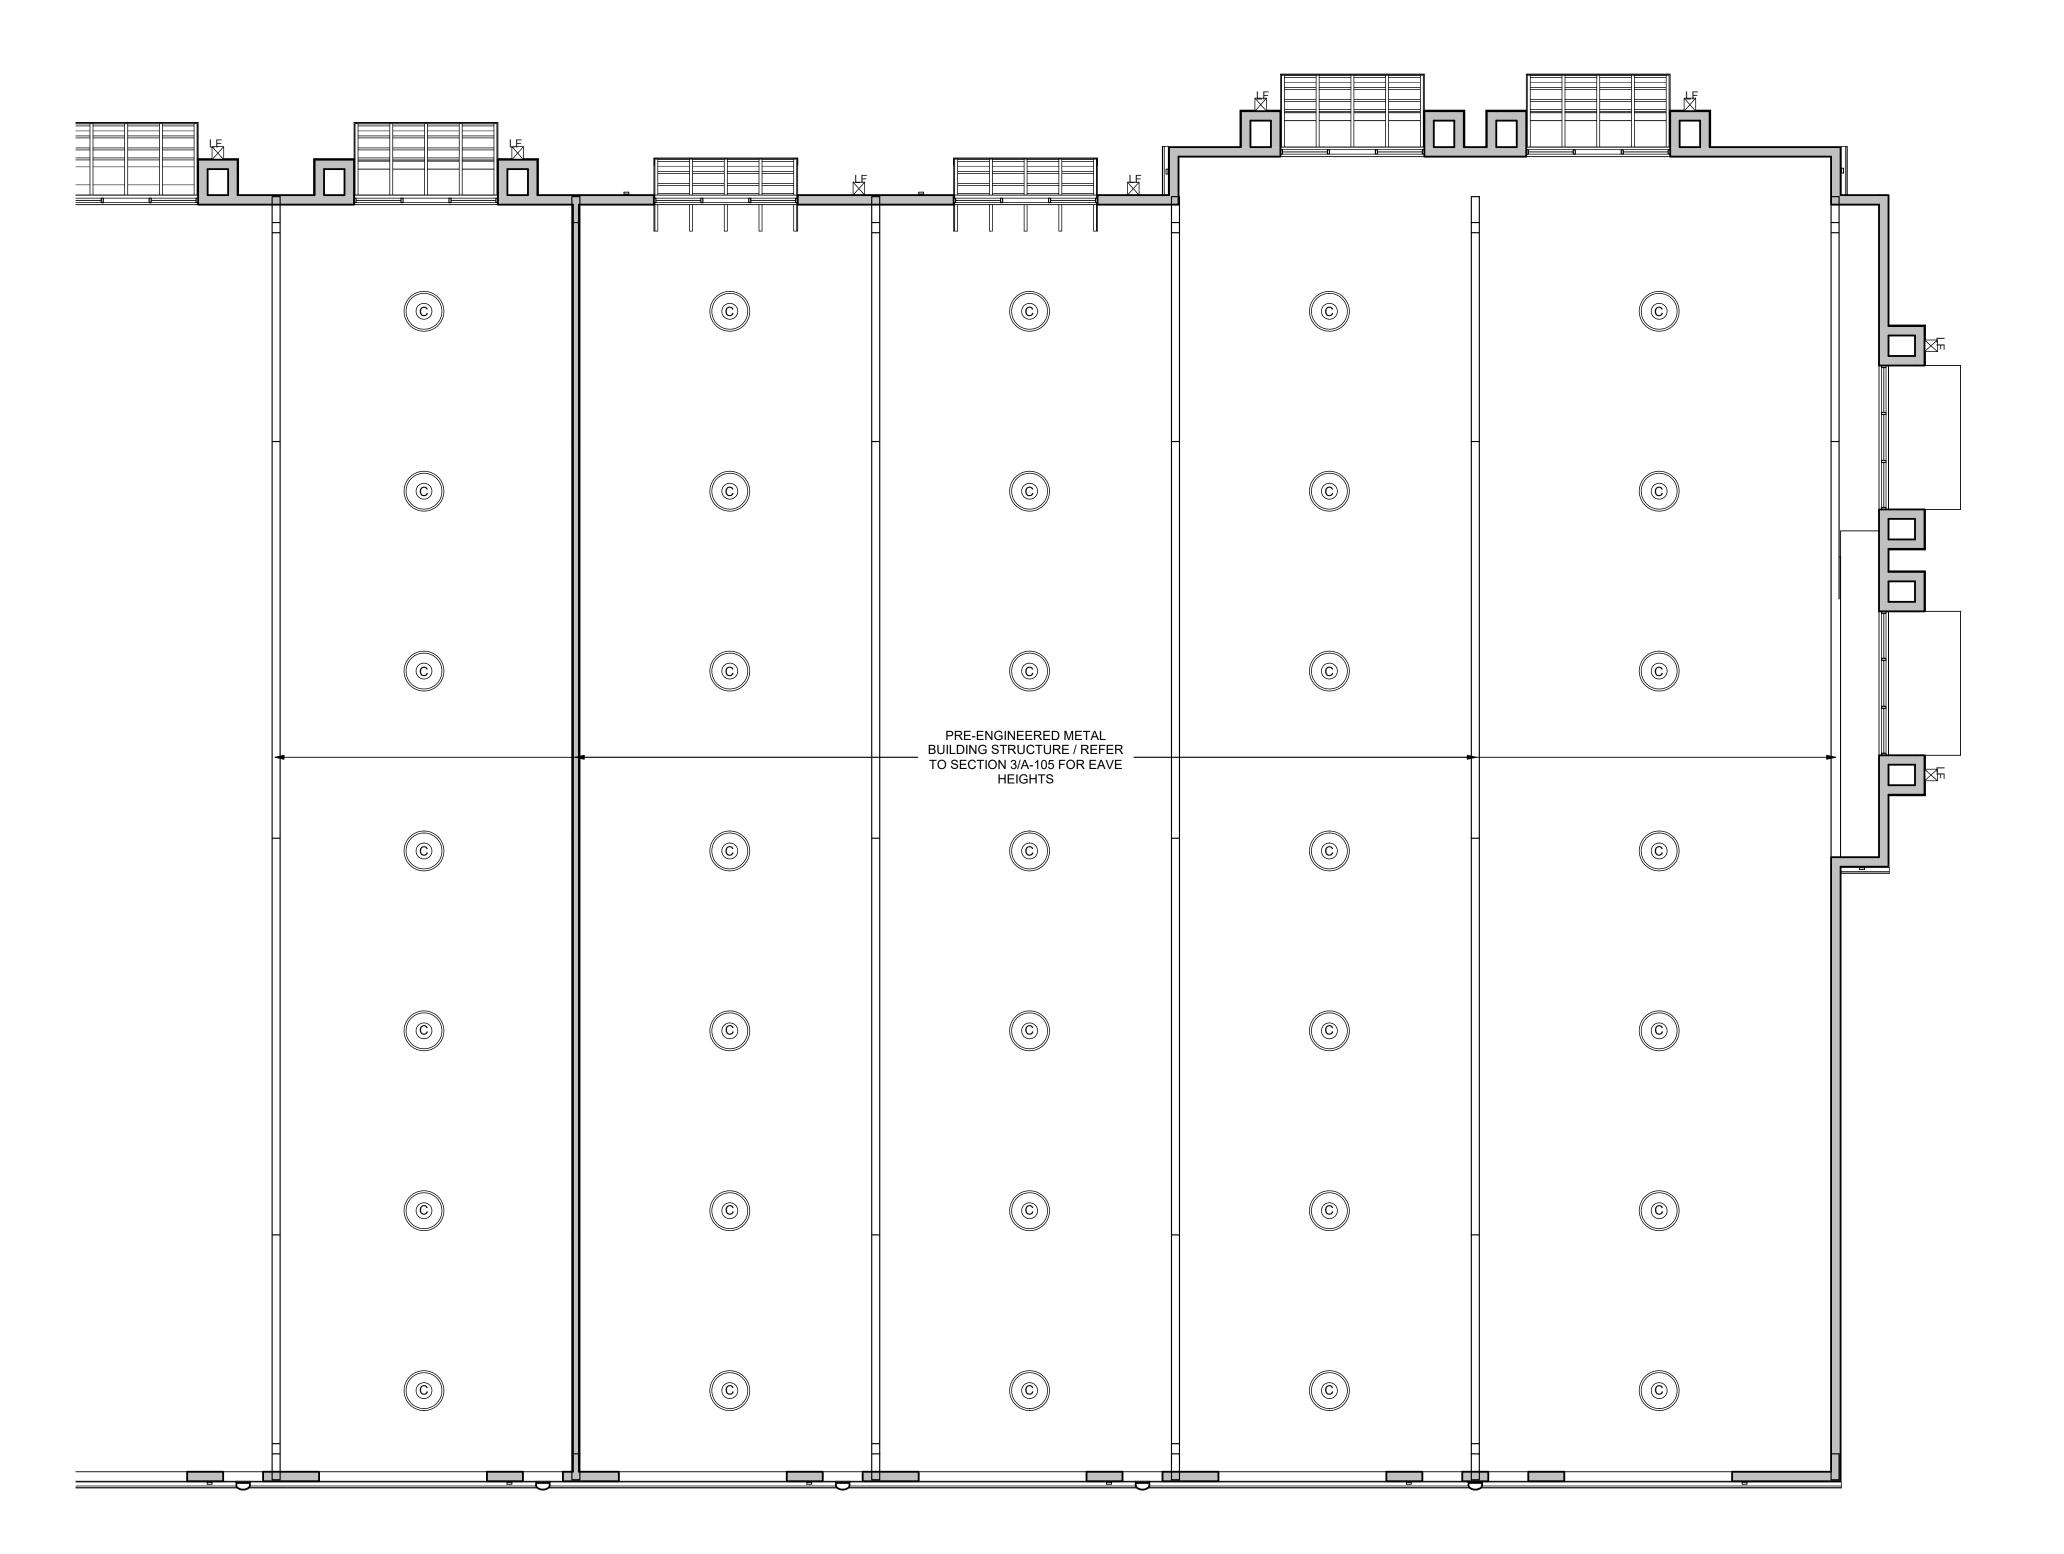

1 FIRST FLOOR RCP RIGHT WING
1/8" = 1'-0"



date 10/2

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NO. DESCRIPTION DATE

Zoning, Design Permitting Inspections Certificate of Occupancy

ONE STOP CODE CONSULTING, LLC

1650 W HUISACHE AVE. SAN ANTONIO, TEXAS, 78201

Phone: (210) 778-8219 fdeleon@onestopcode.net

5709 Nacogdoches

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15709 NACOGDOCHES. SAN ANTONIO, TEXAS 782

ıte: 10/20

10/20/22

drawn by:

drawing title:
REFLECTED CEILING
PLANS

drawn number:


A-103

<u>LEGEND</u>

	SUSPENDED GYPSUM BOARD CEILING
	SUSPENDED ACOUSTICAL CEILING - VINYL FACES
	EXPOSED TO STRUCTURE / PAINT
	64 1/4" X 76 1/4" SKYLIGHT
	A 2X4 LIGHT FIXTURE , RE: ELEC.
	A 2X2 LIGHT FIXTURE , RE: ELEC.
(B CIRCULAR FLUORESCENT PENDANT LIGHT
0	C 5" COMP. FLUORESCENT DOWNLIGHT RECESS
	D LINEAR STRIP LIGHT SYSTEM, RE: ELEC.
	X1 EXIT LIGHT
	AIR SUPPLY GRILLE, RE: MECH
	AIR RETURN GRILLE, RE: MECH
EF	EXHAUST FAN
SD	SMOKE DETECTOR


SUSPENSION SYSTEM DETAILS

NOTE: SHADED SYMBOL INDICATES REQUIREMENTS FOR THIS PROJECT. **LOW SEISMIC ZONE**

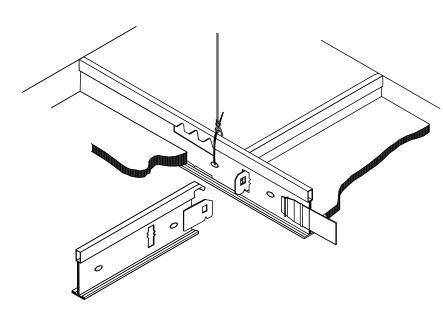

NOTE: THESE TWO DETAILS ARE EXAMPLES OF CEILING SUSPENSION SYSTMES BASED ON LOW AND HIGH SEISMIC DESIGN.

NOTE: BRACING WIRES ARE INCLUDED ON GRID SPACING OF 12 FT x 12 FT. WIRES ARE NOT SHOWN HERE FOR CLARITY. POST IS MADE UP OF 3/4" STEEL TUBING WITH .049" WALL THICKNESS. MAXIMUM UNSUPPORTED LENGTH IS 5'-2". IF MORE THAN 5'-2" IS REQUIRED, NOTIFY ARCHITECT. POST TO HAVE SPRING AND CONNECTION FITTINGS AT TOP AND BOTTOM. (APPROXIMATE ALLOWANCE VERTICAL MOVEMENT IS 1/2" UNDER SEISMIC ACTION.) INSTALL ACCORDING TO MANUFACTURER'S DIRECTIONS. POST ASSEMBLIES ARE AVAILABLE FROM DOWN CORPORATION OR EQUAL.

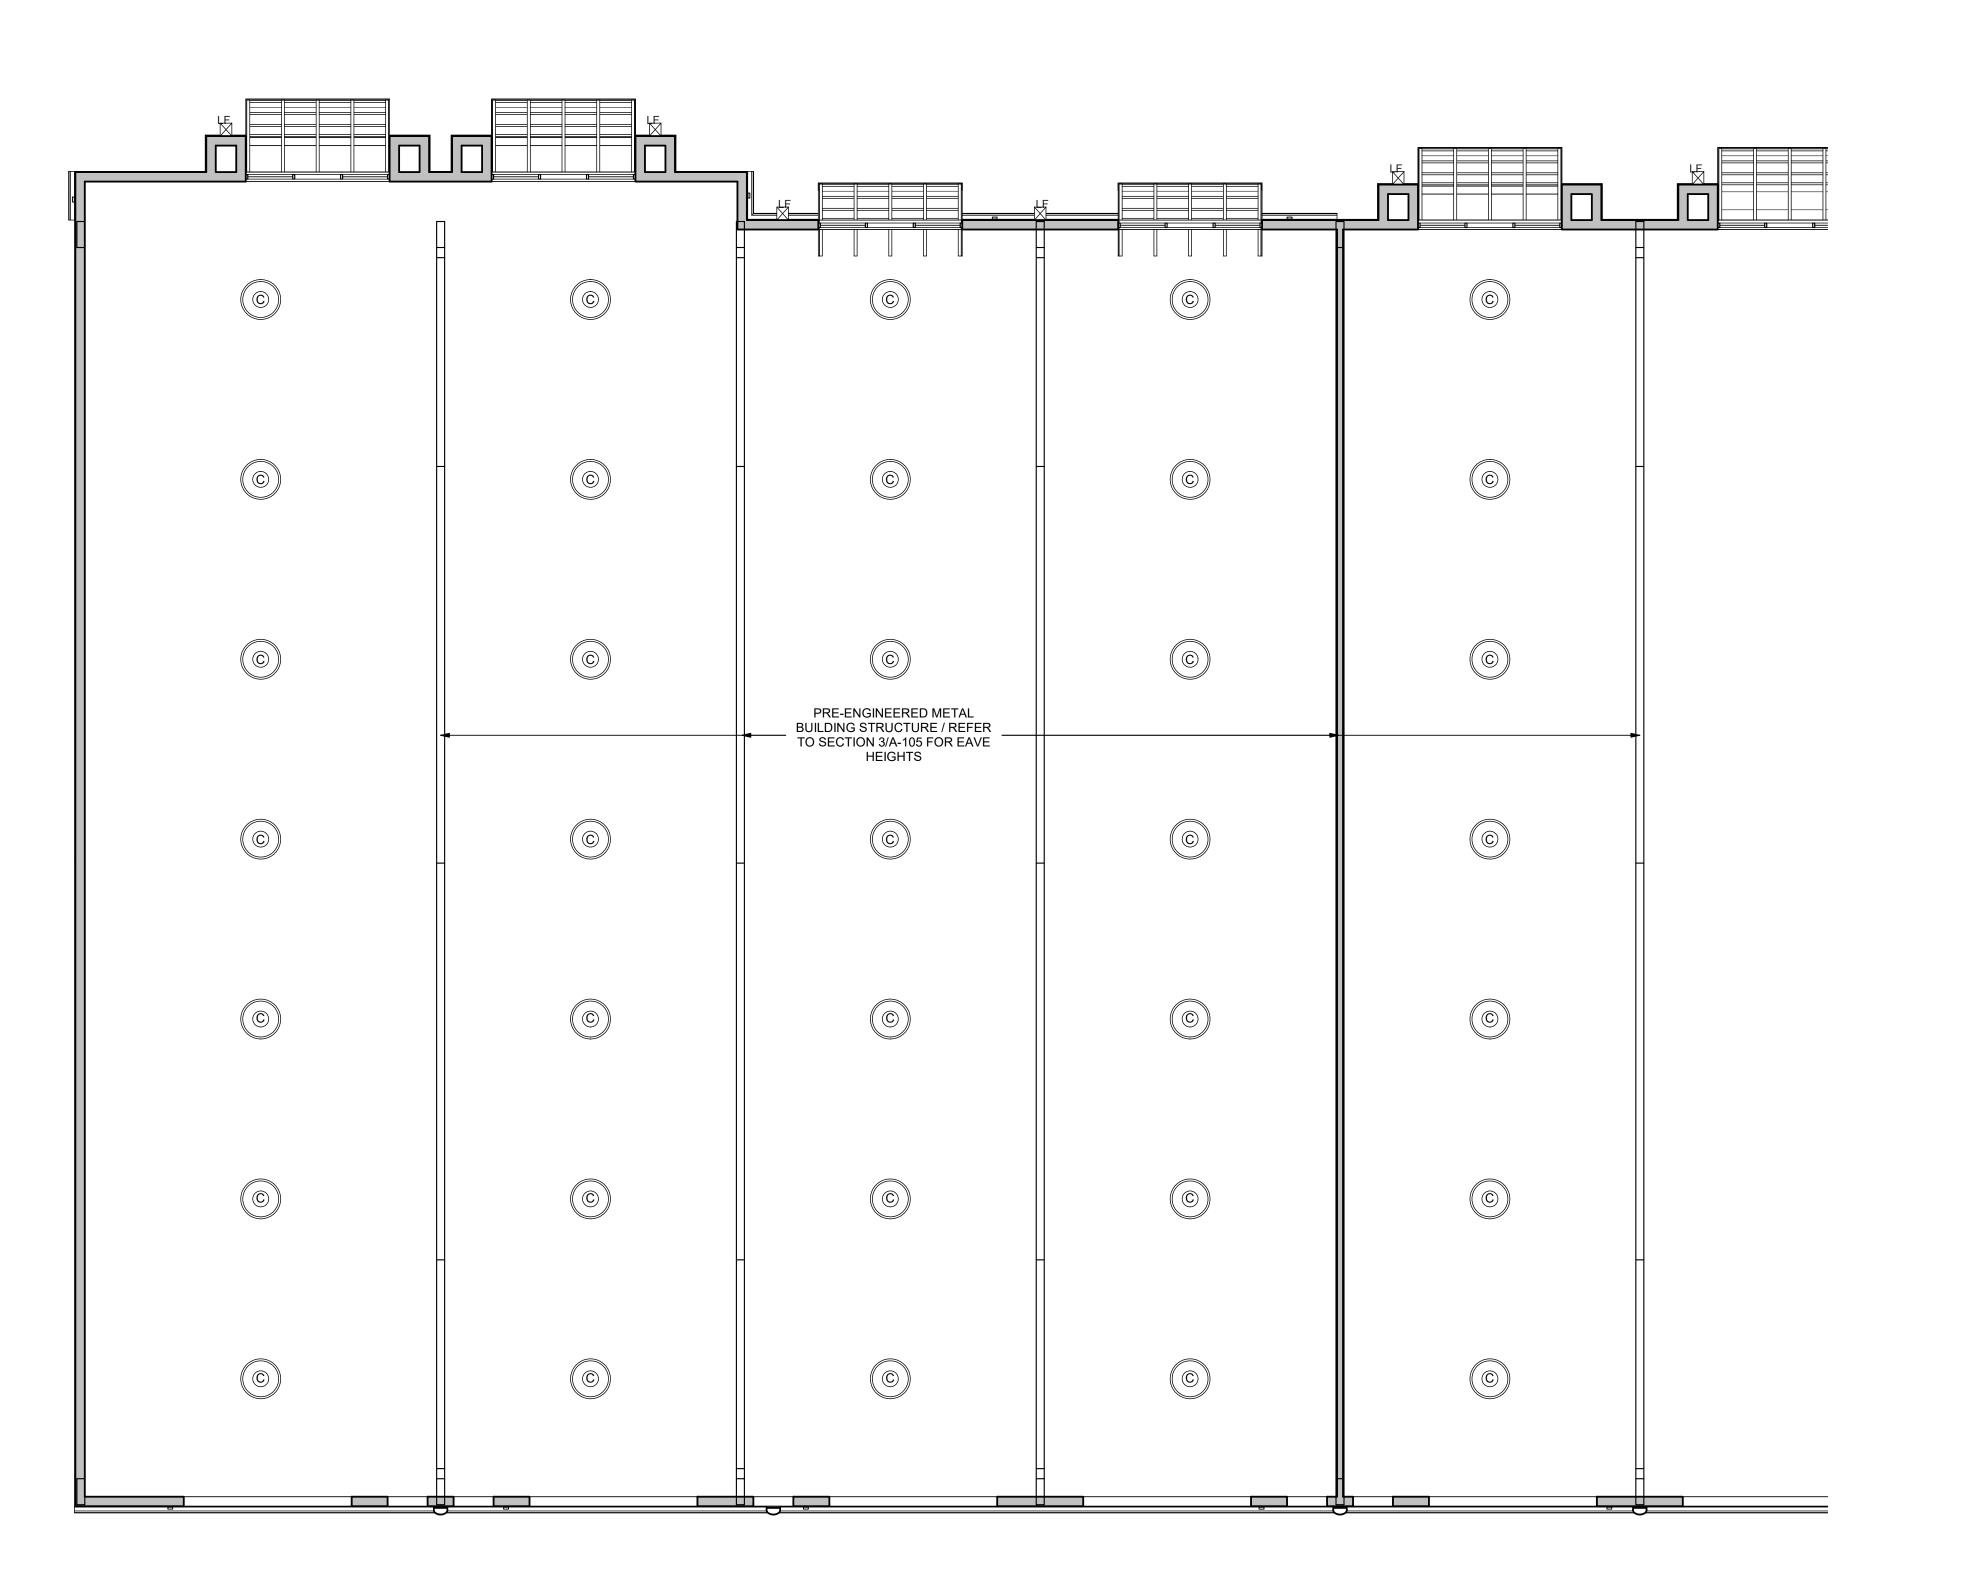

1 FIRST FLOOR RCP LEFT WING



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The user of this file agrees to

NO. DESCRIPTION DATE

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15709 NACOGDOCHES. SAN ANTONIO, TEXAS 782

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10/20/22

drawn by: Author

drawing title: REFLECTED CEILING **PLANS**

drawn number:



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of the named professional.

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15709 NACOGDOCHES. SAN ANTONIO, TEXAS 78247

drawn by:


drawing title:

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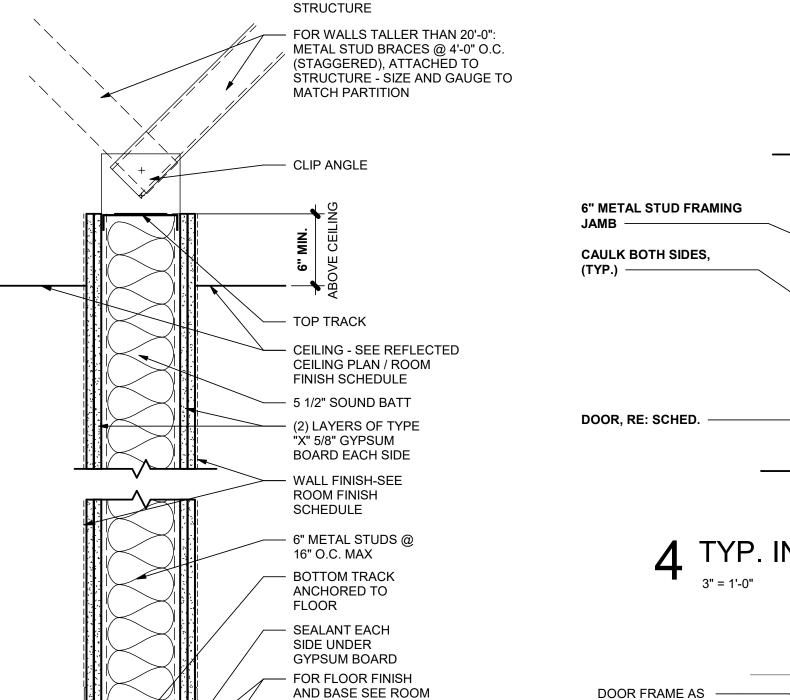
BUILDING SECTIONS

number:




GYP. BD PARTITION

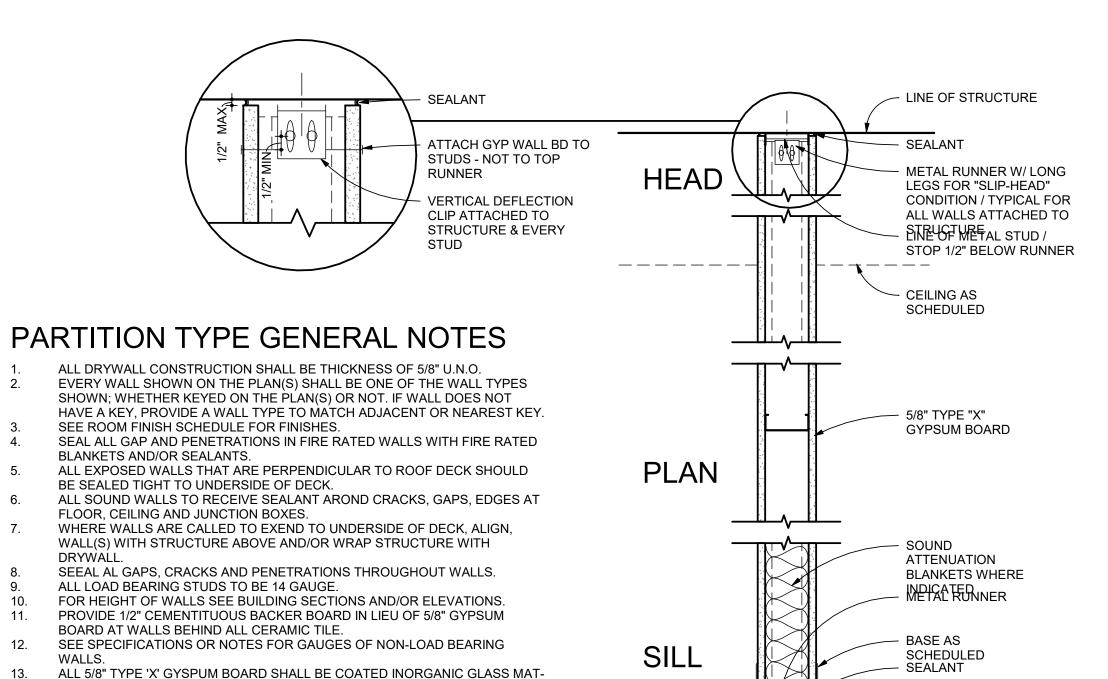NTS TYP NOTES U.N.O.



FINISH SCHEDULE

UNDERSIDE OF ROOF

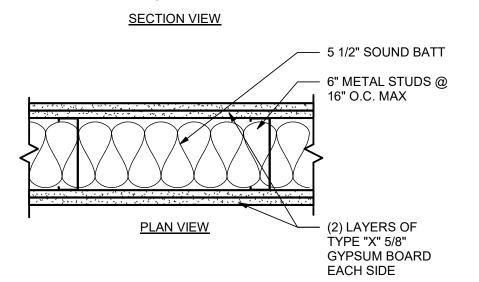


TYPE A1: 1 HR. FIRE RATED WALL UL U419 (5/8" TYPE "X" GYPSUM BOARD EACH SIDE)


DRYWALL.

FACED WATER RESISTANT TREATED GYPSUM CORE WALLBOARD.

PARTITION TYPE SCALE: 1 1/2" = 1'-0"

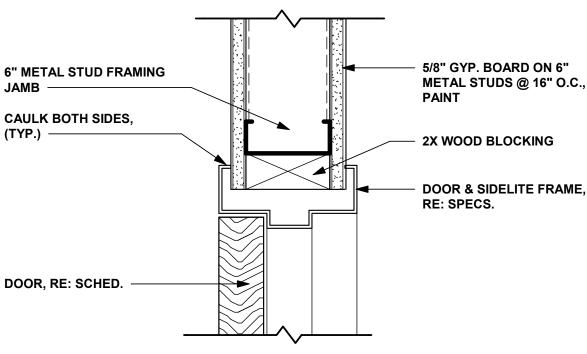

4 TYP. INT. DR. FRAME HEAD

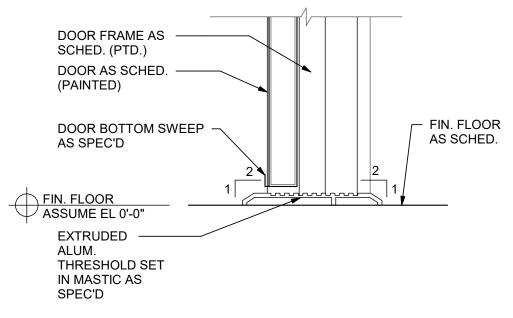

5 DOOR THRESHOLD

WINDOW TYPES


W2


12' - 0"


W1

3' - 9" 2" 3' - 10" 2" 3' - 9"

						DOO	R SCHEI	DULE		
		DOOR					ME			
DOOR NO.	W	Н	Т	DOOR	FINISH	FRAME	FINISH	ELEV. TYPE	HARDWARE	REMARKS
D101	3' - 10"	8' - 0"	1 3/4"	ALUMINUM / GLASS	PAINT	ALUMINUM	PAINT	Α	KEYED LOCKSET / PUSH / PULL BAR / SURFACE CLOSER / DOOR BOTTOM / THRESHOLD / MOTION SENSOR	STOREFRONT SYSTEM
D101A	3' - 0"	8' - 0"	1 3/4"	HOLLOW METAL	PAINT	НМ	PAINT	В	KEYED LOCKSET / PUSH / PULL BAR / SURFACE CLOSER / THRESHOLD / HEADER RAIN DRIP	PANIC HARDWARE
D101B	14' - 0"	12' - 0"	0"	HOLLOW METAL	PAINT	HM	PAINT	С	KEYED LOCKSET / PULL BAR / WEATHER STRIP	O.H. COILING DOOR
D102	3' - 10"	8' - 0"	1 3/4"	ALUMINUM / GLASS	PAINT	ALUMINUM	PAINT	Α	KEYED LOCKSET / PUSH / PULL BAR / SURFACE CLOSER / DOOR BOTTOM / THRESHOLD / MOTION SENSOR	STOREFRONT SYSTEM
D102A	3' - 0"	8' - 0"	1 3/4"	HOLLOW METAL	PAINT	HM	PAINT	В	KEYED LOCKSET / PUSH / PULL BAR / SURFACE CLOSER / THRESHOLD / HEADER RAIN DRIP	PANIC HARDWARE
D102B	14' - 0"	12' - 0"	0"	HOLLOW METAL	PAINT	HM	PAINT	С	KEYED LOCKSET / PULL BAR / WEATHER STRIP	O.H. COILING DOOR
D103	3' - 10"	8' - 0"	1 3/4"	ALUMINUM / GLASS	PAINT	ALUMINUM	PAINT	Α	KEYED LOCKSET / PUSH / PULL BAR / SURFACE CLOSER / DOOR BOTTOM / THRESHOLD / MOTION SENSOR	STOREFRONT SYSTEM
D103A	3' - 0"	8' - 0"	1 3/4"	HOLLOW METAL	PAINT	НМ	PAINT	В	KEYED LOCKSET / PUSH / PULL BAR / SURFACE CLOSER / THRESHOLD / HEADER RAIN DRIP	PANIC HARDWARE
D103B	14' - 0"	12' - 0"	0"	HOLLOW METAL	PAINT	НМ	PAINT	С	KEYED LOCKSET / PULL BAR / WEATHER STRIP	O.H. COILING DOOR
D104	3' - 10"	8' - 0"	1 3/4"	ALUMINUM / GLASS	PAINT	ALUMINUM	PAINT	А	KEYED LOCKSET / PUSH / PULL BAR / SURFACE CLOSER / DOOR BOTTOM / THRESHOLD / MOTION SENSOR	STOREFRONT SYSTEM
D104A	3' - 0"	8' - 0"	1 3/4"	HOLLOW METAL	PAINT	НМ	PAINT	В	KEYED LOCKSET / PUSH / PULL BAR / SURFACE CLOSER / THRESHOLD / HEADER RAIN DRIP	PANIC HARDWARE
D104B	14' - 0"	12' - 0"	0"	HOLLOW METAL	PAINT	HM	PAINT	С	KEYED LOCKSET / PULL BAR / WEATHER STRIP	O.H. COILING DOOR
D105	3' - 10"	8' - 0"	1 3/4"	ALUMINUM / GLASS	PAINT	ALUMINUM	PAINT	Α	KEYED LOCKSET / PUSH / PULL BAR / SURFACE CLOSER / DOOR BOTTOM / THRESHOLD / MOTION SENSOR	STOREFRONT SYSTEM
D105A	3' - 0"	8' - 0"	1 3/4"	HOLLOW METAL	PAINT	НМ	PAINT	В	KEYED LOCKSET / PUSH / PULL BAR / SURFACE CLOSER / THRESHOLD / HEADER RAIN DRIP	PANIC HARDWARE
D105B	14' - 0"	12' - 0"	0"	HOLLOW METAL	PAINT	НМ	PAINT	С	KEYED LOCKSET / PULL BAR / WEATHER STRIP	O.H. COILING DOOR
D106	3' - 10"	8' - 0"	1 3/4"	ALUMINUM / GLASS	PAINT	ALUMINUM	PAINT	Α	KEYED LOCKSET / PUSH / PULL BAR / SURFACE CLOSER / DOOR BOTTOM / THRESHOLD / MOTION SENSOR	STOREFRONT SYSTEM
D106A	3' - 0"	8' - 0"	1 3/4"	HOLLOW METAL	PAINT	НМ	PAINT	В	KEYED LOCKSET / PUSH / PULL BAR / SURFACE CLOSER / THRESHOLD / HEADER RAIN DRIP	PANIC HARDWARE
D106B	14' - 0"	12' - 0"	0"	HOLLOW METAL	PAINT	НМ	PAINT	С	KEYED LOCKSET / PULL BAR / WEATHER STRIP	O.H. COILING DOOR
D107	3' - 10"	8' - 0"	1 3/4"	ALUMINUM / GLASS	PAINT	ALUMINUM	PAINT	Α	KEYED LOCKSET / PUSH / PULL BAR / SURFACE CLOSER / DOOR BOTTOM / THRESHOLD / MOTION SENSOR	STOREFRONT SYSTEM
D107A	3' - 0"	8' - 0"	1 3/4"	HOLLOW METAL	PAINT	НМ	PAINT	В	KEYED LOCKSET / PUSH / PULL BAR / SURFACE CLOSER / THRESHOLD / HEADER RAIN DRIP	PANIC HARDWARE
D107B	14' - 0"	12' - 0"	0"	HOLLOW METAL	PAINT	НМ	PAINT	С	KEYED LOCKSET / PULL BAR / WEATHER STRIP	O.H. COILING DOOR
D108	3' - 10"	8' - 0"	1 3/4"	ALUMINUM / GLASS	PAINT	ALUMINUM	PAINT	Α	KEYED LOCKSET / PUSH / PULL BAR / SURFACE CLOSER / DOOR BOTTOM / THRESHOLD / MOTION SENSOR	STOREFRONT SYSTEM
D108A	3' - 0"	8' - 0"	1 3/4"	HOLLOW METAL	PAINT	НМ	PAINT	В	KEYED LOCKSET / PUSH / PULL BAR / SURFACE CLOSER / THRESHOLD / HEADER RAIN DRIP	PANIC HARDWARE
D108B	14' - 0"	12' - 0"	0"	HOLLOW METAL	PAINT	НМ	PAINT	С	KEYED LOCKSET / PULL BAR / WEATHER STRIP	O.H. COILING DOOR
D109	3' - 10"	8' - 0"	1 3/4"	ALUMINUM / GLASS	PAINT	ALUMINUM	PAINT	Α	KEYED LOCKSET / PUSH / PULL BAR / SURFACE CLOSER / DOOR BOTTOM / THRESHOLD / MOTION SENSOR	STOREFRONT SYSTEM
D109A	3' - 0"	8' - 0"	1 3/4"	HOLLOW METAL	PAINT	НМ	PAINT	В	KEYED LOCKSET / PUSH / PULL BAR / SURFACE CLOSER / THRESHOLD / HEADER RAIN DRIP	PANIC HARDWARE
D109B	14' - 0"	12' - 0"	0"	HOLLOW METAL	PAINT	НМ	PAINT	С	KEYED LOCKSET / PULL BAR / WEATHER STRIP	O.H. COILING DOOR
D110	3' - 10"	8' - 0"	1 3/4"	ALUMINUM / GLASS	PAINT	ALUMINUM	PAINT	Α	KEYED LOCKSET / PUSH / PULL BAR / SURFACE CLOSER / DOOR BOTTOM / THRESHOLD / MOTION SENSOR	STOREFRONT SYSTEM
D110A	3' - 0"	8' - 0"	1 3/4"	HOLLOW METAL	PAINT	НМ	PAINT	В	KEYED LOCKSET / PUSH / PULL BAR / SURFACE CLOSER / THRESHOLD / HEADER RAIN DRIP	PANIC HARDWARE
D110B	14' - 0"	12' - 0"	0"	HOLLOW METAL	PAINT	НМ	PAINT	С	KEYED LOCKSET / PULL BAR / WEATHER STRIP	O.H. COILING DOOR
D111	3' - 10"	8' - 0"	1 3/4"	ALUMINUM / GLASS	PAINT	ALUMINUM	PAINT	Α	KEYED LOCKSET / PUSH / PULL BAR / SURFACE CLOSER / DOOR BOTTOM / THRESHOLD / MOTION SENSOR	STOREFRONT SYSTEM
D111A	3' - 0"	8' - 0"	1 3/4"	HOLLOW METAL	PAINT	НМ	PAINT	В	KEYED LOCKSET / PUSH / PULL BAR / SURFACE CLOSER / THRESHOLD / HEADER RAIN DRIP	PANIC HARDWARE
D111B	14' - 0"	12' - 0"	0"	HOLLOW METAL	PAINT	НМ	PAINT	С	KEYED LOCKSET / PULL BAR / WEATHER STRIP	O.H. COILING DOOR

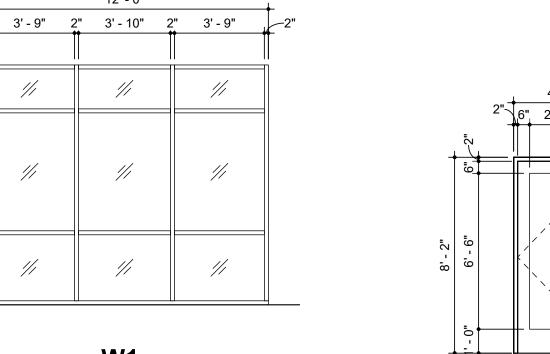

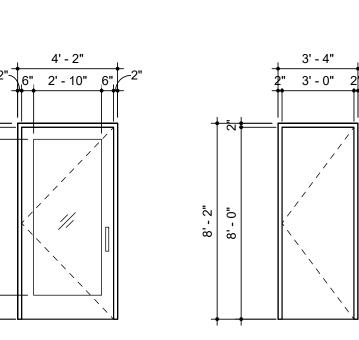

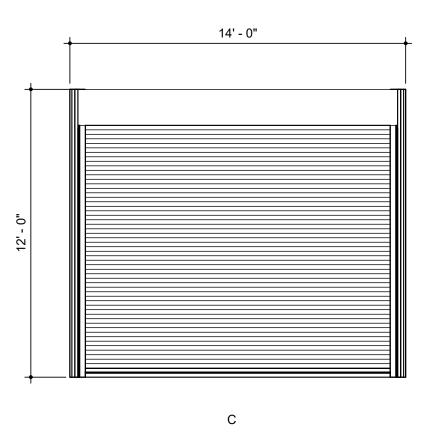

STOREFRONT DOOR AND WINDOW GENERAL NOTES:

- 1. SET WINDOW SUBSILLS IN CONTINUOUS BEAD OF SEALANT.
- 2. TURN SUBSILLS AND FLASHING MEMBRANE UP AT JAMBS (6" MINIMUM) TO FORM END DAMS. 3. SPACE ANCHORS OF DOOR AND WINDOW FRAMES NO MORE THAN 16" O.C.
- 4. INSTALL ONE WINDOW FOR ARCHITECT'S REVIEW AND APPROVAL PRIOR TO PROCEEDING. 5. VERIFY HEAD HEIGHTS OF OPENINGS ON THE EXTERIOR AND INTERIOR ELEVATIONS.
- INFORM THE ARCHITECT OF DISCREPANCIES PRIOR TO PROCEEDING.

SAFETY GLAZING - TEMPERED GLASS SHALL BE PROVIDED AS PER SECTION 2406

- OF THE IBC
- 1. ALL GLAZING IN DOORS 2. ALL GLAZING ADJACENT TO DOORS
- 3. ALL GLAZING IN WINDOWS MEETING ALL OF THE FOLLOWING CONDITIONS:
- a. EXPOSED AREA OF WINDOW PANE IS GREATER THAN 9 SF b. THE BOTTOM EDGE OF GLAZING IS LESS THAN 18" ABOVE THE FLOOR
- c. THE TOP EDGE OF THE GLAZING IS GREATER THAN 36" ABOVE THE FLOOR AND
- d. ONE OR MORE WALKING SURFACES ARE WITHIN 36" MEASURED HORIZONTALLY AND IN A STRAIGHT LINE OF THE PLANE OF THE GLAZING

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drawing title: WALL SECTIONS, SCHEDULES & DETAILS

number:



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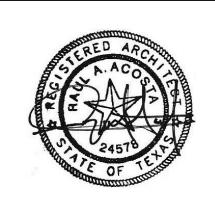
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EXTERIOR ELEVATIONS
RIGHT WING

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ate: 10/20/22

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Author
drawing title:
EXTERIOR ELEVATIONS -

drawn number:

A-119

LEFT WING