

PROJECT LOCATION MAP

**Balcrank** 

GENERAL NOTES:

1. DO NOT USE AS A BLUEPRINTS WITHOUT MR LLC PERMISSION.

2. PLEASE NOTE INTERIOR DIMENSIONS WERE NOT USED IN CALCULATING SQUARE FOOTAGE

3. SIZE OF HEATED AND NOT HEATED AREA AND OTHER INFORMATION WERE OBTAINED PER THE NC REAL ESTATE COMMISSION GUIDELINES (6" FOR EXTERNAL WALLS EXEPT CONDOMINIUMS)

4. FOR REMODELING QUESTIONS OR MORE DETAILED CAD DRAWINGS (INC.SITE PLAN, SECTIONS, ELEVATIONS) ALSO 3D MODEL PLEASE CONTACT ALFRED ZALYS MOB. 828 231 7305 E-MAIL: A.ZALYS@HOTMAIL.COM

LEGEND MAP:

CONCRETE

HEATED FNISHED NOT HEATED/NOT FINISHED WOOD/CER.TILES


Measure Rite LLC 25 Clement Place. Asheville Buncombe County 28805

1 Balcrank Way, Weaverville, NC 28787

**Generic Perspective** 


Contact Name
Alfred ZALYS
mob. 828 231 7305

Layout ID
AS BUILT-3

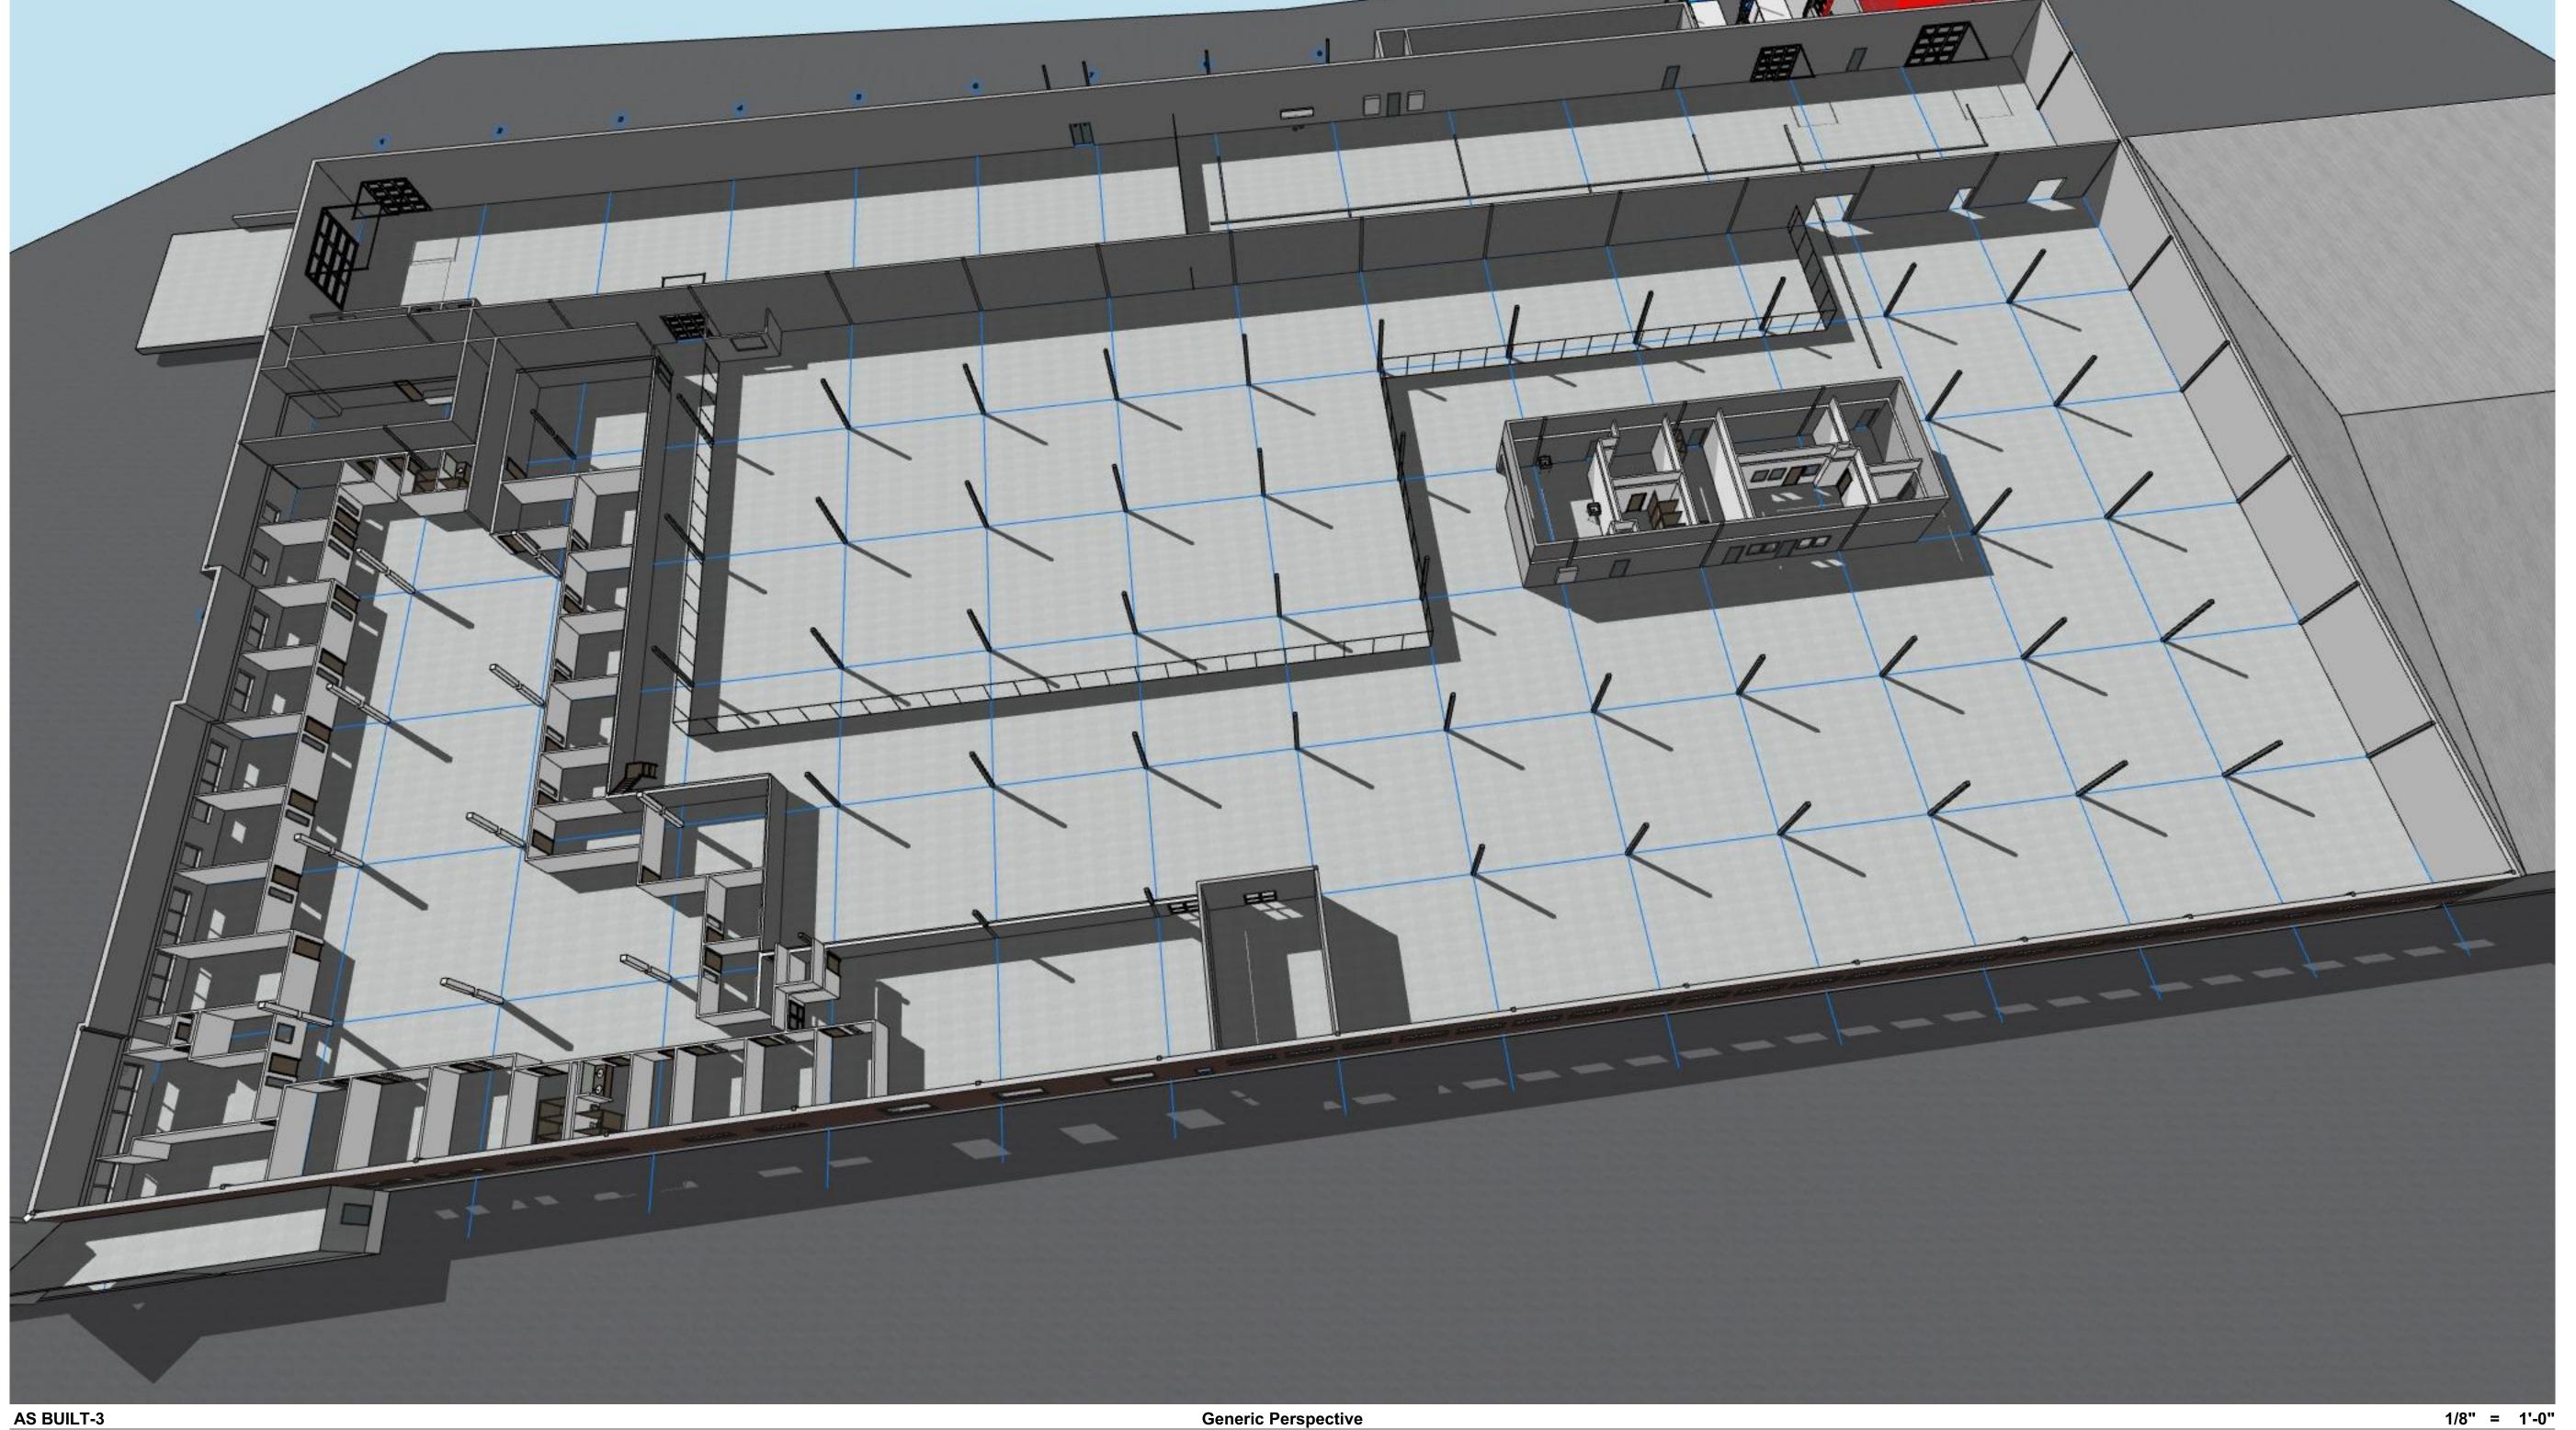




PROJECT LOCATION MAP

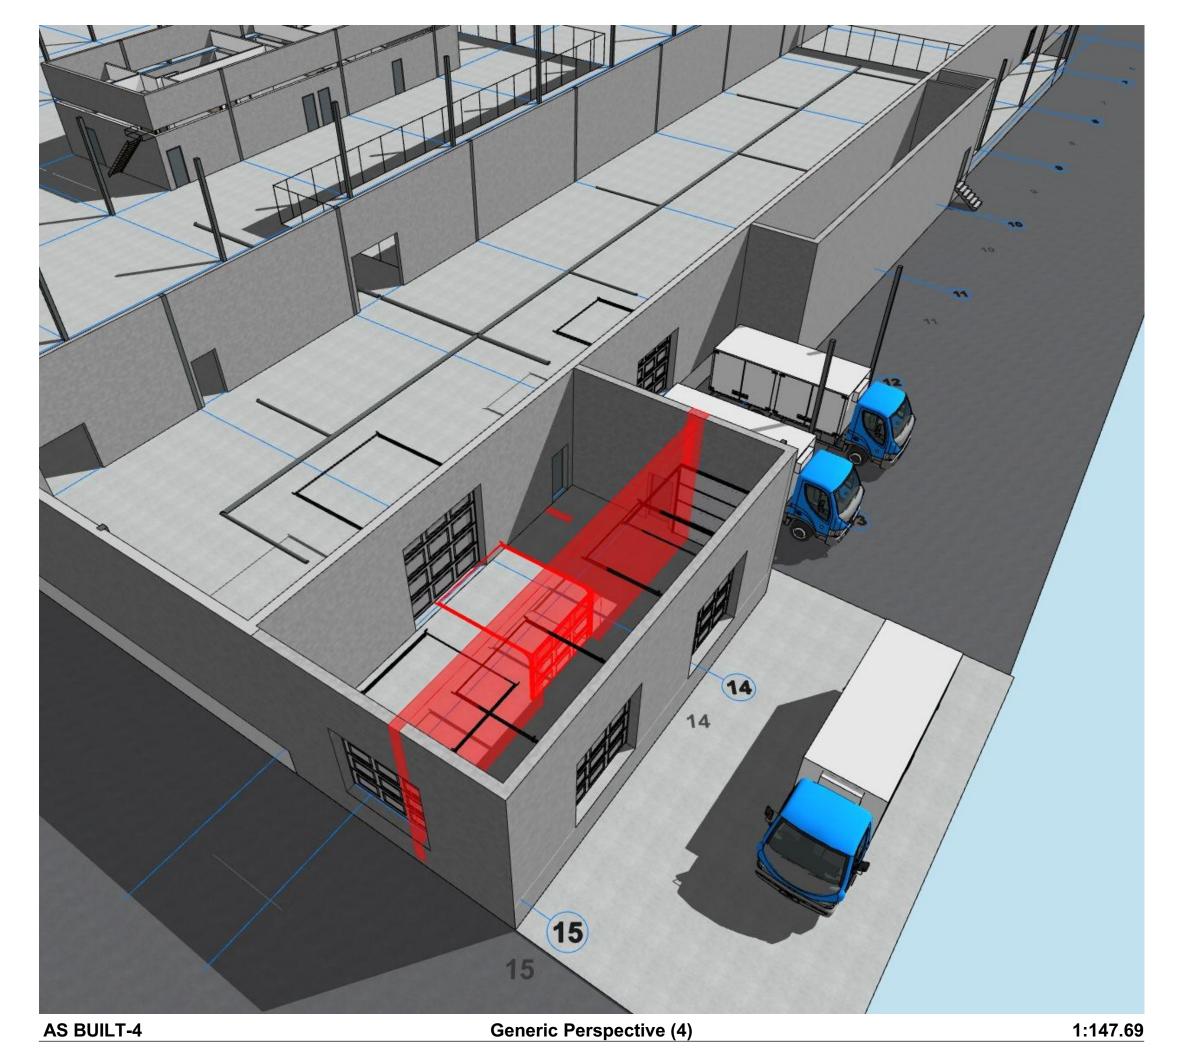

Generic Perspective (3)

AS BUILT-4

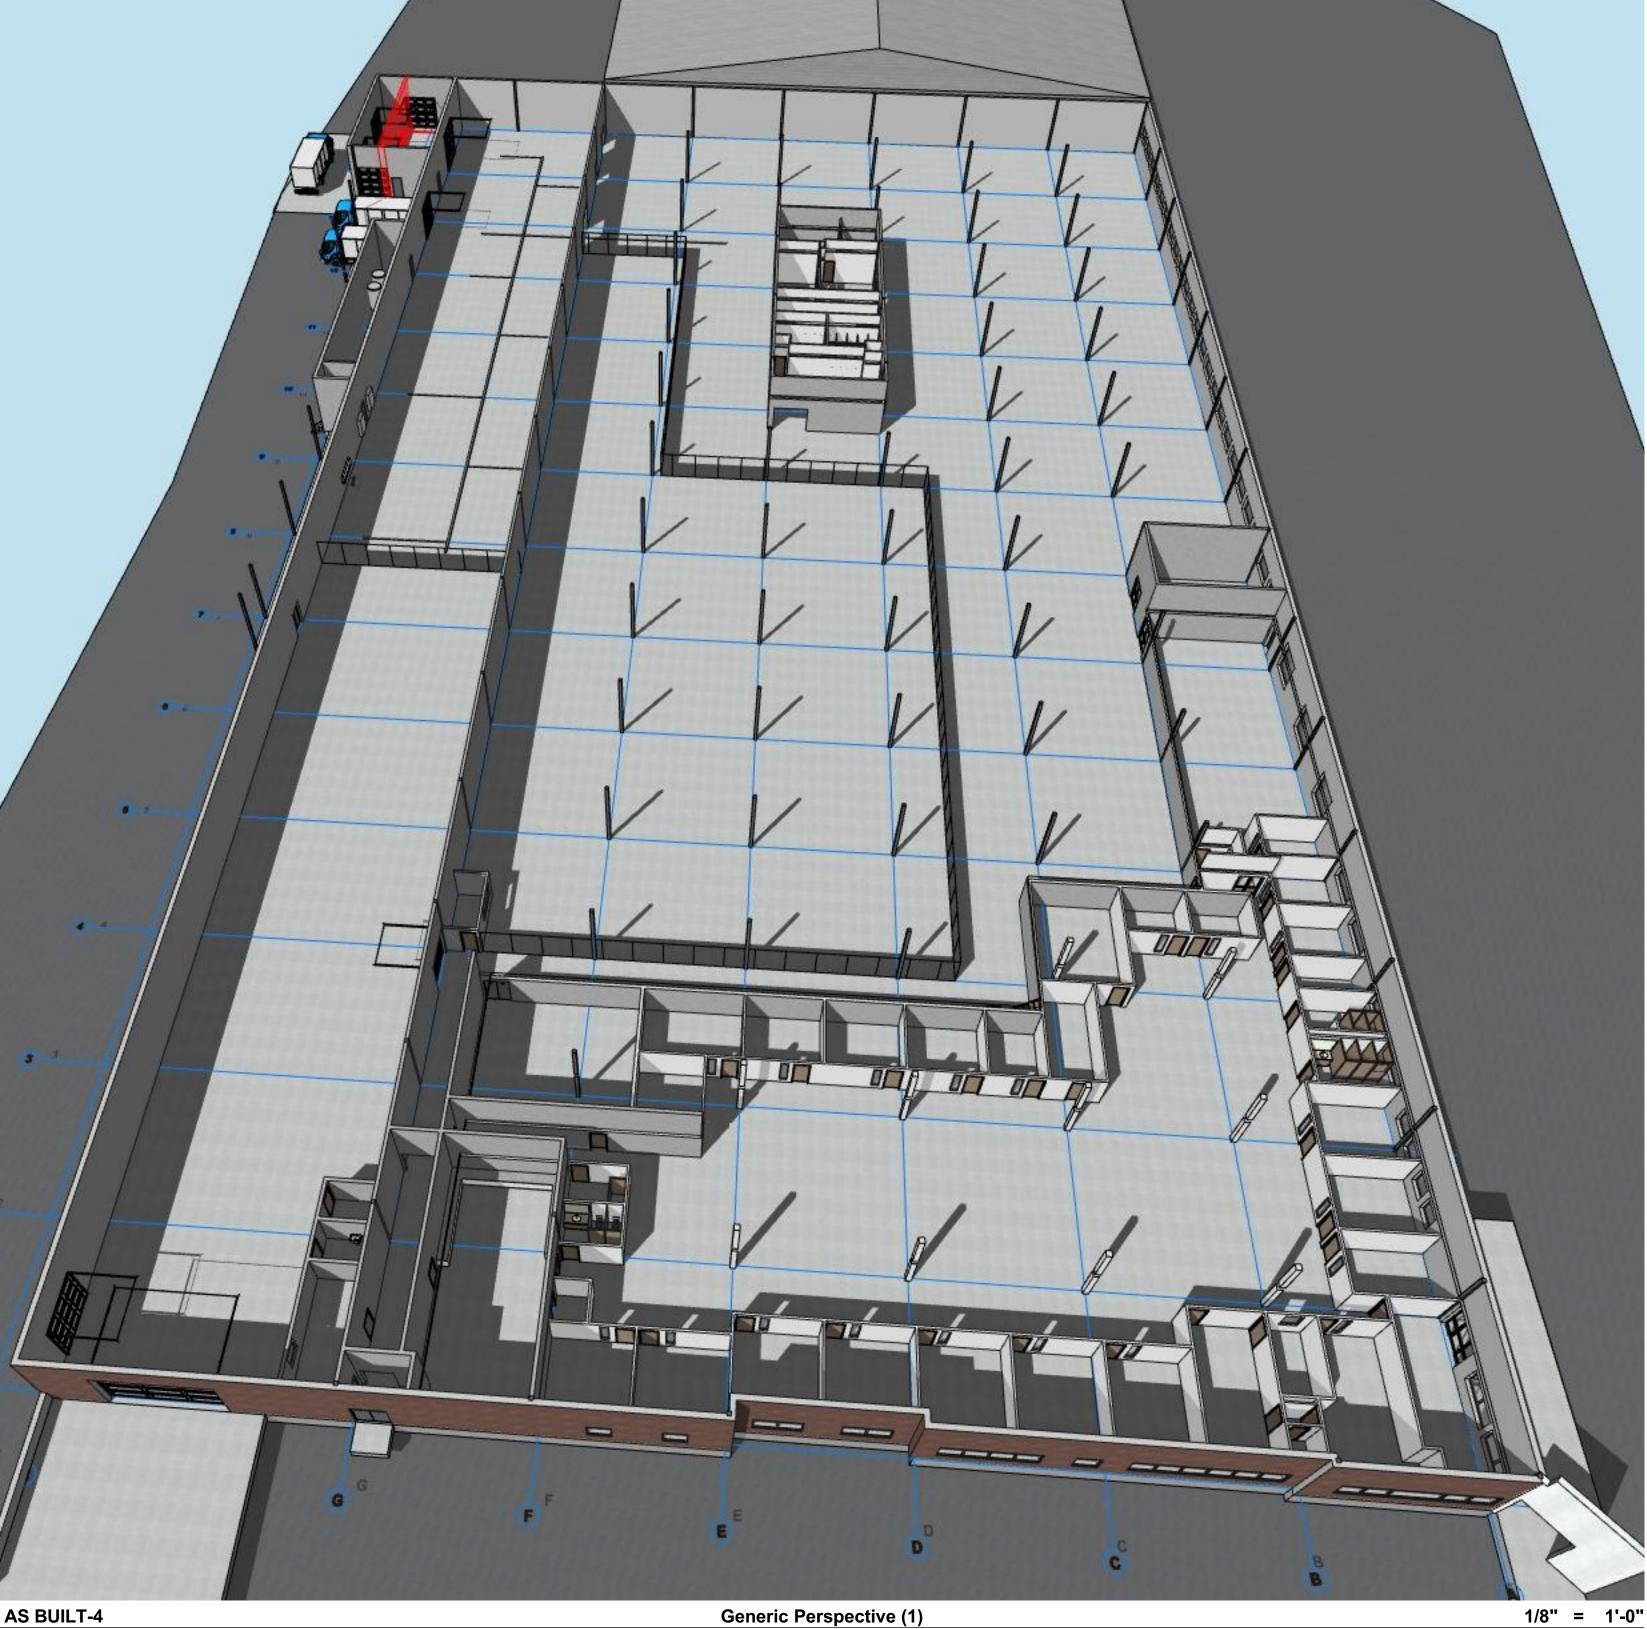

Balcrank

GENERAL NOTES:

1. DO NOT USE AS A BLUEPRINTS WITHOUT MR LLC PERMISSION.

2. PLEASE NOTE INTERIOR DIMENSIONS WERE NOT USED IN CALCULATING SQUARE FOOTAGE

3. SIZE OF HEATED AND NOT HEATED AREA AND OTHER INFORMATION WERE OBTAINED PER THE NC REAL ESTATE COMMISSION GUIDELINES (6" FOR EXTERNAL WALLS EXEPT CONDOMINIUMS)

4. FOR REMODELING QUESTIONS OR MORE DETAILED CAD DRAWINGS (INC. SITE PLAN, SECTIONS, ELEVATIONS) ALSO 3D MODEL PLEASE CONTACT ALFRED ZALYS MOB. 828 231 7305 E-MAIL: A.ZALYS@HOTMAIL.COM

LEGEND MAP:

NOT HEATED/NOT FINISHED WOOD/CER.TILES CONCRETE

Ι.	RevID	ChID	Change Name	



Measure Rite LLC 25 Clement Place. Asheville Buncombe County 28805

Site Address

1 Balcrank Way, Weaverville, NC

28787

Drawing Name
Generic Perspective (1), Generic Perspective (2), Generic

Perspective (3), Generic Perspective (4)

Contact Name	Job Nr.	
Alfred ZALYS	MR 801	
mob. 828 231 7305	Date	
	11/11/2021	
Drawing Scale	Layouts Total	
1/8" = 1'-0", 1:137.14, 1/16" = 1'-0",	4	
<del>1:147.69</del> Layout Nr.	Paper Size	
4	ANSI B	
Layout ID		Revision
AS BUILT-4		

1/16" = 1'-0" AS BUILT-4