Saint Pierre

Palm Desert, California



North West Corner Prespective (Corner of Larrea and Portola)

SHEET T-1 TITLE SHEET

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G-1 GRADING COVER SHEET

G-2 PRECISE GRADING PLAN

P-1 PRELIMINARY SITE/1st FLOOR PLAN

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P-5 PRELIMINARY ROOF PLAN

P-6 PRELIMINARY EXTERIOR ELEVATIONS

P-7 PRELIMINARY EXTERIOR ELEVATIONS

P-8 PRELIMINARY BUILDING SECTIONS

L-1 LANDSCAPE CONCEPTUAL PLAN

L-2 LANDSCAPE CONCEPTUAL IMAGES

1 TENTATIVE PARCEL MAP

1 PRELIMINARY WATER QUALITY MANAGEMENT PLAN

1 PRELIMINARY HYDROLOGY PLAN

Lot 1 thru 4 Block MB 21/50 A.P.N. 627-272-005

Saint Pierre


Drawn By - R.A

1st City Submittal - NA 00, 2019

March 17, 2020

T-1

PROJECT LOCATION

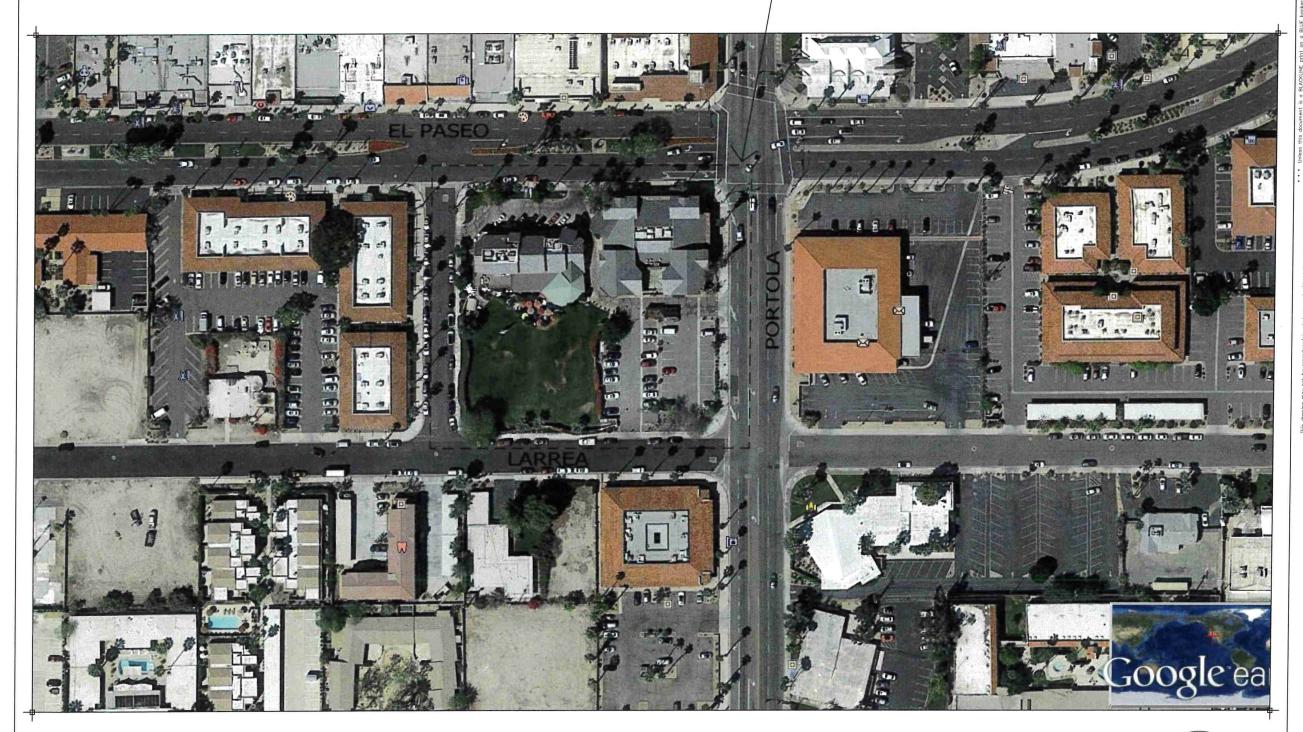



OT to by

h ering

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James G. McIntosh
hitecture and Engineerin
72-905 El Posso, Suite 201
Polm Desert, CA 92260

ixed use Residentail Project

Saint Pierre

73-995 El Paseo Im Desert, CA 92260

Lot 1 thru 4 Bloc MB 21/50

DRAWN RA

1st Submitto ..

Tuesday, March 17, 2020

SCALE N.T.S.

JOB NO. 1926

SHEET NO.

A-1

IAL MAP

PRELIMINARY GRADING PLAN

Plaza Roberge on El Paseo

73-995 El Paseo



VICINITY MAP

NOTE TO OWNER AND CONTRACTOR: IT IS THE OWNER'S RESPONSIBILITY TO SCHEDULE REGULAR MAINTENANCE OF THE DRAINAGE SYSTEM, INCLUDING BUT NOT LIMITED TO AREA DRAINS, DRAIN LINES, DRYWELLS AND BUBBLER BOXES.

CONTRACTOR SHALL RECOMMEND MAINTENANCE SCHEDULE TO OWNER BASED UPON INSTALLED EQUIPMENT AND AS—BUILT CONDITIONS.

ROOF DRAINS, RETAINING WALL FRENCH DRAINS, POT DRAINS, ETC. MAY BE TIED INTO DRAINAGE SYSTEM. OVERSIZING OF PIPES MAY BE NECESSARY.

PALM DESERT GENERAL NOTES:

- ALL WORK SHALL BE DONE IN ACCORDANCE WITH THIS PLAN, THE STANDARD DRAWINGS AND SPECIFICATIONS OF THE CITY OF PALM DESERT, THE STANDARD SPECIFICATIONS FOR PUBLIC WORKS CONSTRUCTION AND THE CALTRANS STANDARD PLANS AND CALTRANS STANDARD SPECIFICATIONS WHEN APPLICABLE.
- NO CONSTRUCTION IS AUTHORIZED WITHOUT THE APPROPRIATE PERMITS ISSUED BY THE CITY OF PALM DESERT PUBLIC WORKS DEPARTMENT.
- 3. THE ENGINEER-OF-WORK SHALL BE NOTIFIED WHEN CONSTRUCTION HAS COMMENCED.
- 4. IN THE EVENT OF DISCREPANCIES AND/OR DEVIATIONS ARISING DURING CONSTRUCTION THE ENGINEER-OF-WORK SHALL BE RESPONSIBLE FOR DETERMINING AN ACCEPTABLE SOLUTION AND REVISING THE PLANS FOR APPROVAL BY THE DIRECTOR OF PUBLIC WORKS.
- THE CONTRACTOR SHALL BE RESPONSIBLE FOR ALL DAMAGES TO ONSITE, OFFSITE AND ADJACENT UTILITIES, FACILITIES AND PROPERTIES.
- 6. THE CONTRACTOR SHALL TAKE ALL NECESSARY AND PROPER PRECAUTIONS TO PROTECT ADJACENT PROPERTY OWNERS FROM ANY AND ALL DAMAGE THAT MAY OCCUR FROM STORM WATER RUNOFF AND/OR DEPOSITION OF DEBRIS RESULTING FROM ANY AND ALL WORK IN CONJUNCTION WITH CONSTRUCTION OF THESE IMPROVEMENT PLANS.
- THE CONTRACTOR, AT NO EXPENSE TO THE CITY, SHALL PROVIDE ALL NECESSARY SAMPLES AND TESTS THAT THE DIRECTOR OF PUBLIC WORKS MAY REQUIRE TO ASSURE THAT QUALITY OF MATERIAL AND WORKMANSHIP ARE IN ACCORDANCE WITH THE SPECIFICATIONS.
- ALL SURVEY MONUMENTS WITHIN OR BOUNDING THE WORK LIMITS, WHETHER FOUND FROM RECORD OR BY INSPECTION, SHALL, PRIOR TO ANY CONSTRUCTION, BE LOCATED AND REFERENCED BY A LICENSEED SURVEYOR OR A CIVIL. ENGINEER AUTHORIZED TO PRACTICE LAND SURVEYING. THE REFERENCED MONUMENTS DISTURBED OR REMOVED DURING CONSTRUCTION SHALL BE RESET IN ACCORDANCE WITH SECTION B771 OF THE LAND SURVEYORS ACT AND CITY STANDARDS AND REQUIREMENTS AT THE CONTRACTOR'S
- THE CONTRACTOR SHALL NOTIFY THE DEPARTMENT OF PUBLIC WORKS IN PALM DESERT AT (760) 776-6450 AT LEAST 48 HOURS PRIOR TO COMMENCING ANY WORK.
- 11. THE CONTRACTOR SHALL BE RESPONSIBLE FOR THE LOCATION AND PROTECTION OF ALL UTILITIES. FOR THE LOCATION OF UNDERGROUND UTILITIES OR FOR EMERGENCY ASSISTANCE CALL:

GAS TELEPHONE

COACHELLA VALLEY WATER DISTRICT COACHELLA VALLEY WATER DISTRICT SOUTHERN CALIFORNIA EDISON THE GAS COMPANY VERIZON CALIFORNIA, INC. TIME WARNER

THE DEPARTMENT OF PUBLIC WORKS DOES NOT ASSUME ANY RESPONSIBILITY FOR THE ACCURACY OF THE QUANTITIES SHOWN HEREON.

760-398-2651 760-398-2651 760-202-4291 1-800-427-2200 1-800-483-1000 760-340-1312 1-800-227-2600

- 13. THE STRUCTURAL SECTION SHALL BE AS PER THE STATE OF CALIFORNIA DEPARTMENT OF TRANSPORTATION, HIGHWAY DESIGN MANUAL TEST NO. 301-F FOR DETERMINATION BY THE R-VALUE METHOD.
- 14. THESE PLANS MAY BE SUBJECT TO REVIEW AND/OR REVISION BY THE CITY OF PALM DESERT DEPARTMENT OF DUBLIC WORKS, IF CONSTRUCTION HAS NOT COMMENCED WITHIN 12 MONTHS FROM THE DATE OF APPROVAL BY THE DIRECTOR OF PUBLIC WORKS.
- 15. ALL P.C.C. AND A.C. REMOVALS SHALL BE OUTLINED TO NECESSARY WORKING LIMITS AND SAWCUT TO A MINIMUM DEPTH OF 2 INCHES PRIOR TO REMOVAL. ALL DEBRIS CREATED BY THE REMOVAL OPERATIONS SHALL BE DISPOSED OF AWAY FROM THE JOB SITE IN A MANNER AND LOCATION ACCEPTABLE TO ALL CONCERNED AGENCIES AND
- 16. ALL P.C.C. AND A.C. IMPROVEMENTS DAMAGED BY THE CONTRACTOR'S OPERATIONS SHALL BE RESTORED TO THEIR ORIGINAL CONDITION BY THE CONTRACTOR AT NO COST TO THE CITY OF PAUM DESERT.
- 17. STREETS IN THE CONSTRUCTION AREA SHALL BE KEPT CLEAN AT ALL TIMES.
- 18. THE CONTRACTOR SHALL BE RESPONSIBLE FOR CLEARING OF THE PROPOSED WORK AREA.
- NO PUBLIC STREET SHALL BE CLOSED TO TRAFFIC WITHOUT PRIOR WRITTEN APPROVAL OF THE CITY ENGINEER.
- NO TRENCHES SHALL REMAIN OPEN OVERNIGHT WITHOUT PRIOR WRITTEN APPROVAL OF THE CITY ENGINEER.
- 21. FAILURE TO COMPLY WITH ANY OF THE ABOVE ITEMS SHALL BE SUFFICIENT CAUSE FOR THE CITY TO ARRANGE FOR NECESSARY WORK TO BE COMPLETED BY OTHERS. COSTS TO COMPLETE THE WORK BY OTHERS WILL BE CHARGED TO THE CONTRACTOR.
- 22. ALL LANDSCAPING AND IRRIGATION THAT IS DAMAGED BY CONSTRUCTION ACTIVITIES SHALL BE REPAIRED OR REPLACED TO THE APPROVAL OF THE CITY AND THE PROPERTY OWNER.
- 23. CONTRACTOR MUST OBTAIN APPROVAL FOR ANY LANE CLOSURES A MINIMUM OF 48 HOURS
- 24. CONTRACTOR SHALL CALL THE PUBLIC WORKS DEPARTMENT TO REQUEST INSPECTION A MINIMUM OF 24 HOURS PRIOR TO STARTING CONSTRUCTION. CONTRACTOR SHALL KEEP THE INSPECTOR INFORMED OF PROGRESS OF THE WORK ON A DAILY BASIS. IMPROVEMENTS

PALM DESERT GRADING NOTES:

- ALL GRADING TO BE DONE IN ACCORDANCE WITH THE CITY OF PALM DESERT GRADING ORDINANCE.
- THIS PLAN IS FOR GRADING PURPOSES ONLY. ISSUANCE OF A GRADING PERMIT BASED ON THIS PLAN DOES NOT CONSTITUTE APPROVAL OF DRIVEWAY LOCATIONS AND SIZES, PARKING LAYOUT, BUILDING LOCATION, WALL HEIGHTS AND LOCATIONS, OFFSITE DRAINAGE FACILITIES, OR OTHER ITEMS NOT RELATED DIRECTLY TO THE BASIC GRADING OPERATION.
- 4 A WET SIGNED LETTER OF CERTIFICATION FROM THE ENGINEER-OF-WORK STATING

LOCATIONS OF FORMS ARE IN SUBSTANTIAL CONFORMANCE WITH THE APPROVED PLAN, AND A COMPACTION REPORT FROM A SOILS ENGINEER ON ALL FILL AREAS ARE REQUIRED PRIOR TO THE BUILDING PERMIT ISSUANCE.

- ALL WALLS SHOWN ON THESE PLANS SHALL BE APPROVED BY ALL WALLS SHOWN ON THESE PLANS SHALL BE APPROVED BY THE DEPARTMENT OF COMMUNITY DEVELOPMENT, ISSUED A SEPARATE PERMIT AND BE INSPECTED BY THE DEPARTMENT OF BUILDING AND SAFETY, THOSE WALLS THAT THE GRADING, PAD ELEVATIONS/FINISHED FLOOR ELEVATION AND HORIZONTAL SHOWN AS RETAINING WALLS SHALL BE CONSTRUCTED TO CITY OF PALM DESERT RETAINING WALL STANDARDS OR BE SUPPORTED BY ENGINEERING CALCULATIONS AND DETAILS.
- THE ENGINEER-OF-WORK SHALL BE NOTIFIED WHEN CONSTRUCTION HAS
- IN THE EVENT OF DISCREPANCIES AND/OR DEVIATIONS ARISING DURING CONSTRUCTION, THE ENGINEER-OF-WORK SHALL BE RESPONSIBLE FOR DETERMINING AN ACCEPTABLE SOLUTION AND REVISING THE PLANS FOR APPROVAL BY THE DEPARTMENT OF PUBLIC WORKS.
- THE CONTRACTOR SHALL BE RESPONSIBLE FOR ALL DAMAGES TO ON-SITE, OFF-SITE AND ADJACENT UTILITIES, FACILITIES AND PROPERTIES.
- THE CONTRACTOR SHALL TAKE ALL NECESSARY AND PROPER PRECAUTIONS TO PROTECT ADJACENT PROPERTY OWNERS FROM ANY AND ALL DAMAGE THAT MAY OCCUF FROM STORM WATER RUNOFF AND/OR DEPOSITION OF DEBRIS RESULTING FROM ANY AND ALL WORK IN CONJUNCTION WITH CONSTRUCTION OF THESE GRADING PLANS.
- THE CONTRACTOR SHALL NOTIFY THE DEPARTMENT OF PUBLIC WORKS (760) 776-6450 AT LEAST 24 HOURS PRIOR TO COMMENCING ANY WORK
- THE CONTRACTOR SHALL BE RESPONSIBLE FOR THE LOCATION AND PROTECTION OF ALL UTILITIES. FOR THE LOCATION OF UNDERGROUND UTILITIES, OR FOR EMERGENCY ASSISTANCE CALL:

COACHELLA VALLEY WATER DISTRICT COACHELLA VALLEY WATER DISTRICT SOUTHERN CALIFORNIA EDISON THE GAS COMPANY VERIZON CALIFORNIA, INC. TIME WARNER SEWER ELECTRIC TELEPHONE DIG ALERT

- 10. ALL PROPERTY CORNER MONUMENTS SHALL NOT BE DISTURBED BY THE GRADING OPERATION AND RELATED WORK. ANY MONUMENT WHICH THE CONTRACTOR ANTICIPATES DISTURBING SHALL BE LOCATED AND REFERENCED B A LICENSED LAND SURVEYOR OR A CIVIL ENGINEER AUTHORIZED TO PRACTICE LAND SURVEYING. ALL MONUMENTS DISTURBED OR REMOVED SHALL BE RESET BY A LICENSED SURVEYOR, OR A CIVIL ENGINEER AUTHORIZED TO PRACTICE LAND SURVEYING, AT THE CONTRACTOR'S EXPENSE.
- 11. THESE PLANS MAY BE SUBJECT TO REVIEW AND/OR REVISION BY THE CITY OF PALM DESERT DEPARTMENT OF PUBLIC WORKS, IF CONSTRUCTION HAS NOT COMMENCED WITHIN 12 MONTHS FROM THE DATE OF APPROVAL BY THE CITY ENGINEER.

EROSION CONTROL NOTE:

PER 2010 CAL GREEN CODE. SECTION 4.106.2:

In order to manage storm water drainage during construction, one or more of the following measures shall be implemented to prevent flooding of adjacent property, prevent erosion and retain soil runoff on the site.

- 1. Retention basins of sufficient size shall be utilized to retain
- 2. Where storm water is conveyed to a public drainage mere storm water is conveyed to a public drainage system, collection point, gutter or similar disposal method, water shall be filtered by use of a barrier system, wattle or other method approved by the enforcing agency.
- 3. Compliance with a lawfully enacted storm water

PROJECT INFO

PROJECT DATA:

TOTAL LOT AREA: 81,022 SQ.FT (1.86 ACRES) DISTURBED AREA: 81,022 SQ.FT (1.86 ACRES)

SOURCE OF TOPOGRAPHY:

THE TOPOGRAPHY SHOWN HEREON WAS OBTAINED BY A FIELD SURVEY BY FEIRO ENGINEERING, INC ON 1/10/16

SITE BENCHMARK:

NAIL AT THE RAMP ON THE NORTH WEST

CORNER OF THE INTERSECTION OF PORTOLA

AVE. AND LARREA STREET.

ELEVATION=(236.47 NAIL)

SITE BENCHMARK:

SITE BENCHMARK:

INDICATES THE BENCHMARK AT THE SITE WHICH
THE ENGINEER OF RECORD SHALL USE TO
CERTIFY PAD ELEVATION AND FINAL GRADING
CERTIFICATION. THE CONTRACTOR SHALL NOTIFY
THE ENGINEER OF RECORD OF ANY
DISCREPANCIES BETWEEN THIS BENCHMARK AND
THE BENCHMARK USED BY THE CONTRACTOR
PRIOR TO ANY GRADING.

APN: 627-272-005

OWNER:

TWO BIRD HOLDINGS C/O JMA ARCHITECTURE, INC. PO BOX 778 PALM DESERT, CA. 92261 TELEPHONE: (760) 346-6155

CIVIL ENGINEER:

FEIRO ENGINEERING, INC 75-060 GERALD FORD DR. STE.3 PALM DESERT, CA 92211 PHONE: (760) 346-8015

QUANTITIES ESTIMATE SHOWN IS FOR PERMIT PURPOSES ONLY. IT IS THE CONTRACTOR'S RESPONSIBILITY TO DETERMINE THE QUANTITIES FOR HIS BID AND PAYMENT

QUANTITIES ESTIMATE DOES NOT INCLUDE CLEARING, SHRINKAGE, SUBSIDENCE, ANY OTHER LOSSES, OR ANY GRADING OR EXCAVATION COVERED UNDER A SEPARATE

EARTHWORK QUANTITIES ESTIMATE:

CUT	=	1,420	CU	YDS
FILL	=	1,420	CU	YDS

CU YDS [BALANCE]

UTILITIES SHOWN REFLECT AVAILABLE PUBLIC RECORDS. IT SHALL BE THE RESPONSIBILITY OF THE CONTRACTOR TO VERIFY AND PROTECT ALL UTILITIES IN THE CONSTRUCTION AREA, WHETHER SHOWN OR NOT HEREON, AND TO NOTIF UNDERGROUND SERVICE ALERT AT 1-800-422-4133, 48 HOURS IN ADVANCE.

ANY MODIFICATION OF THIS PLAN MUST BE APPROVED BY THE CITY PRIOR TO CONSTRUCTION

> BASIS OF BEARINGS: N 00'09'45" W. PER MB 21/50-54.

ELEVATION: 267.732 DATUM: NGVD29 2" CITY OF PALM DESERT BRONZE DISC IN TOP OF CURB.

APPR. DATE

NDER THE DIRECT SUPERVISION OF:

Feiro Engineering Inc. P.O. Box 12980 Palm Desert, Ca 92255 (760) 346-8015 www.feiro.net

PROVED BY:

CITY ISSUE DATE: PLAN CHECKED BY: DEPARTMENT OF PUBLIC WORKS


760-398-2651 760-202-4291 1-800-427-2200 1-800-483-1000

1-800-227-2600


SHEET INDEX COVER SHEET PRECISE GRADING PLAN

PGP01 121m-60 SHEET SHEETS __2 PER PM 21/50-54 CITY FILE NUMBER 73-995 El Paseo, Palm Desert, CA, 92260

DWG FILE: 121m60pap0 LAYOUT: CITY OF PALM DESERT PRELIMINARY GRADING PLAN LOTS 1 23 & 4

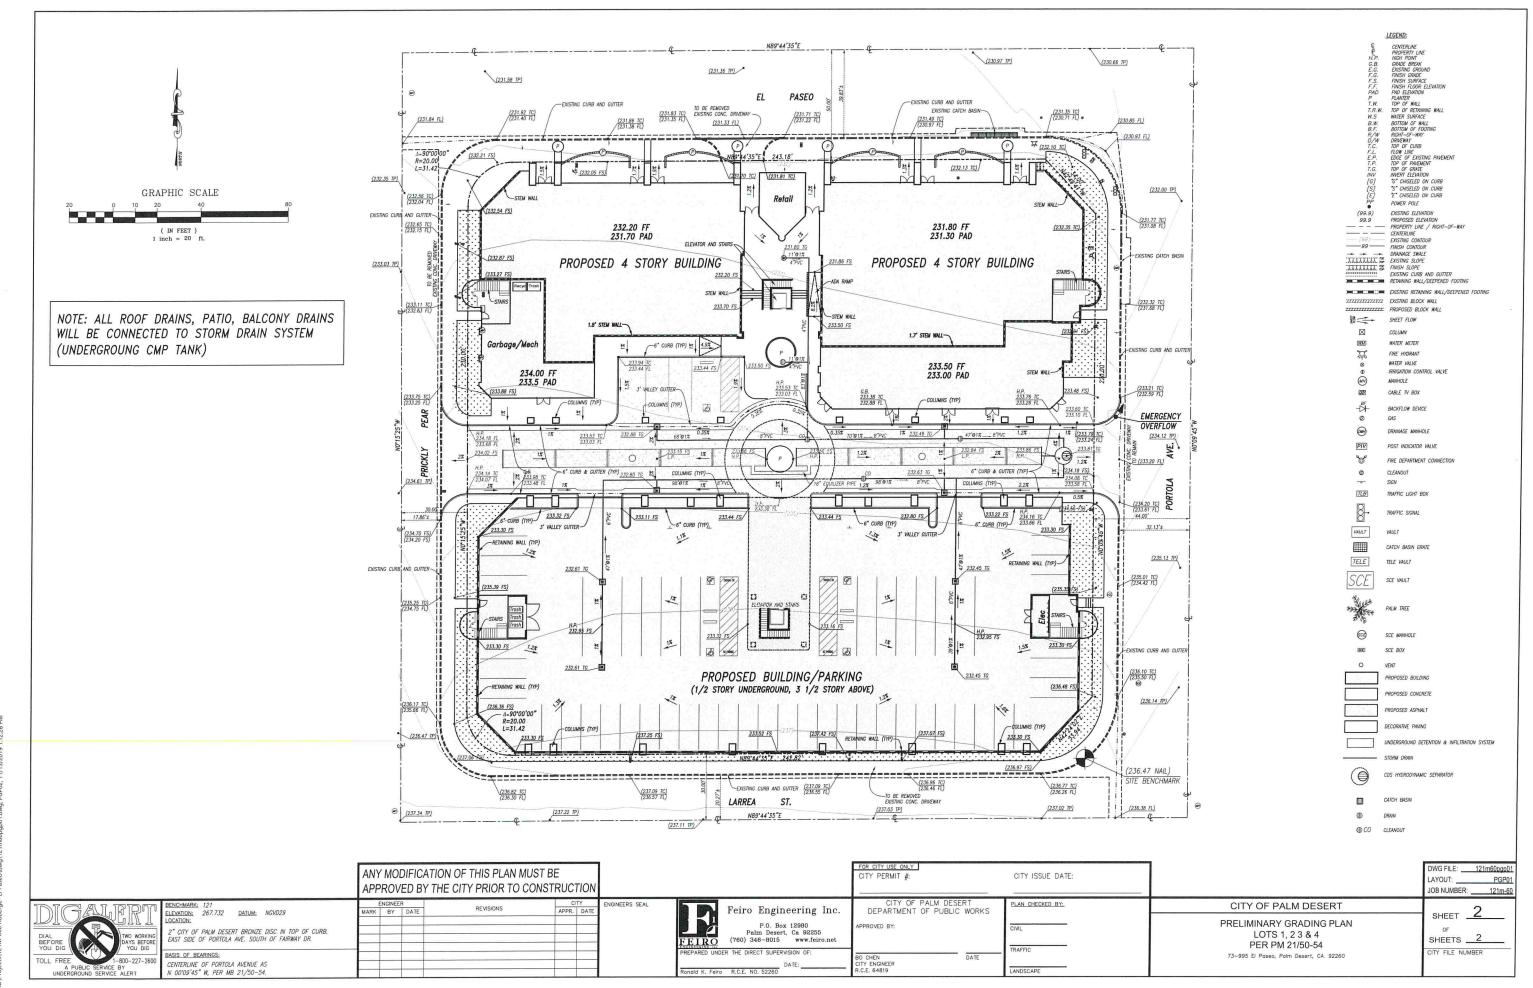

ierts\121M-060 Roberra. El Daces\right\rightarra\121m60.cm01 dura BCB03 11712/2010 1172-20 014

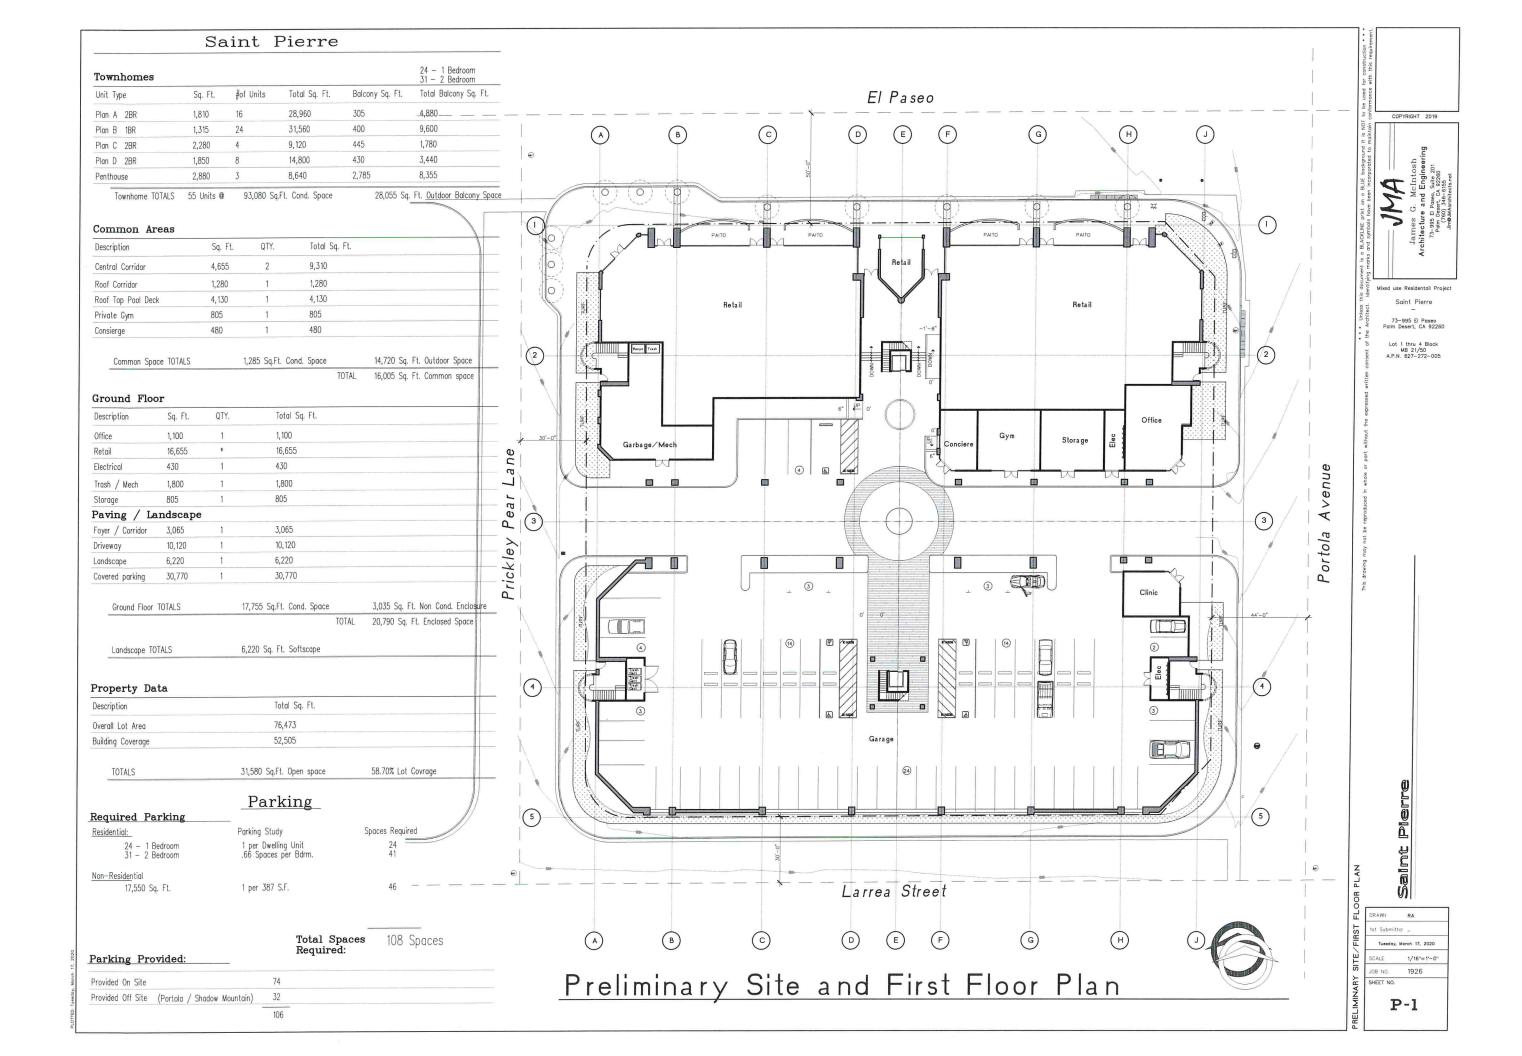



Mixed use Residentail Project for:

Saint Pierre

73-995 El Paseo Palm Desert, CA 92260

Lot 1 thru 4 Block MB 21/50 A.P.N. 627-272-005

00-00-00 City


Saint Pierre

Drawn By - R.A 1st City Submittal - NA 00, 2019 March 17, 2020

Scale = 1/16"=1'-0"

Resiadence

Job Number - 1926

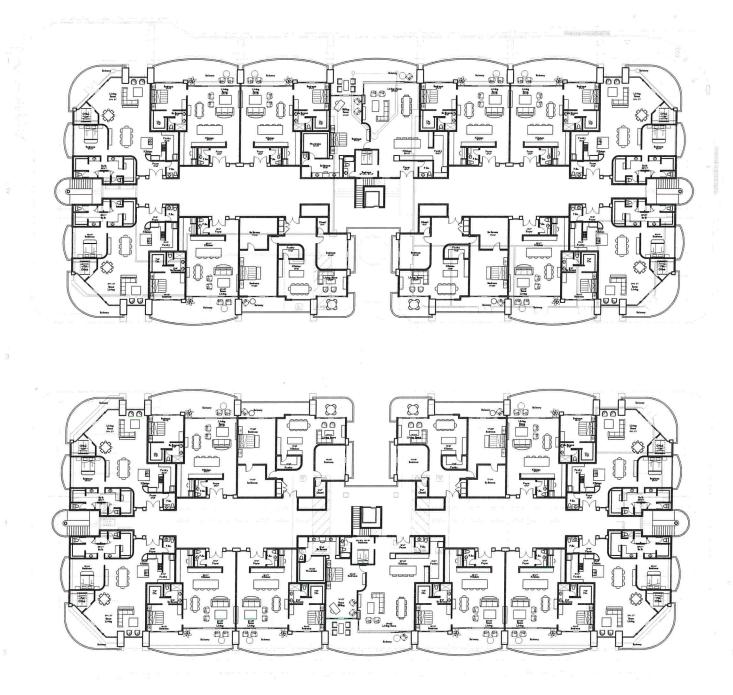

Preliminary 2nd Floor Suite Plans

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Mixed use Residental Projec

73-995 El Pase Palm Desert, CA 92

Lot 1 thru 4 BI MB 21/50 A.P.N. 627-272-

SCA SCA SOLIE PLAN


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Tuesday, M

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B NO. 1926

P2.2



JMA

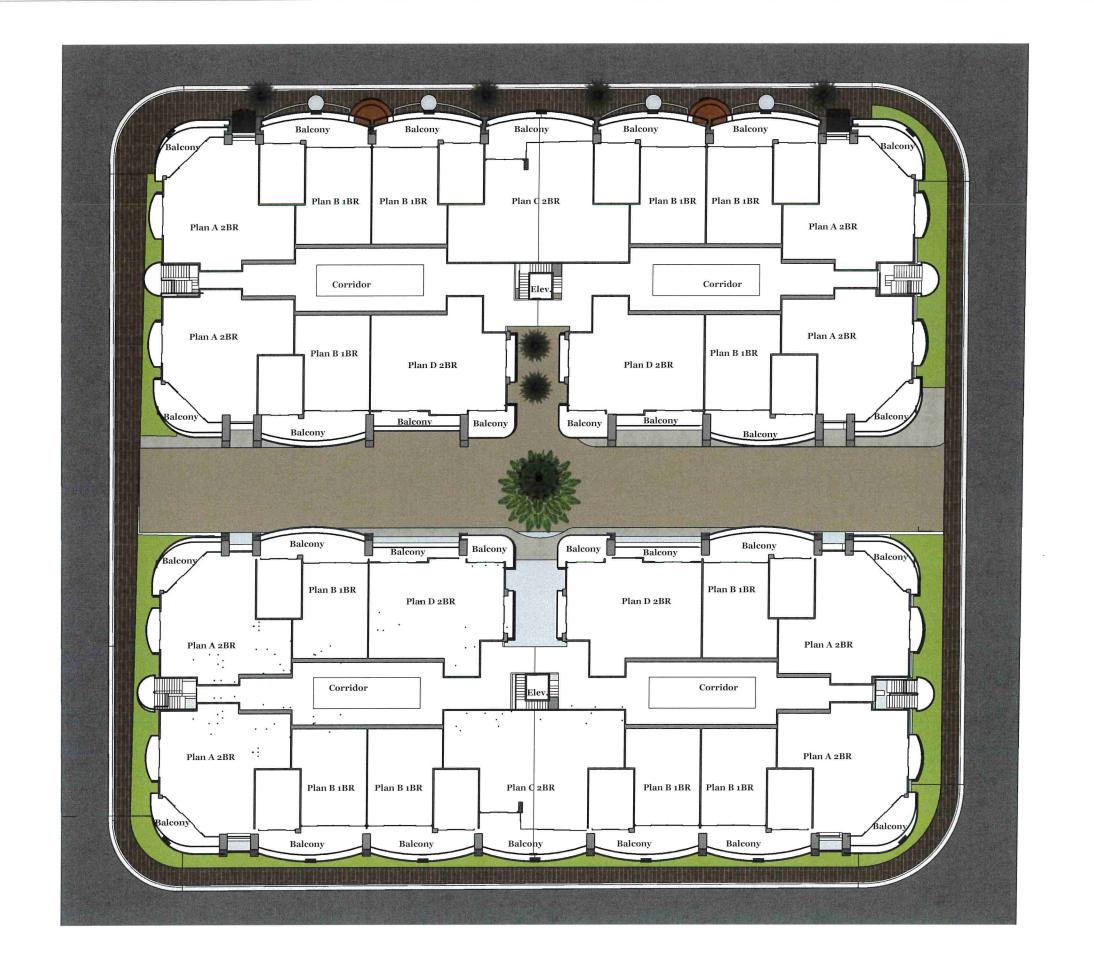Mixed use Residentail Project for:

Saint Pierre

73-995 El Paseo Palm Desert, CA 92260

Lot 1 thru 4 Block MB 21/50 A.P.N. 627-272-005

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City


Saint Pierre

Saint Pi

Drawn By - R.A 1st City Submittal - NA 00, 2019

March 17, 2020 Scale = 1/16"=1'-0"

Job Number - 1926

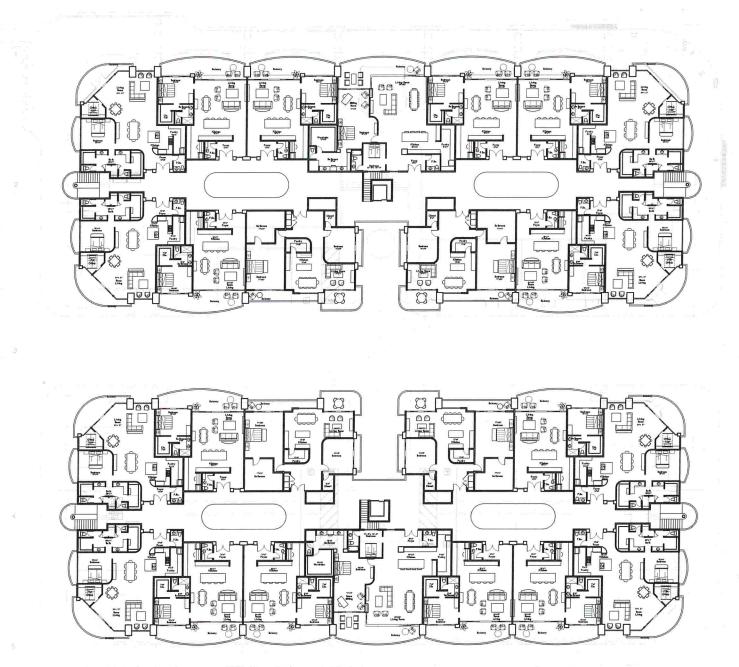

Preliminary 3rd Floor Suite Plans



James G. McIntosh

Mixed use Residentail Project for:

Saint Pierre 73-995 El Paseo Palm Desert, CA 92260

Lot 1 thru 4 Block MB 21/50 A.P.N. 627-272-005

> 00-00-00 City

Saint Pierre

Drawn By - R.A

1st City Submittal - NA 00, 2019

March 17, 2020

Job Number - 1926

P-4

PRELIMINARY 4th FLOOR PLAN



James G. McIntosh

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Saint Pierre

73-995 El Paseo Palm Desert, CA 92260

Lot 1 thru 4 Block MB 21/50 A.P.N. 627-272-005

> 00-00-00 City

Saint Pierre

Drawn By - R.A

Resiadence

ıst City Submittal - NA 00, 2019

March 17, 2020

Scale = 1/16"=1'-0"

Job Number - 1926





James G. McIntosh
Architecture and Engineering
73-995 El Pasco, Suite zor
Pland Docert, Co. 92260
Pland Docert, Co. 92260

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Saint Pierre 73-995 El Paseo

Lot 1 thru 4 Block MB 21/50 A.P.N. 627-272-005

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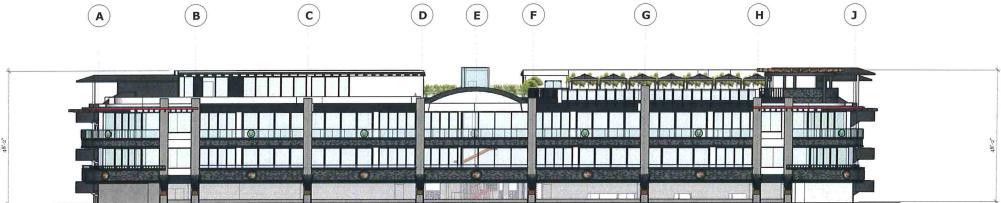
Saint Pierre

Drawn By - R.A City Submittal - NA 00

March 17, 2020 Scale = 1/16"=1'-0"

Job Number - 192





Rear Elevation (Larrea)



Lot 1 thru 4 Block MB 21/50 A.P.N. 627-272-005

00-00-00 City

Saint Pierre

Job Number - 1926



Building Section A

James G. McIntosh Architecture and Engineering

Mixed use Residentail Project for:

Saint Pierre

73-995 El Paseo Palm Desert, CA 9220

Lot 1 thru 4 Block MB 21/50 A.P.N. 627-272-005

> 00-00-City

Saint Pierre


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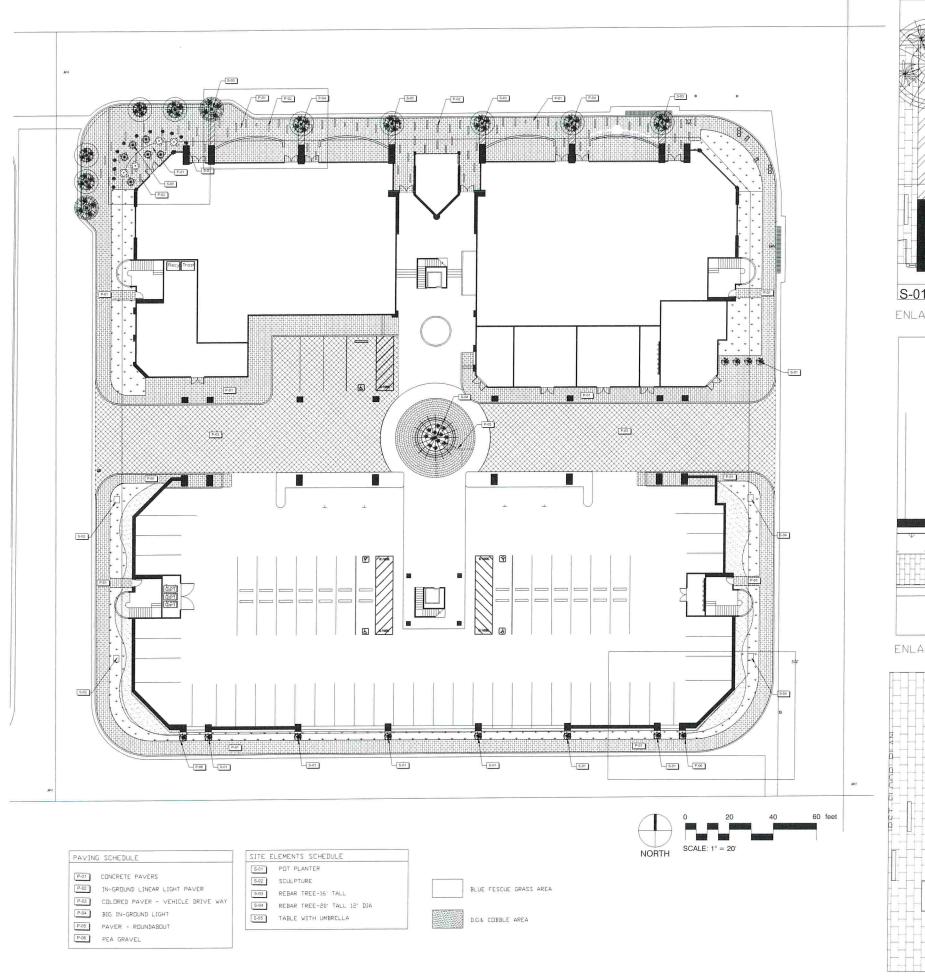
1st City Submittal - NA oc


March 17, 2020

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Job Number - 1926





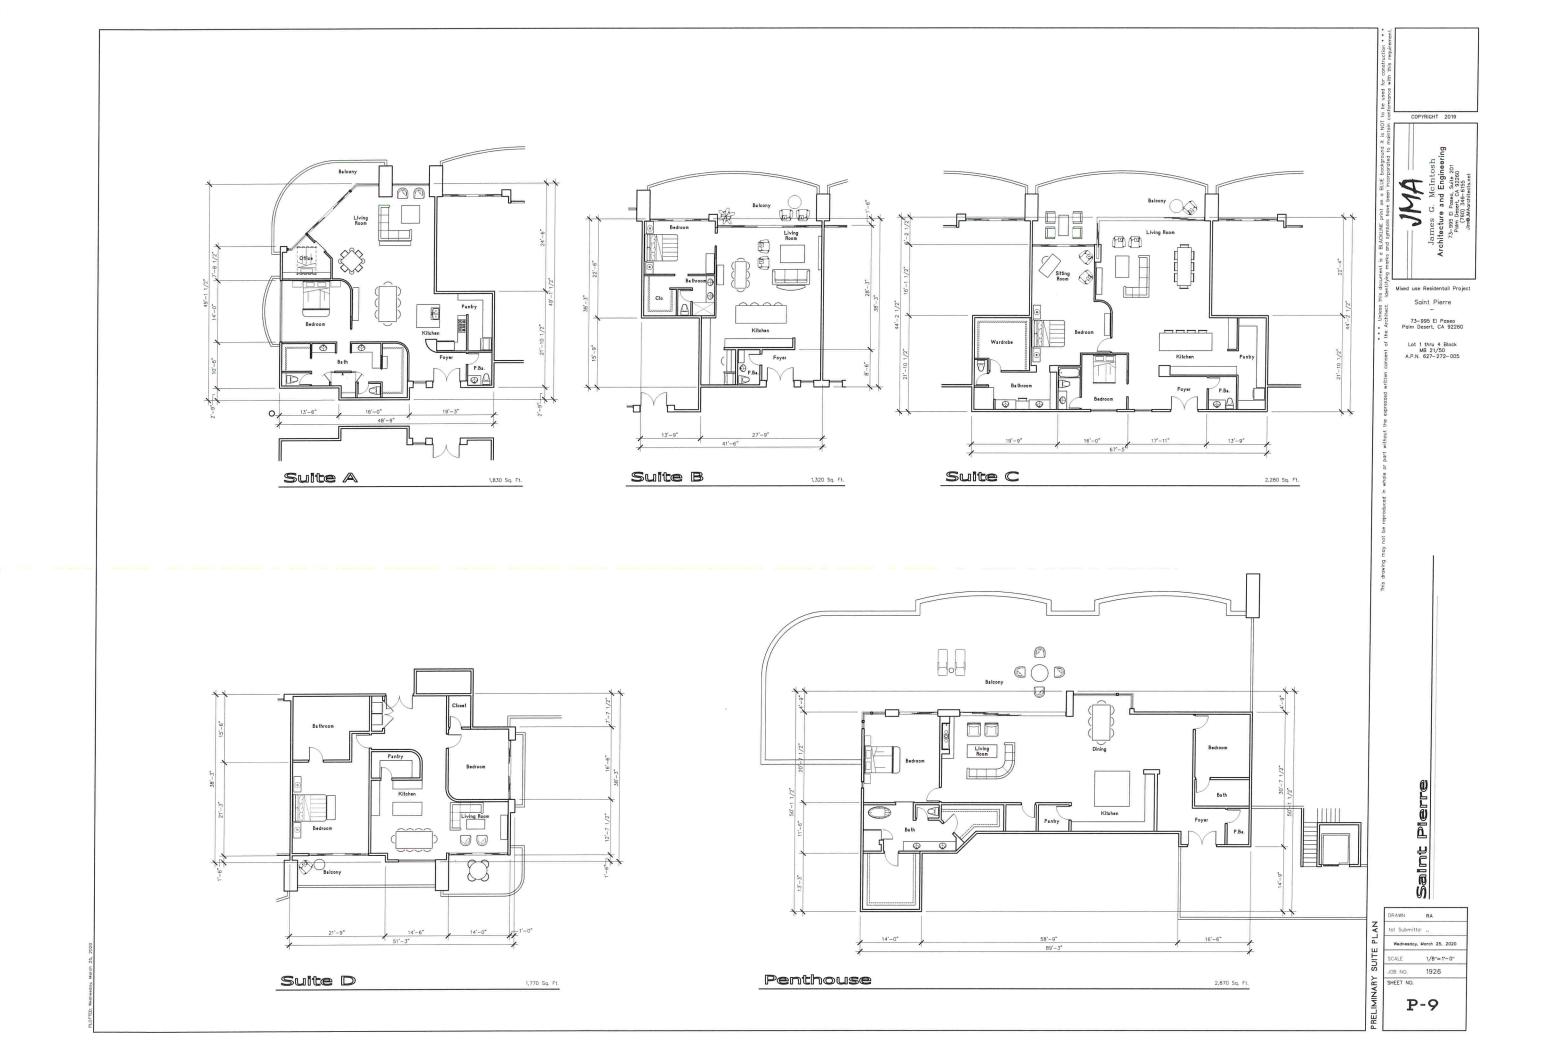

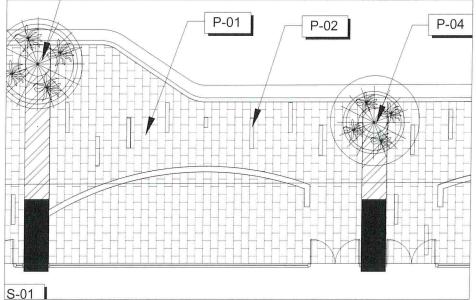ENLARGED EL PASEO SIDEWALK PLAN


SCALE: 3/16"=1'-0"

S-04

P-01 S-01 P-06

ENLARGED LARREA STREET SIDEWALK PLAN

SCALE: 1/8"=1'-0"

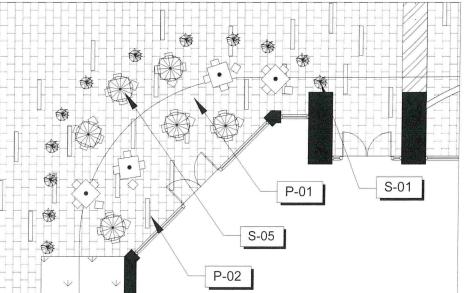

ENLARGED PLAYFUL FOUNTAIN AREA PLAN

SCALE: 3/16"=1'-0"



869 W. 9th St. Upland, Ca 91786 P. 909.346.1111 chris@soltislandscape.com dbenson@soltislandscape.com



ROJECT OWN

LAZA ROBERGE ON EL PASEO 3-995 EL PASEO PALM DESERT A 92260

NO.	REVISIONS	
1		

SHEETTITLE
CONSTRUCTION
CONCEPTUAL
PLAN

DRAV	NBY DLW
CHEC	KEDBY CMS/DRE
DATE	01/29/2020

SHEET:

L-1

SHEETS 1 OF 3



P-06 PEA GRAVEL




S-03 REBAR TREE-16' TALL




SCULPTURE S-02



S-01 POT PLANTER

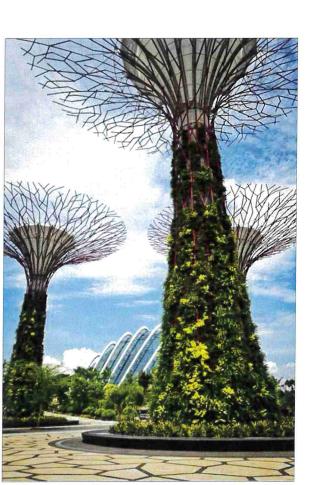




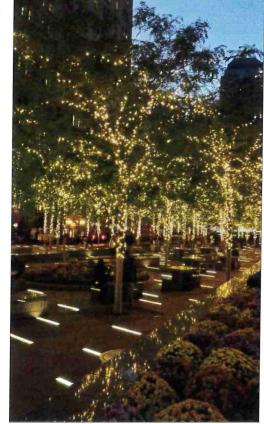

P-02 IN-GROUND LINEAR LIGHT PAVER

869 W. 9th St. Upland, Ca 91786 P. 909.346.1111 chris@soltislandscape.com dbenson@soltislandscape.com

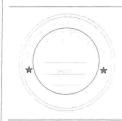

'LAZA ROBERGE ON EL PASEO 3-995 EL PASEO PALM DESERT 3A 92260

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NO	REVISIONS	
1		
		_

SHEET TITLE CONSTRUCTION CONCEPTUAL PLAN

DRAWN BY DLV	V
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CHECKED BY C M S /D R B

DATE 01/29/2020

JOB NO B120

SHEET:

SHEETS 2 OF 3

S-04 REBAR TREE-20' TALL 12' DIA

P-01 CONCRETE PAVERS

















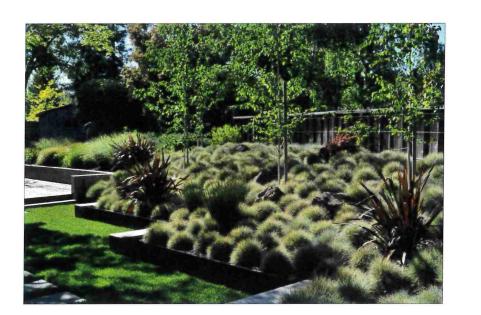



869 W. 9th St. Upland, Ca 91786 P. 909.346.1111 chris@soltislandscape.com dbenson@soltislandscape.com

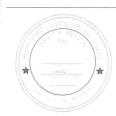

OJECT OWN

PLAZA ROBERGE ON EL PASEO 73-995 EL PASEO PALM DESERT CA 92260

NO	REVISIONS
1	

SHEET TITLE
CONSTRUCTION
CONCEPTUAL
PLAN

DRAWN BY D.L.W

CHECKED BY CMS/DRB

DATE 01/29/2020

JOB NO. B120

SHEET:


L-3

SHEETS 3 OF 3

IN THE CITY OF PALM DESERT, COUNTY OF RIVERSIDE, STATE OF CALIFORNIA

TENTATIVE TRACT MAP NO.

BEING A SUBDIVISION OF LOTS 1-4, BLOCK T, PALM DESERT PER MAP BOOK RECORDED OCTOBER 17, 1946 MAP BOOK 21/50-54, OF OFFICIAL RECORDS, IN THE OFFICE OF THE COUNTY RECORDER OF RIVERSIDE COUNTY, CALIFORNIA, BEING A PORTION OF THE SOUTH HALF OF SECTION 20, TOWNSHIP 5 SOUTH, RANGE 6 EAST, S.B.B.&M. NOVEMBER, 2019 FEIRO ENGINEERING, INC.

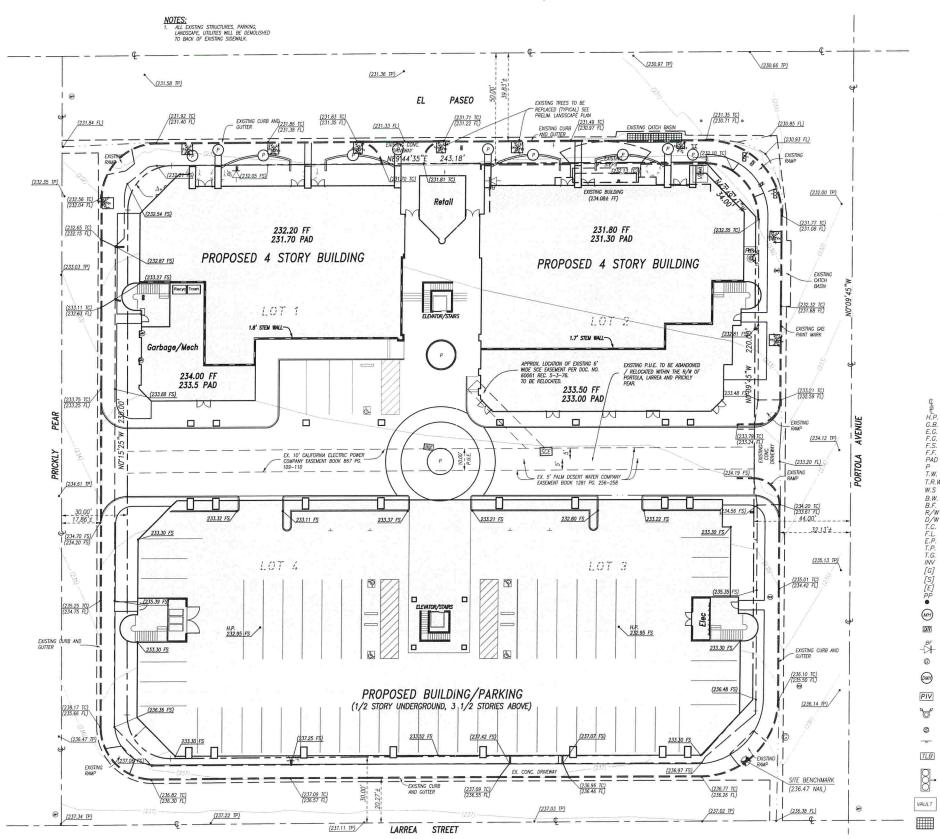

OWNER/APPLICANT:

TWO BIRD HOLDINGS, LLC c/o JMA ARCHITECTURE, INC. P.O. BOX 778 PALM DESERT. CA 92261 (760) 346-6155 PHONE

ENGINEER:

FEIRO ENGINEERING, INC. P. O. BOX 12980 PALM DESERT, CA. 92255 (760) 346-8015 PHONE

627-272-005

APPROXIMATE AREA: 1.76 ACRES OR 76,474 sq. ft.

BASIS OF BEARING: CENTERLINE OF PORTOLA AVENUE AS

N 00'09'45" W, PER MB 21/50-54.

CITY OF PALM DESERT BM#121 2" CITY OF PALM DESERT BRONZE DISC IN TOP OF CURB. EAST SIDE OF PORTOLA AVE. SOUTH OF FAIRWAY DR. FI FVATION=(267, 732) NGVD29

SITE BENCHMARK:

NAIL AT THE RAMP ON THE NORTH WEST CORNER OF THE INTERSECTION OF PORTOLA AVE. AND LARREA STREET. FI FVATION=(236.47 NAII.) SITE BENCHMARK:

SILE BENCHMARK:

NOICATES THE BENCHMARK AT THE SITE WHICH THE ENGINEER OF RECORD SHALL USE TO CERTIFY PAD ELEVATION AND FINAL GRADING CERTIFICATION. THE CONTRACTOR SHALL NOTIFY THE ENCINEER OF RECORD OF ANY DISCREPANCIES BETWEEN THIS BENCHMARK AND THE BENCHMARK USED BY THE CONTRACTOR PRIOR TO ANY GRADING.

SOURCE OF TOPOGRAPHY:

THE TOPOGRAPHY SHOWN HEREON WAS OBTAINED BY A FIELD SURVEY BY FEIRO ENGINEERING DATED 1-10-2016.

LEGAL DESCRIPTION:

TRAFFIC LIGHT BOX

TRAFFIC SIGNAL

CATCH BASIN GRATE

LEONE DESIGNATION.

LOTS 1, 2, 3 AND 4 IN BLOCK T OF PALM DESERT IN THE CITY OF PALM DESERT, COUNTY OF RIVERSIDE, AS PER MAP ON FILE IN BOOK 21 OF MAPS, PAGES 50 TO 54 OF MAPS, IN THE OFFICE OF THE COUNTY RECORDER OF SAID COUNTY.

HIGHWAY 111 -SITE 🗟 SHADOW MOUNTAIN DRIVE CANDLEWOOD STREE

VICINITY MAP NOT TO SCALE

UTILITIES: ELECTRIC

TELEPHONE

SEWER

SOUTHERN CALIFORNIA EDISON 760-202-4286 SO. CA. GAS (THE GAS COMPANY)
FRONTIER COMMUNICATIONS 800-427-2200 877-775-6373 760-398-2651 CVWD 760-398-2651 888-892-2253

SCHOOL DISTRICT:

DESERT SANDS UNIFIED SCHOOL DISTRICT

PROPOSED LAND USE:


MUILTI USE RETAIL/RESIDENTIA

EXISTING & PROPOSED ZONING:

GENERAL PLAN DESIGNATION:

LEGEND: EXISTING ELEVATION 99.9 PROPOSED ELEVATION
PROPERTY LINE / RIGHT-OF-WAY DENVERGINE
PROPERTY LINE
HIGH POINT
GRADE BREAK
EXISTING GROUND
FINISH GRADE
FINISH SURFACE
FINISH SURFACE
FINISH FLOOR ELEVATION
PAD ELEVATION
PLANTER H.P. G.B. E.G. F.S. F.F. PAD P. T.W. T.R.W. CENTERLINE EXISTING CONTOUR ——99 —— FINISH CONTOUR DRAINAGE SWALL


THE EXISTING SLOPE DRAINAGE SWALE TATALATA TOE FINISH SLOPE EXISTING CURB AND GUTTER RETAINING WALL/DEEPENED FOOTING TOP OF RETAINING WALL TOP OF RETAINING WALL
WATER SURFACE
BOTTOM OF WALL
BOTTOM OF FOOTING
RIGHT-OF-MAY
DRIVEWAY
TOP OF CURB
FLOW LINE
EDGE OF EXISTING PAVEMENT
TOP OF PAVEMENT
TOP OF PAVEMENT
TOP OF ORATE
INVERT ELEVATION
"C" CHISET DON CURR DESCRIPTION EXISTING RETAINING WALL/DEEPENED FOOTING CATIZITATIZITATIZ EXISTING BLOCK WALL TITITITITITE PROPOSED BLOCK WALL NOW TOWN SHEET FLOW CONCRETE \boxtimes COLUMN [WM] WATER METER "G" CHISELED ON CURE "S" CHISELED ON CURB D. FIRE HYDRANT "E" CHISELED ON CURB WATER VALVE POWER POLE IRRIGATION CONTROL VALVE MANHOLE CABLE TV BOX SCE SCF VALUET GAS PALM TREE POST INDICATOR VALVE (CE) SCE MANHOLE FIRE DEPARTMENT CONNECTION CLEANOUT SCF BOX SIGN

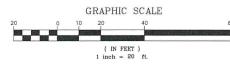


In the City of Indio


Preliminary Water Quality Management Plan

Plaza Roberge on El Paseo

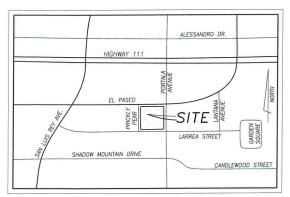

VICINITY MAP

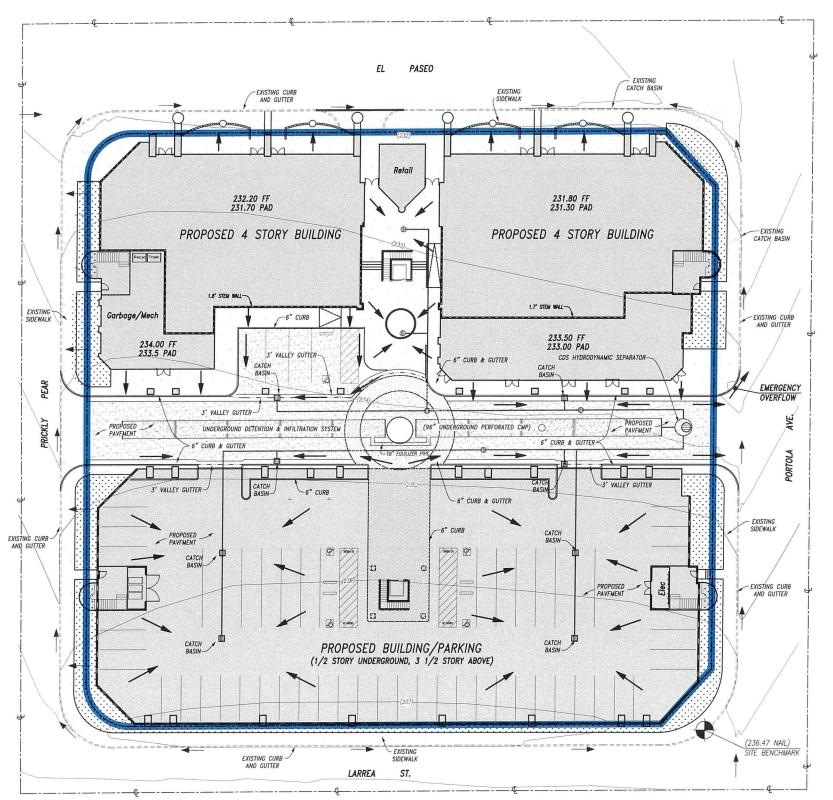

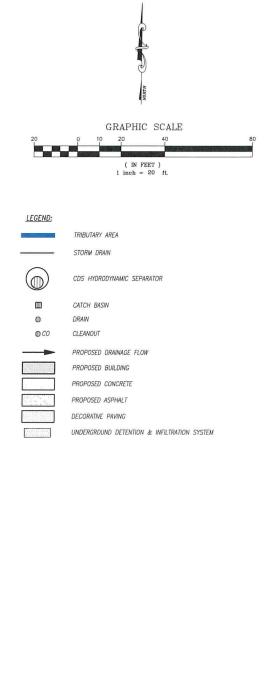



Civil Engineering Poll Desert, Collorio 92.

Land Surveying (760) 346–8015

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PREPARED UNDER THE DIRECT SUPERVISION OF:

City of Palm Desert

Preliminary Water Quality Management Plan

OF 1 SHEET NUM

1

OF 1 SHEET NUM


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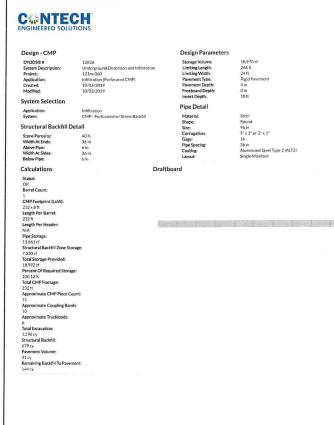
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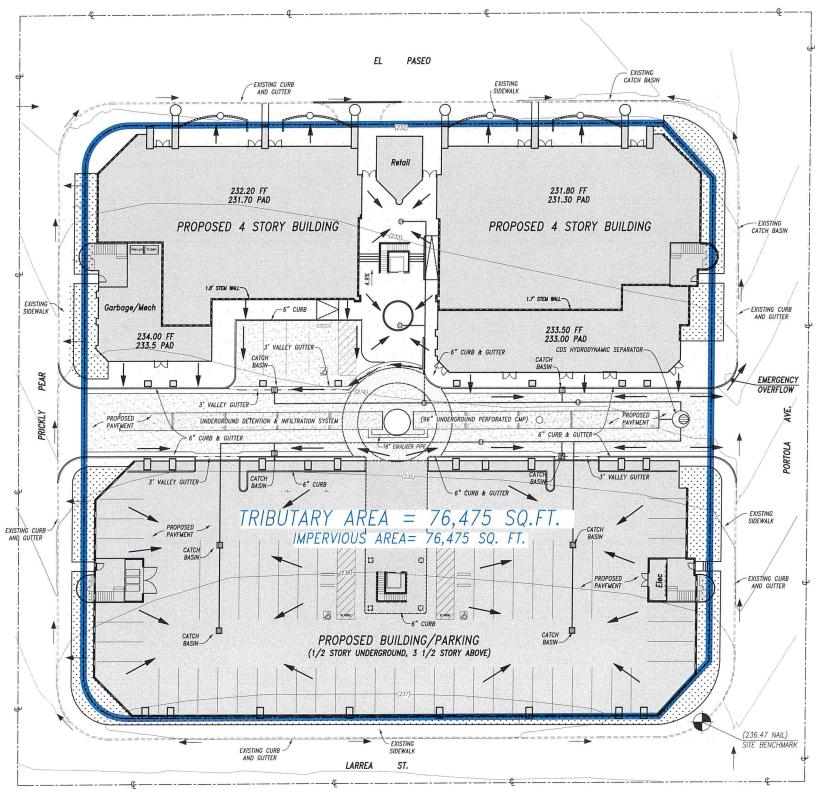
In the City of Indio


Preliminary Hydrology Plan

Plaza Roberge on El Paseo





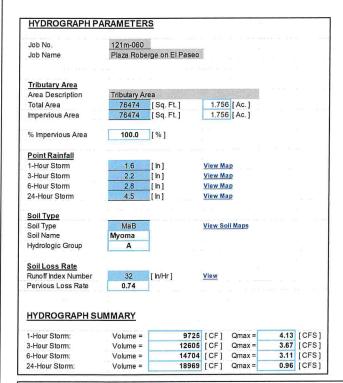

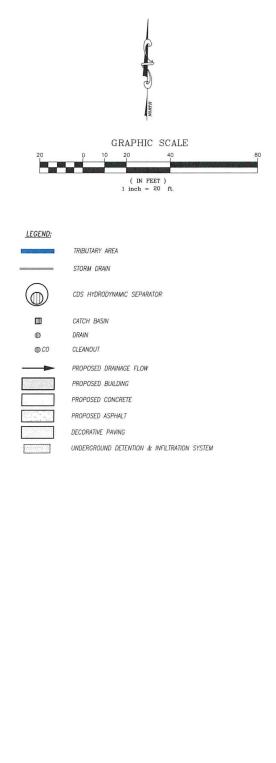



Civil Engineering Palm Desert, California
Land Surveying (760) 346–80

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City of Palm Desert
Preliminary Hydrology Plan

FOR: Plaza Roberge on El Paseo

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