HARRIS HEALTH SYSTEM

SPRING BRANCH HEALTH CENTER

9801 Long Point Houston, Texas

November 4, 2013 Issue for Permit & Pricing

Harris County

El Franco Lee
Commissioner Precinct 1

Jack Morman
Commissioner Precinct 2

Barbara J. Schott
County Auditor

Ed Emmett
County Judge




Steve Radack
Commissioner Precinct 3

R. Jack Cagle
Commissioner Precinct 4

Arthur L. Storey Jr., P.E. County Engineer

AREA MAP STANDARD ABBREVIATIONS INDEX OF SHEETS West Houston Seventh Day Adventist Churc ABOVE FINISH FLOOR Sheet ADJ. ADDL LLV LONG LEG VERTICAL ADJUSTABLE Number Sheet Name Sheet Issue Date LONG LEG HORIZONTAI ADDITIONAL **LOW POINT** ALTERNATE SHEET & DRAWING REFERENCE LEGEND ALUMINUM **MANUFACTURER ANCHOR BOLTS MASONRY** Spring Plaza A-000 INDEX 11/04/13 MASONRY OPENING Spring Woods Veterinary REFER TO CIVIL, STRUCTURAL & MECHANICAL SHEETS FOR RESPECTIVE DISCIPLINE **ARCHITECTURAL** MAXIMUM ARCHITECTURE **LEGENDS** MECH./ELECT./PLUME **PARTITION TYPES** 11/04/13 BACK-UP ROD MECHANICAL A-002 DOOR TYPES 11/04/13 DISCIPLINE BOTTOM MINIMUM A-003 TOILET TYPES 11/04/13 BUILDING NOT IN CONTRACT Gx - GENERAL ARCHITECTURAL LEVEL 1 LIFE SAFETY PLAN 11/04/13 **BUILT-UP ROOF** NOT TO SCALE Cx - CIVIL ON CENTER AF-102 UL RATINGS 11/04/13 CEILING Lx - LANDSCAPE UL RATINGS 11/04/13 CEM. **CEMENT** AF - LIFE SAFETY Kurio Drywall **CENTER LINE OUTSIDE DIAMETER AD-DEMOLITION** UL RATINGS 11/04/13 CERAMIC OPPOSITE HAND Ax - ARCHITECTURAL LEVEL 1 DEMOLITION PLAN 11/04/13 **CERAMIC TILE** Ix - INTERIORS COL. COLUMN LEVEL 1 FLOOR PLAN & REFLECTED CEILING PLAN 11/04/13 PLASTIC LAMINATE Sx STRUCTURAL CONCRETE PLASTIC LAMINATE INTERIOR ELEVATIONS & CABINETRY TYPES 11/04/13 Mx MECHANICAL CONCRETE MASONRY UNIT PLUMB. PLUMBING New Community Baptist Church INTERIORS PLYWD. Ex ELECTRICAL CONSTRUCTION **PLYWOOD** CONTINUOUS PRESSED STEEL Px PLUMBING INTERIOR FINISHES SCHEDULE & GENERAL NOTES 11/04/13 NUMBER OF PLAN, DETAIL, SHEET NO. Palace Inn Ivyride I-10 West CONTRACTOR PLATE/ PROPERTY LINE FP FIRE PROTECTION I-101 SECTION, ETC. ON SHEET LEVEL 1 INTERIOR FINISHES PLAN 11/04/13 CORNER GUARD PLUMBING Tx TECHNOLOGY CONTROL JOIN **EQUIPMENT** POLISHED CURTAIN WAL PATCH TO MATCH **EQUIPMENT** 11/04/13 DECORATIVE RADIUS RECEPTACLE DIAMETER REFERENCE MECHANICAL LEGENDS, SYMBOLS & GENERAL NOTES 11/04/13 DIMENSION REINFORCING Westview Dr MECHANICAL FLOOR PLAN 11/04/13 REQUIRED R./ REV. R./REV. MECHANICAL DETAILS 11/04/13 DOWN SPOUT RISER/RADIUS Briar Branch MECHANICAL DETAILS 11/04/13 ROOF DRAIN EACH WAY MECHANICAL DETAILS 11/04/13 ELECTRIC **ROUGH OPENING** 11/04/13 MECHANICAL SCHEDULES ELECTRIC WATER COOLER SPLASH BLOCK ELECTRICAL ELEVATOR SCHEDULE / SCHEDULED ELEVATION ELECTRICAL SYMBOLS LEGEND & PANEL SCHEDULES 11/04/13 E-101 11/04/13 POWER PLAN Four Points by Sheraton Houston West EXPANSION SIMILAR EXPANSION JOINT SHAFT OPENING E-201 LIGHTING PLAN 11/04/13 EXTERIOR SPECIFICATION E-301 FIRE ALARM PLAN 11/04/13 SQUARE PLUMBING FINISH FLOOR STAINLESS STEEL FIRE EXTINGUISHER CABINET STANDARD 11/04/13 PLUMBINGFLOOR PLAN FIRE EXTINGUISHER GENERAL NOTES PLUMBING RISERS 11/04/13 FIRE HOSE CABINET **STRUCT** STRUCTURAL FIRE HYDRANT PLUMBING DETAILS 11/04/13 FLASHING P-401 PLUMBING SCHEDULES 11/04/13 TOP OF BEAM FLOOR DRAIN TOP OF CURB **GALVANIZED** TOP OF JOIST LEGENDS, INDES, AND NOTES - TELECOM 11/04/13 DO NOT SCALE DRAWINGS FOR CONSTRUCTION PURPOSES. IN THE EVENT OF OMISSION OF NECESSARY DIMENSION(S), NOTIFY GALVANIZED IRON TOP OF STEEL THE ARCHITECT. FACEPLATE, BACKBOX, AND CONDUIT REQUIREMENTS - TELECOM 11/04/13 TOP OF PLATE GENERA TOP OF WALL LEVEL 1 FLOOR PLAN - TELECOM 11/04/13 GYPSUM WALL BOARD ALL DIMENSIONS ON 1/8", & 1/4" SCALE PLANS ARE TO THE FACE OF MASONRY, CONCRETE OR THE FACE OF GYPSUM BOARD. 11/04/13 ENLARGED PLAN AND ELEVATIONS - TELECON GYPSUM BOARD UNLESS NOTED OTHERWISE. ALL MASONRY DIMENSIONS ARE ACTUAL, UNLESS NOTED OTHERWISE UNLESS NOTED OTHERWISE VERIFY ALL DIMENSIONS, CONDITIONS, EXISTING CONSTRUCTION, AND GRADES AT THE JOB SITE. NOTIFY ARCHITECT IN WRITING URINAL VERTICAL VESTIBULE VERTICAL WALL COVERING OF ANY DISCREPANCIES OR CONFLICTS. HORSE POWER **NOVEMBER 4, 2013 HOLLOW METAL** HOIST WAY OPENING VERIFY SIZE, LOCATION, AND CHARACTERISTICS OF ALL WORK AND EQUIPMENT TO BE INSTALLED OR RELOCATED WHETHER HORIZONTAL FURNISHED BY OWNER OR BY CONTRACTOR(S) BEFORE ANY CONSTRUCTION PERTAINING TO SAME HAS BEGUN. INTERIOR DIAMETER WATER PROOF INSULATION WIDE FLANGE VERIFY AND COORDINATE THE SIZE AND LOCATION OF ALL THE OPENINGS FOR STRUCTURAL, MECHANICAL AND ELECTRICAL INTERIOR WITH WORK AND EQUIPMENT WITH ALL TRADES INVOLVED. WITHOUT ISSUE FOR PERMIT & PRICING LAMINATE / LAMINATED WOOD WELDED WIRE FABRIC CEILING HEIGHTS INDICATED ON THE ROOM FINISH SCHEDULE ARE TAKEN FROM THE FINISH FLOOR ELEVATION. VERIFY THE SIZE, LOCATION AND CHARACTERISTICS OF ALL MECHANICAL, ELECTRICAL, AND STRUCTURAL ITEMS BEFORE CEILING CONSTRUCTION IS BEGUN. COORDINATE WITH ALL TRADES TO MAINTAIN SCHEDULED CEILING HEIGHTS. DEMOLITION INFORMATION IS SHOWN THROUGHOUT THE DRAWINGS AND IS NOT LIMITED TO THE DEMOLITION DRAWINGS. COORDINATE VISUAL APPEARANCE OF ALL ELECTRICAL, MECHANICAL & PLUMBING WORK AT AREAS W/ EXPOSED **ARCHITECT MEP ENGINEERS TECHNOLOGY** MEDICAL EQUIPMENT CEILING/STRUCTURE. RUN ALL PIPES, CONDUITS, DUCTWORK, ETC., ORTHOGONAL WITH STRUCTURE W/ ALL TURNS & BENDS AT MAZZETTI JOHNSTON, LLC JOHNSTON, LLC **SMITH SECKMAN REID** VERIFY THAT REQUIRED OPERATION AND MAINTENANCE CLEARANCES ARE PROVIDED FOR ALL EQUIPMENT ITEMS. INSTALL ALL ITEMS IN ACCORDANCE W/ THE MANUFACTURER'S WRITTEN INSTRUCTIONS, EXCEPT THAT THE SPECIFICATIONS 2000 Bering Drive 2000 Bering Drive 3700 W. Sam Houston Pkwy. South **12727 Featherwood Drive** HEREIN, WHERE MORE STRINGENT, SHALL SUPERCEDE. NOTIFY THE ARCHITECT IN WRITING OF ANY CONFLICTS. Suite 850 **Suite 850** Suite 200 **Suite 285** PROVIDE BLOCKING FOR ALL WALL MOUNTED ITEMS OR EQUIPMENT FASTENING TO DRYWALL PARTITIONS. Houston, TX 77034 Houston, Texas 77057 Houston, Texas 77057 Houston, TX 77042 COORDINATE WITH OWNER'S COMMUNICATION AND SECURITY CONTRACTORS FOR THE INSTALLATION OF PHONES, COMPUTERS, AND SECURITY SYSTEMS. (713) 532-2466 (713) 784-8211 (281) 480-5563 (713) 532-2466 www.johnston-llc.com www.johnston-llc.com www.ssr-inc.com www.mazzetti.com DRAWING LEGEND NAME ROOM NAME / NUMBER 1557 1557 DOOR TYPE NUMBER N-101A-16 (X)---DOOR TYPE NUMBER A3 PARTITION TYPE PLAN NOTE x NUMBER INTERIOR BORROWED LITE MARK WINDOW MARK MEDICAL EQUIMENT TAG (REFER 1523 SIGNIFICANT EQUIPMENT (ASE)

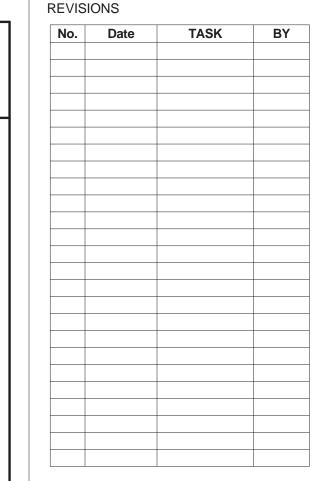

ISSUE FOR PERMIT &

HARRISHEALTH

Houston, Tx 77054

HARRIS HEALTH SYSTEM

2525 Holly Hall Street,

ARCHITECT & ENGINEERS




Firm Registration #:

SPRING BRANCH HEALTH CENTER

PROJECT LOCATION: 9801 Long Point, Houston, Tx 77055

SHEET TITLE: **INDEX**

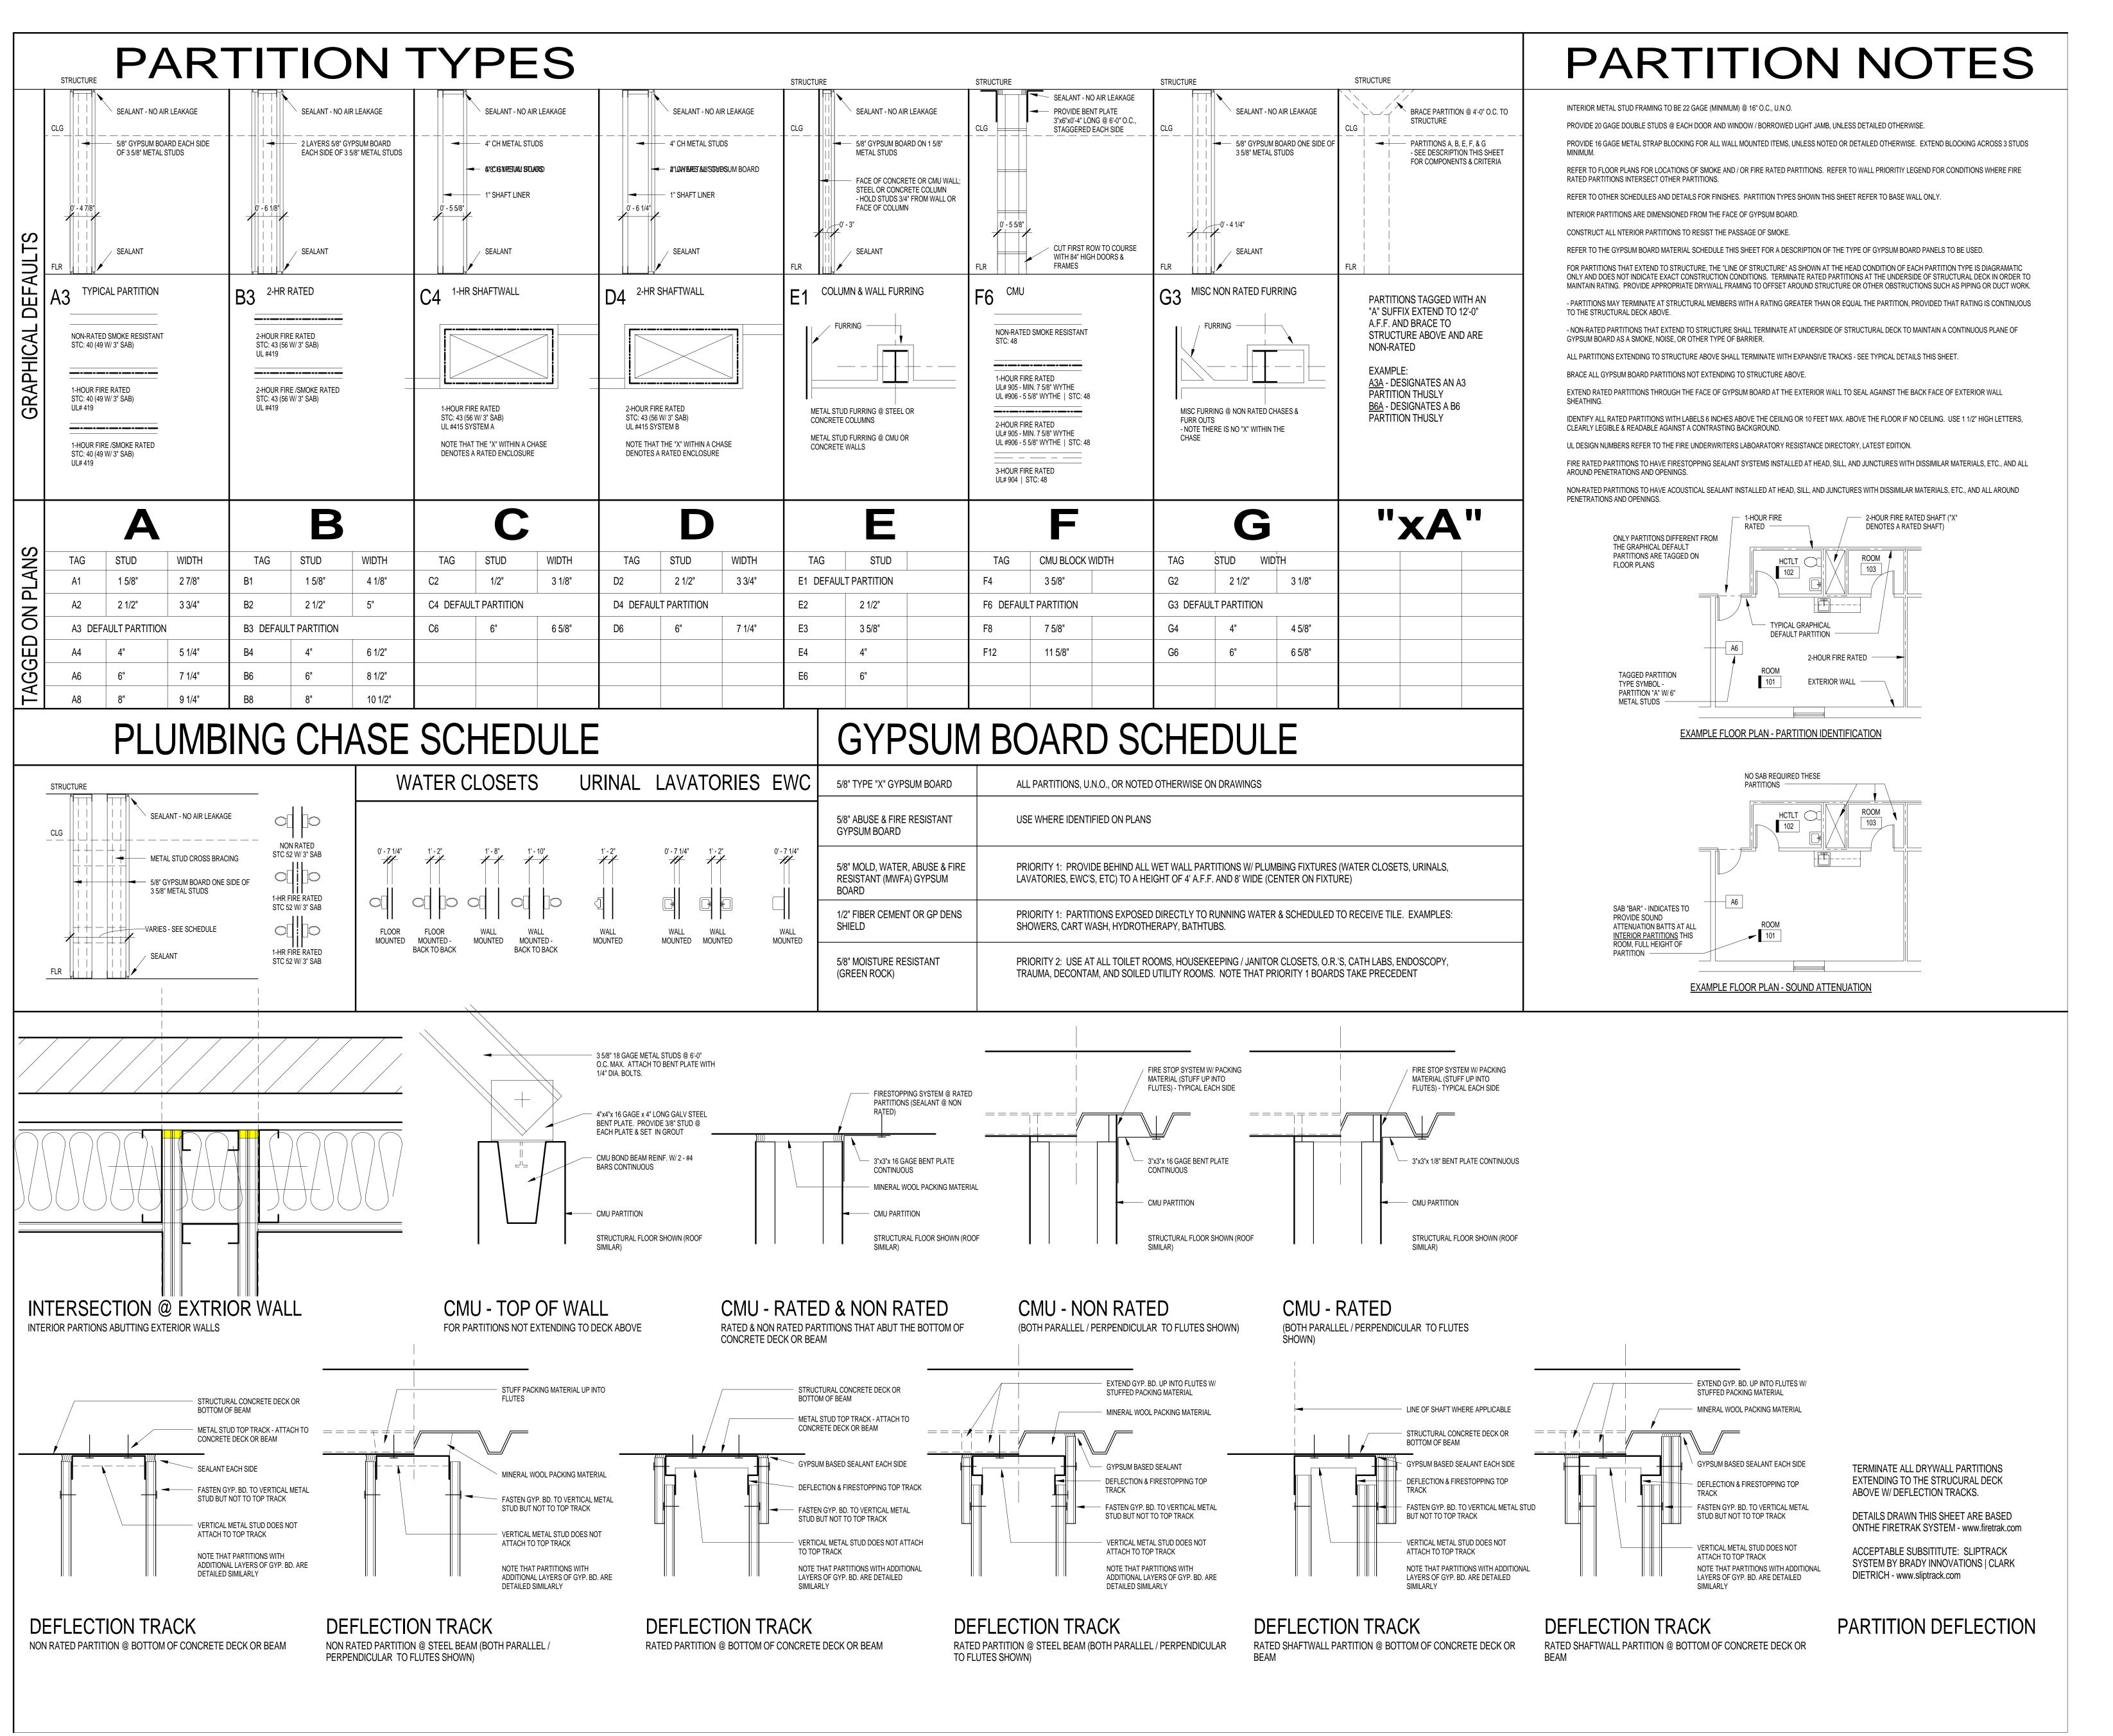

REVISIONS

ISSUE FOR PERMIT &



2525 Holly Hall Street, Houston, Tx 77054

HARRIS HEALTH SYSTEM

ARCHITECT & ENGINEERS:



MEP: Johnston, LLC <u>CIVIL:</u> Johnston, LLC

Firm Registration #: **SPRING BRANCH HEALTH CENTER**

PROJECT LOCATION: 9801 Long Point, Houston,

Tx 77055

PARTITION TYPES

11/04/13


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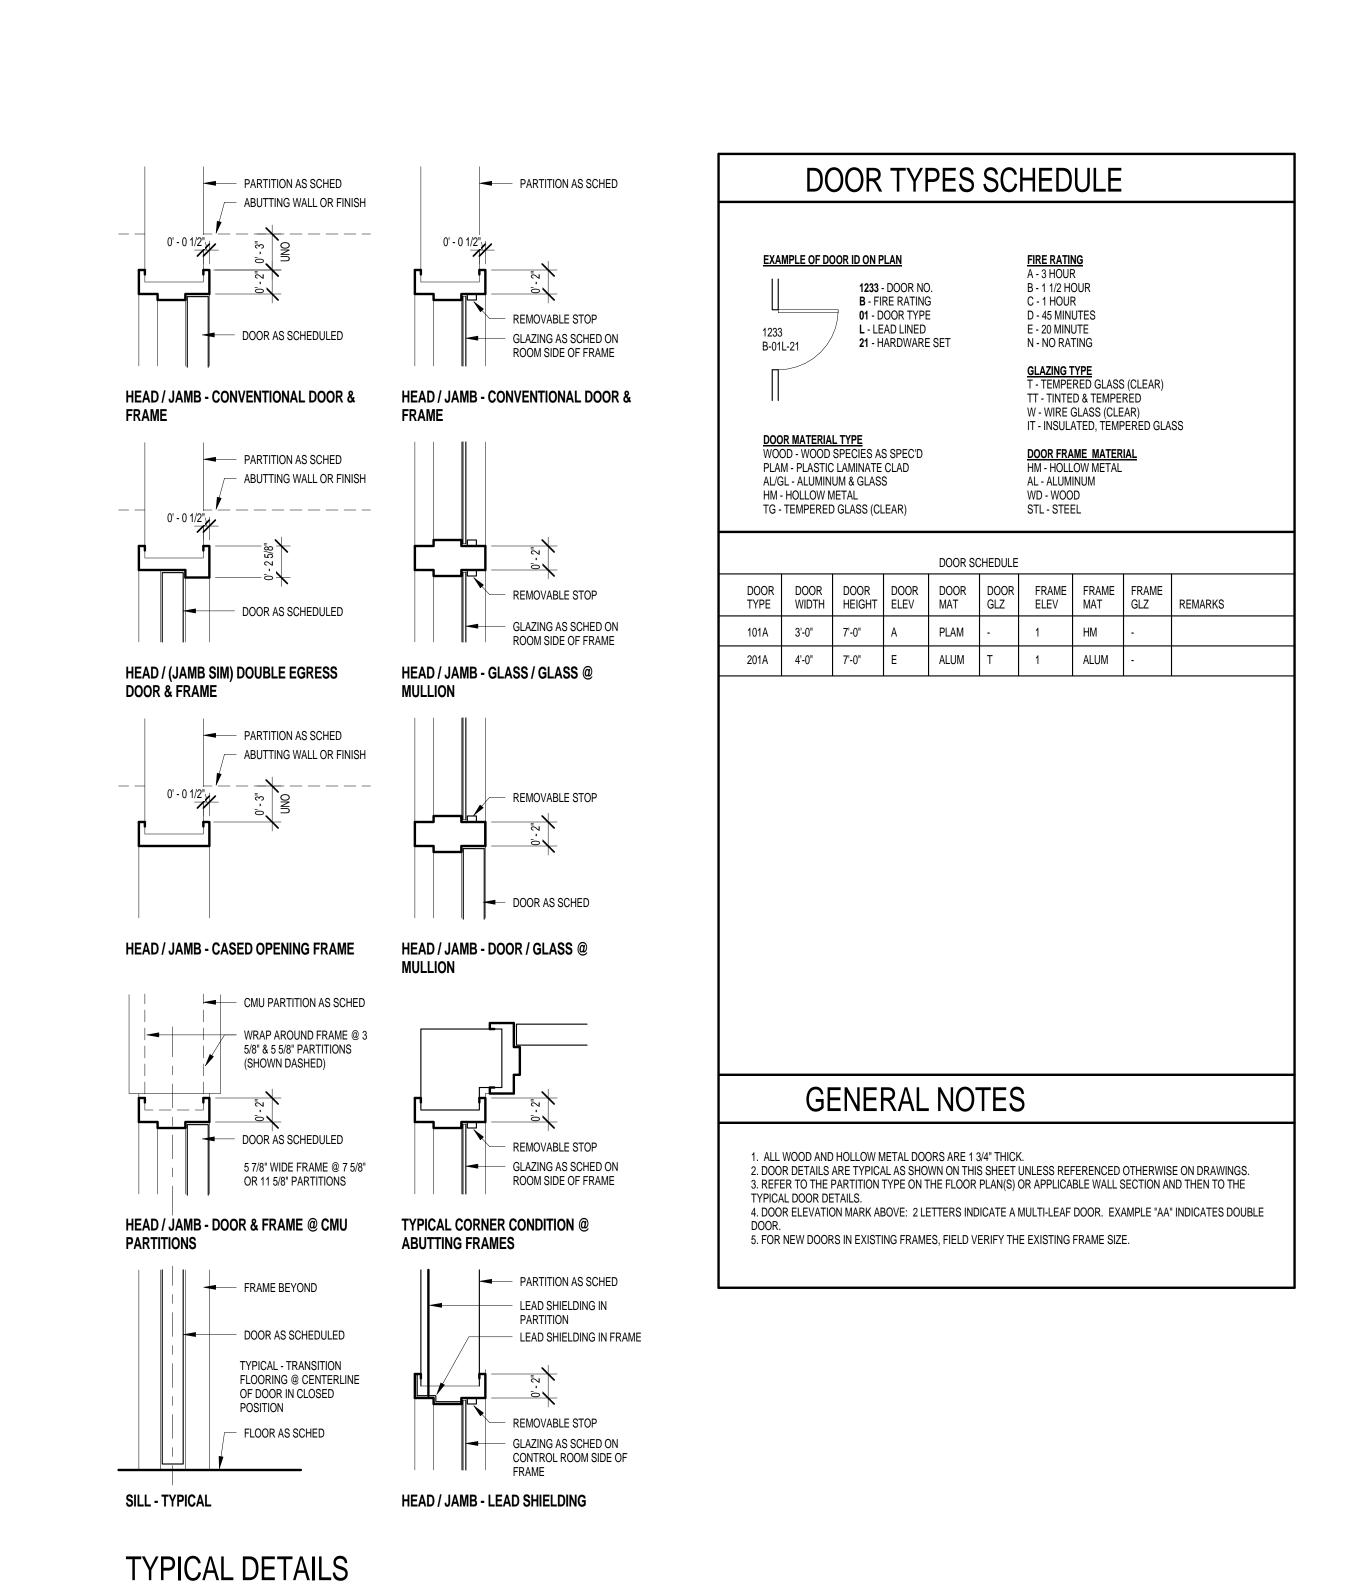
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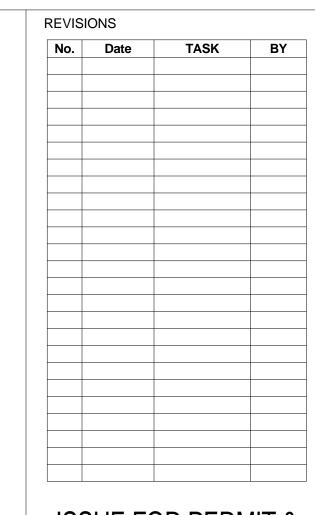
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HARRIS HEALTH SYSTEM

2525 Holly Hall Street, Houston, Tx 77054

ARCHITECT & ENGINEERS:



ARCHITECT:
Johnston, LLC

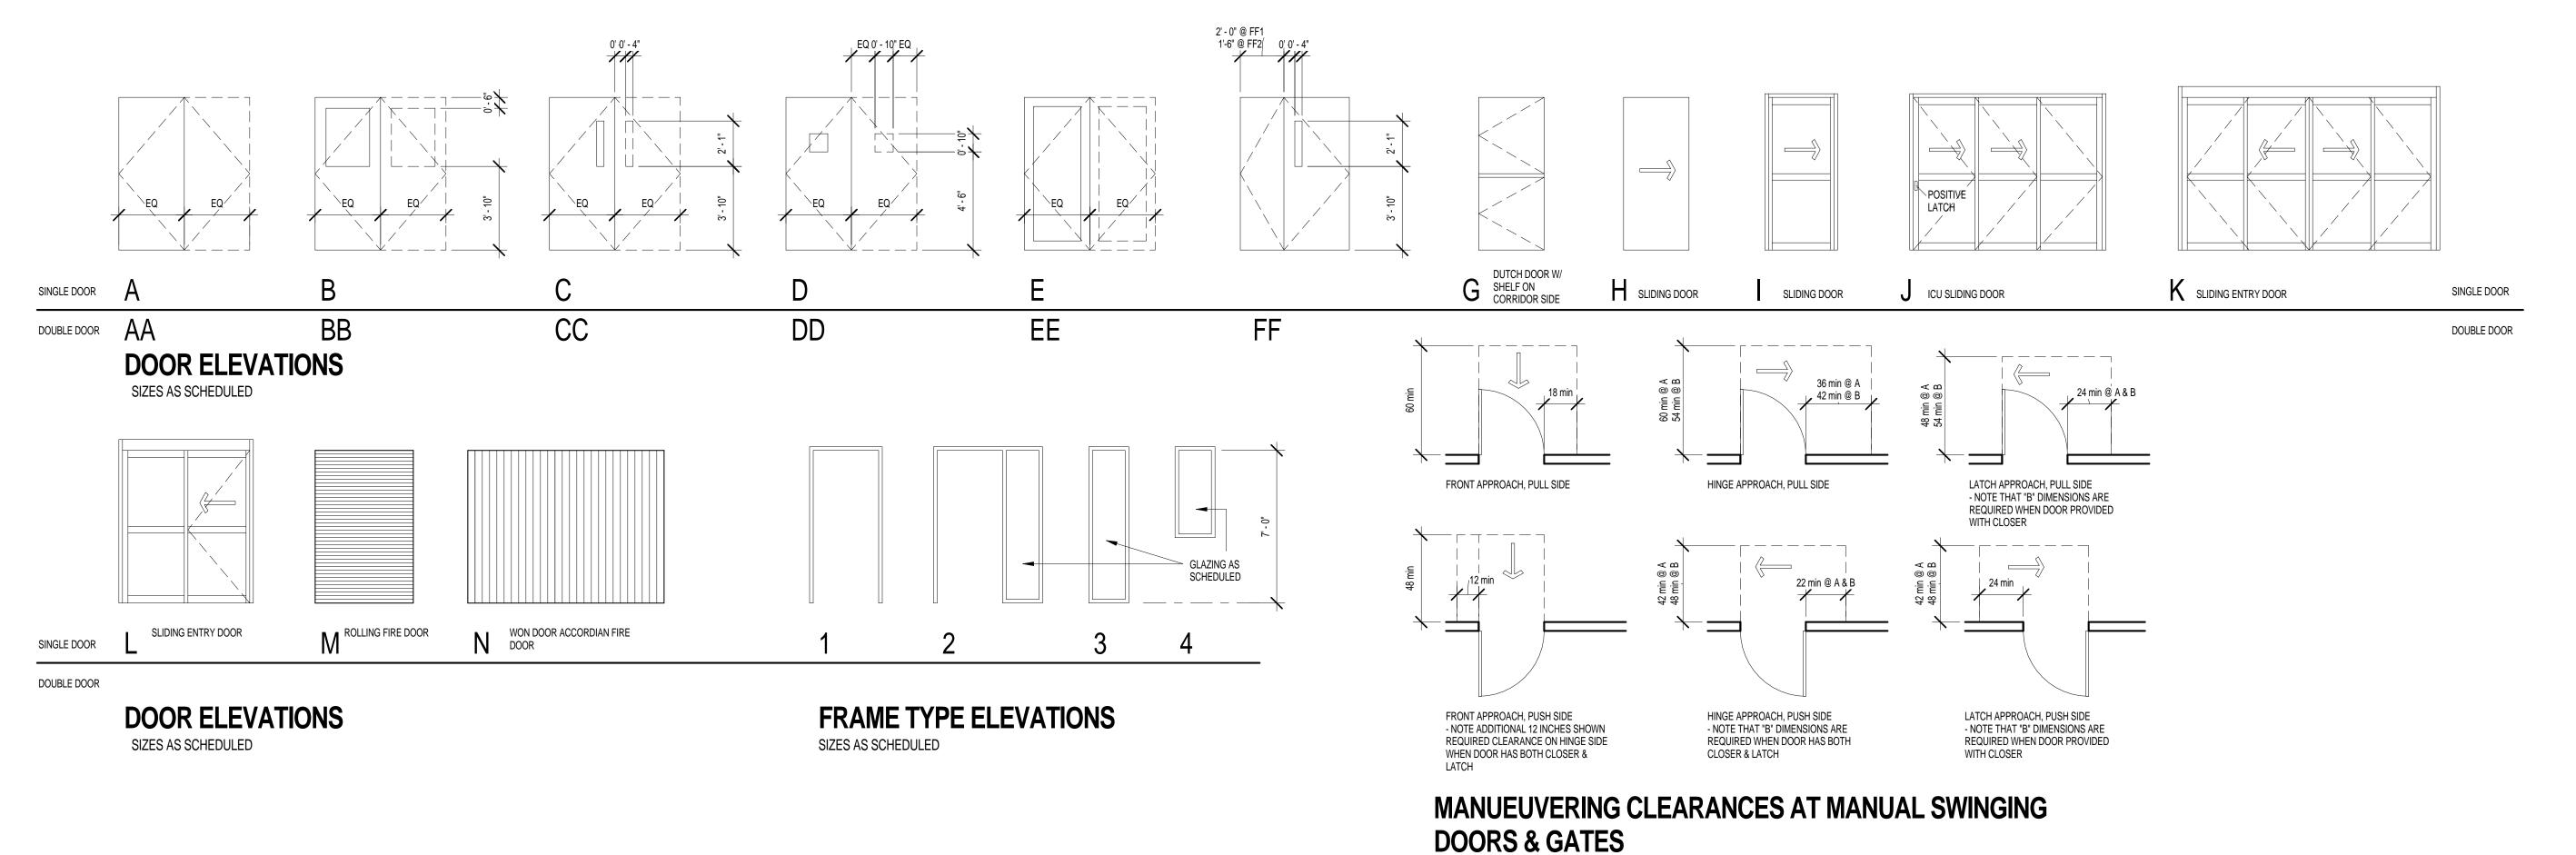MEP:
Johnston, LLC

CIVIL:
Johnston, LLC

Section 19928 Self

Firm Registration #:

PROJECT TITLE:

SPRING BRANCH
HEALTH CENTER

PROJECT LOCATION:
9801 Long Point, Houston,
Tx 77055

SHEET TITLE:
DOOR TYPES

11/04/13

SHEET NUMBER:


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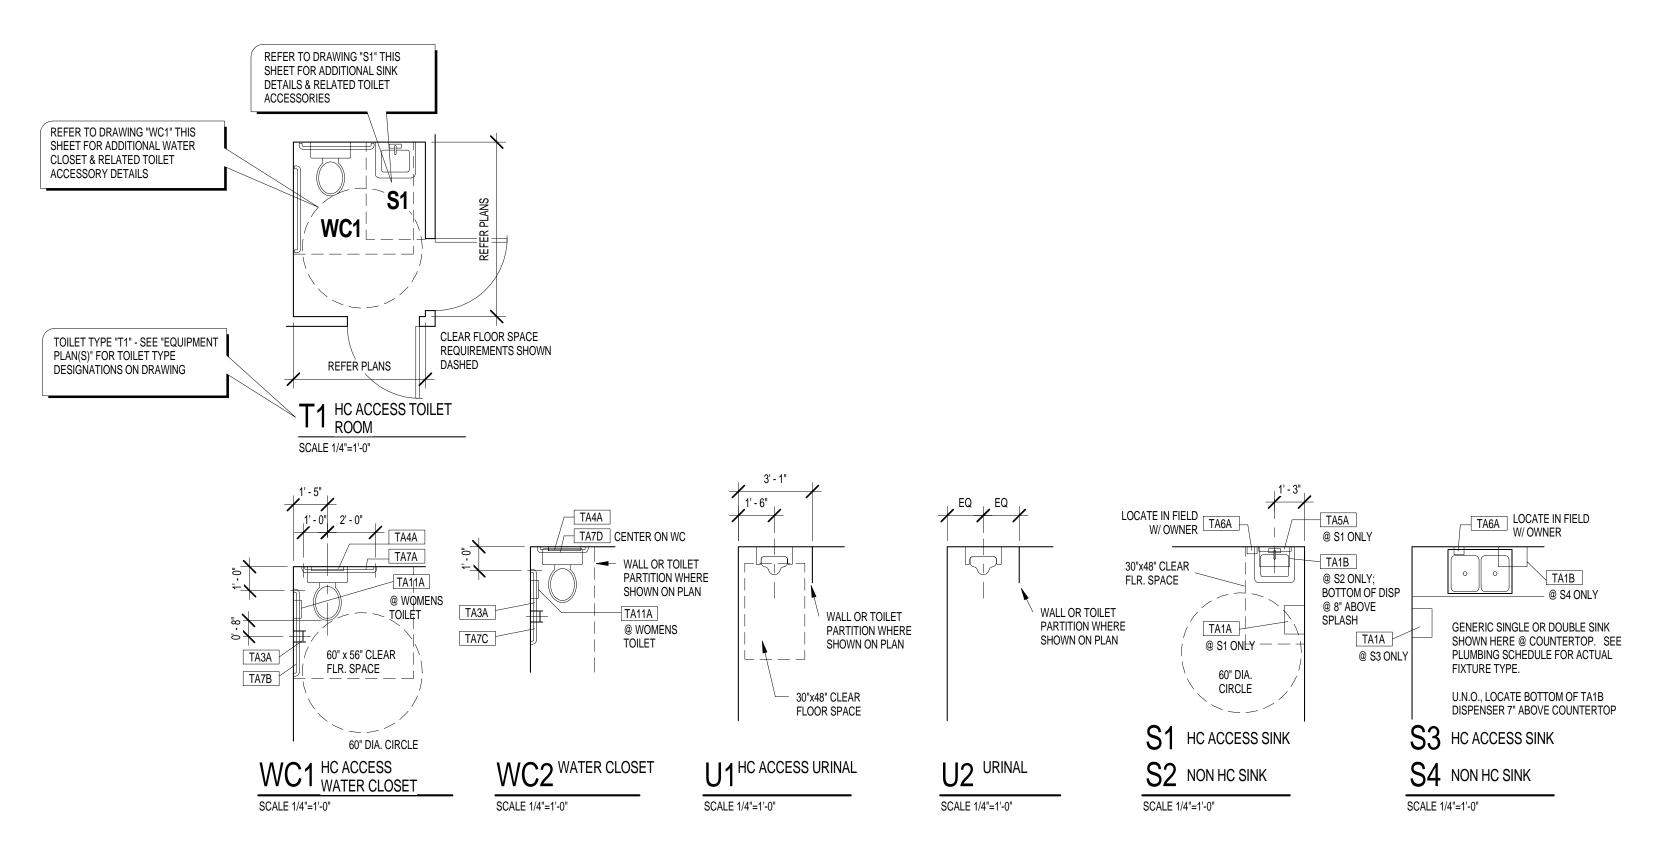
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Author As indicated

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Checker






	TOWEL DISPENSER & WASTE RECEPTACLES			
TA1A	ENMOTION S.S., RECESSED UNIT & TOWEL DISPENSER	GP	59491 & 59466	OWNER FURNISHED, CONTRACTOR INSTALLED
TA1B	ENMOTION TOWEL DISPENSER	GP	59462	·
	TOU ET DADED TICCUE DICDENICED			
TA3A	TOILET PAPER TISSUE DISPENSER JUMBO BATH TISSUE DISPENSER	GP	E0200	CIAINED FURNISHED CONTRACTOR INSTALLED
IASA	JUMBO BATH 1155UE DISPENSER	GP	59209	OWNER FURNISHED, CONTRACTOR INSTALLED
	TOILET SEAT COVER DISPENSER			
TA4A	TOILET SEAT COVER DISPENSER, WHITE	GRAINGER	2VEX8	OWNER FURNISHED, CONTRACTOR INSTALLED
	MIRRORS			
TA5A	24 x 36 CHANNEL FRAMED	BOBRICK	B-165	
TA5B	UNFRAMED	SEE SPECS		SIZES INDICATED ON PLANS
	SOAP DISPENSERS			
TA6A	SOAP DISPENSER	ECOLAB	EC-BFD-DISP	OWNER FURNISHED, CONTRACTOR INSTALLED
TA6B	LAVATORY MOUNTED SOAP DISPENSER	NOT	USED	
	GRAB BARS			
TA7A	36" LONG	BOBRICK	B-6806	1 1/2" DIA. W/ #256 SERIES MTG. PLATES
TA7B	42" LONG	BOBRICK	B-6806	1 1/2" DIA. W/ #256 SERIES MTG. PLATES
TA7C	24" LONG	BOBRICK	B-6806	1 1/2" DIA. W/ #256 SERIES MTG. PLATES
TA7D	30" LONG	BOBRICK	B-6806	1 1/2" DIA. W/ #256 SERIES MTG. PLATES
	SANITARY NAPKIN DISPOSAL			
TA11A	RECESSED - IN WALL	BOBRICK	B-4353	
TA11B	RECESSED - TOILET PARTITION MOUNTED	BOBRICK	B-4354	
	LICOVE DODE TOWEL 9 IV			
TA 40A	HOOKS - ROBE, TOWEL, & IV	DODDIOK	D 70747	
TA12A	ROBE HOOK	BOBRICK	B-76717	
TA12B	TOWEL HOOK	NOT	USED	
TA12C	HOOK x TOILET PARTITION MANUFACTURER			
	BABY CHANGING STATION			
TA16A	HORIZONTAL STATION, WALL MOUNTED	KOALA	HORIZ	MODEL KB110-SSWM

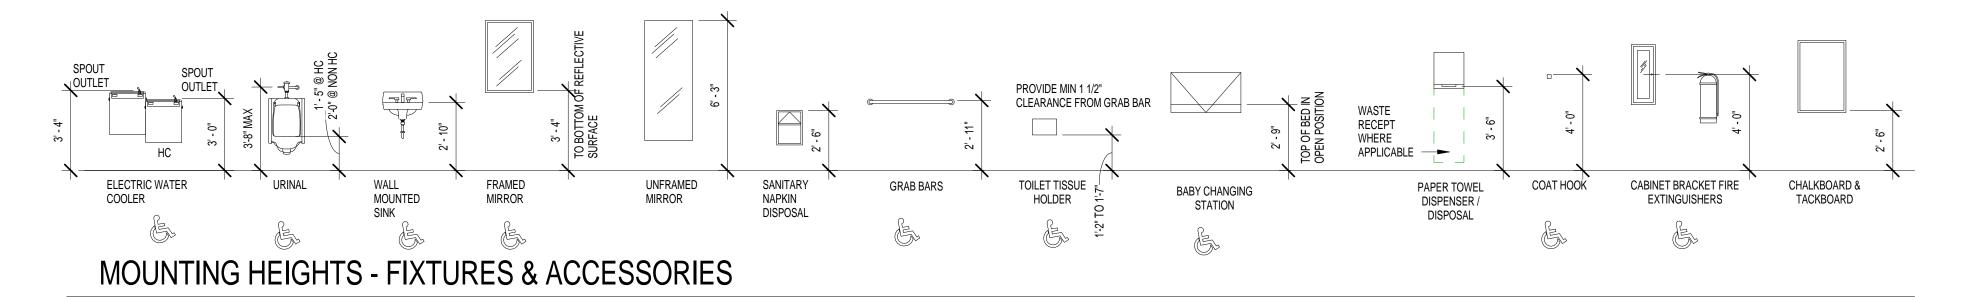TOILET ROOM & ACCESSORY NOTES

- 1. ENLARGED PLANS INDICATE TYPICAL DIMENSIONS, LOCATIONS FOR ACCESSORIES, AND SPECIALTIES, AND REQUIRED CLEARANCES TO BE MAINTAINED.
- 2. INDIVIDUAL TOILET ROOM AND SINK "TYPES" ARE KEYED ONTO THE FLOOR PLANS.
- REFER TO FLOOR PLAN SHEETS FOR TOILET ROOM AND / OR FIXTURE ORIENTATION, DOOR LOCATION(S), WALL CONSTRUCTIONA DN ADDITIONAL EQUIPMENT ITEMS.
 DIMENSIONS INDICATED ARE TYPICAL, U.N.O. DIMENSIONED ON FLOOR PLAN SHEETS OR INTERIOR ELEVATIONS.
- 5. DIMENSIONS SHOWN FOR WALLS AND OPENINGS ARE FROM FACE OF GYPSUM BOARD.
- 6. DIMENSIONS SHOWN FOR ACCESSORIES AND EQUIPMENT ITEMS AND CLEAR FLOOR SPACE ARE FROM FACE OF ROOM FINISH (SUCH AS TILE).
- 7. NOTE THAT DOORS CANNOT INFRINGE OR SWING UPON OR INTO THE REQUIRED "CLEAR FLOOR SPACE" AREAS SO NOTED & DASHED ON ENLARGED PLANS.
- 8. GENERIC PLUMBING FIXTURES ARE SHOWN HERE SEE PLUMBING DRAWINGS FOR SCHEDULED FIXTURES.

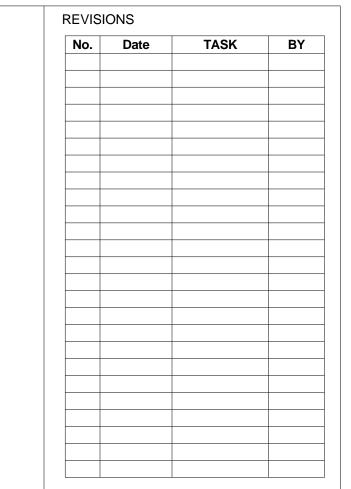

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HARRIS HEALTH SYSTEM

2525 Holly Hall Street, Houston, Tx 77054

ARCHITECT & ENGINEERS:



ARCHITECT:
Johnston, LLC
MEP:
Johnston, LLC
CIVIL:
Johnston, LLC



Firm Registration #:

PROJECT TITLE:

SPRING BRANCH
HEALTH CENTER

PROJECT LOCATION:
9801 Long Point, Houston,
Tx 77055

SHEET TITLE:
TOILET TYPES

DATE: 11/04/13

SHEET NUMBER:

N BY: SC or KED BY: JC

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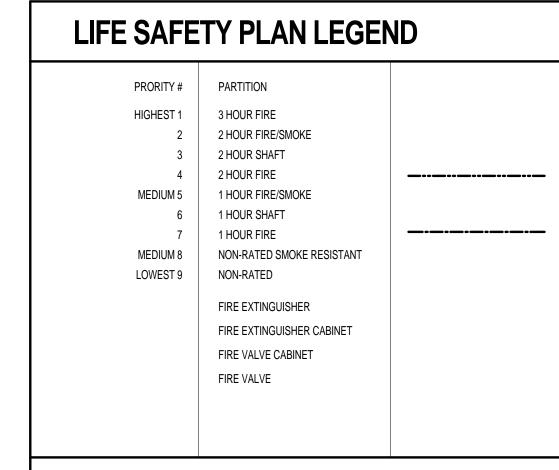
GENERAL DESCRIPTION A. PROJECT NAME: SPRING BRANCH HEALTH CENTER B. PROJECT LOCATION: 9801 LONG POINT, HOUSTON, TX APPLICABLE CODES: 2006 INTERNATIONAL BUILDING CODE: CITY OF HOUSTON REQUIREMENT 2006 INTERNATIONAL FIRE CODE: CITY OF HOUSTON REQUIREMENT 2006 UNIFORM MECHANICAL CODE: CITY OF HOUSTON REQUIREMENT 2006 UNIFORM PLUMBING CODE: CITY OF HOUSTON REQUIREMENT 2011 NATIONAL ELECTRICAL CODE: CITY OF HOUSTON REQUIREMENT CONSTRUCTION TYPE: 2006 INTERNATIONAL BUILDING CODE: TYPE III-B ASSUMED (NONCOMBUSTIBLE, UNPROTECTED) BUILDING OCCUPANCY: 2006 INTERNATIONAL BUILDING CODE: "B" BUSINESS

EXIT WIDTH PROVIDED

l			
ĺ	EXIT NUMBER	DOOR WIDTHS	CLEAR WIDTHS
ĺ	1.1	72"	68"
I	1.2	48"	44"
I	TOTAL	120"	112"
I			
I	TOTAL WIDTH OF REQUIRED EXIT		
ĺ	-LEVEL 1 PROJECT SPACE	16.6" (47 X .2) / 78" PROVIDED	TABLE 1005.1


CODE ANALYSIS


ITEM	REQUIREMENTS/ PROVIDED	REF. SECTION
OCCUPANCY CLASSIFICATION	GROUP B BUSINESS	304
CONSTRUCTION TYPE	TYPE III-B / TYPE III-B	602.3 / TABLE 601
ALLOWABLE AREA PER FLOOR	19,000 SF / 8,279 PROJECT RELATED SPACE OF 12,435 SF ON LEVEL 1	TABLE 503
MAXIMUM FLOORS	4 FLOORS / 1 FLOORS	TABLE 503
MAXIMUM HEIGHT	55' / EXISTING CONSTRUCTION	TABLE 503
STRUCTURAL FRAME		
-COLUMNS (SUPPORTING FLOORS)	0 HR / EXISTING CONSTRUCTION	TABLE 601
-FLOOR/CEILING	0 HR / EXISTING CONSTRUCTION	TABLE 601
-ROOF/CEILING	0 HR / EXISTING CONSTRUCTION	TABLE 601
SHAFT ENCLOSURE	1 HR / 1 HR	707.4
WALLS		
-EXTERIOR BEARING	2 HR/ EXISTING CONSTRUCTION	TABLE 601
-EXTERIOR NON-BEARING	0 HR (GREATER THAN 30') / EXISTING CONSTRUCTION	TABLE 602
-INTERIOR BEARING	0 HR / EXISTING CONSTRUCTION	TABLE 601
-INTERIOR NON-BEARING	0 HR, NONCOMBUSTIBLE / 0 HR NONCOMBUSTIBLE	TABLE 601
CORRIDORS	1 HR / 1 HR	TABLE 1017.1
FIRE PROTECTION SYSTEM		
-AUTOMATIC SPRINKLER SYSTEM	NOT REQUIRED FOR GROUP B / NOT SPRINKLERED	903
-PORTABLE FIRE EXTINGUISHERS	ABC TYPE; 2-A MIN; 75' MAX. TRAVEL	TABLE 906.3, NFPA 10
-FIRE ALARM SYSTEM	YES / YES	907
OCCUPANCY LOAD		
-LEVEL 1 PROJECT SPACE	100 SF/PERSON = 83 (8,279 / 100)	TABLE 1004.1.1
MINIMUM NO. EXITS/FLOOR		
-LEVEL 1	2 REQUIRED / 2 PROVIDED	TABLE 1019.1
EXIT ACCESS TRAVEL DISTANCE	200' MAX / <150'	TABLE 1016.1



LIFE SAFETY PLAN GENERAL NOTES

- A. THE LIFE SAFETY PLANS ARE FOR REFERNCE ONLY AND DO NOT INDICATE PROJECT
- LIFE SAFETY PLANS INDICATE ASSUMED CONFORMANCE OF EXISTING CONSTRUCTION TO APPLICABLE CODE AND / OR GOVERNING CODE AGENCIES REQUIREMENTS BASED ON OWNER FURNISHED INFORMATION. LIFE SAFETY PLANS ARE PROVIDED TO SHOW INTEGRATION OF NEW WORK WITH EXISTING
- CONSTRUCTION AS PART OF A COMPREHENSIVE FIRE / SMOKE BARRIER SYSTEM. LIFE SAFETY PLANS SHALL NOT BE CONSTRUED TO MEAN VERIFICATION OF FIRE / SMOKE RATINGS OF EXISTING CONSTRUCTION. WHERE NEW AND REMODELED CONSTRUCTION OCCURS, AS INDICATED IN THE DRAWINGS, PARTITION FIRE & SMOKE RATINGS MEET APLICABLE CODE REQUIRMENTS FOR NEW CONSTRUCTION.

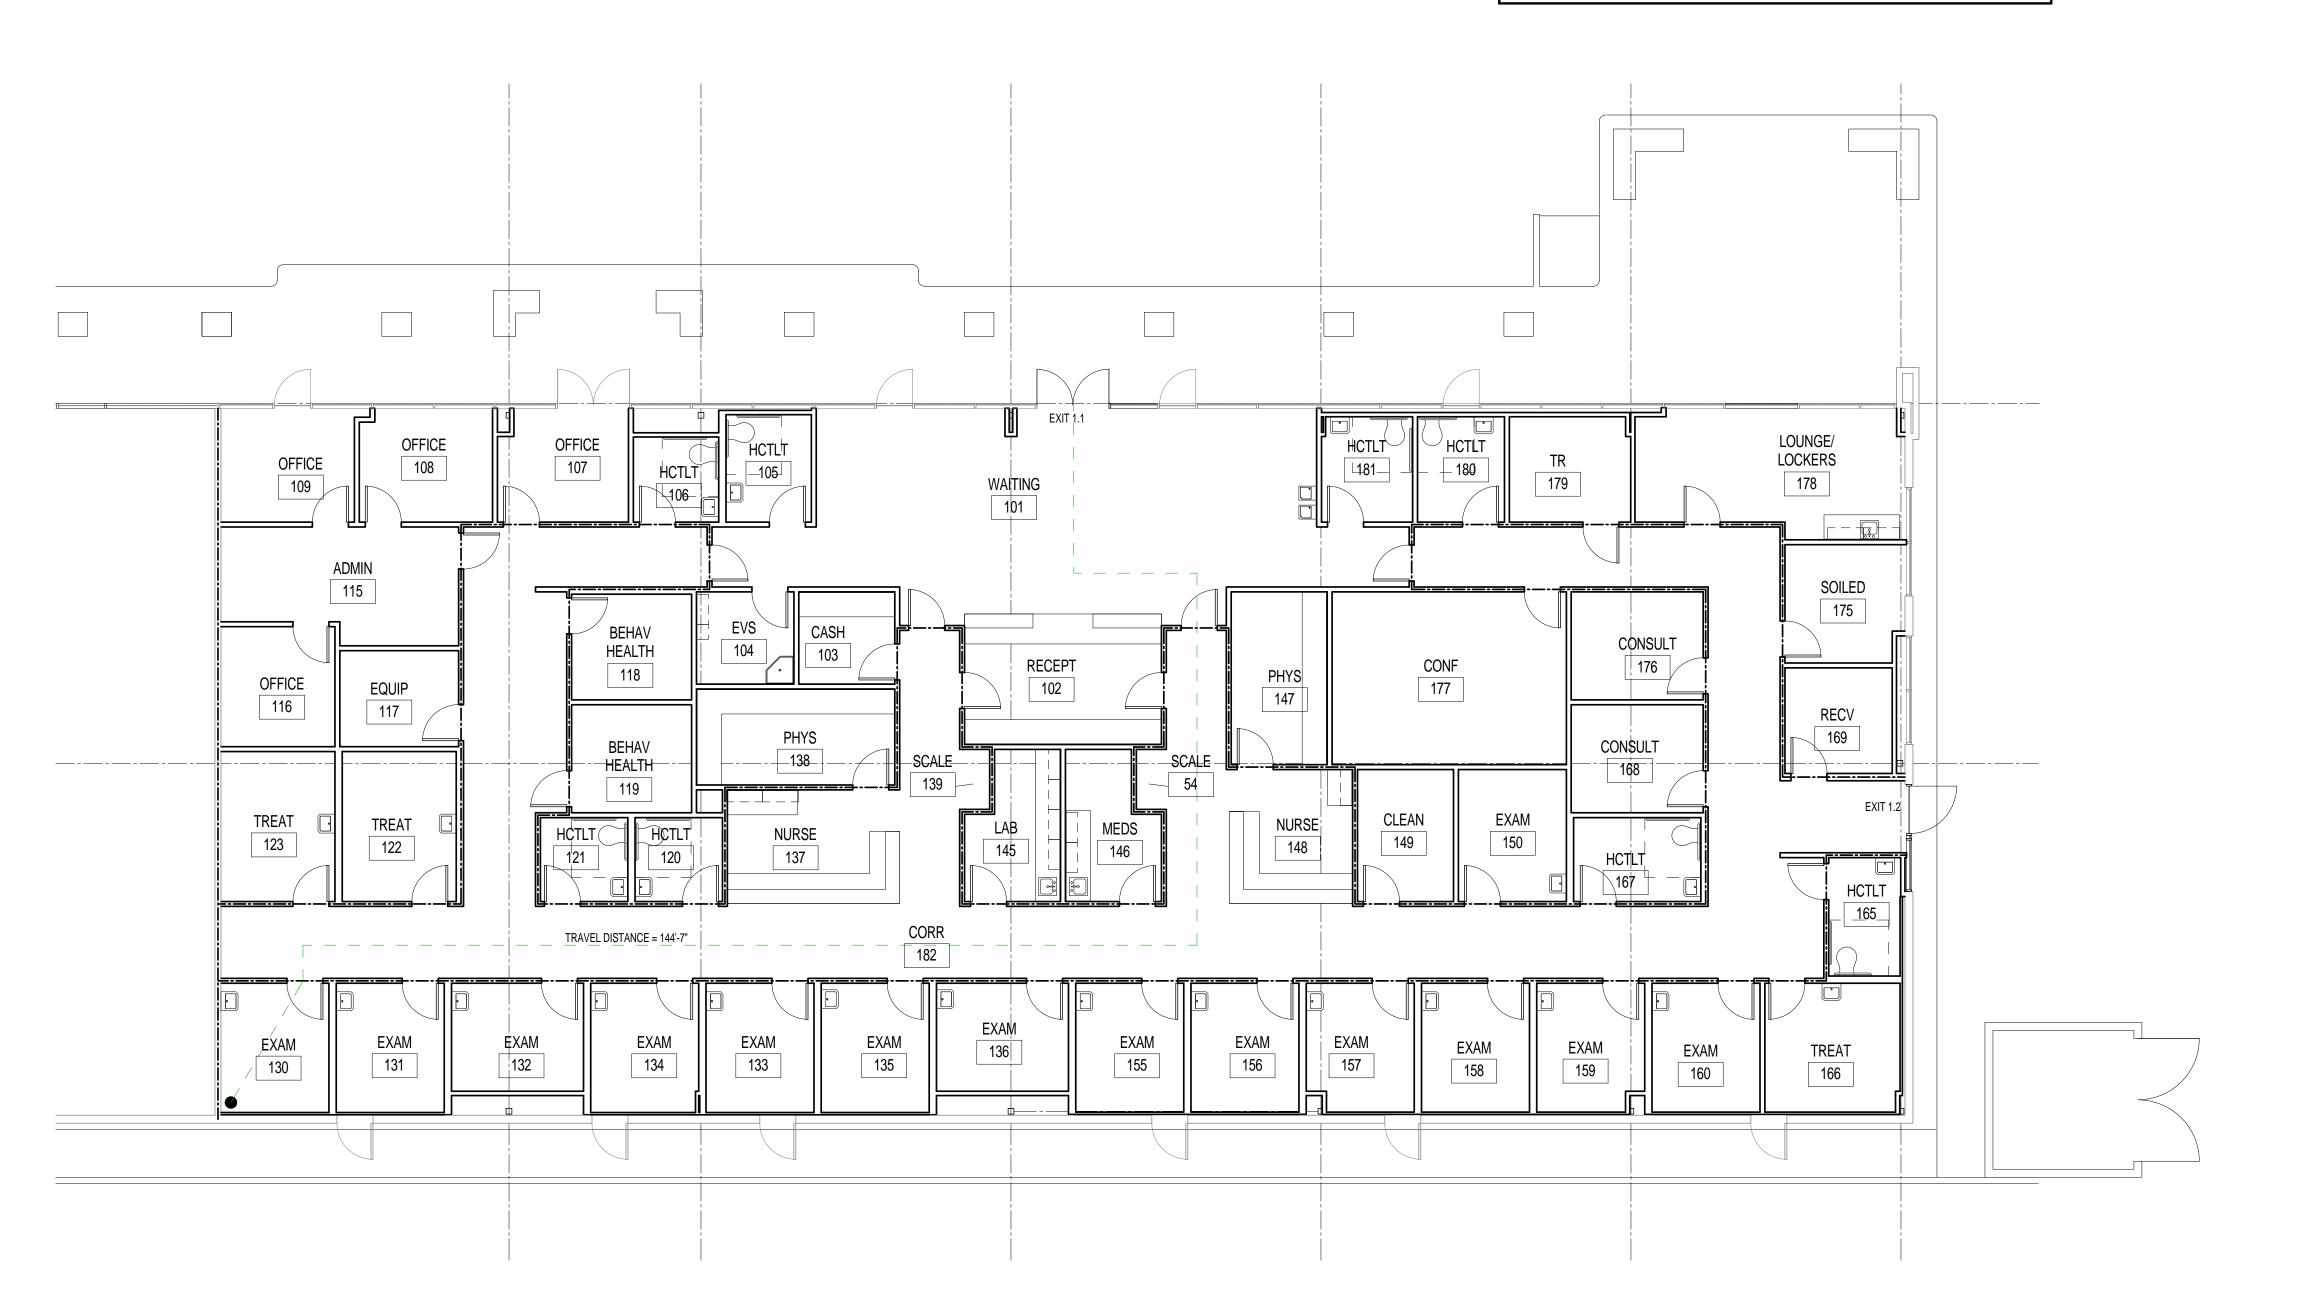

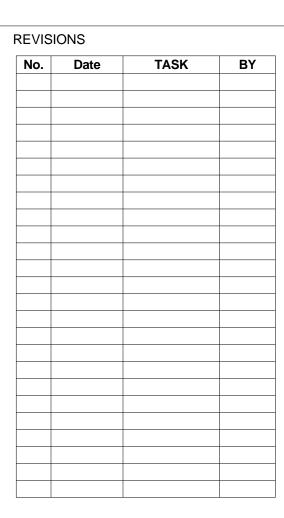

ISSUE FOR PERMIT & **PRICING**



HARRIS HEALTH SYSTEM 2525 Holly Hall Street, Houston, Tx 77054

ARCHITECT & ENGINEERS:



MEP: Johnston, LLC CIVIL: Johnston, LLC



Firm Registration #: PROJECT TITLE: SPRING BRANCH

HEALTH CENTER

PROJECT LOCATION: 9801 Long Point, Houston, Tx 77055

SHEET TITLE: LEVEL 1 LIFE SAFETY PLAN

11/04/13


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SCALE:

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2525 Holly Hall Street, Houston, Tx 77054

2000 BERING DRIVE


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11/04/13

SCALE:

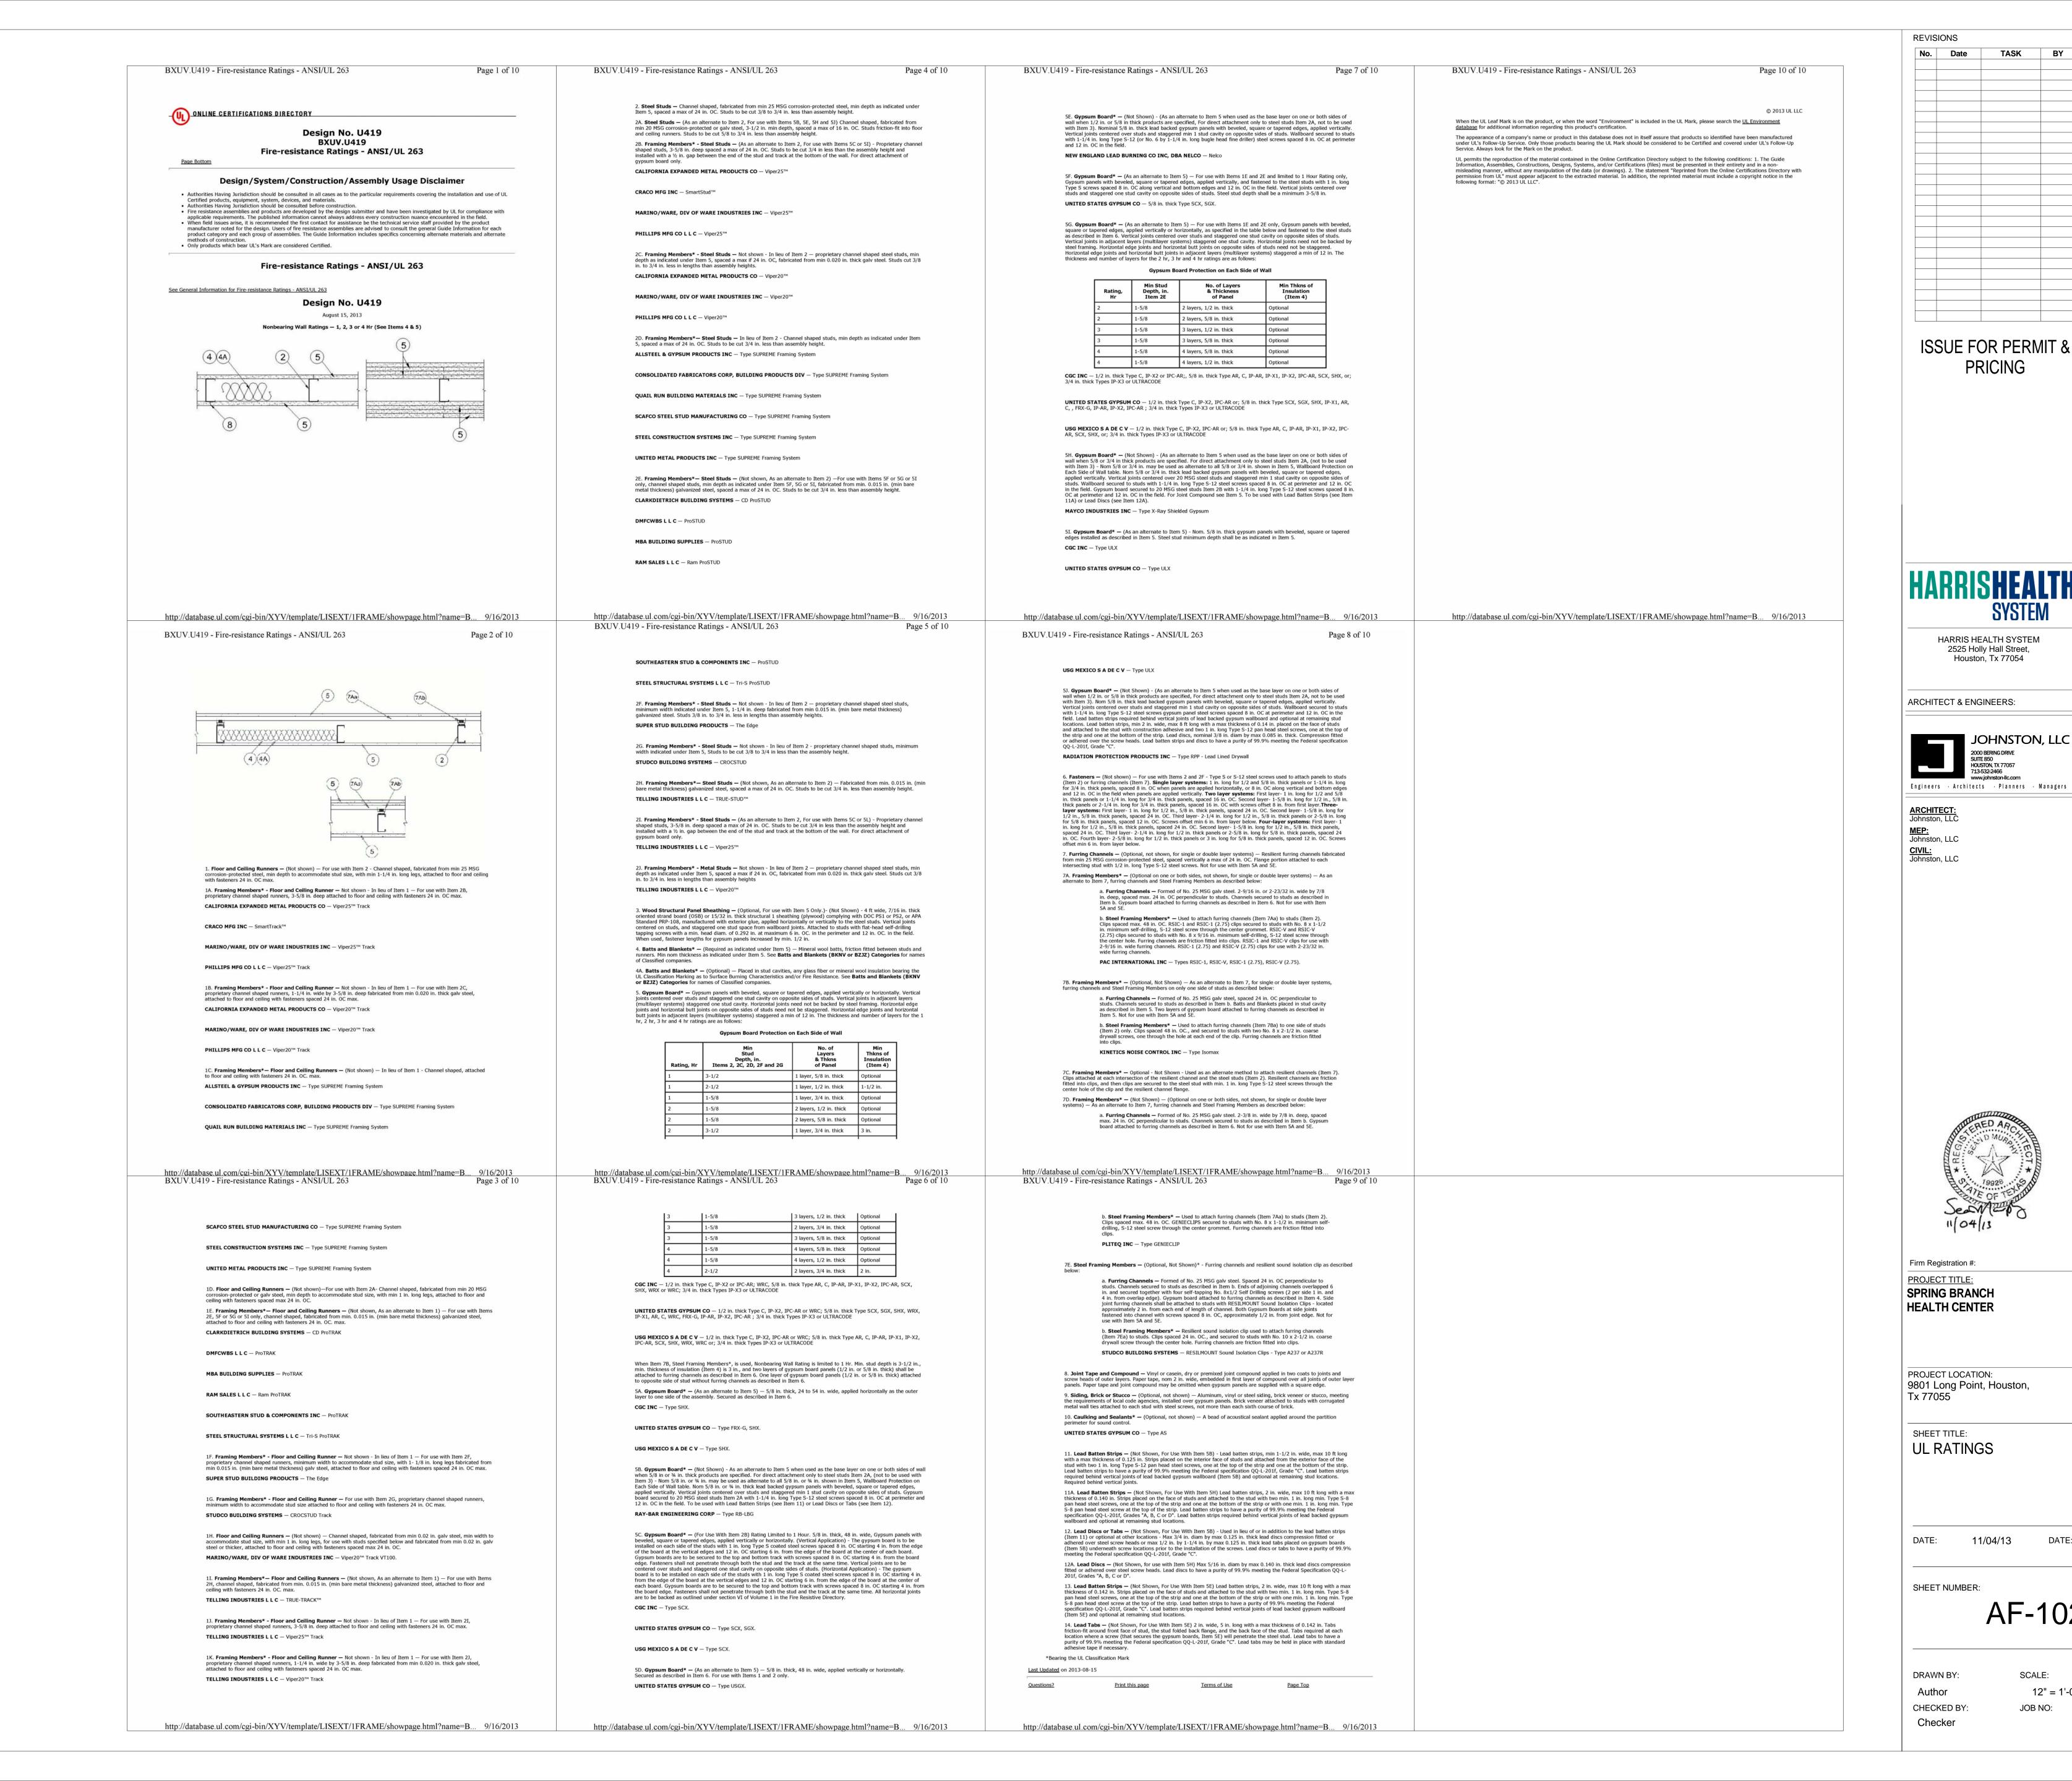JOB NO:


12" = 1'-0"

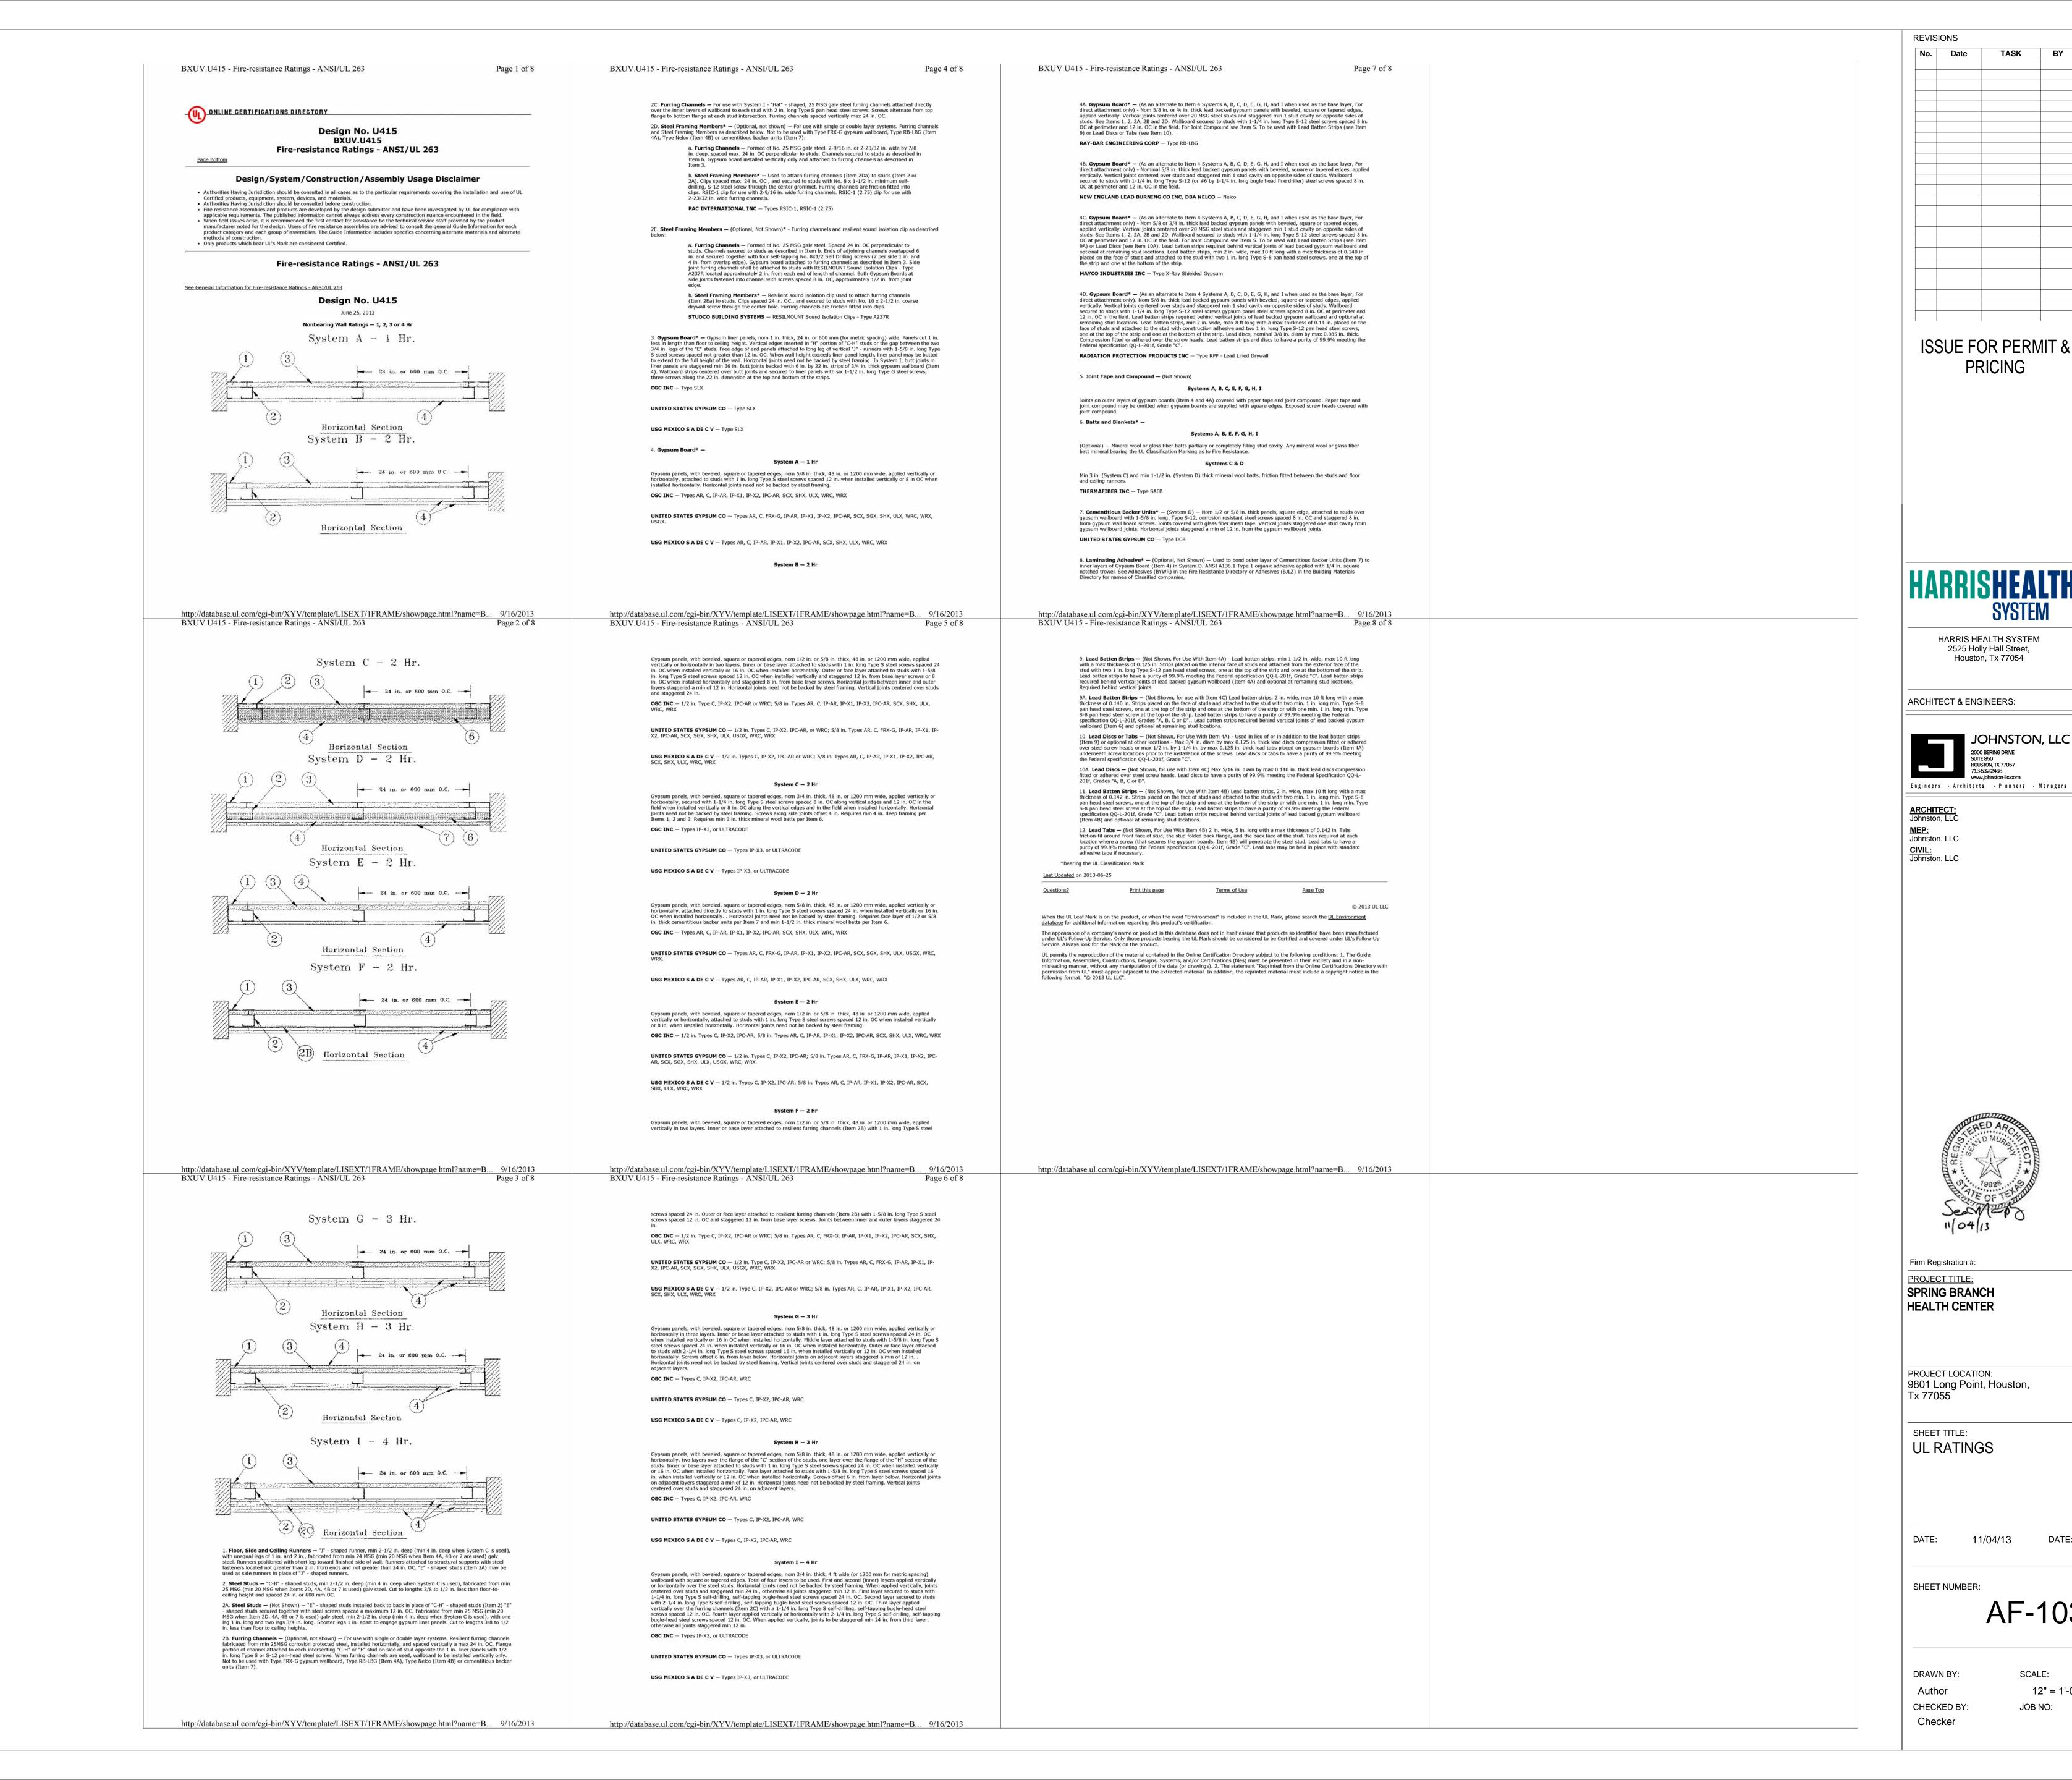


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JOB NO:

12" = 1'-0"

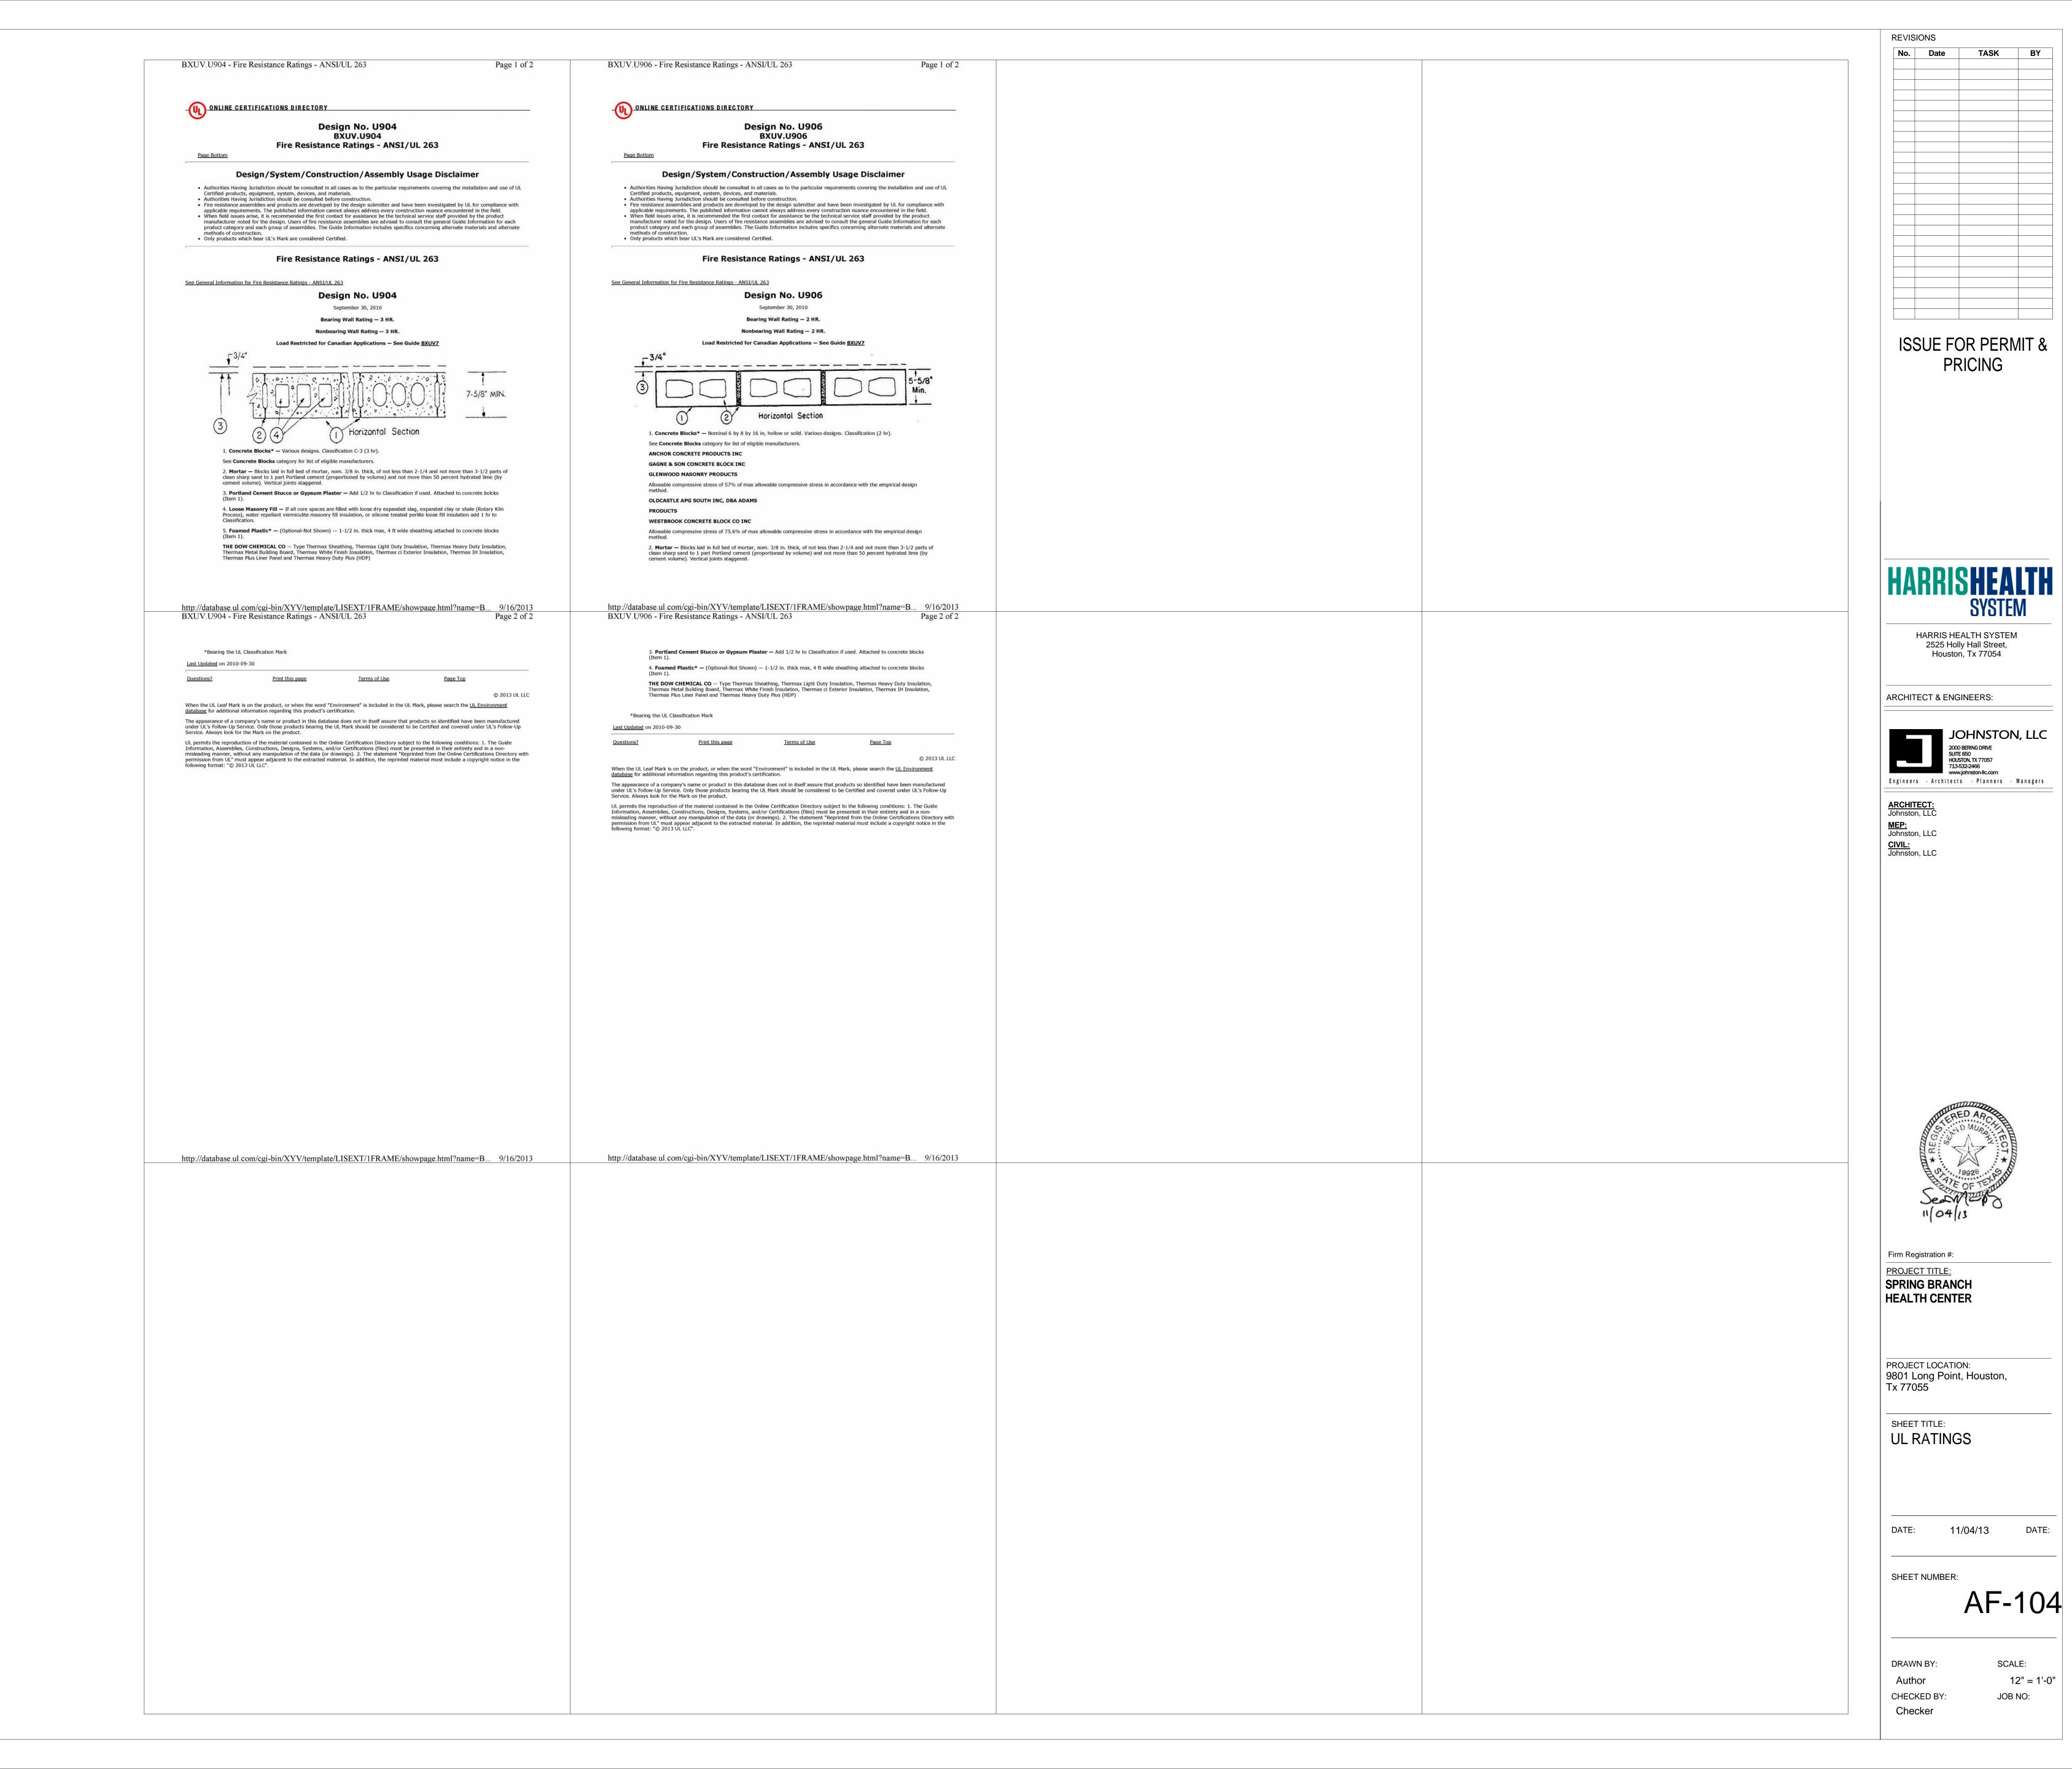

DEMOLITION PLAN GENERAL NOTES SHADED AREAS DENOTE GENERAL LIMITS OF CONSTRUCTION. EXISTING CONSTRUCTION TO BE REMOVED SHOWN DASHED. COORDINATE MEP DEMOLITION WITH DRAWINGS & REQUIREMENTS FOR NEW WORK. NOT ALL NUMBERED NOTES NECESSARILY APPLY TO THIS SHEET. COORDINATE OWNER WALK THRU TO IDENTIFY ALL ITEMS TO BE SALVAGED FOR THE OWNER'S RE-USE, INCLUDING BUT NOT LIMITED TO MEDICAL EQUIPMENT, FRAMED DOCUMENTS, SIGNS / GRAPHIC ART, ETC. REMOVE ITEMS THUSLY IDENTIFIED AND GIVE TO OWNER OR STORE FOR RE-USE AT THIER DIRECTION. **DEMOLITION PLAN NOTES BY NUMBER** REMOVE EXISTING STOREFRONT FRAMING & MODIFY AS REQUIRED FOR NEW DOOR REMOVE EXISTING DOUBLE DOORS FOR REINSTALLATION THS PROJECT 1/8" = 1'-0"

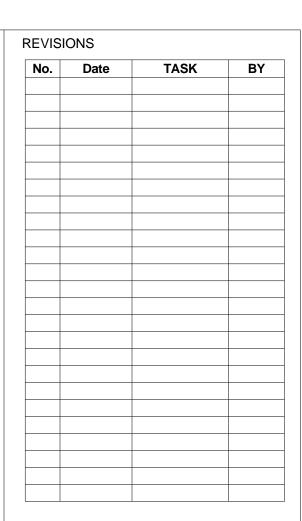

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ARCHITECT & ENGINEERS:



ARCHITECT:
Johnston, LLC
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PROJECT TITLE:
SPRING BRANCH

HEALTH CENTER

PROJECT LOCATION:
9801 Long Point, Houston,
Tx 77055

SHEET TITLE:

LEVEL 1 DEMOLITION
PLAN

TE: 11/04/13


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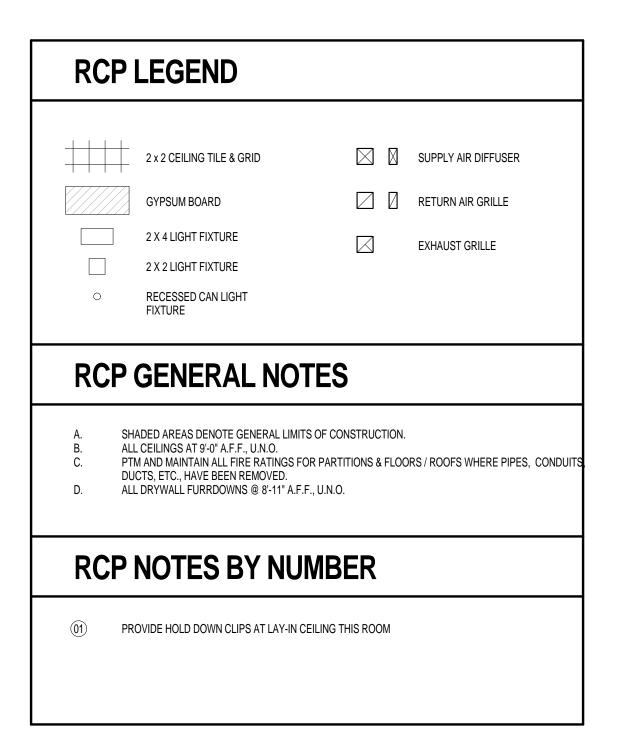
AD-101


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A-101

SCALE:

JOB NO:

As indicated
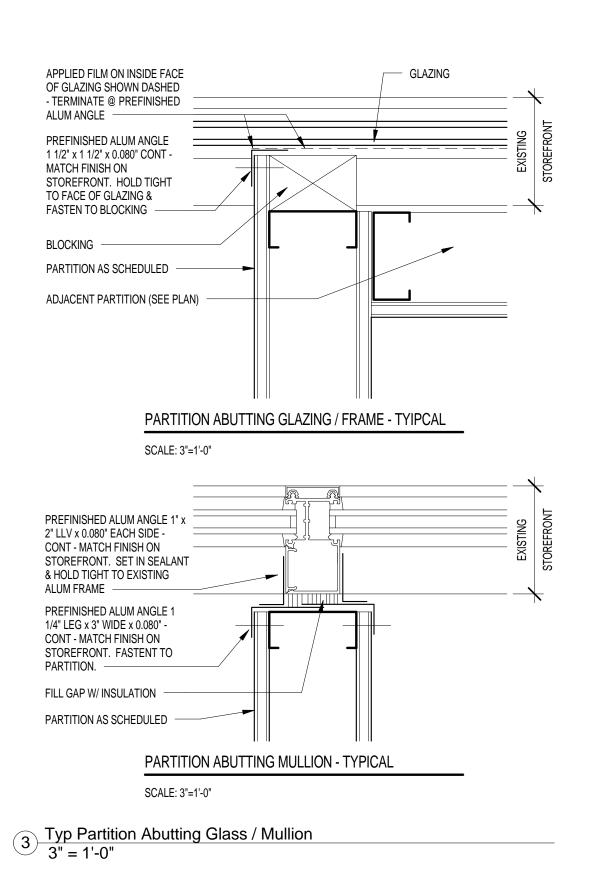
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Author
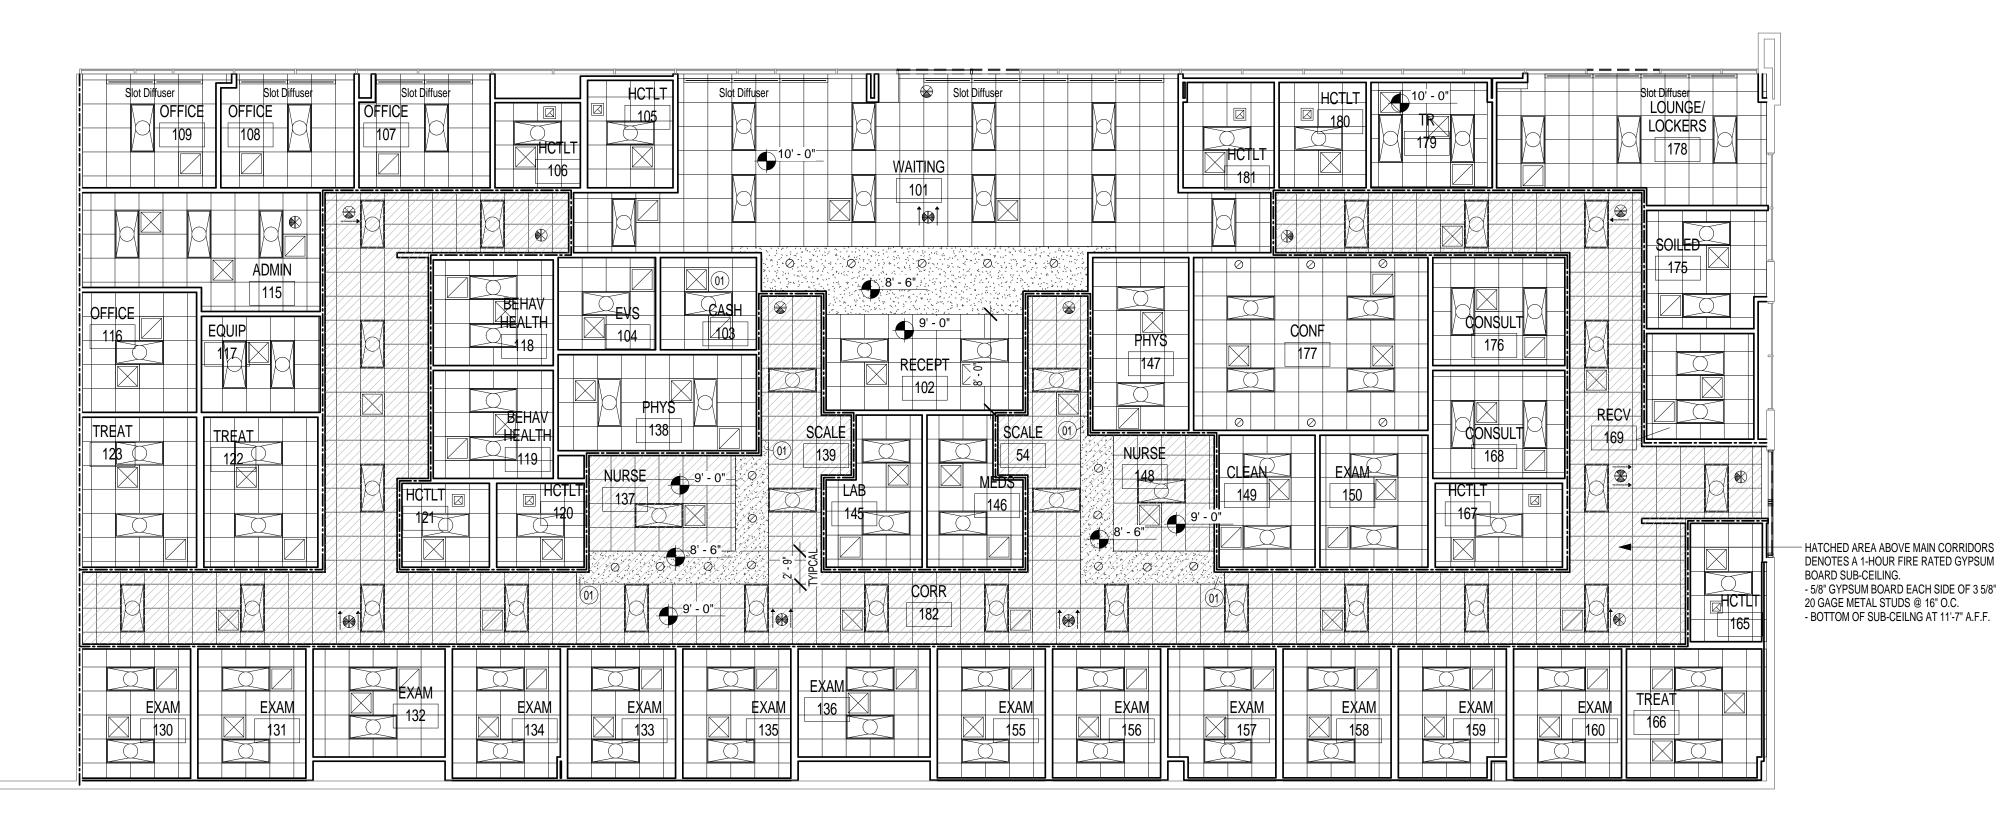
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Checker

REVISIONS

No. Date

TASK

ISSUE FOR PERMIT &

PRICING

HARRIS HEALTH SYSTEM

2000 BERING DRIVE SUITE 850 HOUSTON, TX 77057 713-532-2466 www.johnston-llc.com

Engineers · Architects · Planners · Managers

2525 Holly Hall Street, Houston, Tx 77054

ARCHITECT & ENGINEERS:

ARCHITECT: Johnston, LLC

MEP: Johnston, LLC

CIVIL: Johnston, LLC




- SHADED AREAS DENOTE GENERAL LIMITS OF CONSTRUCTION. ALL INTERIOR PARTITIONS ARE TYPE "A3A", AND EXTEND TO 12'-0" A.F.F., U.N.O.
- PROVIDE 5/8" GYPSUM BOARD ALL EXTERIOR WALLS. EXTEND & SEAL TO STRUCTURAL DECK ABOVE. SEAL ALL PENETRATIONS TIGHT. PROVIDE ADD'L UNFACED BATT INSULATION WHERE MISSING TO PROVIDE A COMPLETE THERMAL ENCLOSURE.
- PTM AND MAINTAIN ALL FIRE RATINGS FOR PARTITIONS & FLOORS / ROOFS WHERE PIPES, CONDUITS, DUCTS, ETC., HAVE BEEN REMOVED.


FLOOR PLAN NOTES BY NUMBER


- WALL MOUNTED TV CENTER ON WALL PLANE. PROVIDE 2 LAYERS OF 3/4 PLYWOOD BLOCKING 18" HIGH BETWEEN 16 GAGE METAL STUDS. CENTER PLYWOOD HORIZ & VERTICALLY ON TV MOUNT; ATTACH TO EACH STUD W/ MINIMUM 4 SCREW FASTENERS x 3"
- PROVIDE 3/4" PLYWOOD THE FULL WIDTH OF THIS WALL PLANE x 8'-0" HIGH.
- PROVIDE 5/8" USG AQUA TOUGH FIBERROCK GYPSUM BOARD ALL WALLS THIS ROOM FULL HEIGHT OF PARTITION
- CENTER NEW PARTITION ON MULLION SEE 3/A-101. EXISTING DOOR TO REMAIN. REMOVE EXISTING DOOR HANDLES & GIVE TO BUILDING
- PROVIDE 8 TRIPLE TIER LOCKERS (24 LOCKERS TOTAL) 12" x 12" x 72" HIGH W/ SLOPED
- TOPS. SET LOCKERS ON 4 INCH HIGH WOOD BASE HOLD FRONT OF WOOD BASE 1 INCH BEHIND FACE OF LOCKERS. PROVIDE CLOSURE PANELS / TRIM TO ABUTTING WALLS.
- PROVIDE 5/8" GYPSUM BOARD OVER EXISTING METAL STUDS. EXTEND & SEAL TO STRUCTURAL DECK ABOVE TO PROVIDE A 1-HOUR FIRE RATING. PROVIDE ADD'L BATT INSULATION WHERE MISSING.
- HOLD PARTITION FRAMING TIGHT TO EXISTING COLUMN.
- PROVIDE 3M FASARA GLASS FINISH MAT CRYSTAL FILM ON INSIDE FACE OF GLAZING BEHIND PARTITION. DO NOT CLOSE OFF DRYWALL CONSTRUCTION AT TOP OF SPACE BETWEEN NEW PARTITION & EXTERIOR TO ALLOW AIR MOVEMENT. SEE TYPICAL DETAILS THIS SHEET FOR WALL CLOSURE AT EXTERIOR STOREFRONT.
- INSTALL DRYWALL FRAMING TO FIT WITHIN EXISTING ALUM TRIM AT COLUMN FACE NEAR
- CENTER PARTITIONS ON EXISTING COLUMN.
- HOLD PARTITION AS FAR TOWARDS STOREFRONT / GLAZING AS POSSIBLE. NOTE REDUCED CEILING HEIGHT THIS ROOM.
- SEE 3/A-101 FOR TYPICAL DETAIL OF PARTITION ABUTTING GLAZING / MULLIONS.
- WALL MOUNTED PC ON ERGOTRON SUPPORT BRACKET PROVIDE 2 LAYERS OF 3/4 PLYWOOD BLOCKING x 16" WIDE B/T 16 GAGE METAL STUDS. CENTER PLYWOOD ON BRACKET & EXTEND FROM 24" A.F.F. TO 72" A.F.F.; ATTACH TO EACH STUD W/ MINIMUM 4 SCREW FASTENERS x 3" LONG. - EXAM ROOMS 130 - 136, 155 - 160: CENTER 60 INCHES FROM SOUTH WALL - EXAM 150: CENTER 60 INCHES FROM NORTH WALL - TREATMENT ROOM 166: CENTER 60" FROM EAST WALL
- TREATMENT ROOM 122, 123: CENTER 60" FROM WEST WALL - RECV : CENTER ON WALL PLANE - LOUNGE / LOCKERS 178: CENTER ON WALL PLANE - CONF 177: CENTER 42 INCHES FROM DOOR
- TA16A BABY CHANGING STATION (SEE SHEET A-003 FOR DESCRIPTION)
- PROVIDE NEW STOREFRONT FRAMING & GLAZING AS REQUIRED WHERE DOOR WAS REMOVED. MATCH EXISTING APPEARANCE.
- MODIFY EXISTING STOREFRONT FRAMING & GLAZING AS REQUIRED TO REINSTALL EXISTING DOUBLE DOORS. MATCH EXISTING APPEARANCE.

1 LEVEL 1 FLOOR PLAN 1/8" = 1'-0"

MODIFY EXISTING STOREFRONT FRAMING & GLAZING AS REQUIRED FOR NEW DOOR.

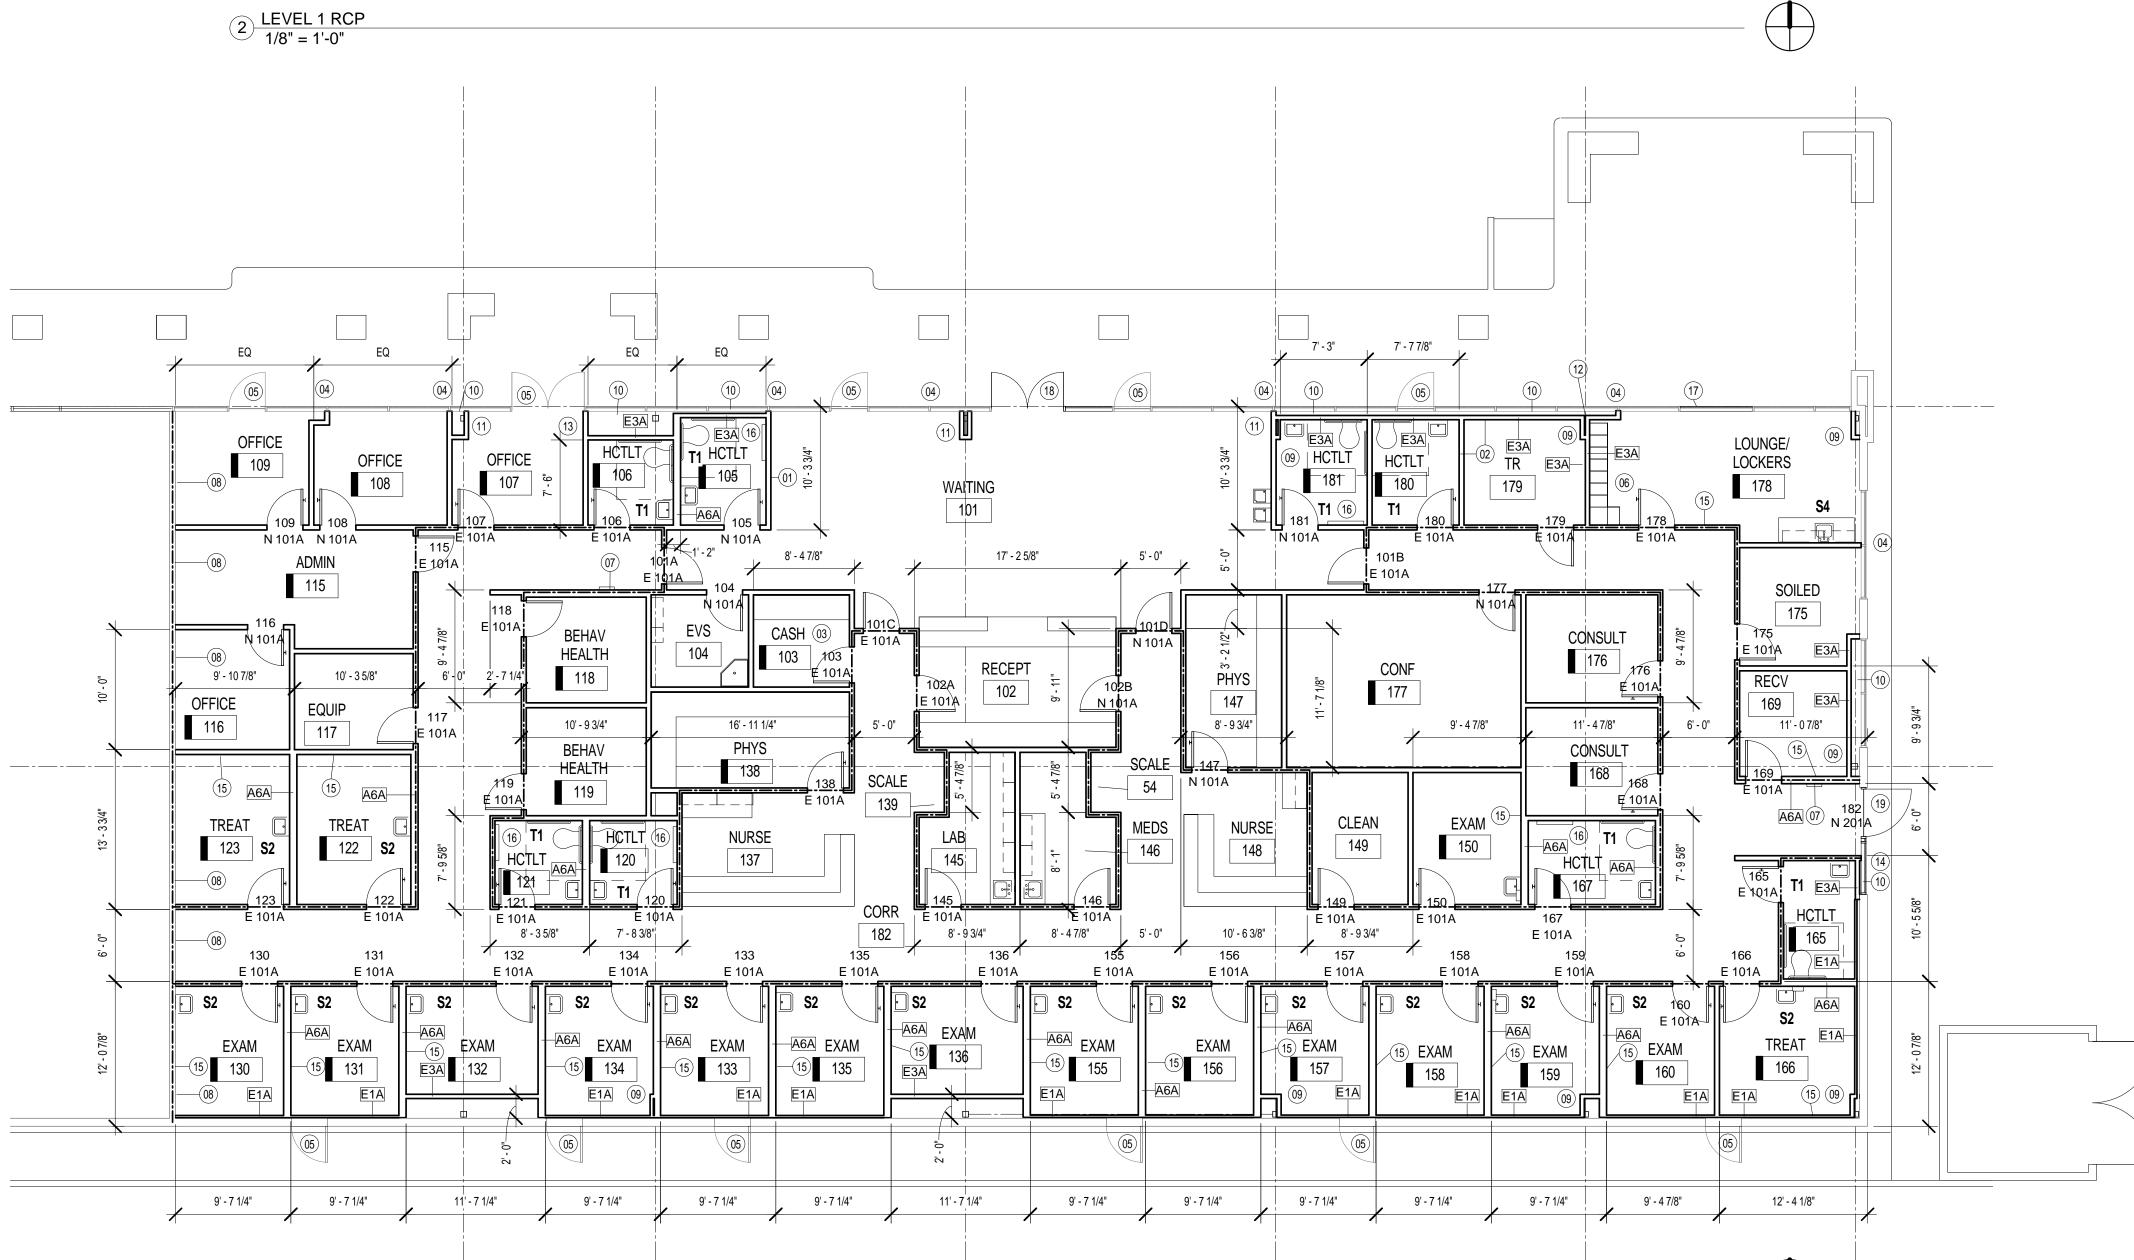

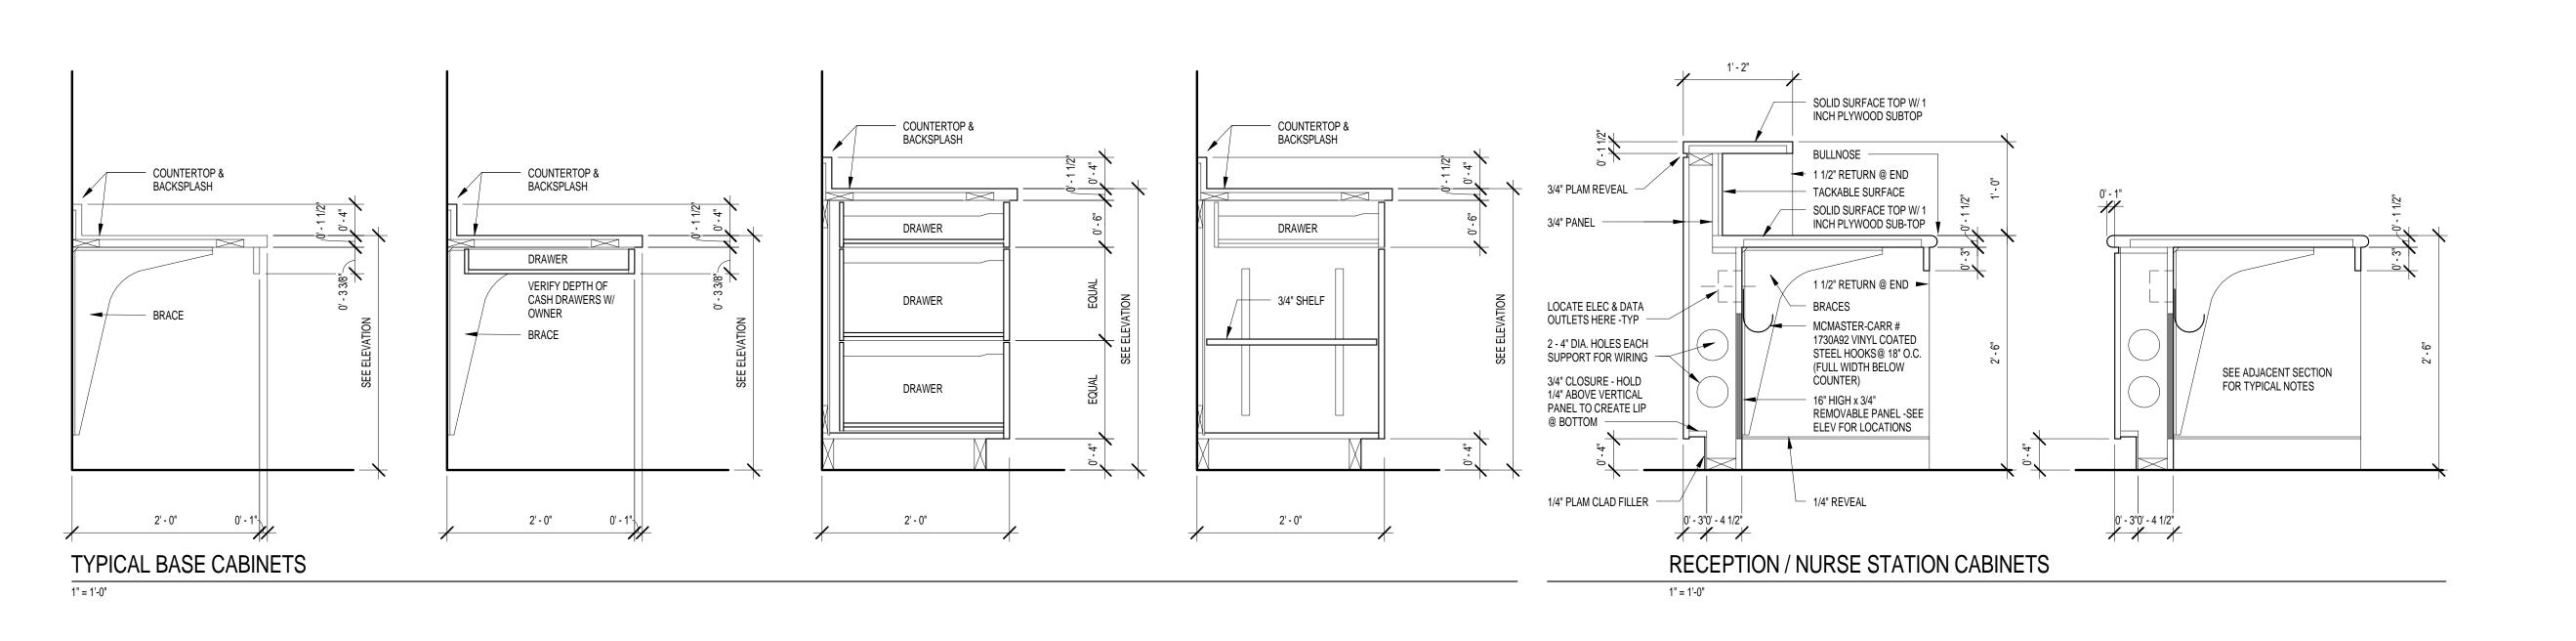

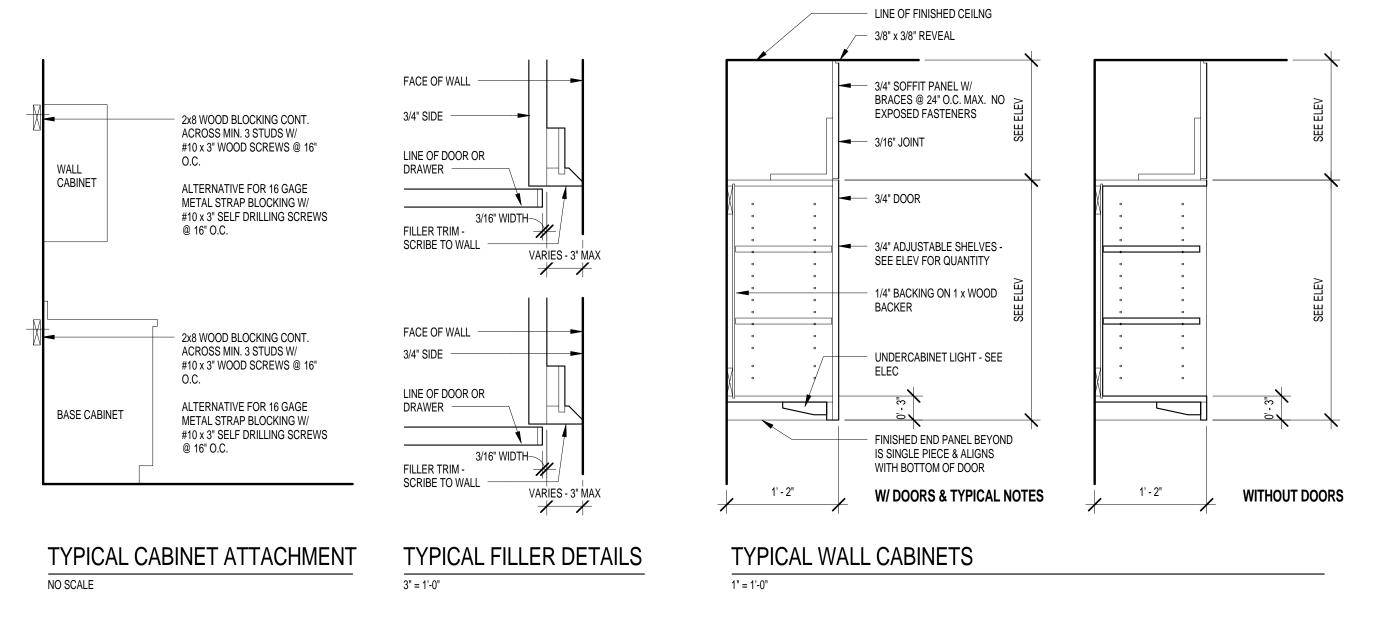

CABINETRY NOTES

GENERAL
REFER TO INTERIOR ELEVATIONS ON A6.xx SHEETS WHERE THE DRAWING NAME IDENTIFIES THE ROOM AND WALL (N-NORTH, S-SOUTH, E-EAST, AND W-WEST) ON WHICH THE CABINETRY IS LOCATED. REFER ALSO TO THE FLOOR PLANS.

SPECIALIZED CABINET SECTIONS ONLY ARE KEYED OR NOTED ON CABINET ELEVATIONS. CABINET SECTIONS SHOWN THIS

SHEET ILLUSTRATE TYPICAL CONSTRUCTION AND NOT EVERY DOOR AND / OR DRAWER VARIATION IS SHOWN.

REFER TO "ARCHITECTURALLY SIGNIFICANT EQUIPMENT" - "ASE" BOOK BY THE OWNER FOR MEDICAL EQUIPMENT PURCHASE & INSTALLATION CRITERIA.

- REFER TO "AQ" FLOOR PLAN SHEETS FOR EQUIPMENT LOCATIONS & TAGS

- COORDINATE SIZE OF OPENINGS WITHIN CABINETRY & ADJACENT SPACES

CONSTRUCTION ALL CABINETRY IS PLASTIC LAMINATE CLAD, U.N.O

ALL COUNTERTOPS ARE SOLID SURFACE MATERIAL, U.N.O.
- FOR ANY STRAIGHT RUN PLAM CLAD COUNTERTOPS W/ SINKS, PROVIDE POSTFORMING AT BACKSPLASH TO COUNTERTOP.

- PROVIDE 1 INCH PLYWOOD SUB-TOPS BELOW - BOTTOM OF SUB-TOP FLUSH W/ BOTTOM OF SOLID SURFACE EDGE.

PROVIDE PLAM CLAD TRIM & FILLER PANELS WHERE EQUIPMENT IS LOCATED WITHIN CABINET UNITS.

PROVIDE 1 1/2" WIDE SIDE & END PANELS WHERE SHOWN ON ELEVATIONS.

ALL UPPER CABINETS HAVE PLAM CLAD "SOFFIT PANELS" ABOVE, EXTENDING FROM THE TOP OF CABINET TO CEILING IN LIEU OF GYP. BD. FURR DOWNS. VERIFY THE ROOM CEILING HEIGHT TO DETERMINE ACTUAL "SOFFIT PANEL" HEIGHTS.

AT THE BOTTOM OF UPPER CABINET UNITS, ALLOW FOR CONTINUOUS RUNS OF UNDERCOUNTER LIGHTS. SEE ALSO ELECTRICAL DRAWINGS.

PROVIDE BLOCKING IN PARTITIONS FOR ALL CABINETRY ATTACHED TO WALLS. SEE SECTION THIS SHEET FOR FASTENING DETAILS.

DEPTH OF CABINET UNITS ARE AS SHOWN ON SECTIONS, U.N.O., ON INTERIOR ELEVATIONS.

PROVIDE SIDE SPLASHES WHERE COUNTERTOPS ABUT WALLS AT SIDES, U.N.O.
GLASS PANELS ARE 1/4 INCH CLEAR TEMPERED GLASS, U.N.O.

FILE DRAWERS ARE NOTED ON ELEVATIONS. PROVIDE MINIMUM INSIDE CLEAR DIMENSIONS OF 13.5" WIDE x 10.5" HIGH x 20.5" DEEP.

PROVIDE COUNTERTOP BRACE SUPPORTS AT 42" O.C. MAX. @ KNEESPACES & LAVATORY COUNTERS, U.N.O. - 25" DEEP COUNTERTOPS - GAMBAS "LARGE WORKSTATION BRACKETS" - WWW.GAMBASBRACKETS.COM - 30" DEEP COUNTERTOPS - SEE SUPPORT DETAIL THIS SHEET.

PROVIDE 2" DIAMETER BLACK GROMMETS AT BACK OF COUNTERTOPS - 1 PER 30" OF KNEESPACE WIDTH. LOCATE IN FIELD WITH ARCHITECT.

PAINT OR SEAL ALL VISIBLE WOOD, PLYWOOD, OR MDF BUCKS, CLEATS, SUPPORTS, BRACES, ETC., AT KNEESPACES. I.E., NO UNFINISHED WOOD PRODUCT SURFACES OR EDGES.


PROVIDE BOTTOM CLOSURE FOR FILLER PANELS AT TOE SPACES AND AT BOTTOM OF UPPER WALL CABINETS TO CLOSE OFF ALL CONCEALED SPACES - I.E., KEEP VERMIN OUT.


SOLID SURFACE
- EASE ALL EDGES TO APPROXIMATE 1/8" RADIUS, U.N.O.
- RADIUS TOP EDGE OF BACK & SIDE SPLASHES TO 1/2" RADIUS - NO FLAT TOP FOR WATER ACCUMULATION

SOLID SURFACE SINK SCHEDULE

DUPONT MODEL 816 W/ NO OVERFLOW - INSTALL TO MEET ADA - INSTALL IN COUNTERTOPS AT MENS 103 & WOMENS 155

TYPICAL CASEWORK NOMENCLATURE

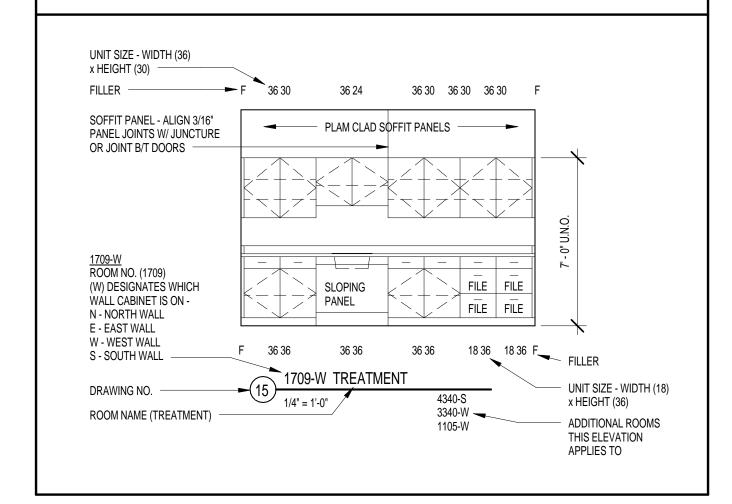

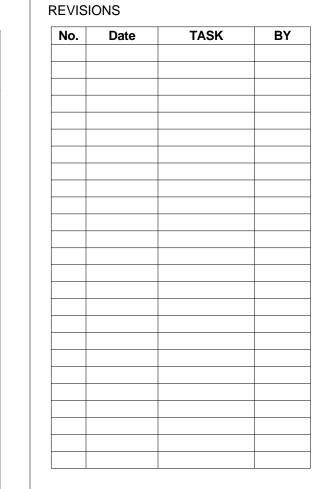

ISSUE FOR PERMIT & PRICING



HARRIS HEALTH SYSTEM 2525 Holly Hall Street,

Houston, Tx 77054

ARCHITECT & ENGINEERS:



ARCHITECT:
Johnston, LLC

MEP:
Johnston, LLC

CIVIL:
Johnston, LLC

Section of the party of the par

Firm Registration #:

PROJECT TITLE:

SPRING BRANCH

HEALTH CENTER

Tx 77055

PROJECT LOCATION:
9801 Long Point, Houston,

SHEET TITLE:
INTERIOR ELEVATIONS

& CABINETRY TYPES

11/04/13 DATE:

SHEET NUMBER:

SCALE:


A-601

DRAWN BY: SCALE:

Author As indicated

CHECKED BY: JOB NO:

Checker

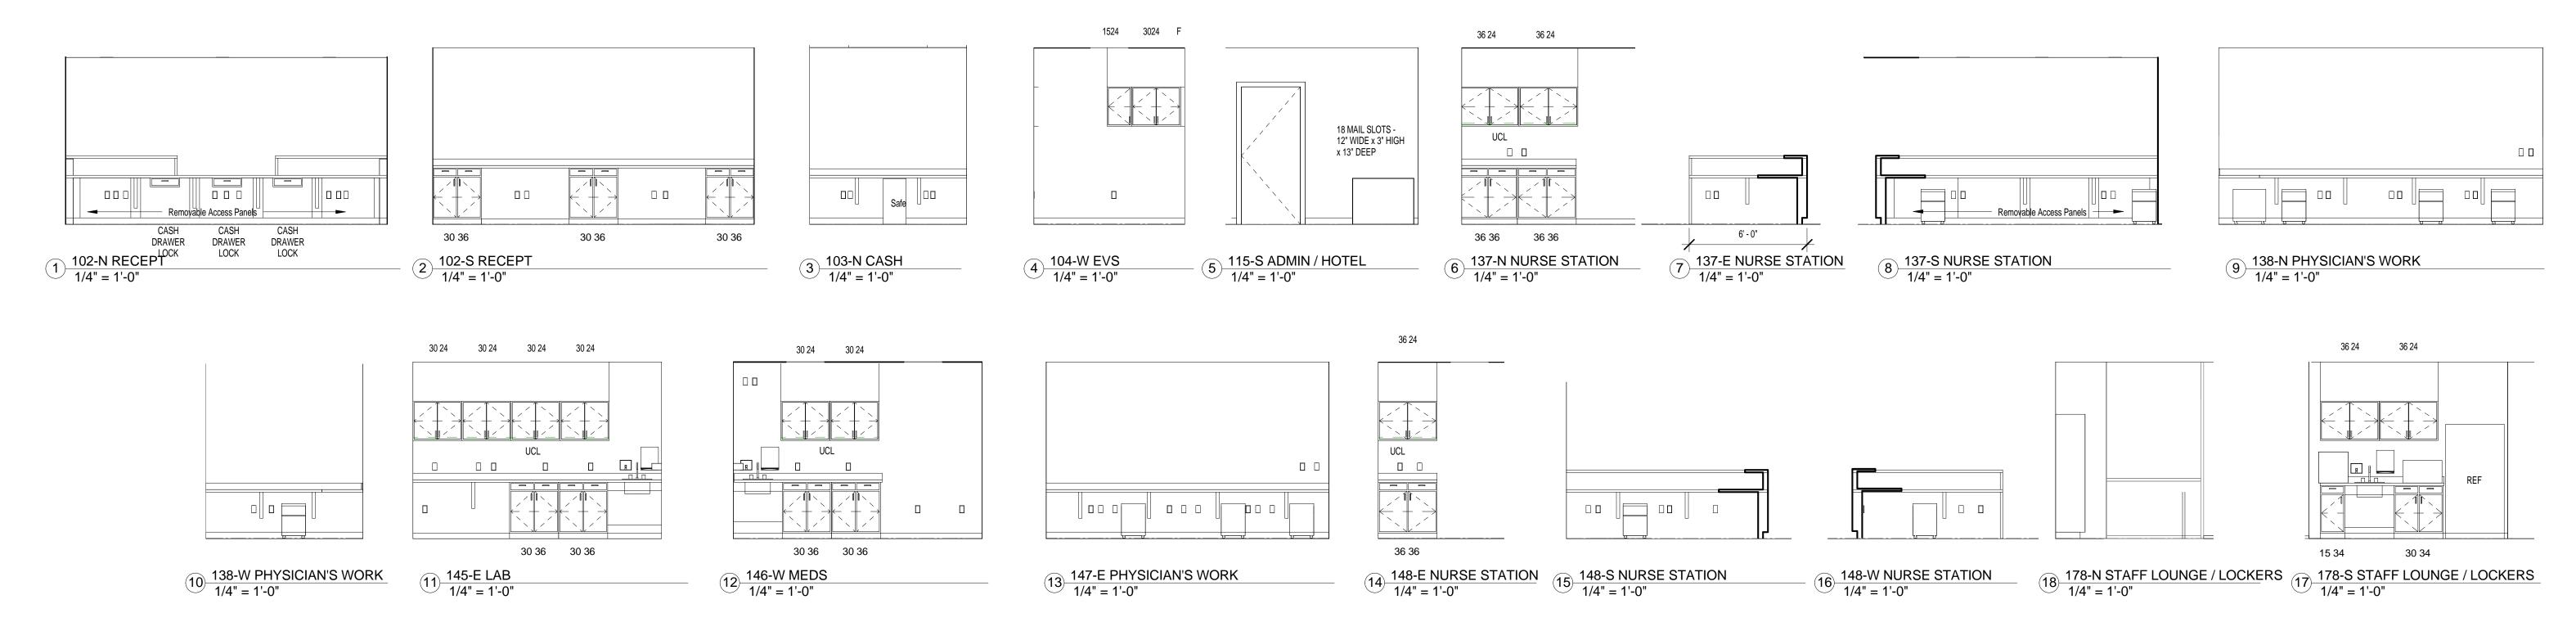

CODE	MATERIAL	MANUFACTURER	DESCRIPTION	NOTES	HHS CODE	CONTACT
LOORING						
C1A		PATCRAFT COMMERCIAL CARPET	STYLE NAME: SPLASH STYLE NUMBER: 10074 COLOR: SPRINGBOARD 74308	BEN TAUB, VALLBONA, CASA DE AMIGOS, GULFGATE	CPT-1	Coy Holman (800) 713-6697 x 5233 Coy.holman@patcraft.com
			SIZE: 24" X 24" TILES INSTALLATION: ONE QUARTER TURN		 	
C1B		TANDUS	STYLE NAME: AFTERMATH II STYLE NUMBER: 03026 COLOR: POTPOURRI 23510	FRY RD, LBJ, SPRING BRANCH	CPT-7	Karen Perucki (832) 367-5109 kperucki@tandus.com
C1C		LEES CARPET	SIZE: 24" X 24" TILES INSTALLATION: ONE QUARTER TURN STYLE NAME: TEXTURE BLOCKS	GULFGATE DENTAL	CPT-8	Joel Kerstein
CIC		LLLS CARPET	STYLE NUMBER: DN073 COLOR: PLAYGROUND BLUE 427	GOLI GATE DENTAL	CF 1-0	(281) 704-4508 Joel Kerstein
R	FLOORING, RESILIENT SHEET		SIZE: 24" X 24" TILES INSTALLATION: ONE QUARTER TURN			JoelKerstein@leescarpets.co
R1A	SHEET VINYL	MANNINGTON	SERIES: BIOSPEC MD WIDTH: 6'		VSF-1	
R1B	NOT USED		COLOR: OYSTER WHITE 15201			_
т						
T1A	PORCELAIN TILE	DAL TILE	PRODUCT: DUNA DI SABBIA CD98 SIZE: 12" X 12" INSTALLATION PATTERN: STACKED	TOILETS	CT-11	
			GROUT: TEX RITE EPOXY GROUT COLOR: CANVAS 251		G-6	
V V1A	VINYL COMPOSITE TILE	ARMSTRONG	GROUT JOINTS" 1/8" SERIES: STANDARD EXCELON	FIELD TILE	VCT-1	
VIA	VINTE COIVIT OSTIE TIEE	ANVISTRONG	SIZE: 12" X 12" COLOR: ANTIQUE WHITE 51811	THE THE	VCI-1	
V1B	VINYL COMPOSITE TILE	ARMSTRONG	INSTALLATION: ONE QUARTER TURN SERIES: STANDARD EXCELON SIZE: 12" X 12"	ACCENT TILE (GREEN PALETTE)	VCT-2	_
			COLOR: GRANNY SMITH 51885 INSTALLATION: ONE QUARTER TURN			
V1C	NOT USED					
V1D	VINYL COMPOSITE TILE	ARMSTRONG	SERIES: STANDARD EXCELON	ACCENT TILE	VCT-4	_
			SIZE: 12" X 12" COLOR: CAYENNE RED 51943 INSTALLATION: ONE QUARTER TURN			
V1E	VINYL COMPOSITE TILE	ARMSTRONG	SERIES: STANDARD EXCELON SIZE: 12" X 12"	ACCENT TILE (ALL PALETTES)	VCT-5	1
V1F	VINYL COMPOSITE TILE	ARMSTRONG	COLOR: GENTIAN BLUE 51946 INSTALLATION: ONE QUARTER TURN SERIES: STANDARD EXCELON	ACCENT TILE	VCT-6	_
ΛTL	AUALE COIMILOSHE HIFF	DNIONTCIVING	SERIES: STANDARD EXCELON SIZE: 12" X 12" COLOR: TYRIAN PURPLE 51944	POCCEINT TILE	VC1-0	
V1G	VINYL COMPOSITE TILE	ARMSTRONG	INSTALLATION: ONE QUARTER TURN SERIES: STANDARD EXCELON SIZE: 12" X 12"	ACCENT TILE (TAN PALETTE)	VCT-7	-
			SIZE: 12" X 12" COLOR: CAMEL BEIGE 51805 INSTALLATION: ONE QUARTER TURN			
V1H	VINYL COMPOSITE TILE	ARMSTRONG	SERIES: STANDARD EXCELON SIZE: 12" X 12"	ACCENT TILE (SMOKEY BROWN)	VCT-8	
·V1J	VINYL COMPOSITE TILE	ARMSTRONG	COLOR: SMOKEY BROWN 51868 INSTALLATION: ONE QUARTER TURN SERIES: STANDARD EXCELON	ACCENT TILE	VCT-9	-
			SIZE: 12" X 12" COLOR: GOLDEN 51878			
V1K	VINYL COMPOSITE TILE	ARMSTRONG	INSTALLATION: ONE QUARTER TURN SERIES: STANDARD EXCELON SIZE: 12" X 12"	ACCENT TILE	VCT-10	-
			COLOR: COLORADO STONE 57506 INSTALLATION: ONE QUARTER TURN			
-1 -2	COMBINATION COMBINATION	N/A N/A	COMBINATION OF FV1A, FV1B, FV1D, FV1E, FV1G, FV1H COMBINATION OF FV1A AND FV1B	GREEN PALETTE		_
-3 -4	COMBINATION COMBINATION	N/A N/A	COMBINATION OF FV1A, FV1E, AND FV1H COMBINATION OF FV1A, FV1E, AND FV1G			
-5 -6 -7	COMBINATION COMBINATION COMBINATION	N/A N/A N/A	COMBINATION OF FV1A AND FV1G COMBINATION OF FV1A AND FV1H COMBINATION OF FV1A, FV1B, FV1F, FV1J, ANF FV1K	TAN PALETTE SMOKEY BROWN PALETTE		=
<i>NALL BA</i> : BV	SE BASE, RESILIENT COVE		"TRIM" PER SECTION 096513			
BV1A	RUBBER COVE BASE	ROPPE	SERIES: PINNACLE RUBBER BASE PROFILE: STANDARD, COVE HEIGHT: 4"		B-4	
BR1A	BASE, RESILIENT, SHEET (INTERGRAL) 	COLOR: 193 BLACK BROWN SERIES/COLOR: MATCH ADJACENT FLOORING UNO	I		
			HEIGHT: 6" PROVIDE RESILIENT TOPCAP			
T T1A VALL FIN	BASE, TILE PORCELAIN TILE BASE	DAL TILE				
VP VP1A	WALL, EGGSHELL, PAINTED GYP BOA	RD	EXCEPTION PER SECTION 099100			
	LATEX	SHERWIN WILLIAMS	COLOR: CLARY SAGE	ACCENT COLOR (CREEN	PT-4	Roy Parez
VP1B	LATEA	HARMONY EGGSHELL	SW# 6178 COORD WALL PROTECTION COLOR: OCEAN GRAY 853	PALETTE)	r 1-4	Roy Perez (832) 567-8856 swrep6143@sherwin.com
VP1C	LATEX	SHERWIN WILLIAMS	COLOR: ARTICHOKE			_ sureport to C street transcorti
VP1D	_	HARMONY EGGSHELL	SW# 6179	ACCENT COLOR (GREEN PALETTE)	PT-5	Tim Besson
	LATEX	HARMONY EGGSHELL SHERWIN WILLIAMS HARMONY EGGSHELL			PT-8	1
WP1E	LATEX	SHERWIN WILLIAMS HARMONY EGGSHELL SHERWIN WILLIAMS	SW# 6179 COORD WALL PROTECTION COLOR: SAVANNAH 522 COLOR: ALEUTIAN SW# 6241 COORD WALL PROTECTION COLOR: CAPE BLUE 325 COLOR: BRACING BLUE	PALETTE) ACCENT COLOR (TAN & SMOKEY BROWN PALETTES) ACCENT COLOR (TAN &	PT-8 PT-9	Tim Besson (713) 529-6515
		SHERWIN WILLIAMS HARMONY EGGSHELL	SW# 6179 COORD WALL PROTECTION COLOR: SAVANNAH 522 COLOR: ALEUTIAN SW# 6241 COORD WALL PROTECTION COLOR: CAPE BLUE 325	PALETTE) ACCENT COLOR (TAN & SMOKEY BROWN PALETTES)	PT-8 PT-9	Tim Besson (713) 529-6515
WP1F	NOT USED	SHERWIN WILLIAMS HARMONY EGGSHELL SHERWIN WILLIAMS HARMONY EGGSHELL	SW# 6179 COORD WALL PROTECTION COLOR: SAVANNAH 522 COLOR: ALEUTIAN SW# 6241 COORD WALL PROTECTION COLOR: CAPE BLUE 325 COLOR: BRACING BLUE SW# 6242 COORD WALL PROTECTION COLOR: DANUBE 233	PALETTE) ACCENT COLOR (TAN & SMOKEY BROWN PALETTES) ACCENT COLOR (TAN & SMOKEY BROWN PALETTES)	PT-8 PT-9	Tim Besson (713) 529-6515
WP1F	LATEX	SHERWIN WILLIAMS HARMONY EGGSHELL SHERWIN WILLIAMS	SW# 6179 COORD WALL PROTECTION COLOR: SAVANNAH 522 COLOR: ALEUTIAN SW# 6241 COORD WALL PROTECTION COLOR: CAPE BLUE 325 COLOR: BRACING BLUE SW# 6242	PALETTE) ACCENT COLOR (TAN & SMOKEY BROWN PALETTES) ACCENT COLOR (TAN & SMOKEY BROWN PALETTES)	PT-8 PT-9	Tim Besson (713) 529-6515
VP1F VP1G	NOT USED	SHERWIN WILLIAMS HARMONY EGGSHELL SHERWIN WILLIAMS HARMONY EGGSHELL SHERWIN WILLIAMS	SW# 6179 COORD WALL PROTECTION COLOR: SAVANNAH 522 COLOR: ALEUTIAN SW# 6241 COORD WALL PROTECTION COLOR: CAPE BLUE 325 COLOR: BRACING BLUE SW# 6242 COORD WALL PROTECTION COLOR: DANUBE 233 COLOR: SOFT OFF WHITE SW# CUSTOM MATCH HCHD PT10 COORD WALL PROTECTION COLOR: TETON WHITE 517 COLOR: SW STONINGTON BEIGE SW# CUSTOM MATCH HCHD PT11	PALETTE) ACCENT COLOR (TAN & SMOKEY BROWN PALETTES) ACCENT COLOR (TAN & SMOKEY BROWN PALETTES) FIELD COLOR	PT-8 PT-9	Tim Besson (713) 529-6515
VP1F VP1G VP1H	LATEX NOT USED LATEX LATEX	SHERWIN WILLIAMS HARMONY EGGSHELL SHERWIN WILLIAMS HARMONY EGGSHELL SHERWIN WILLIAMS HARMONY EGGSHELL SHERWIN WILLIAMS	SW# 6179 COORD WALL PROTECTION COLOR: SAVANNAH 522 COLOR: ALEUTIAN SW# 6241 COORD WALL PROTECTION COLOR: CAPE BLUE 325 COLOR: BRACING BLUE SW# 6242 COORD WALL PROTECTION COLOR: DANUBE 233 COLOR: SOFT OFF WHITE SW# CUSTOM MATCH HCHD PT10 COORD WALL PROTECTION COLOR: TETON WHITE 517 COLOR: SW STONINGTON BEIGE SW# CUSTOM MATCH HCHD PT11 COORD WALL PROTECTION COLOR: BEIGE 103	PALETTE) ACCENT COLOR (TAN & SMOKEY BROWN PALETTES) ACCENT COLOR (TAN & SMOKEY BROWN PALETTES) FIELD COLOR	PT-9 PT-10	Tim Besson (713) 529-6515
VP1F VP1G VP1H VS	LATEX NOT USED LATEX LATEX DOOR FRAMES, SEMI-GLOSS PAINT NOT USED	SHERWIN WILLIAMS HARMONY EGGSHELL SHERWIN WILLIAMS HARMONY EGGSHELL SHERWIN WILLIAMS HARMONY EGGSHELL SHERWIN WILLIAMS	SW# 6179 COORD WALL PROTECTION COLOR: SAVANNAH 522 COLOR: ALEUTIAN SW# 6241 COORD WALL PROTECTION COLOR: CAPE BLUE 325 COLOR: BRACING BLUE SW# 6242 COORD WALL PROTECTION COLOR: DANUBE 233 COLOR: SOFT OFF WHITE SW# CUSTOM MATCH HCHD PT10 COORD WALL PROTECTION COLOR: TETON WHITE 517 COLOR: SW STONINGTON BEIGE SW# CUSTOM MATCH HCHD PT11	PALETTE) ACCENT COLOR (TAN & SMOKEY BROWN PALETTES) ACCENT COLOR (TAN & SMOKEY BROWN PALETTES) FIELD COLOR	PT-10 PT-11 PT-12	Tim Besson (713) 529-6515 sw7403@sherwin.com
VP1F VP1G VP1H VS VS1A VS1B	LATEX NOT USED LATEX LATEX DOOR FRAMES, SEMI-GLOSS PAINT	SHERWIN WILLIAMS HARMONY EGGSHELL SHERWIN WILLIAMS HARMONY EGGSHELL SHERWIN WILLIAMS HARMONY EGGSHELL SHERWIN WILLIAMS	SW# 6179 COORD WALL PROTECTION COLOR: SAVANNAH 522 COLOR: ALEUTIAN SW# 6241 COORD WALL PROTECTION COLOR: CAPE BLUE 325 COLOR: BRACING BLUE SW# 6242 COORD WALL PROTECTION COLOR: DANUBE 233 COLOR: SOFT OFF WHITE SW# CUSTOM MATCH HCHD PT10 COORD WALL PROTECTION COLOR: TETON WHITE 517 COLOR: SW STONINGTON BEIGE SW# CUSTOM MATCH HCHD PT11 COORD WALL PROTECTION COLOR: BEIGE 103 EXCEPTION PER SECTION 099100	PALETTE) ACCENT COLOR (TAN & SMOKEY BROWN PALETTES) ACCENT COLOR (TAN & SMOKEY BROWN PALETTES) FIELD COLOR FIELD COLOR	PT-9 PT-10 PT-11 PT-12 PT-13	Tim Besson (713) 529-6515 sw7403@sherwin.com
VP1F VP1G VP1H VS VS1A VS1B VS1C	LATEX NOT USED LATEX LATEX DOOR FRAMES, SEMI-GLOSS PAINT NOT USED NOT USED	SHERWIN WILLIAMS HARMONY EGGSHELL SHERWIN WILLIAMS HARMONY EGGSHELL SHERWIN WILLIAMS HARMONY EGGSHELL SHERWIN WILLIAMS	SW# 6179 COORD WALL PROTECTION COLOR: SAVANNAH 522 COLOR: ALEUTIAN SW# 6241 COORD WALL PROTECTION COLOR: CAPE BLUE 325 COLOR: BRACING BLUE SW# 6242 COORD WALL PROTECTION COLOR: DANUBE 233 COLOR: SOFT OFF WHITE SW# CUSTOM MATCH HCHD PT10 COORD WALL PROTECTION COLOR: TETON WHITE 517 COLOR: SW STONINGTON BEIGE SW# CUSTOM MATCH HCHD PT11 COORD WALL PROTECTION COLOR: BEIGE 103	PALETTE) ACCENT COLOR (TAN & SMOKEY BROWN PALETTES) ACCENT COLOR (TAN & SMOKEY BROWN PALETTES) FIELD COLOR	PT-10 PT-11 PT-12	Tim Besson (713) 529-6515 sw7403@sherwin.com
VP1F VP1G VP1H VS VS1A VS1B VS1C	LATEX NOT USED LATEX LATEX DOOR FRAMES, SEMI-GLOSS PAINT NOT USED	SHERWIN WILLIAMS HARMONY EGGSHELL SHERWIN WILLIAMS HARMONY EGGSHELL SHERWIN WILLIAMS HARMONY EGGSHELL SHERWIN WILLIAMS	COLOR: SOFT OFF WHITE SW# CUSTOM MATCH HCHD PT11 COORD WALL PROTECTION COLOR: TETON WHITE 517 COLOR: SW STONINGTON BEIGE SW# CUSTOM MATCH HCHD PT11 COORD WALL PROTECTION COLOR: BEIGE 103 EXCEPTION PER SECTION 099100 COLOR: SW STONINGTON BEIGE SW# CUSTOM MATCH HCHD PT11 COORD WALL PROTECTION COLOR: BEIGE 103	PALETTE) ACCENT COLOR (TAN & SMOKEY BROWN PALETTES) ACCENT COLOR (TAN & SMOKEY BROWN PALETTES) FIELD COLOR FIELD COLOR	PT-9 PT-10 PT-11 PT-12 PT-13	Tim Besson (713) 529-6515 sw7403@sherwin.com Roy Perez (832) 567-8856 swrep6143@sherwin.com Tim Besson (713) 529-6515
VP1F VP1G VP1H VS VS1A VS1B VS1C	LATEX NOT USED LATEX LATEX DOOR FRAMES, SEMI-GLOSS PAINT NOT USED NOT USED WALL, TILE	SHERWIN WILLIAMS HARMONY EGGSHELL SHERWIN WILLIAMS HARMONY EGGSHELL SHERWIN WILLIAMS HARMONY EGGSHELL SHERWIN WILLIAMS HARMONY EGGSHELL	COLOR: ALEUTIAN SW# 6241 COORD WALL PROTECTION COLOR: CAPE BLUE 325 COLOR: BRACING BLUE SW# 6242 COORD WALL PROTECTION COLOR: DANUBE 233 COLOR: SOFT OFF WHITE SW# CUSTOM MATCH HCHD PT10 COORD WALL PROTECTION COLOR: TETON WHITE 517 COLOR: SW STONINGTON BEIGE SW# CUSTOM MATCH HCHD PT11 COORD WALL PROTECTION COLOR: BEIGE 103 EXCEPTION PER SECTION 099100 COLOR: SW STONINGTON BEIGE SW# CUSTOM MATCH HCHD PT114	PALETTE) ACCENT COLOR (TAN & SMOKEY BROWN PALETTES) ACCENT COLOR (TAN & SMOKEY BROWN PALETTES) FIELD COLOR TYP	PT-9 PT-10 PT-11 PT-12 PT-13 PT-14	Tim Besson (713) 529-6515 sw7403@sherwin.com Roy Perez (832) 567-8856 swrep6143@sherwin.com Tim Besson (713) 529-6515
VP1F VP1G VP1H VS VS1A VS1B VS1C	LATEX NOT USED LATEX LATEX DOOR FRAMES, SEMI-GLOSS PAINT NOT USED NOT USED WALL, TILE	SHERWIN WILLIAMS HARMONY EGGSHELL SHERWIN WILLIAMS HARMONY EGGSHELL SHERWIN WILLIAMS HARMONY EGGSHELL SHERWIN WILLIAMS HARMONY EGGSHELL	COLOR: SOFT OFF WHITE SW# CUSTOM MALL PROTECTION COLOR: TETON WHITE 517 COLOR: SW STONINGTON BEIGE SW# CUSTOM MATCH HCHD PT11 COORD WALL PROTECTION COLOR: BEIGE 103 EXCEPTION PER SECTION 099100 COLOR: SW STONINGTON BEIGE SW# CUSTOM MATCH HCHD PT11 COORD WALL PROTECTION COLOR: BEIGE 103	PALETTE) ACCENT COLOR (TAN & SMOKEY BROWN PALETTES) ACCENT COLOR (TAN & SMOKEY BROWN PALETTES) FIELD COLOR TYP	PT-9 PT-10 PT-11 PT-12 PT-13 PT-14	Tim Besson (713) 529-6515 sw7403@sherwin.com Roy Perez (832) 567-8856 swrep6143@sherwin.com Tim Besson (713) 529-6515
VP1F VP1G VP1H VS VS1A VS1A VS1C VT VT1A	LATEX NOT USED LATEX LATEX DOOR FRAMES, SEMI-GLOSS PAINT NOT USED NOT USED WALL, TILE	SHERWIN WILLIAMS HARMONY EGGSHELL SHERWIN WILLIAMS HARMONY EGGSHELL SHERWIN WILLIAMS HARMONY EGGSHELL SHERWIN WILLIAMS HARMONY EGGSHELL	COLOR: ALEUTIAN SW# 6241 COORD WALL PROTECTION COLOR: CAPE BLUE 325 COLOR: BRACING BLUE SW# 6242 COORD WALL PROTECTION COLOR: CAPE BLUE 325 COLOR: BRACING BLUE SW# 6242 COORD WALL PROTECTION COLOR: DANUBE 233 COLOR: SOFT OFF WHITE SW# CUSTOM MATCH HCHD PT10 COORD WALL PROTECTION COLOR: TETON WHITE 517 COLOR: SW STONINGTON BEIGE SW# CUSTOM MATCH HCHD PT11 COORD WALL PROTECTION COLOR: BEIGE 103 EXCEPTION PER SECTION 099100 COLOR: SW STONINGTON BEIGE SW# CUSTOM MATCH HCHD PT114 COLOR: ALMOND 0135 SIZE: 4 1/4" X 4 1/4" INSTALLATION PATTERN: BRICK (REF ELEVATIONS) HEIGHT: 48" AFF UNO (REF ELEVATIONS) GROUT: TEX RITE EPOXY GROUT COLOR: BONE 53 GROUT JOINTS: 1/8" COLOR: ARTISAN BROWN 0144	PALETTE) ACCENT COLOR (TAN & SMOKEY BROWN PALETTES) ACCENT COLOR (TAN & SMOKEY BROWN PALETTES) FIELD COLOR TYP WALL FIELD WALL ACCENT (ALL	PT-9 PT-10 PT-11 PT-12 PT-13 PT-14	Tim Besson (713) 529-6515 sw7403@sherwin.com Roy Perez (832) 567-8856 swrep6143@sherwin.com Tim Besson (713) 529-6515
VP1F VP1G VP1H VS VS1A VS1A VS1C VT VT1A	LATEX NOT USED LATEX LATEX DOOR FRAMES, SEMI-GLOSS PAINT NOT USED NOT USED WALL, TILE CERAMIC TILE	SHERWIN WILLIAMS HARMONY EGGSHELL SHERWIN WILLIAMS HARMONY EGGSHELL SHERWIN WILLIAMS HARMONY EGGSHELL SHERWIN WILLIAMS HARMONY EGGSHELL DAL TILE	COLOR: ALEUTIAN SW# 6241 COORD WALL PROTECTION COLOR: CAPE BLUE 325 COLOR: BRACING BLUE SW# 6242 COORD WALL PROTECTION COLOR: CAPE BLUE 325 COLOR: BRACING BLUE SW# 6242 COORD WALL PROTECTION COLOR: DANUBE 233 COLOR: SOFT OFF WHITE SW# CUSTOM MATCH HCHD PT10 COORD WALL PROTECTION COLOR: TETON WHITE 517 COLOR: SW STONINGTON BEIGE SW# CUSTOM MATCH HCHD PT11 COORD WALL PROTECTION COLOR: BEIGE 103 EXCEPTION PER SECTION 099100 COLOR: SW STONINGTON BEIGE SW# CUSTOM MATCH HCHD PT114 COLOR: SW STONINGTON BEIGE SW# CUSTOM MATCH HCHD PT114 COLOR: ALMOND 0135 SIZE: 4 1/4" X 4 1/4" INSTALLATION PATTERN: BRICK (REF ELEVATIONS) HEIGHT: 48" AFF UNO (REF ELEVATIONS) GROUT: TEX RITE EPOXY GROUT COLOR: BONE 53 GROUT JOINTS: 1/8"	PALETTE) ACCENT COLOR (TAN & SMOKEY BROWN PALETTES) ACCENT COLOR (TAN & SMOKEY BROWN PALETTES) FIELD COLOR TYP WALL FIELD	PT-9 PT-10 PT-11 PT-12 PT-13 PT-14 CT-3	Tim Besson (713) 529-6515 sw7403@sherwin.com Roy Perez (832) 567-8856 swrep6143@sherwin.com Tim Besson (713) 529-6515
VP1F VP1G VP1H VS VS1A VS1A VS1C VT VT1A	LATEX NOT USED LATEX LATEX DOOR FRAMES, SEMI-GLOSS PAINT NOT USED NOT USED WALL, TILE CERAMIC TILE	SHERWIN WILLIAMS HARMONY EGGSHELL SHERWIN WILLIAMS HARMONY EGGSHELL SHERWIN WILLIAMS HARMONY EGGSHELL SHERWIN WILLIAMS HARMONY EGGSHELL DAL TILE	SW# 6179 COORD WALL PROTECTION COLOR: SAVANNAH 522 COLOR: ALEUTIAN SW# 6241 COORD WALL PROTECTION COLOR: CAPE BLUE 325 COLOR: BRACING BLUE SW# 6242 COORD WALL PROTECTION COLOR: DANUBE 233 COLOR: SOFT OFF WHITE SW# CUSTOM MATCH HCHD PT10 COORD WALL PROTECTION COLOR: TETON WHITE 517 COLOR: SW STONINGTON BEIGE SW# CUSTOM MATCH HCHD PT11 COORD WALL PROTECTION COLOR: BEIGE 103 EXCEPTION PER SECTION 099100 COLOR: SW STONINGTON BEIGE SW# CUSTOM MATCH HCHD PT114 COLOR: SW STONINGTON BEIGE SW# CUSTOM MATCH HCHD PT114 COLOR: SW STONINGTON BEIGE SW# CUSTOM MATCH HCHD PT114 COLOR: SW STONINGTON BEIGE SW# CUSTOM MATCH HCHD PT114 COLOR: SW STONINGTON BEIGE SW# CUSTOM MATCH HCHD PT114 COLOR: ALMOND 0135 SIZE: 4 1/4" X 4 1/4" INSTALLATION PATTERN: BRICK (REF ELEVATIONS) GROUT: TEX RITE EPOXY GROUT COLOR: BONE 53 GROUT JOINTS: 1/8" COLOR: ARTISAN BROWN 0144 SIZE: 4 1/4" X 4 1/4" INSTALLATION PATTERN: BRICK (REF ELEVATIONS) HEIGHT: 48" AFF UNO (REF ELEVATIONS) GROUT: TEX RITE EPOXY GROUT COLOR: BONE 53	PALETTE) ACCENT COLOR (TAN & SMOKEY BROWN PALETTES) ACCENT COLOR (TAN & SMOKEY BROWN PALETTES) FIELD COLOR TYP WALL FIELD WALL ACCENT (ALL	PT-9 PT-10 PT-11 PT-12 PT-13 PT-14 CT-3	Tim Besson (713) 529-6515 sw7403@sherwin.com Roy Perez (832) 567-8856 swrep6143@sherwin.com Tim Besson (713) 529-6515
VP1F VP1G VP1H VS VS1A VS1B VS1C VT VT1A	LATEX NOT USED LATEX LATEX DOOR FRAMES, SEMI-GLOSS PAINT NOT USED NOT USED WALL, TILE CERAMIC TILE	SHERWIN WILLIAMS HARMONY EGGSHELL SHERWIN WILLIAMS HARMONY EGGSHELL SHERWIN WILLIAMS HARMONY EGGSHELL SHERWIN WILLIAMS HARMONY EGGSHELL DAL TILE	SW# 6179 COORD WALL PROTECTION COLOR: SAVANNAH 522 COLOR: ALEUTIAN SW# 6241 COORD WALL PROTECTION COLOR: CAPE BLUE 325 COLOR: BRACING BLUE SW# 6242 COORD WALL PROTECTION COLOR: DANUBE 233 COLOR: SOFT OFF WHITE SW# CUSTOM MATCH HCHD PT10 COORD WALL PROTECTION COLOR: TETON WHITE 517 COLOR: SW STONINGTON BEIGE SW# CUSTOM MATCH HCHD PT11 COORD WALL PROTECTION COLOR: BEIGE 103 EXCEPTION PER SECTION 099100 COLOR: SW STONINGTON BEIGE SW# CUSTOM MATCH HCHD PT114 COLOR: SW STONINGTON BEIGE SW# CUSTOM MATCH HCHD PT114 COLOR: ALMOND 0135 SIZE: 4 1/4" X 4 1/4" INSTALLATION PATTERN: BRICK (REF ELEVATIONS) HEIGHT: 48" AFF UNO (REF ELEVATIONS) GROUT: TEX RITE EPOXY GROUT COLOR: BONE 53 GROUT JOINTS: 1/8" COLOR: ARTISAN BROWN 0144 SIZE: 4 1/4" X 4 1/4" INSTALLATION PATTERN: BRICK (REF ELEVATIONS) HEIGHT: 48" AFF UNO (REF ELEVATIONS) GROUT: TEX RITE EPOXY	PALETTE) ACCENT COLOR (TAN & SMOKEY BROWN PALETTES) ACCENT COLOR (TAN & SMOKEY BROWN PALETTES) FIELD COLOR TYP WALL FIELD WALL ACCENT (ALL	PT-9 PT-10 PT-11 PT-12 PT-13 PT-14 CT-3 CT-3	Tim Besson (713) 529-6515 sw7403@sherwin.com Roy Perez (832) 567-8856 swrep6143@sherwin.com Tim Besson (713) 529-6515
VP1F VP1G VP1H VS VS1A VS1B VS1C VT VT1A	LATEX NOT USED LATEX DOOR FRAMES, SEMI-GLOSS PAINT NOT USED NOT USED WALL, TILE CERAMIC TILE CERAMIC TILE	SHERWIN WILLIAMS HARMONY EGGSHELL SHERWIN WILLIAMS HARMONY EGGSHELL SHERWIN WILLIAMS HARMONY EGGSHELL SHERWIN WILLIAMS HARMONY EGGSHELL DAL TILE DAL TILE	SW# 6179 COORD WALL PROTECTION COLOR: SAVANNAH 522 COLOR: ALEUTIAN SW# 6241 COORD WALL PROTECTION COLOR: CAPE BLUE 325 COLOR: BRACING BLUE SW# 6242 COORD WALL PROTECTION COLOR: DANUBE 233 COLOR: SOFT OFF WHITE SW# CUSTOM MATCH HCHD PT10 COORD WALL PROTECTION COLOR: TETON WHITE 517 COLOR: SW STONINGTON BEIGE SW# CUSTOM MATCH HCHD PT11 COORD WALL PROTECTION COLOR: BEIGE 103 EXCEPTION PER SECTION 099100 COLOR: SW STONINGTON BEIGE SW# CUSTOM MATCH HCHD PT114 COLOR: SW STONINGTON BEIGE SW# CUSTOM MATCH HCHD PT114 COLOR: ALMOND 0135 SIZE: 4 1/4" X 4 1/4" INSTALLATION PATTERN: BRICK (REF ELEVATIONS) GROUT: TEX RITE EPOXY GROUT COLOR: BONE 53 GROUT JOINTS: 1/8" COLOR: ARTISAN BROWN 0144 SIZE: 4 1/4" X 4 1/4" INSTALLATION PATTERN: BRICK (REF ELEVATIONS) HEIGHT: 48" AFF UNO (REF ELEVATIONS) GROUT: TEX RITE EPOXY GROUT COLOR: BONE 53 GROUT JOINTS: 1/8" COLOR: NAVY K189 SIZE: 4 1/4" X 4 1/4" INSTALLATION PATTERN: BRICK (REF ELEVATIONS) HEIGHT: 48" AFF UNO (REF ELEVATIONS) HISTALLATION PATTERN: BRICK (REF ELEVATIONS)	PALETTE) ACCENT COLOR (TAN & SMOKEY BROWN PALETTES) ACCENT COLOR (TAN & SMOKEY BROWN PALETTES) FIELD COLOR TYP WALL FIELD WALL ACCENT (ALL PALETTES)	PT-9 PT-10 PT-11 PT-12 PT-13 PT-14 CT-3 G-4 CT-8 G-4 CT-9	Tim Besson (713) 529-6515 sw7403@sherwin.com Roy Perez (832) 567-8856 swrep6143@sherwin.com Tim Besson (713) 529-6515
VP1F VP1G VP1H VS VS1A VS1B VS1C VT VT1A	LATEX NOT USED LATEX DOOR FRAMES, SEMI-GLOSS PAINT NOT USED NOT USED WALL, TILE CERAMIC TILE CERAMIC TILE	SHERWIN WILLIAMS HARMONY EGGSHELL SHERWIN WILLIAMS HARMONY EGGSHELL SHERWIN WILLIAMS HARMONY EGGSHELL SHERWIN WILLIAMS HARMONY EGGSHELL DAL TILE DAL TILE	SW# 6179 COORD WALL PROTECTION COLOR: SAVANNAH 522 COLOR: ALEUTIAN SW# 6241 COORD WALL PROTECTION COLOR: CAPE BLUE 325 COLOR: BRACING BLUE SW# 6242 COORD WALL PROTECTION COLOR: DANUBE 233 COLOR: SOFT OFF WHITE SW# CUSTOM MATCH HCHD PT10 COORD WALL PROTECTION COLOR: TETON WHITE 517 COLOR: SW STONINGTON BEIGE SW# CUSTOM MATCH HCHD PT11 COORD WALL PROTECTION COLOR: BEIGE 103 EXCEPTION PER SECTION 099100 COLOR: ALMOND 0135 SIZE: 4 1/4" X 4 1/4" INSTALLATION PATTERN: BRICK (REF ELEVATIONS) GROUT: TEX RITE EPOXY GROUT COLOR: BONE 53 GROUT JOINTS: 1/8" COLOR: ARTISAN BROWN 0144 SIZE: 4 1/4" X 4 1/4" INSTALLATION PATTERN: BRICK (REF ELEVATIONS) HEIGHT: 48" AFF UNO (REF ELEVATIONS) GROUT: TEX RITE EPOXY GROUT COLOR: BONE 53 GROUT JOINTS: 1/8" COLOR: ARTISAN BROWN 0144 SIZE: 4 1/4" X 4 1/4" INSTALLATION PATTERN: BRICK (REF ELEVATIONS) HEIGHT: 48" AFF UNO (REF ELEVATIONS) GROUT: TEX RITE EPOXY GROUT COLOR: BONE 53 GROUT JOINTS: 1/8" COLOR: NAVY K189 SIZE: 4 1/4" X 4 1/4" INSTALLATION PATTERN: BRICK (REF ELEVATIONS) HEIGHT: 48" AFF UNO (REF ELEVATIONS) GROUT: TEX RITE EPOXY GROUT COLOR: BONE 53 GROUT JOINTS: 1/8" COLOR: NAVY K189 SIZE: 4 1/4" X 4 1/4" INSTALLATION PATTERN: BRICK (REF ELEVATIONS) HEIGHT: 48" AFF UNO (REF ELEVATIONS) GROUT: TEX RITE EPOXY GROUT COLOR: BONE 53 GROUT: TEX RITE EPOXY GROUT COLOR: BONE 53	PALETTE) ACCENT COLOR (TAN & SMOKEY BROWN PALETTES) ACCENT COLOR (TAN & SMOKEY BROWN PALETTES) FIELD COLOR TYP WALL FIELD WALL ACCENT (ALL PALETTES)	PT-9 PT-10 PT-11 PT-12 PT-13 PT-14 CT-3 G-4 CT-8	Tim Besson (713) 529-6515 sw7403@sherwin.com Roy Perez (832) 567-8856 swrep6143@sherwin.com Tim Besson (713) 529-6515
WP1E WP1G WP1H WS1A WS1A WS1A WS1A WT1A WT1A	LATEX NOT USED LATEX DOOR FRAMES, SEMI-GLOSS PAINT NOT USED NOT USED WALL, TILE CERAMIC TILE CERAMIC TILE	SHERWIN WILLIAMS HARMONY EGGSHELL SHERWIN WILLIAMS HARMONY EGGSHELL SHERWIN WILLIAMS HARMONY EGGSHELL SHERWIN WILLIAMS HARMONY EGGSHELL DAL TILE DAL TILE	SW# 6179 COORD WALL PROTECTION COLOR: SAVANNAH 522 COLOR: ALEUTIAN SW# 6241 COLOR: BRACING BLUE SW# 6242 COORD WALL PROTECTION COLOR: CAPE BLUE 325 COLOR: SOFT OFF WHITE SW# 6242 COORD WALL PROTECTION COLOR: DANUBE 233 COLOR: SOFT OFF WHITE SW# CUSTOM MATCH HCHD PT10 COORD WALL PROTECTION COLOR: TETON WHITE 517 COLOR: SW STONINGTON BEIGE SW# CUSTOM MATCH HCHD PT11 COORD WALL PROTECTION COLOR: BEIGE 103 EXCEPTION PER SECTION 099100 COLOR: SW STONINGTON BEIGE SW# CUSTOM MATCH HCHD PT114 COLOR: ALMOND 0135 SIZE: 4 1/4" X 4 1/4" INSTALLATION PATTERN: BRICK (REF ELEVATIONS) HEIGHT: 48" AFF UNO (REF ELEVATIONS) GROUT: TEX RITE EPOXY GROUT COLOR: BONE 53 GROUT JOINTS: 1/8" COLOR: ARTISAN BROWN 0144 SIZE: 4 1/4" X 4 1/4" INSTALLATION PATTERN: BRICK (REF ELEVATIONS) HEIGHT: 48" AFF UNO (REF ELEVATIONS) GROUT: TEX RITE EPOXY GROUT COLOR: BONE 53 GROUT JOINTS: 1/8" COLOR: NAVY K189 SIZE: 4 1/4" X 4 1/4" INSTALLATION PATTERN: BRICK (REF ELEVATIONS) HEIGHT: 48" AFF UNO (REF ELEVATIONS) GROUT: TEX RITE EPOXY GROUT COLOR: BONE 53 GROUT JOINTS: 1/8" COLOR: NAVY K189 SIZE: 4 1/4" X 4 1/4" INSTALLATION PATTERN: BRICK (REF ELEVATIONS) HEIGHT: 48" AFF UNO (REF ELEVATIONS) GROUT: TEX RITE EPOXY GROUT COLOR: BONE 53 GROUT JOINTS: 1/8" COLOR: GARDEN SPOT 0141 SIZE: 4 1/4" X 4 1/4"	PALETTE) ACCENT COLOR (TAN & SMOKEY BROWN PALETTES) ACCENT COLOR (TAN & SMOKEY BROWN PALETTES) FIELD COLOR TYP WALL FIELD WALL ACCENT (ALL PALETTES)	PT-9 PT-10 PT-11 PT-12 PT-13 PT-14 CT-3 G-4 CT-8 G-4 CT-9	Tim Besson (713) 529-6515 sw7403@sherwin.com Roy Perez (832) 567-8856 swrep6143@sherwin.com Tim Besson (713) 529-6515
WP1F WP1G WP1H WS WS1A WS1B WS1C WT WT1A	LATEX NOT USED LATEX LATEX DOOR FRAMES, SEMI-GLOSS PAINT NOT USED WALL, TILE CERAMIC TILE CERAMIC TILE CERAMIC TILE	SHERWIN WILLIAMS HARMONY EGGSHELL SHERWIN WILLIAMS HARMONY EGGSHELL SHERWIN WILLIAMS HARMONY EGGSHELL DAL TILE DAL TILE DAL TILE	SW# 6179 COORD WALL PROTECTION COLOR: SAVANNAH 522 COLOR: ALEUTIAN SW# 6241 COLOR: BRACING BLUE SW# 6242 COORD WALL PROTECTION COLOR: CAPE BLUE 325 COLOR: SOFT OFF WHITE SW# 6242 COORD WALL PROTECTION COLOR: DANUBE 233 COLOR: SOFT OFF WHITE SW# CUSTOM MATCH HCHD PT10 COORD WALL PROTECTION COLOR: TETON WHITE 517 COLOR: SW STONINGTON BEIGE SW# CUSTOM MATCH HCHD PT11 COORD WALL PROTECTION COLOR: BEIGE 103 EXCEPTION PER SECTION 099100 COLOR: SW STONINGTON BEIGE SW# CUSTOM MATCH HCHD PT114 COLOR: SW STONINGTON BEIGE SW# CUSTOM MATCH HCHD PT114 COLOR: ALMOND 0135 SIZE: 4 1/4" X 4 1/4" INSTALLATION PATTERN: BRICK (REF ELEVATIONS) GROUT: TEX RITE EPOXY GROUT COLOR: BONE 53 GROUT JOINTS: 1/8" COLOR: ARTISAN BROWN 0144 SIZE: 4 1/4" X 4 1/4" INSTALLATION PATTERN: BRICK (REF ELEVATIONS) HEIGHT: 48" AFF UNO (REF ELEVATIONS) GROUT: TEX RITE EPOXY GROUT COLOR: BONE 53 GROUT JOINTS: 1/8" COLOR: NAVY K189 SIZE: 4 1/4" X 4 1/4" INSTALLATION PATTERN: BRICK (REF ELEVATIONS) HEIGHT: 48" AFF UNO (REF ELEVATIONS) GROUT: TEX RITE EPOXY GROUT COLOR: BONE 53 GROUT JOINTS: 1/8" COLOR: NAVY K189 SIZE: 4 1/4" X 4 1/4" INSTALLATION PATTERN: BRICK (REF ELEVATIONS) HEIGHT: 48" AFF UNO (REF ELEVATIONS) GROUT: TEX RITE EPOXY GROUT COLOR: BONE 53 GROUT JOINTS: 1/8" COLOR: GARDEN SPOT 0141	PALETTE) ACCENT COLOR (TAN & SMOKEY BROWN PALETTES) ACCENT COLOR (TAN & SMOKEY BROWN PALETTES) FIELD COLOR TYP WALL FIELD WALL ACCENT (ALL PALETTES) WALL ACCENT (ALL PALETTES)	PT-9 PT-10 PT-11 PT-12 PT-13 PT-14 CT-3 G-4 CT-8 G-4 CT-9	Tim Besson (713) 529-6515 sw7403@sherwin.com Roy Perez (832) 567-8856 swrep6143@sherwin.com Tim Besson (713) 529-6515

	MATERIAL	MANUFACTURER	DESCRIPTION	NOTES	HHS CODE	CONTACT
V-1	COMBINATION	N/A	COMBINATION OF WP1H WITH WT1A, WT1B, AND WT1C	TILE FULL WALL AT WET		
V-2	COMBINATION	N/A	COMBINATION OF WP1H WITH WT1A, WT1B, AND WT1B	WALL(S) TILE FULL WALL AT WET		
:A	CEILING, ACOUSTICAL TILE			WALL(S)		
A1A	ACOUSTICAL CEILING PANEL	ARMSTRONG	PATTERN: 584 CIRRUS		1	
			SIZE: 24" X 24" X 3/4" COLOR/PROFILE: WHITE/ANGLED TEGULAR			
			GRID: 15/16" PRELUDE XL EXPOSED TEE			
			GRID COLOR: WHITE			
			BRACING: INCOMPLIANCE WITH SEISMIC SITE CLASS C FIRE RATING: CLASS A			
			FLAME SPREAD: LESS THAN 25			
P	CEILING, FLAT PAINTED GYP BOARI	<u> </u>	SMOKE DEVELOPED: LESS THAN 50 EXCEPTION PER SECTION 099100			
P1A	LATEX	SHERWIN WILLIAMS	COLOR: CEILING WHITE 24		PT-29	Roy Perez
P1B	LATEX	HARMONY FLAT SHERWIN WILLIAMS	SW# CUSTOM MATCH HCHD PT29 COLOR: MATCH WP1G			(832) 567-8856 swrep6143@sherwii
PID	LATEX	HARMONY FLAT	COLOR: MATCH WP1G			swrep6145@snerwi
P1C	LATEX	SHERWIN WILLIAMS HARMONY FLAT	COLOR: MATCH WP1H			Tim Besson
		HARMONT FLAT				(713) 529-6515
-1	COMBINATION	N/A	COMBINATION OF CA1A AND CP1B			$\overline{\Box}$
:-2 :-3	COMBINATION COMBINATION	N/A N/A	COMBINATION OF CA1A AND CP1C COMBINATION OF CA1A AND CP1A			\dashv
5	COMBINATION	1577	COMBINATION OF CATA AND CFTA			
MILLWOR						
ИS ИS1A	MILLWORK, SOLID SURFACE SOLID POLYMER	DUPONT	PRODUCT: CORIAN	I	SS-5	
NJIA	SOCIOT OCTIVICIO	BOTON	COLOR: AURORA		33-3	
			THICKNESS: 1/2"			
			EDGE: MITRE-FOLD DROP FIRE RATING: CLASS A			
ИS1B	SOLID POLYMER	DUPONT	PRODUCT: CORIAN		SS-7	
			COLOR: WILLOW THICKNESS: 1/2"			
			EDGE: MITRE-FOLD DROP			
ЛS1C	SOLID POLYMER	FORMICA	FIRE RATING: CLASS A PRODUCT: FORMICA		SS-8	\dashv
NSIC	SOLID POLYMER	FORMICA	COLOR: RIVER ROCK MOSIAC 656		55-8	
			THICKNESS: 1/2"			
			EDGE: MITRE-FOLD DROP FIRE RATING: CLASS A			
ИL	MILLWORK, HIGH-PRESSURE DECO					
ИL1	HIGH-PRESSURE LAMINATE	WILSONART	FINISH: #38 FINE VELVET TEXTURE			
			SHEET SIZE: 4' X 8' GRAIN DIRECTION: VERTICAL, UNO ON ELEVATIONS			
			FABRICATE OUTSIDE CORNERS WITH MITRED EDGE			
			FLAME SPREAD: LESS THAN 50 SMOLE CHAMBER TEST: ASTM E-662 (LESS THAN 450)			
ЛL1A			PATTERN/COLOR: 7919-38 AMBER CHERRY	TYP. BASE/UPPERS	PL-4	
ИL1B ИL1C			PATTERN/COLOR: D92-60 DOVE GRAY NOT USED		PL-1	
ИL1D			NOT USED			
/L1E			PATTERN/COLOR: D331-60 SAND		PL-10	
VL1F			PATTERN/COLOR: 4143-60 NEUTRAL GLACE PATTERN/COLOR: D30-60 NATURAL ALMOND		PL-16	
VILIG	1	I	FATTERNY COLOR. D30-00 NATORAL ALMOND		PL-17	
					PL-17	
	COMBINATION	N/A	ML1A ON VERTICAL SURFACES, ML1B PLASTIC LAMINATE	GREEN PALETTE	PL-17	
	COMBINATION	N/A		GREEN PALETTE	Pt-17	
ML1G M-1			ML1A ON VERTICAL SURFACES, ML1B PLASTIC LAMINATE COUNTERTOP, MS1B SOLID POLYMER TRANSACTION COUNTER. PROVIDE 4" WIRE PULL HARDWARE (TYP.)		PL-17	
И-1	COMBINATION	N/A	ML1A ON VERTICAL SURFACES, ML1B PLASTIC LAMINATE COUNTERTOP, MS1B SOLID POLYMER TRANSACTION	GREEN PALETTE TAN PALETTE	Pt-17	
И-1			ML1A ON VERTICAL SURFACES, ML1B PLASTIC LAMINATE COUNTERTOP, MS1B SOLID POLYMER TRANSACTION COUNTER. PROVIDE 4" WIRE PULL HARDWARE (TYP.) ML1A ON VERTICAL SURFACES, ML1E PLASTIC LAMINATE		PL-17	
л-1 л-2			ML1A ON VERTICAL SURFACES, ML1B PLASTIC LAMINATE COUNTERTOP, MS1B SOLID POLYMER TRANSACTION COUNTER. PROVIDE 4" WIRE PULL HARDWARE (TYP.) ML1A ON VERTICAL SURFACES, ML1E PLASTIC LAMINATE COUNTERTOP, MS1A SOLID POLYMER TRANSACTION		PL-17	
л-1 л-2	COMBINATION	N/A	ML1A ON VERTICAL SURFACES, ML1B PLASTIC LAMINATE COUNTERTOP, MS1B SOLID POLYMER TRANSACTION COUNTER. PROVIDE 4" WIRE PULL HARDWARE (TYP.) ML1A ON VERTICAL SURFACES, ML1E PLASTIC LAMINATE COUNTERTOP, MS1A SOLID POLYMER TRANSACTION COUNTER. PROVIDE 4" WIRE PULL HARDWARE (TYP.) ML1A PLASTIC LAMINATE ON VERTICAL SURFACES, ML1E ON ALL OTHER SURFACES. PROVIDE 4" WIRE PULL		PL-17	
л-1 л-2 л-3	COMBINATION	N/A	ML1A ON VERTICAL SURFACES, ML1B PLASTIC LAMINATE COUNTERTOP, MS1B SOLID POLYMER TRANSACTION COUNTER. PROVIDE 4" WIRE PULL HARDWARE (TYP.) ML1A ON VERTICAL SURFACES, ML1E PLASTIC LAMINATE COUNTERTOP, MS1A SOLID POLYMER TRANSACTION COUNTER. PROVIDE 4" WIRE PULL HARDWARE (TYP.) ML1A PLASTIC LAMINATE ON VERTICAL SURFACES, ML1E ON ALL OTHER SURFACES. PROVIDE 4" WIRE PULL HARDWARE (TYP.)	TAN PALETTE	PL-17	
М-1 М-2 М-3	COMBINATION	N/A	ML1A ON VERTICAL SURFACES, ML1B PLASTIC LAMINATE COUNTERTOP, MS1B SOLID POLYMER TRANSACTION COUNTER. PROVIDE 4" WIRE PULL HARDWARE (TYP.) ML1A ON VERTICAL SURFACES, ML1E PLASTIC LAMINATE COUNTERTOP, MS1A SOLID POLYMER TRANSACTION COUNTER. PROVIDE 4" WIRE PULL HARDWARE (TYP.) ML1A PLASTIC LAMINATE ON VERTICAL SURFACES, ML1E ON ALL OTHER SURFACES. PROVIDE 4" WIRE PULL HARDWARE (TYP.) ML1A ON VERTICAL SURFACES, ML1G PLASTIC LAMINATE COUNTERTOP, MS1C SOLID POLYMER TRANSACTION		PL-17	
л-1 л-2 л-3	COMBINATION	N/A	ML1A ON VERTICAL SURFACES, ML1B PLASTIC LAMINATE COUNTERTOP, MS1B SOLID POLYMER TRANSACTION COUNTER. PROVIDE 4" WIRE PULL HARDWARE (TYP.) ML1A ON VERTICAL SURFACES, ML1E PLASTIC LAMINATE COUNTERTOP, MS1A SOLID POLYMER TRANSACTION COUNTER. PROVIDE 4" WIRE PULL HARDWARE (TYP.) ML1A PLASTIC LAMINATE ON VERTICAL SURFACES, ML1E ON ALL OTHER SURFACES. PROVIDE 4" WIRE PULL HARDWARE (TYP.) ML1A ON VERTICAL SURFACES, ML1G PLASTIC LAMINATE	TAN PALETTE	PL-17	
л-1 л-2 л-3	COMBINATION	N/A	ML1A ON VERTICAL SURFACES, ML1B PLASTIC LAMINATE COUNTERTOP, MS1B SOLID POLYMER TRANSACTION COUNTER. PROVIDE 4" WIRE PULL HARDWARE (TYP.) ML1A ON VERTICAL SURFACES, ML1E PLASTIC LAMINATE COUNTERTOP, MS1A SOLID POLYMER TRANSACTION COUNTER. PROVIDE 4" WIRE PULL HARDWARE (TYP.) ML1A PLASTIC LAMINATE ON VERTICAL SURFACES, ML1E ON ALL OTHER SURFACES. PROVIDE 4" WIRE PULL HARDWARE (TYP.) ML1A ON VERTICAL SURFACES, ML1G PLASTIC LAMINATE COUNTERTOP, MS1C SOLID POLYMER TRANSACTION COUNTER. PROVIDE 4" WIRE PULL HARDWARE (TYP.)	TAN PALETTE	PL-17	
л-1 л-2 л-3	COMBINATION COMBINATION COMBINATION	N/A N/A N/A	ML1A ON VERTICAL SURFACES, ML1B PLASTIC LAMINATE COUNTERTOP, MS1B SOLID POLYMER TRANSACTION COUNTER. PROVIDE 4" WIRE PULL HARDWARE (TYP.) ML1A ON VERTICAL SURFACES, ML1E PLASTIC LAMINATE COUNTERTOP, MS1A SOLID POLYMER TRANSACTION COUNTER. PROVIDE 4" WIRE PULL HARDWARE (TYP.) ML1A PLASTIC LAMINATE ON VERTICAL SURFACES, ML1E ON ALL OTHER SURFACES. PROVIDE 4" WIRE PULL HARDWARE (TYP.) ML1A ON VERTICAL SURFACES, ML1G PLASTIC LAMINATE COUNTERTOP, MS1C SOLID POLYMER TRANSACTION COUNTER. PROVIDE 4" WIRE PULL HARDWARE (TYP.) ML1A PLASTIC LAMINATE ON VERTICAL SURFACES, MS1A SOLID POLYMER COUNTERTOP. PROVIDE CONCEALED LED	TAN PALETTE SMOKEY BROWN PALETTE TAN PALETTE	PL-17	
л-1 л-2 л-3	COMBINATION COMBINATION COMBINATION	N/A N/A N/A	ML1A ON VERTICAL SURFACES, ML1B PLASTIC LAMINATE COUNTERTOP, MS1B SOLID POLYMER TRANSACTION COUNTER. PROVIDE 4" WIRE PULL HARDWARE (TYP.) ML1A ON VERTICAL SURFACES, ML1E PLASTIC LAMINATE COUNTERTOP, MS1A SOLID POLYMER TRANSACTION COUNTER. PROVIDE 4" WIRE PULL HARDWARE (TYP.) ML1A PLASTIC LAMINATE ON VERTICAL SURFACES, ML1E ON ALL OTHER SURFACES. PROVIDE 4" WIRE PULL HARDWARE (TYP.) ML1A ON VERTICAL SURFACES, ML1G PLASTIC LAMINATE COUNTERTOP, MS1C SOLID POLYMER TRANSACTION COUNTER. PROVIDE 4" WIRE PULL HARDWARE (TYP.) ML1A PLASTIC LAMINATE ON VERTICAL SURFACES, MS1A SOLID POLYMER COUNTERTOP. PROVIDE CONCEALED LED TASK LIGHTING UNDER UPPER CABINETS. PROVIDE 4" WIRE	TAN PALETTE SMOKEY BROWN PALETTE TAN PALETTE	PL-17	
л-1 л-2 л-3	COMBINATION COMBINATION COMBINATION	N/A N/A N/A	ML1A ON VERTICAL SURFACES, ML1B PLASTIC LAMINATE COUNTERTOP, MS1B SOLID POLYMER TRANSACTION COUNTER. PROVIDE 4" WIRE PULL HARDWARE (TYP.) ML1A ON VERTICAL SURFACES, ML1E PLASTIC LAMINATE COUNTERTOP, MS1A SOLID POLYMER TRANSACTION COUNTER. PROVIDE 4" WIRE PULL HARDWARE (TYP.) ML1A PLASTIC LAMINATE ON VERTICAL SURFACES, ML1E ON ALL OTHER SURFACES. PROVIDE 4" WIRE PULL HARDWARE (TYP.) ML1A ON VERTICAL SURFACES, ML1G PLASTIC LAMINATE COUNTERTOP, MS1C SOLID POLYMER TRANSACTION COUNTER. PROVIDE 4" WIRE PULL HARDWARE (TYP.) ML1A PLASTIC LAMINATE ON VERTICAL SURFACES, MS1A SOLID POLYMER COUNTERTOP. PROVIDE CONCEALED LED	TAN PALETTE SMOKEY BROWN PALETTE TAN PALETTE	PL-17	
л-1 л-2 л-3	COMBINATION COMBINATION COMBINATION COMBINATION	N/A N/A N/A	ML1A ON VERTICAL SURFACES, ML1B PLASTIC LAMINATE COUNTERTOP, MS1B SOLID POLYMER TRANSACTION COUNTER. PROVIDE 4" WIRE PULL HARDWARE (TYP.) ML1A ON VERTICAL SURFACES, ML1E PLASTIC LAMINATE COUNTERTOP, MS1A SOLID POLYMER TRANSACTION COUNTER. PROVIDE 4" WIRE PULL HARDWARE (TYP.) ML1A PLASTIC LAMINATE ON VERTICAL SURFACES, ML1E ON ALL OTHER SURFACES. PROVIDE 4" WIRE PULL HARDWARE (TYP.) ML1A ON VERTICAL SURFACES, ML1G PLASTIC LAMINATE COUNTERTOP, MS1C SOLID POLYMER TRANSACTION COUNTER. PROVIDE 4" WIRE PULL HARDWARE (TYP.) ML1A PLASTIC LAMINATE ON VERTICAL SURFACES, MS1A SOLID POLYMER COUNTERTOP. PROVIDE CONCEALED LED TASK LIGHTING UNDER UPPER CABINETS. PROVIDE 4" WIRE PULL HARDWARE (TYP.) ML1A PLASTIC LAMINATE ON VERTICAL SURFACES, MS1A SOLID POLYMER ON ALL OTHER SURFACES. PROVIDE 4"	TAN PALETTE SMOKEY BROWN PALETTE TAN PALETTE	PL-17	
M-1 M-2 M-3 M-4	COMBINATION COMBINATION COMBINATION COMBINATION	N/A N/A N/A	ML1A ON VERTICAL SURFACES, ML1B PLASTIC LAMINATE COUNTERTOP, MS1B SOLID POLYMER TRANSACTION COUNTER. PROVIDE 4" WIRE PULL HARDWARE (TYP.) ML1A ON VERTICAL SURFACES, ML1E PLASTIC LAMINATE COUNTERTOP, MS1A SOLID POLYMER TRANSACTION COUNTER. PROVIDE 4" WIRE PULL HARDWARE (TYP.) ML1A PLASTIC LAMINATE ON VERTICAL SURFACES, ML1E ON ALL OTHER SURFACES. PROVIDE 4" WIRE PULL HARDWARE (TYP.) ML1A ON VERTICAL SURFACES, ML1G PLASTIC LAMINATE COUNTERTOP, MS1C SOLID POLYMER TRANSACTION COUNTER. PROVIDE 4" WIRE PULL HARDWARE (TYP.) ML1A PLASTIC LAMINATE ON VERTICAL SURFACES, MS1A SOLID POLYMER COUNTERTOP. PROVIDE CONCEALED LED TASK LIGHTING UNDER UPPER CABINETS. PROVIDE 4" WIRE PULL HARDWARE (TYP.) ML1A PLASTIC LAMINATE ON VERTICAL SURFACES, MS1A SOLID POLYMER COUNTERTOP. PROVIDE CONCEALED LED TASK LIGHTING UNDER UPPER CABINETS. PROVIDE 4" WIRE PULL HARDWARE (TYP.)	TAN PALETTE SMOKEY BROWN PALETTE TAN PALETTE	PL-17	
л-1 л-2 л-3 л-4	COMBINATION COMBINATION COMBINATION COMBINATION	N/A N/A N/A N/A	ML1A ON VERTICAL SURFACES, ML1B PLASTIC LAMINATE COUNTERTOP, MS1B SOLID POLYMER TRANSACTION COUNTER. PROVIDE 4" WIRE PULL HARDWARE (TYP.) ML1A ON VERTICAL SURFACES, ML1E PLASTIC LAMINATE COUNTERTOP, MS1A SOLID POLYMER TRANSACTION COUNTER. PROVIDE 4" WIRE PULL HARDWARE (TYP.) ML1A PLASTIC LAMINATE ON VERTICAL SURFACES, ML1E ON ALL OTHER SURFACES. PROVIDE 4" WIRE PULL HARDWARE (TYP.) ML1A ON VERTICAL SURFACES, ML1G PLASTIC LAMINATE COUNTERTOP, MS1C SOLID POLYMER TRANSACTION COUNTER. PROVIDE 4" WIRE PULL HARDWARE (TYP.) ML1A PLASTIC LAMINATE ON VERTICAL SURFACES, MS1A SOLID POLYMER COUNTERTOP. PROVIDE CONCEALED LED TASK LIGHTING UNDER UPPER CABINETS. PROVIDE 4" WIRE PULL HARDWARE (TYP.) ML1A PLASTIC LAMINATE ON VERTICAL SURFACES, MS1A SOLID POLYMER ON ALL OTHER SURFACES. PROVIDE 4" WIRE PULL HARDWARE (TYP.) ML1A PLASTIC LAMINATE ON VERTICAL SURFACES, MS1A SOLID POLYMER ON ALL OTHER SURFACES. PROVIDE 4" WIRE PULL HARDWARE (TYP.)	TAN PALETTE SMOKEY BROWN PALETTE TAN PALETTE TAN PALETTE GREEN PALETTE	Pt-17	
M-1 M-2 M-3 M-4	COMBINATION COMBINATION COMBINATION COMBINATION	N/A N/A N/A N/A	ML1A ON VERTICAL SURFACES, ML1B PLASTIC LAMINATE COUNTERTOP, MS1B SOLID POLYMER TRANSACTION COUNTER. PROVIDE 4" WIRE PULL HARDWARE (TYP.) ML1A ON VERTICAL SURFACES, ML1E PLASTIC LAMINATE COUNTERTOP, MS1A SOLID POLYMER TRANSACTION COUNTER. PROVIDE 4" WIRE PULL HARDWARE (TYP.) ML1A PLASTIC LAMINATE ON VERTICAL SURFACES, ML1E ON ALL OTHER SURFACES. PROVIDE 4" WIRE PULL HARDWARE (TYP.) ML1A ON VERTICAL SURFACES, ML1G PLASTIC LAMINATE COUNTERTOP, MS1C SOLID POLYMER TRANSACTION COUNTER. PROVIDE 4" WIRE PULL HARDWARE (TYP.) ML1A PLASTIC LAMINATE ON VERTICAL SURFACES, MS1A SOLID POLYMER COUNTERTOP. PROVIDE CONCEALED LED TASK LIGHTING UNDER UPPER CABINETS. PROVIDE 4" WIRE PULL HARDWARE (TYP.) ML1A PLASTIC LAMINATE ON VERTICAL SURFACES, MS1A SOLID POLYMER ON ALL OTHER SURFACES. PROVIDE 4" WIRE PULL HARDWARE (TYP.) ML1A PLASTIC LAMINATE ON VERTICAL SURFACES, MS1A SOLID POLYMER ON ALL OTHER SURFACES. PROVIDE 4" WIRE PULL HARDWARE (TYP.) ML1A PLASTIC LAMINATE ON VERTICAL SURFACES, MS1B SOLID POLYMER COUNTERTOP. PROVIDE CONCEALED LED TASK LIGHTING UNDER UPPER CABINETS. PROVIDE 4" WIRE	TAN PALETTE SMOKEY BROWN PALETTE TAN PALETTE TAN PALETTE GREEN PALETTE	Pt-17	
л-1 л-2 л-3 л-4 л-5	COMBINATION COMBINATION COMBINATION COMBINATION	N/A N/A N/A N/A	ML1A ON VERTICAL SURFACES, ML1B PLASTIC LAMINATE COUNTERTOP, MS1B SOLID POLYMER TRANSACTION COUNTER. PROVIDE 4" WIRE PULL HARDWARE (TYP.) ML1A ON VERTICAL SURFACES, ML1E PLASTIC LAMINATE COUNTERTOP, MS1A SOLID POLYMER TRANSACTION COUNTER. PROVIDE 4" WIRE PULL HARDWARE (TYP.) ML1A PLASTIC LAMINATE ON VERTICAL SURFACES, ML1E ON ALL OTHER SURFACES. PROVIDE 4" WIRE PULL HARDWARE (TYP.) ML1A ON VERTICAL SURFACES, ML1G PLASTIC LAMINATE COUNTERTOP, MS1C SOLID POLYMER TRANSACTION COUNTER. PROVIDE 4" WIRE PULL HARDWARE (TYP.) ML1A PLASTIC LAMINATE ON VERTICAL SURFACES, MS1A SOLID POLYMER COUNTERTOP. PROVIDE CONCEALED LED TASK LIGHTING UNDER UPPER CABINETS. PROVIDE 4" WIRE PULL HARDWARE (TYP.) ML1A PLASTIC LAMINATE ON VERTICAL SURFACES, MS1A SOLID POLYMER ON ALL OTHER SURFACES. PROVIDE 4" WIRE PULL HARDWARE (TYP.) ML1A PLASTIC LAMINATE ON VERTICAL SURFACES, MS1B SOLID POLYMER COUNTERTOP. PROVIDE CONCEALED LED TASK LIGHTING UNDER UPPER CABINETS. PROVIDE 4" WIRE PULL HARDWARE (TYP.) ML1A PLASTIC LAMINATE ON VERTICAL SURFACES, MS1B SOLID POLYMER COUNTERTOP. PROVIDE CONCEALED LED TASK LIGHTING UNDER UPPER CABINETS. PROVIDE 4" WIRE PULL HARDWARE (TYP.)	TAN PALETTE SMOKEY BROWN PALETTE TAN PALETTE TAN PALETTE GREEN PALETTE	PL-17	
M-1 M-2 M-3 M-4 M-5	COMBINATION COMBINATION COMBINATION COMBINATION COMBINATION	N/A N/A N/A N/A N/A N/A	ML1A ON VERTICAL SURFACES, ML1B PLASTIC LAMINATE COUNTERTOP, MS1B SOLID POLYMER TRANSACTION COUNTER. PROVIDE 4" WIRE PULL HARDWARE (TYP.) ML1A ON VERTICAL SURFACES, ML1E PLASTIC LAMINATE COUNTERTOP, MS1A SOLID POLYMER TRANSACTION COUNTER. PROVIDE 4" WIRE PULL HARDWARE (TYP.) ML1A PLASTIC LAMINATE ON VERTICAL SURFACES, ML1E ON ALL OTHER SURFACES. PROVIDE 4" WIRE PULL HARDWARE (TYP.) ML1A ON VERTICAL SURFACES, ML1G PLASTIC LAMINATE COUNTERTOP, MS1C SOLID POLYMER TRANSACTION COUNTER. PROVIDE 4" WIRE PULL HARDWARE (TYP.) ML1A PLASTIC LAMINATE ON VERTICAL SURFACES, MS1A SOLID POLYMER COUNTERTOP. PROVIDE CONCEALED LED TASK LIGHTING UNDER UPPER CABINETS. PROVIDE 4" WIRE PULL HARDWARE (TYP.) ML1A PLASTIC LAMINATE ON VERTICAL SURFACES, MS1A SOLID POLYMER ON ALL OTHER SURFACES. PROVIDE 4" WIRE PULL HARDWARE (TYP.) ML1A PLASTIC LAMINATE ON VERTICAL SURFACES, MS1B SOLID POLYMER COUNTERTOP. PROVIDE CONCEALED LED TASK LIGHTING UNDER UPPER CABINETS. PROVIDE 4" WIRE PULL HARDWARE (TYP.) ML1A PLASTIC LAMINATE ON VERTICAL SURFACES, MS1B SOLID POLYMER COUNTERTOP. PROVIDE CONCEALED LED TASK LIGHTING UNDER UPPER CABINETS. PROVIDE 4" WIRE PULL HARDWARE (TYP.)	TAN PALETTE SMOKEY BROWN PALETTE TAN PALETTE TAN PALETTE GREEN PALETTE	PL-17	
л-1 л-2 л-3 л-4 л-5	COMBINATION COMBINATION COMBINATION COMBINATION COMBINATION	N/A N/A N/A N/A N/A N/A	ML1A ON VERTICAL SURFACES, ML1B PLASTIC LAMINATE COUNTERTOP, MS1B SOLID POLYMER TRANSACTION COUNTER. PROVIDE 4" WIRE PULL HARDWARE (TYP.) ML1A ON VERTICAL SURFACES, ML1E PLASTIC LAMINATE COUNTERTOP, MS1A SOLID POLYMER TRANSACTION COUNTER. PROVIDE 4" WIRE PULL HARDWARE (TYP.) ML1A PLASTIC LAMINATE ON VERTICAL SURFACES, ML1E ON ALL OTHER SURFACES. PROVIDE 4" WIRE PULL HARDWARE (TYP.) ML1A ON VERTICAL SURFACES, ML1G PLASTIC LAMINATE COUNTERTOP, MS1C SOLID POLYMER TRANSACTION COUNTER. PROVIDE 4" WIRE PULL HARDWARE (TYP.) ML1A PLASTIC LAMINATE ON VERTICAL SURFACES, MS1A SOLID POLYMER COUNTERTOP. PROVIDE CONCEALED LED TASK LIGHTING UNDER UPPER CABINETS. PROVIDE 4" WIRE PULL HARDWARE (TYP.) ML1A PLASTIC LAMINATE ON VERTICAL SURFACES, MS1A SOLID POLYMER ON ALL OTHER SURFACES. PROVIDE 4" WIRE PULL HARDWARE (TYP.) ML1A PLASTIC LAMINATE ON VERTICAL SURFACES, MS1B SOLID POLYMER COUNTERTOP. PROVIDE CONCEALED LED TASK LIGHTING UNDER UPPER CABINETS. PROVIDE 4" WIRE PULL HARDWARE (TYP.) ML1A PLASTIC LAMINATE ON VERTICAL SURFACES, MS1B SOLID POLYMER COUNTERTOP. PROVIDE CONCEALED LED TASK LIGHTING UNDER UPPER CABINETS. PROVIDE 4" WIRE PULL HARDWARE (TYP.)	TAN PALETTE SMOKEY BROWN PALETTE TAN PALETTE TAN PALETTE GREEN PALETTE	PL-17	
л-1 л-2 л-3 л-4 л-5	COMBINATION COMBINATION COMBINATION COMBINATION COMBINATION COMBINATION	N/A N/A N/A N/A N/A N/A	ML1A ON VERTICAL SURFACES, ML1B PLASTIC LAMINATE COUNTERTOP, MS1B SOLID POLYMER TRANSACTION COUNTER. PROVIDE 4" WIRE PULL HARDWARE (TYP.) ML1A ON VERTICAL SURFACES, ML1E PLASTIC LAMINATE COUNTERTOP, MS1A SOLID POLYMER TRANSACTION COUNTER. PROVIDE 4" WIRE PULL HARDWARE (TYP.) ML1A PLASTIC LAMINATE ON VERTICAL SURFACES, ML1E ON ALL OTHER SURFACES. PROVIDE 4" WIRE PULL HARDWARE (TYP.) ML1A ON VERTICAL SURFACES, ML1G PLASTIC LAMINATE COUNTERTOP, MS1C SOLID POLYMER TRANSACTION COUNTER. PROVIDE 4" WIRE PULL HARDWARE (TYP.) ML1A PLASTIC LAMINATE ON VERTICAL SURFACES, MS1A SOLID POLYMER COUNTERTOP. PROVIDE CONCEALED LED TASK LIGHTING UNDER UPPER CABINETS. PROVIDE 4" WIRE PULL HARDWARE (TYP.) ML1A PLASTIC LAMINATE ON VERTICAL SURFACES, MS1A SOLID POLYMER ON ALL OTHER SURFACES. PROVIDE 4" WIRE PULL HARDWARE (TYP.) ML1A PLASTIC LAMINATE ON VERTICAL SURFACES, MS1B SOLID POLYMER COUNTERTOP. PROVIDE CONCEALED LED TASK LIGHTING UNDER UPPER CABINETS. PROVIDE 4" WIRE PULL HARDWARE (TYP.) ML1A PLASTIC LAMINATE ON VERTICAL SURFACES, MS1B SOLID POLYMER COUNTERTOP. PROVIDE CONCEALED LED TASK LIGHTING UNDER UPPER CABINETS. PROVIDE 4" WIRE PULL HARDWARE (TYP.) ML1A PLASTIC LAMINATE ON VERTICAL SURFACES, MS1B SOLID POLYMER ON ALL OTHER SURFACES. PROVIDE 4" WIRE PULL HARDWARE (TYP.)	TAN PALETTE SMOKEY BROWN PALETTE TAN PALETTE GREEN PALETTE GREEN PALETTE SMOKEY BROWN PALETTE	PL-17	
л-1 л-2 л-3 л-4 л-5	COMBINATION COMBINATION COMBINATION COMBINATION COMBINATION COMBINATION	N/A N/A N/A N/A N/A N/A	ML1A ON VERTICAL SURFACES, ML1B PLASTIC LAMINATE COUNTERTOP, MS1B SOLID POLYMER TRANSACTION COUNTER. PROVIDE 4" WIRE PULL HARDWARE (TYP.) ML1A ON VERTICAL SURFACES, ML1E PLASTIC LAMINATE COUNTERTOP, MS1A SOLID POLYMER TRANSACTION COUNTER. PROVIDE 4" WIRE PULL HARDWARE (TYP.) ML1A PLASTIC LAMINATE ON VERTICAL SURFACES, ML1E ON ALL OTHER SURFACES. PROVIDE 4" WIRE PULL HARDWARE (TYP.) ML1A ON VERTICAL SURFACES, ML1G PLASTIC LAMINATE COUNTERTOP, MS1C SOLID POLYMER TRANSACTION COUNTER. PROVIDE 4" WIRE PULL HARDWARE (TYP.) ML1A PLASTIC LAMINATE ON VERTICAL SURFACES, MS1A SOLID POLYMER COUNTERTOP. PROVIDE CONCEALED LED TASK LIGHTING UNDER UPPER CABINETS. PROVIDE 4" WIRE PULL HARDWARE (TYP.) ML1A PLASTIC LAMINATE ON VERTICAL SURFACES, MS1A SOLID POLYMER ON ALL OTHER SURFACES. PROVIDE 4" WIRE PULL HARDWARE (TYP.) ML1A PLASTIC LAMINATE ON VERTICAL SURFACES, MS1B SOLID POLYMER COUNTERTOP. PROVIDE CONCEALED LED TASK LIGHTING UNDER UPPER CABINETS. PROVIDE 4" WIRE PULL HARDWARE (TYP.) ML1A PLASTIC LAMINATE ON VERTICAL SURFACES, MS1B SOLID POLYMER COUNTERTOP. PROVIDE CONCEALED LED TASK LIGHTING UNDER UPPER CABINETS. PROVIDE 4" WIRE PULL HARDWARE (TYP.) ML1A PLASTIC LAMINATE ON VERTICAL SURFACES, MS1B SOLID POLYMER ON ALL OTHER SURFACES. PROVIDE 4" WIRE PULL HARDWARE (TYP.)	TAN PALETTE SMOKEY BROWN PALETTE TAN PALETTE GREEN PALETTE GREEN PALETTE SMOKEY BROWN PALETTE	PL-17	
л-1 л-2 л-3 л-4 л-5 л-7	COMBINATION COMBINATION COMBINATION COMBINATION COMBINATION COMBINATION	N/A N/A N/A N/A N/A N/A	ML1A ON VERTICAL SURFACES, ML1B PLASTIC LAMINATE COUNTERTOP, MS1B SOLID POLYMER TRANSACTION COUNTER. PROVIDE 4" WIRE PULL HARDWARE (TYP.) ML1A ON VERTICAL SURFACES, ML1E PLASTIC LAMINATE COUNTERTOP, MS1A SOLID POLYMER TRANSACTION COUNTER. PROVIDE 4" WIRE PULL HARDWARE (TYP.) ML1A PLASTIC LAMINATE ON VERTICAL SURFACES, ML1E ON ALL OTHER SURFACES. PROVIDE 4" WIRE PULL HARDWARE (TYP.) ML1A ON VERTICAL SURFACES, ML1G PLASTIC LAMINATE COUNTERTOP, MS1C SOLID POLYMER TRANSACTION COUNTER. PROVIDE 4" WIRE PULL HARDWARE (TYP.) ML1A PLASTIC LAMINATE ON VERTICAL SURFACES, MS1A SOLID POLYMER COUNTERTOP. PROVIDE CONCEALED LED TASK LIGHTING UNDER UPPER CABINETS. PROVIDE 4" WIRE PULL HARDWARE (TYP.) ML1A PLASTIC LAMINATE ON VERTICAL SURFACES, MS1A SOLID POLYMER ON ALL OTHER SURFACES. PROVIDE 4" WIRE PULL HARDWARE (TYP.) ML1A PLASTIC LAMINATE ON VERTICAL SURFACES, MS1B SOLID POLYMER COUNTERTOP. PROVIDE CONCEALED LED TASK LIGHTING UNDER UPPER CABINETS. PROVIDE 4" WIRE PULL HARDWARE (TYP.) ML1A PLASTIC LAMINATE ON VERTICAL SURFACES, MS1B SOLID POLYMER ON ALL OTHER SURFACES. PROVIDE 4" WIRE PULL HARDWARE (TYP.) ML1A PLASTIC LAMINATE ON VERTICAL SURFACES, MS1B SOLID POLYMER ON ALL OTHER SURFACES. PROVIDE 4" WIRE PULL HARDWARE (TYP.) ML1A PLASTIC LAMINATE ON VERTICAL SURFACES, MS1C SOLID POLYMER COUNTERTOP. PROVIDE CONCEALED LED TASK LIGHTING UNDER UPPER CABINETS. PROVIDE 4" WIRE PULL HARDWARE (TYP.) ML1A PLASTIC LAMINATE ON VERTICAL SURFACES, MS1C SOLID POLYMER COUNTERTOP. PROVIDE CONCEALED LED TASK LIGHTING UNDER UPPER CABINETS. PROVIDE 4" WIRE PULL HARDWARE (TYP.)	TAN PALETTE SMOKEY BROWN PALETTE TAN PALETTE GREEN PALETTE GREEN PALETTE SMOKEY BROWN PALETTE	PL-17	
M-1 M-2 M-3 M-4 M-5 M-7	COMBINATION COMBINATION COMBINATION COMBINATION COMBINATION COMBINATION COMBINATION COMBINATION	N/A N/A N/A N/A N/A N/A N/A N/A	ML1A ON VERTICAL SURFACES, ML1B PLASTIC LAMINATE COUNTERTOP, MS1B SOLID POLYMER TRANSACTION COUNTER. PROVIDE 4" WIRE PULL HARDWARE (TYP.) ML1A ON VERTICAL SURFACES, ML1E PLASTIC LAMINATE COUNTERTOP, MS1A SOLID POLYMER TRANSACTION COUNTER. PROVIDE 4" WIRE PULL HARDWARE (TYP.) ML1A PLASTIC LAMINATE ON VERTICAL SURFACES, ML1E ON ALL OTHER SURFACES. PROVIDE 4" WIRE PULL HARDWARE (TYP.) ML1A ON VERTICAL SURFACES, ML1G PLASTIC LAMINATE COUNTERTOP, MS1C SOLID POLYMER TRANSACTION COUNTER. PROVIDE 4" WIRE PULL HARDWARE (TYP.) ML1A PLASTIC LAMINATE ON VERTICAL SURFACES, MS1A SOLID POLYMER COUNTERTOP. PROVIDE CONCEALED LED TASK LIGHTING UNDER UPPER CABINETS. PROVIDE 4" WIRE PULL HARDWARE (TYP.) ML1A PLASTIC LAMINATE ON VERTICAL SURFACES, MS1A SOLID POLYMER ON ALL OTHER SURFACES. PROVIDE 4" WIRE PULL HARDWARE (TYP.) ML1A PLASTIC LAMINATE ON VERTICAL SURFACES, MS1B SOLID POLYMER COUNTERTOP. PROVIDE CONCEALED LED TASK LIGHTING UNDER UPPER CABINETS. PROVIDE 4" WIRE PULL HARDWARE (TYP.) ML1A PLASTIC LAMINATE ON VERTICAL SURFACES, MS1B SOLID POLYMER ON ALL OTHER SURFACES. PROVIDE 4" WIRE PULL HARDWARE (TYP.) ML1A PLASTIC LAMINATE ON VERTICAL SURFACES, MS1B SOLID POLYMER ON ALL OTHER SURFACES. PROVIDE 4" WIRE PULL HARDWARE (TYP.) ML1A PLASTIC LAMINATE ON VERTICAL SURFACES, MS1C SOLID POLYMER COUNTERTOP. PROVIDE CONCEALED LED TASK LIGHTING UNDER UPPER CABINETS. PROVIDE 4" WIRE PULL HARDWARE (TYP.) ML1A PLASTIC LAMINATE ON VERTICAL SURFACES, MS1C SOLID POLYMER COUNTERTOP. PROVIDE CONCEALED LED TASK LIGHTING UNDER UPPER CABINETS. PROVIDE 4" WIRE PULL HARDWARE (TYP.)	TAN PALETTE SMOKEY BROWN PALETTE TAN PALETTE TAN PALETTE GREEN PALETTE GREEN PALETTE SMOKEY BROWN PALETTE	PL-17	
M-1 M-2 M-3 M-4 M-5 M-7 M-8 M-9	COMBINATION COMBINATION COMBINATION COMBINATION COMBINATION COMBINATION COMBINATION COMBINATION COMBINATION	N/A N/A N/A N/A N/A N/A N/A N/A	ML1A ON VERTICAL SURFACES, ML1B PLASTIC LAMINATE COUNTERTOP, MS1B SOLID POLYMER TRANSACTION COUNTER. PROVIDE 4" WIRE PULL HARDWARE (TYP.) ML1A ON VERTICAL SURFACES, ML1E PLASTIC LAMINATE COUNTERTOP, MS1A SOLID POLYMER TRANSACTION COUNTER. PROVIDE 4" WIRE PULL HARDWARE (TYP.) ML1A PLASTIC LAMINATE ON VERTICAL SURFACES, ML1E ON ALL OTHER SURFACES. PROVIDE 4" WIRE PULL HARDWARE (TYP.) ML1A ON VERTICAL SURFACES, ML1G PLASTIC LAMINATE COUNTERTOP, MS1C SOLID POLYMER TRANSACTION COUNTER. PROVIDE 4" WIRE PULL HARDWARE (TYP.) ML1A PLASTIC LAMINATE ON VERTICAL SURFACES, MS1A SOLID POLYMER COUNTERTOP. PROVIDE CONCEALED LED TASK LIGHTING UNDER UPPER CABINETS. PROVIDE 4" WIRE PULL HARDWARE (TYP.) ML1A PLASTIC LAMINATE ON VERTICAL SURFACES, MS1A SOLID POLYMER ON ALL OTHER SURFACES. PROVIDE 4" WIRE PULL HARDWARE (TYP.) ML1A PLASTIC LAMINATE ON VERTICAL SURFACES, MS1B SOLID POLYMER COUNTERTOP. PROVIDE CONCEALED LED TASK LIGHTING UNDER UPPER CABINETS. PROVIDE 4" WIRE PULL HARDWARE (TYP.) ML1A PLASTIC LAMINATE ON VERTICAL SURFACES, MS1B SOLID POLYMER ON ALL OTHER SURFACES. PROVIDE 4" WIRE PULL HARDWARE (TYP.) ML1A PLASTIC LAMINATE ON VERTICAL SURFACES, MS1C SOLID POLYMER COUNTERTOP. PROVIDE CONCEALED LED TASK LIGHTING UNDER UPPER CABINETS. PROVIDE 4" WIRE PULL HARDWARE (TYP.) ML1A PLASTIC LAMINATE ON VERTICAL SURFACES, MS1C SOLID POLYMER COUNTERTOP. PROVIDE CONCEALED LED TASK LIGHTING UNDER UPPER CABINETS. PROVIDE 4" WIRE PULL HARDWARE (TYP.) ML1A PLASTIC LAMINATE ON VERTICAL SURFACES, MS1C SOLID POLYMER ON ALL OTHER SURFACES. PROVIDE 4" WIRE PULL HARDWARE (TYP.)	TAN PALETTE SMOKEY BROWN PALETTE TAN PALETTE GREEN PALETTE GREEN PALETTE SMOKEY BROWN PALETTE SMOKEY BROWN PALETTE	PC-17	
M-1 M-2 M-3 M-4 M-5 M-7 M-8 M-9	COMBINATION	N/A N/A N/A N/A N/A N/A N/A N/A	ML1A ON VERTICAL SURFACES, ML1B PLASTIC LAMINATE COUNTERTOP, MS1B SOLID POLYMER TRANSACTION COUNTER. PROVIDE 4" WIRE PULL HARDWARE (TYP.) ML1A ON VERTICAL SURFACES, ML1E PLASTIC LAMINATE COUNTERTOP, MS1A SOLID POLYMER TRANSACTION COUNTER. PROVIDE 4" WIRE PULL HARDWARE (TYP.) ML1A PLASTIC LAMINATE ON VERTICAL SURFACES, ML1E ON ALL OTHER SURFACES. PROVIDE 4" WIRE PULL HARDWARE (TYP.) ML1A ON VERTICAL SURFACES, ML1G PLASTIC LAMINATE COUNTERTOP, MS1C SOLID POLYMER TRANSACTION COUNTER. PROVIDE 4" WIRE PULL HARDWARE (TYP.) ML1A PLASTIC LAMINATE ON VERTICAL SURFACES, MS1A SOLID POLYMER COUNTERTOP. PROVIDE CONCEALED LED TASK LIGHTING UNDER UPPER CABINETS. PROVIDE 4" WIRE PULL HARDWARE (TYP.) ML1A PLASTIC LAMINATE ON VERTICAL SURFACES, MS1A SOLID POLYMER ON ALL OTHER SURFACES. PROVIDE 4" WIRE PULL HARDWARE (TYP.) ML1A PLASTIC LAMINATE ON VERTICAL SURFACES, MS1B SOLID POLYMER COUNTERTOP. PROVIDE CONCEALED LED TASK LIGHTING UNDER UPPER CABINETS. PROVIDE 4" WIRE PULL HARDWARE (TYP.) ML1A PLASTIC LAMINATE ON VERTICAL SURFACES, MS1B SOLID POLYMER ON ALL OTHER SURFACES. PROVIDE 4" WIRE PULL HARDWARE (TYP.) ML1A PLASTIC LAMINATE ON VERTICAL SURFACES, MS1C SOLID POLYMER COUNTERTOP. PROVIDE CONCEALED LED TASK LIGHTING UNDER UPPER CABINETS. PROVIDE 4" WIRE PULL HARDWARE (TYP.) ML1A PLASTIC LAMINATE ON VERTICAL SURFACES, MS1C SOLID POLYMER COUNTERTOP. PROVIDE CONCEALED LED TASK LIGHTING UNDER UPPER CABINETS. PROVIDE 4" WIRE PULL HARDWARE (TYP.) ML1A PLASTIC LAMINATE ON VERTICAL SURFACES, MS1C SOLID POLYMER ON ALL OTHER SURFACES. PROVIDE 4" WIRE PULL HARDWARE (TYP.)	TAN PALETTE SMOKEY BROWN PALETTE TAN PALETTE TAN PALETTE GREEN PALETTE SMOKEY BROWN PALETTE SMOKEY BROWN PALETTE SMOKEY BROWN PALETTE	CG-4	
M-1 M-2 M-3 M-4 M-5 M-7 M-8 M-9	COMBINATION COMBINATION COMBINATION COMBINATION COMBINATION COMBINATION COMBINATION COMBINATION COMBINATION	N/A N/A N/A N/A N/A N/A N/A N/A	ML1A ON VERTICAL SURFACES, ML1B PLASTIC LAMINATE COUNTERTOP, MS1B SOLID POLYMER TRANSACTION COUNTER. PROVIDE 4" WIRE PULL HARDWARE (TYP.) ML1A ON VERTICAL SURFACES, ML1E PLASTIC LAMINATE COUNTERTOP, MS1A SOLID POLYMER TRANSACTION COUNTER. PROVIDE 4" WIRE PULL HARDWARE (TYP.) ML1A PLASTIC LAMINATE ON VERTICAL SURFACES, ML1E ON ALL OTHER SURFACES. PROVIDE 4" WIRE PULL HARDWARE (TYP.) ML1A ON VERTICAL SURFACES, ML1G PLASTIC LAMINATE COUNTERTOP, MS1C SOLID POLYMER TRANSACTION COUNTER. PROVIDE 4" WIRE PULL HARDWARE (TYP.) ML1A PLASTIC LAMINATE ON VERTICAL SURFACES, MS1A SOLID POLYMER COUNTERTOP. PROVIDE CONCEALED LED TASK LIGHTING UNDER UPPER CABINETS. PROVIDE 4" WIRE PULL HARDWARE (TYP.) ML1A PLASTIC LAMINATE ON VERTICAL SURFACES, MS1A SOLID POLYMER ON ALL OTHER SURFACES. PROVIDE 4" WIRE PULL HARDWARE (TYP.) ML1A PLASTIC LAMINATE ON VERTICAL SURFACES, MS1B SOLID POLYMER COUNTERTOP. PROVIDE CONCEALED LED TASK LIGHTING UNDER UPPER CABINETS. PROVIDE 4" WIRE PULL HARDWARE (TYP.) ML1A PLASTIC LAMINATE ON VERTICAL SURFACES, MS1B SOLID POLYMER COUNTERTOP. PROVIDE CONCEALED LED TASK LIGHTING UNDER UPPER CABINETS. PROVIDE 4" WIRE PULL HARDWARE (TYP.) ML1A PLASTIC LAMINATE ON VERTICAL SURFACES, MS1C SOLID POLYMER COUNTERTOP. PROVIDE CONCEALED LED TASK LIGHTING UNDER UPPER CABINETS. PROVIDE 4" WIRE PULL HARDWARE (TYP.) ML1A PLASTIC LAMINATE ON VERTICAL SURFACES, MS1C SOLID POLYMER COUNTERTOP. PROVIDE CONCEALED LED TASK LIGHTING UNDER UPPER CABINETS. PROVIDE 4" WIRE PULL HARDWARE (TYP.) ML1A PLASTIC LAMINATE ON VERTICAL SURFACES, MS1C SOLID POLYMER ON ALL OTHER SURFACES. PROVIDE 4" WIRE PULL HARDWARE (TYP.)	TAN PALETTE SMOKEY BROWN PALETTE TAN PALETTE GREEN PALETTE GREEN PALETTE SMOKEY BROWN PALETTE SMOKEY BROWN PALETTE		
M-1 M-2 M-3 M-4 M-5 M-6 M-7 M-8 M-9 M-10	COMBINATION	N/A N/A N/A N/A N/A N/A N/A N/A	ML1A ON VERTICAL SURFACES, ML1B PLASTIC LAMINATE COUNTERTOP, MS1B SOLID POLYMER TRANSACTION COUNTER. PROVIDE 4" WIRE PULL HARDWARE (TYP.) ML1A ON VERTICAL SURFACES, ML1E PLASTIC LAMINATE COUNTERTOP, MS1A SOLID POLYMER TRANSACTION COUNTER. PROVIDE 4" WIRE PULL HARDWARE (TYP.) ML1A PLASTIC LAMINATE ON VERTICAL SURFACES, ML1E ON ALL OTHER SURFACES. PROVIDE 4" WIRE PULL HARDWARE (TYP.) ML1A ON VERTICAL SURFACES. ML1G PLASTIC LAMINATE COUNTERTOP, MS1C SOLID POLYMER TRANSACTION COUNTER. PROVIDE 4" WIRE PULL HARDWARE (TYP.) ML1A PLASTIC LAMINATE ON VERTICAL SURFACES, MS1A SOLID POLYMER COUNTERTOP. PROVIDE CONCEALED LED TASK LIGHTING UNDER UPPER CABINETS. PROVIDE 4" WIRE PULL HARDWARE (TYP.) ML1A PLASTIC LAMINATE ON VERTICAL SURFACES, MS1A SOLID POLYMER ON ALL OTHER SURFACES. PROVIDE 4" WIRE PULL HARDWARE (TYP.) ML1A PLASTIC LAMINATE ON VERTICAL SURFACES, MS1B SOLID POLYMER COUNTERTOP. PROVIDE CONCEALED LED TASK LIGHTING UNDER UPPER CABINETS. PROVIDE 4" WIRE PULL HARDWARE (TYP.) ML1A PLASTIC LAMINATE ON VERTICAL SURFACES, MS1B SOLID POLYMER COUNTERTOP. PROVIDE CONCEALED LED TASK LIGHTING UNDER UPPER CABINETS. PROVIDE 4" WIRE PULL HARDWARE (TYP.) ML1A PLASTIC LAMINATE ON VERTICAL SURFACES, MS1C SOLID POLYMER COUNTERTOP. PROVIDE CONCEALED LED TASK LIGHTING UNDER UPPER CABINETS. PROVIDE 4" WIRE PULL HARDWARE (TYP.) ML1A PLASTIC LAMINATE ON VERTICAL SURFACES, MS1C SOLID POLYMER COUNTERTOP. PROVIDE CONCEALED LED TASK LIGHTING UNDER UPPER CABINETS. PROVIDE 4" WIRE PULL HARDWARE (TYP.) ML1A PLASTIC LAMINATE ON VERTICAL SURFACES, MS1C SOLID POLYMER ON ALL OTHER SURFACES. PROVIDE 4" WIRE PULL HARDWARE (TYP.) ML1A PLASTIC LAMINATE ON VERTICAL SURFACES, MS1C SOLID POLYMER ON ALL OTHER SURFACES. PROVIDE 4" WIRE PULL HARDWARE (TYP.)	TAN PALETTE SMOKEY BROWN PALETTE TAN PALETTE GREEN PALETTE GREEN PALETTE SMOKEY BROWN PALETTE SMOKEY BROWN PALETTE BY SYMBOL, REFER TO ARCHITECTURE PLANS FOR		
л-1 л-2 л-3 л-4 л-5 л-6 л-7 л-8 л-10	COMBINATION	N/A N/A N/A N/A N/A N/A N/A N/A	ML1A ON VERTICAL SURFACES, ML1B PLASTIC LAMINATE COUNTERTOP, MS1B SOLID POLYMER TRANSACTION COUNTER. PROVIDE 4" WIRE PULL HARDWARE (TYP.) ML1A ON VERTICAL SURFACES, ML1E PLASTIC LAMINATE COUNTERTOP, MS1A SOLID POLYMER TRANSACTION COUNTER. PROVIDE 4" WIRE PULL HARDWARE (TYP.) ML1A PLASTIC LAMINATE ON VERTICAL SURFACES, ML1E ON ALL OTHER SURFACES. PROVIDE 4" WIRE PULL HARDWARE (TYP.) ML1A ON VERTICAL SURFACES. ML1G PLASTIC LAMINATE COUNTERTOP, MS1C SOLID POLYMER TRANSACTION COUNTER. PROVIDE 4" WIRE PULL HARDWARE (TYP.) ML1A PLASTIC LAMINATE ON VERTICAL SURFACES, MS1A SOLID POLYMER COUNTERTOP. PROVIDE CONCEALED LED TASK LIGHTING UNDER UPPER CABINETS. PROVIDE 4" WIRE PULL HARDWARE (TYP.) ML1A PLASTIC LAMINATE ON VERTICAL SURFACES, MS1A SOLID POLYMER ON ALL OTHER SURFACES. PROVIDE 4" WIRE PULL HARDWARE (TYP.) ML1A PLASTIC LAMINATE ON VERTICAL SURFACES, MS1B SOLID POLYMER COUNTERTOP. PROVIDE CONCEALED LED TASK LIGHTING UNDER UPPER CABINETS. PROVIDE 4" WIRE PULL HARDWARE (TYP.) ML1A PLASTIC LAMINATE ON VERTICAL SURFACES, MS1B SOLID POLYMER COUNTERTOP. PROVIDE CONCEALED LED TASK LIGHTING UNDER UPPER CABINETS. PROVIDE 4" WIRE PULL HARDWARE (TYP.) ML1A PLASTIC LAMINATE ON VERTICAL SURFACES, MS1C SOLID POLYMER ON ALL OTHER SURFACES. PROVIDE 4" WIRE PULL HARDWARE (TYP.) ML1A PLASTIC LAMINATE ON VERTICAL SURFACES, MS1C SOLID POLYMER COUNTERTOP. PROVIDE CONCEALED LED TASK LIGHTING UNDER UPPER CABINETS. PROVIDE 4" WIRE PULL HARDWARE (TYP.) ML1A PLASTIC LAMINATE ON VERTICAL SURFACES, MS1C SOLID POLYMER ON ALL OTHER SURFACES. PROVIDE 4" WIRE PULL HARDWARE (TYP.) ML1A PLASTIC LAMINATE ON VERTICAL SURFACES, MS1C SOLID POLYMER ON ALL OTHER SURFACES. PROVIDE 4" WIRE PULL HARDWARE (TYP.)	TAN PALETTE SMOKEY BROWN PALETTE TAN PALETTE GREEN PALETTE GREEN PALETTE SMOKEY BROWN PALETTE SMOKEY BROWN PALETTE BY SYMBOL, REFER TO ARCHITECTURE PLANS FOR		
л-1 л-2 л-3 л-4 л-5 л-7 л-8 л-9 л-10 VALL PRO	COMBINATION SURFACE MOUNTED CORNER GUARD	N/A N/A N/A N/A N/A N/A N/A N/A	ML1A ON VERTICAL SURFACES, ML1B PLASTIC LAMINATE COUNTERTOP, MS1B SOLID POLYMER TRANSACTION COUNTER. PROVIDE 4" WIRE PULL HARDWARE (TYP.) ML1A ON VERTICAL SURFACES, ML1E PLASTIC LAMINATE COUNTERTOP, MS1A SOLID POLYMER TRANSACTION COUNTER. PROVIDE 4" WIRE PULL HARDWARE (TYP.) ML1A PLASTIC LAMINATE ON VERTICAL SURFACES, ML1E ON ALL OTHER SURFACES. PROVIDE 4" WIRE PULL HARDWARE (TYP.) ML1A ON VERTICAL SURFACES, ML1G PLASTIC LAMINATE COUNTERTOP, MS1C SOLID POLYMER TRANSACTION COUNTER. PROVIDE 4" WIRE PULL HARDWARE (TYP.) ML1A PLASTIC LAMINATE ON VERTICAL SURFACES, MS1A SOLID POLYMER COUNTERTOP, PROVIDE CONCEALED LED TASK LIGHTING UNDER UPPER CABINETS. PROVIDE 4" WIRE PULL HARDWARE (TYP.) ML1A PLASTIC LAMINATE ON VERTICAL SURFACES, MS1A SOLID POLYMER ON ALL OTHER SURFACES. PROVIDE 4" WIRE PULL HARDWARE (TYP.) ML1A PLASTIC LAMINATE ON VERTICAL SURFACES, MS1B SOLID POLYMER COUNTERTOP. PROVIDE CONCEALED LED TASK LIGHTING UNDER UPPER CABINETS. PROVIDE 4" WIRE PULL HARDWARE (TYP.) ML1A PLASTIC LAMINATE ON VERTICAL SURFACES, MS1B SOLID POLYMER ON ALL OTHER SURFACES. PROVIDE 4" WIRE PULL HARDWARE (TYP.) ML1A PLASTIC LAMINATE ON VERTICAL SURFACES, MS1C SOLID POLYMER COUNTERTOP. PROVIDE CONCEALED LED TASK LIGHTING UNDER UPPER CABINETS. PROVIDE 4" WIRE PULL HARDWARE (TYP.) ML1A PLASTIC LAMINATE ON VERTICAL SURFACES, MS1C SOLID POLYMER ON ALL OTHER SURFACES. PROVIDE 4" WIRE PULL HARDWARE (TYP.) ML1A PLASTIC LAMINATE ON VERTICAL SURFACES, MS1C SOLID POLYMER ON ALL OTHER SURFACES. PROVIDE 4" WIRE PULL HARDWARE (TYP.) PRODUCT: SM20-N COLOR: 517 TETON WHITE TEXTURE: SHADOW GRAIN THICKNESS: 0.078" HEIGHT: FULL HEIGHT UNO WING: 3" PRODUCT:	TAN PALETTE SMOKEY BROWN PALETTE TAN PALETTE GREEN PALETTE GREEN PALETTE SMOKEY BROWN PALETTE SMOKEY BROWN PALETTE BY SYMBOL, REFER TO ARCHITECTURE PLANS FOR LOCATIONS	CG-4	
л-1 л-2 л-3 л-4 л-5 л-7 л-8 л-9 л-10 VALL PRO	COMBINATION COMBINATION	N/A N/A N/A N/A N/A N/A N/A N/A	ML1A ON VERTICAL SURFACES, ML1B PLASTIC LAMINATE COUNTERTOP, MS1B SOLID POLYMER TRANSACTION COUNTER. PROVIDE 4" WIRE PULL HARDWARE (TYP.) ML1A ON VERTICAL SURFACES, ML1E PLASTIC LAMINATE COUNTER. PROVIDE 4" WIRE PULL HARDWARE (TYP.) ML1A ON VERTICAL SURFACES, ML1E PLASTIC LAMINATE COUNTER. PROVIDE 4" WIRE PULL HARDWARE (TYP.) ML1A PLASTIC LAMINATE ON VERTICAL SURFACES, ML1E ON ALL OTHER SURFACES. PROVIDE 4" WIRE PULL HARDWARE (TYP.) ML1A ON VERTICAL SURFACES, ML1G PLASTIC LAMINATE COUNTERTOP, MS1C SOLID POLYMER TRANSACTION COUNTER. PROVIDE 4" WIRE PULL HARDWARE (TYP.) ML1A PLASTIC LAMINATE ON VERTICAL SURFACES, MS1A SOLID POLYMER COUNTERTOP. PROVIDE CONCEALED LED TASK LIGHTING UNDER UPPER CABINETS. PROVIDE 4" WIRE PULL HARDWARE (TYP.) ML1A PLASTIC LAMINATE ON VERTICAL SURFACES, MS1A SOLID POLYMER ON ALL OTHER SURFACES. PROVIDE 4" WIRE PULL HARDWARE (TYP.) ML1A PLASTIC LAMINATE ON VERTICAL SURFACES, MS1B SOLID POLYMER COUNTERTOP. PROVIDE CONCEALED LED TASK LIGHTING UNDER UPPER CABINETS. PROVIDE 4" WIRE PULL HARDWARE (TYP.) ML1A PLASTIC LAMINATE ON VERTICAL SURFACES, MS1B SOLID POLYMER ON ALL OTHER SURFACES. PROVIDE 4" WIRE PULL HARDWARE (TYP.) ML1A PLASTIC LAMINATE ON VERTICAL SURFACES, MS1B SOLID POLYMER ON ALL OTHER SURFACES. PROVIDE 4" WIRE PULL HARDWARE (TYP.) ML1A PLASTIC LAMINATE ON VERTICAL SURFACES, MS1C SOLID POLYMER COUNTERTOP. PROVIDE CONCEALED LED TASK LIGHTING UNDER UPPER CABINETS. PROVIDE 4" WIRE PULL HARDWARE (TYP.) ML1A PLASTIC LAMINATE ON VERTICAL SURFACES, MS1C SOLID POLYMER ON ALL OTHER SURFACES. PROVIDE 4" WIRE PULL HARDWARE (TYP.) ML1A PLASTIC LAMINATE ON VERTICAL SURFACES, MS1C SOLID POLYMER ON ALL OTHER SURFACES. PROVIDE 4" WIRE PULL HARDWARE (TYP.) ML1A PLASTIC LAMINATE ON VERTICAL SURFACES. PROVIDE 4" WIRE PULL HARDWARE (TYP.) PRODUCT: SM20-N COLOR: S17 TETON WHITE TEXTURE: SHADOW GRAIN THICKNESS: 0.078" HEIGHT: FULL HEIGHT UNO WHITE	TAN PALETTE SMOKEY BROWN PALETTE TAN PALETTE GREEN PALETTE GREEN PALETTE SMOKEY BROWN PALETTE SMOKEY BROWN PALETTE BY SYMBOL, REFER TO ARCHITECTURE PLANS FOR LOCATIONS REFER TO INTERIOR ROOM STYLES SCHEDULE FOR	CG-4	
//-1 //-2 //-3 //-4 //-5 //-6 //-7 //-8 //-9 //-10	COMBINATION SURFACE MOUNTED CORNER GUARD	N/A N/A N/A N/A N/A N/A N/A N/A	ML1A ON VERTICAL SURFACES, ML1B PLASTIC LAMINATE COUNTERTOP, MS1B SOLID POLYMER TRANSACTION COUNTER. PROVIDE 4" WIRE PULL HARDWARE (TYP.) ML1A ON VERTICAL SURFACES, ML1E PLASTIC LAMINATE COUNTER. PROVIDE 4" WIRE PULL HARDWARE (TYP.) ML1A ON VERTICAL SURFACES, ML1E PLASTIC LAMINATE COUNTER. PROVIDE 4" WIRE PULL HARDWARE (TYP.) ML1A PLASTIC LAMINATE ON VERTICAL SURFACES, ML1E ON ALL OTHER SURFACES. PROVIDE 4" WIRE PULL HARDWARE (TYP.) ML1A ON VERTICAL SURFACES, ML1G PLASTIC LAMINATE COUNTERTOP, MS1C SOLID POLYMER TRANSACTION COUNTER. PROVIDE 4" WIRE PULL HARDWARE (TYP.) ML1A PLASTIC LAMINATE ON VERTICAL SURFACES, MS1A SOLID POLYMER COUNTERTOP. PROVIDE CONCEALED LED TASK LIGHTING UNDER UPPER CABINETS. PROVIDE 4" WIRE PULL HARDWARE (TYP.) ML1A PLASTIC LAMINATE ON VERTICAL SURFACES, MS1A SOLID POLYMER ON ALL OTHER SURFACES. PROVIDE 4" WIRE PULL HARDWARE (TYP.) ML1A PLASTIC LAMINATE ON VERTICAL SURFACES, MS1B SOLID POLYMER COUNTERTOP. PROVIDE CONCEALED LED TASK LIGHTING UNDER UPPER CABINETS. PROVIDE 4" WIRE PULL HARDWARE (TYP.) ML1A PLASTIC LAMINATE ON VERTICAL SURFACES, MS1B SOLID POLYMER ON ALL OTHER SURFACES. PROVIDE 4" WIRE PULL HARDWARE (TYP.) ML1A PLASTIC LAMINATE ON VERTICAL SURFACES, MS1B SOLID POLYMER ON ALL OTHER SURFACES. PROVIDE 4" WIRE PULL HARDWARE (TYP.) ML1A PLASTIC LAMINATE ON VERTICAL SURFACES, MS1C SOLID POLYMER COUNTERTOP. PROVIDE CONCEALED LED TASK LIGHTING UNDER UPPER CABINETS. PROVIDE 4" WIRE PULL HARDWARE (TYP.) ML1A PLASTIC LAMINATE ON VERTICAL SURFACES, MS1C SOLID POLYMER ON ALL OTHER SURFACES. PROVIDE 4" WIRE PULL HARDWARE (TYP.) ML1A PLASTIC LAMINATE ON VERTICAL SURFACES, MS1C SOLID POLYMER ON ALL OTHER SURFACES. PROVIDE 4" WIRE PULL HARDWARE (TYP.) ML1A PLASTIC LAMINATE ON VERTICAL SURFACES. PROVIDE 4" WIRE PULL HARDWARE (TYP.) PRODUCT: SM20-N COLOR: S17 TETON WHITE TEXTURE: SHADOW GRAIN THICKNESS: 0.078" HEIGHT: FULL HEIGHT UNO WHITE	TAN PALETTE SMOKEY BROWN PALETTE TAN PALETTE GREEN PALETTE GREEN PALETTE SMOKEY BROWN PALETTE SMOKEY BROWN PALETTE BY SYMBOL, REFER TO ARCHITECTURE PLANS FOR LOCATIONS	CG-4	
M-1 M-2 M-3 M-6 M-7 M-8 M-10	COMBINATION SURFACE MOUNTED CORNER GUARD SURFACE MOUNTED CRASH RAIL	N/A N/A N/A N/A N/A N/A N/A N/A	ML1A ON VERTICAL SURFACES, ML1B PLASTIC LAMINATE COUNTERTOP, MS1B SOLID POLYMER TRANSACTION COUNTER. PROVIDE 4" WIRE PULL HARDWARE (TYP.) ML1A ON VERTICAL SURFACES, ML1E PLASTIC LAMINATE COUNTERTOP, MS1A SOLID POLYMER TRANSACTION COUNTER. PROVIDE 4" WIRE PULL HARDWARE (TYP.) ML1A PLASTIC LAMINATE ON VERTICAL SURFACES, ML1E ON ALL OTHER SURFACES. PROVIDE 4" WIRE PULL HARDWARE (TYP.) ML1A ON VERTICAL SURFACES, ML1G PLASTIC LAMINATE COUNTERTOP, MS1C SOLID POLYMER TRANSACTION COUNTER. PROVIDE 4" WIRE PULL HARDWARE (TYP.) ML1A PLASTIC LAMINATE ON VERTICAL SURFACES, MS1A SOLID POLYMER COUNTERTOP. PROVIDE CONCEALED LED TASK LIGHTING UNDER UPPER CABINETS. PROVIDE 4" WIRE PULL HARDWARE (TYP.) ML1A PLASTIC LAMINATE ON VERTICAL SURFACES, MS1A SOLID POLYMER ON ALL OTHER SURFACES. PROVIDE 4" WIRE PULL HARDWARE (TYP.) ML1A PLASTIC LAMINATE ON VERTICAL SURFACES, MS1B SOLID POLYMER COUNTERTOP. PROVIDE CONCEALED LED TASK LIGHTING UNDER UPPER CABINETS. PROVIDE 4" WIRE PULL HARDWARE (TYP.) ML1A PLASTIC LAMINATE ON VERTICAL SURFACES, MS1B SOLID POLYMER COUNTERTOP. PROVIDE CONCEALED LED TASK LIGHTING UNDER UPPER CABINETS. PROVIDE 4" WIRE PULL HARDWARE (TYP.) ML1A PLASTIC LAMINATE ON VERTICAL SURFACES, MS1C SOLID POLYMER COUNTERTOP. PROVIDE CONCEALED LED TASK LIGHTING UNDER UPPER CABINETS. PROVIDE 4" WIRE PULL HARDWARE (TYP.) ML1A PLASTIC LAMINATE ON VERTICAL SURFACES, MS1C SOLID POLYMER ON ALL OTHER SURFACES. PROVIDE 4" WIRE PULL HARDWARE (TYP.) ML1A PLASTIC LAMINATE ON VERTICAL SURFACES, MS1C SOLID POLYMER ON ALL OTHER SURFACES. PROVIDE 4" WIRE PULL HARDWARE (TYP.) PRODUCT: SM20-N COLOR: 517 TETON WHITE TEXTURE: SHADOW GRAIN THICKNESS: 0.078" HEIGHT: FULL HEIGHT UNO WING: 3" PRODUCT: COLOR: 517 TETON WHITE TEXTURE: SHADOW GRAIN THICKNESS: HEIGHT: HICKNESS: HEIGHT:	TAN PALETTE SMOKEY BROWN PALETTE TAN PALETTE TAN PALETTE GREEN PALETTE SMOKEY BROWN PALETTE SMOKEY BROWN PALETTE BY SYMBOL, REFER TO ARCHITECTURE PLANS FOR LOCATIONS REFER TO INTERIOR ROOM STYLES SCHEDULE FOR LOCATIONS	CG-4	
M-1 M-2 M-3 M-6 M-7 M-8 M-10	COMBINATION SURFACE MOUNTED CORNER GUARD SURFACE MOUNTED CRASH RAIL	N/A N/A N/A N/A N/A N/A N/A N/A	ML1A ON VERTICAL SURFACES, ML1B PLASTIC LAMINATE COUNTERTOP, MS1B SOLID POLYMER TRANSACTION COUNTER. PROVIDE 4" WIRE PULL HARDWARE (TYP.) ML1A ON VERTICAL SURFACES, ML1E PLASTIC LAMINATE COUNTERTOP, MS1A SOLID POLYMER TRANSACTION COUNTER. PROVIDE 4" WIRE PULL HARDWARE (TYP.) ML1A PLASTIC LAMINATE ON VERTICAL SURFACES, ML1E ON ALL OTHER SURFACES. PROVIDE 4" WIRE PULL HARDWARE (TYP.) ML1A ON VERTICAL SURFACES, ML1G PLASTIC LAMINATE COUNTERTOP, MS1C SOLID POLYMER TRANSACTION COUNTER. PROVIDE 4" WIRE PULL HARDWARE (TYP.) ML1A PLASTIC LAMINATE ON VERTICAL SURFACES, MS1A SOLID POLYMER COUNTERTOP. PROVIDE CONCEALED LED TASK LIGHTING UNDER UPPER CABINETS. PROVIDE 4" WIRE PULL HARDWARE (TYP.) ML1A PLASTIC LAMINATE ON VERTICAL SURFACES, MS1A SOLID POLYMER ON ALL OTHER SURFACES. PROVIDE 4" WIRE PULL HARDWARE (TYP.) ML1A PLASTIC LAMINATE ON VERTICAL SURFACES, MS1B SOLID POLYMER COUNTERTOP. PROVIDE CONCEALED LED TASK LIGHTING UNDER UPPER CABINETS. PROVIDE 4" WIRE PULL HARDWARE (TYP.) ML1A PLASTIC LAMINATE ON VERTICAL SURFACES, MS1B SOLID POLYMER ON ALL OTHER SURFACES. PROVIDE 4" WIRE PULL HARDWARE (TYP.) ML1A PLASTIC LAMINATE ON VERTICAL SURFACES, MS1B SOLID POLYMER ON ALL OTHER SURFACES. PROVIDE 4" WIRE PULL HARDWARE (TYP.) ML1A PLASTIC LAMINATE ON VERTICAL SURFACES, MS1C SOLID POLYMER COUNTERTOP. PROVIDE CONCEALED LED TASK LIGHTING UNDER UPPER CABINETS. PROVIDE 4" WIRE PULL HARDWARE (TYP.) ML1A PLASTIC LAMINATE ON VERTICAL SURFACES, MS1C SOLID POLYMER ON ALL OTHER SURFACES. PROVIDE 4" WIRE PULL HARDWARE (TYP.) ML1A PLASTIC LAMINATE ON VERTICAL SURFACES, MS1C SOLID POLYMER ON ALL OTHER SURFACES. PROVIDE 4" WIRE PULL HARDWARE (TYP.) ML1A PLASTIC LAMINATE ON VERTICAL SURFACES, MS1C SOLID POLYMER ON ALL OTHER SURFACES. PROVIDE 4" WIRE PULL HARDWARE (TYP.) ML1A PLASTIC LAMINATE ON VERTICAL SURFACES. PROVIDE 4" WIRE PULL HARDWARE (TYP.) PRODUCT: SM20-N COLOR: 517 TETON WHITE TEXTURE: SHADOW GRAIN THICKNESS: HEIGHT: PRODUCT: HIGH IMPACT WALL COVERING	TAN PALETTE SMOKEY BROWN PALETTE TAN PALETTE GREEN PALETTE GREEN PALETTE SMOKEY BROWN PALETTE SMOKEY BROWN PALETTE BY SYMBOL, REFER TO ARCHITECTURE PLANS FOR LOCATIONS REFER TO INTERIOR ROOM STYLES SCHEDULE FOR LOCATIONS	CG-4	
M-1 M-2 M-3 M-4 M-5 M-7 M-8 M-9	COMBINATION SURFACE MOUNTED CORNER GUARD SURFACE MOUNTED CRASH RAIL	N/A N/A N/A N/A N/A N/A N/A N/A	ML1A ON VERTICAL SURFACES, ML1B PLASTIC LAMINATE COUNTERTOP, MS1B SOLID POLYMER TRANSACTION COUNTER. PROVIDE 4" WIRE PULL HARDWARE (TYP.) ML1A ON VERTICAL SURFACES, ML1E PLASTIC LAMINATE COUNTERTOP, MS1A SOLID POLYMER TRANSACTION COUNTER. PROVIDE 4" WIRE PULL HARDWARE (TYP.) ML1A PLASTIC LAMINATE ON VERTICAL SURFACES, ML1E ON ALL OTHER SURFACES. PROVIDE 4" WIRE PULL HARDWARE (TYP.) ML1A ON VERTICAL SURFACES, ML1G PLASTIC LAMINATE COUNTERTOP, MS1C SOLID POLYMER TRANSACTION COUNTER. PROVIDE 4" WIRE PULL HARDWARE (TYP.) ML1A PLASTIC LAMINATE ON VERTICAL SURFACES, MS1A SOLID POLYMER COUNTERTOP. PROVIDE CONCEALED LED TASK LIGHTING UNDER UPPER CABINETS. PROVIDE 4" WIRE PULL HARDWARE (TYP.) ML1A PLASTIC LAMINATE ON VERTICAL SURFACES, MS1A SOLID POLYMER ON ALL OTHER SURFACES. PROVIDE 4" WIRE PULL HARDWARE (TYP.) ML1A PLASTIC LAMINATE ON VERTICAL SURFACES, MS1B SOLID POLYMER COUNTERTOP. PROVIDE CONCEALED LED TASK LIGHTING UNDER UPPER CABINETS. PROVIDE 4" WIRE PULL HARDWARE (TYP.) ML1A PLASTIC LAMINATE ON VERTICAL SURFACES, MS1B SOLID POLYMER COUNTERTOP. PROVIDE CONCEALED LED TASK LIGHTING UNDER UPPER CABINETS. PROVIDE 4" WIRE PULL HARDWARE (TYP.) ML1A PLASTIC LAMINATE ON VERTICAL SURFACES, MS1C SOLID POLYMER ON ALL OTHER SURFACES. PROVIDE 4" WIRE PULL HARDWARE (TYP.) ML1A PLASTIC LAMINATE ON VERTICAL SURFACES, MS1C SOLID POLYMER OUNTERTOP. PROVIDE CONCEALED LED TASK LIGHTING UNDER UPPER CABINETS. PROVIDE 4" WIRE PULL HARDWARE (TYP.) ML1A PLASTIC LAMINATE ON VERTICAL SURFACES, MS1C SOLID POLYMER ON ALL OTHER SURFACES. PROVIDE 4" WIRE PULL HARDWARE (TYP.) PRODUCT: SM20-N COLOR: 517 TETON WHITE TEXTURE: SHADOW GRAIN THICKNESS: HEIGHT: FULL HEIGHT UNO WING: 3" PRODUCT: COLOR: 517 TETON WHITE TEXTURE: SHADOW GRAIN THICKNESS: HEIGHT: PRODUCT: HIGH IMPACT WALL COVERING COLOR: VARIES	TAN PALETTE SMOKEY BROWN PALETTE TAN PALETTE TAN PALETTE GREEN PALETTE SMOKEY BROWN PALETTE SMOKEY BROWN PALETTE BY SYMBOL, REFER TO ARCHITECTURE PLANS FOR LOCATIONS REFER TO INTERIOR ROOM STYLES SCHEDULE FOR LOCATIONS	CG-4	

ALL SYMI	BOLS NOT NECESSARILY USED		
XXX	ROOM NUMBER ROOM STYLE	<u> </u>	ALIGN INDICATED SURFACES
		<i></i> -	ACCENT WALL FINISH
			→ DENOTES FINISH AND AREA
F	FLOOR FINISH C CARPET	С	CEILING FINISH A ACOUSTICAL CEILING TILE
	V VINYL T TILE - SPECIALTY OR COMBINATION		P FLAT LATEX PAINTED GYPSIM BO - SPECIALTY OR COMBINATION
В	BASE FINISH	М	MILLWORK FINISH S SOLID SURFACE
J	V RUBBER BASE R INTEGRAL BASE		L PLASTIC LAMINATE - SPECIALTY OR COMBINATION
W	T TILE - SPECIALTY OR COMBINATION WALL FINISH	S	SPECIALTY - SPECIALTY OR COMBINATION
	C WALLCOVERING P EGGSHELL LATEX PAINT S SEMIGLOSS LATEX PAINT	EX	EXISTING FINISH TO REMAIN
	T TILE - SPECIALTY OR COMBINATION		

ALL ROOMS STYLES ARE NOT NECESSARILY USED. PROVIDE 10% ATTIC STOCK OF PORCELAIN TILE, RESILIENT WALL BASE, PAINT, WALL PROTECTION, PLASTIC LAMINATE, SOLID POLYMER, ACOUSTICAL CEILING TILE, AND WINDOW TREATMENTS TO HHS FACILITIES. WHERE FLOORING MATERIALS OF DIFFERENT THICKNESSES ABUT ONE ANOTHER, PROVIDE JOHNSONITE SUBFLOOR LEVELERS AND METAL DIVIDER STRIPS TO ELIMINATE FINISHED FLOOR LEVEL CHANGES.

WHERE FLOORING MATERIAL CHANGES AT DOORWAYS, TERMINATE FLOORING AT CENTER OF DOOR LEAF. AS CASED OPENINGS, TERMINATE FLOORING AS INDICATED ON FINISH PLAN. INSTALL FLOOR/WALL TILE CENTERED (UNO) AT A 90 DEGREE ANGLE TO ADJACENT WALL, UNO. TERMINATE ACCENT PAINT COLORS AND WALL TILE INSTALLATIONS AT INSIDE CORNERS OF WALLS OR

BEHIND FULL HEIGHT CORNER GUARDS, UNO. PROVIDE CORNER GUARDS AT ALL OUTSIDE CORNERS, EXCEPT SEATING AREAS (REFER TO FINISH LEGEND FOR SIZE AND TYPE). PROVIDE FULL-HEIGHT, SURFACE MOUNTED END GUARDS AT THE TERMINATION OF ALL WING WALLS.

H. FINISH ALL METAL ACCESS PANELS AND INTERIOR SUPPLY/RETURN DIFFUSERS TO MATCH ADJACENT CEILING OR WALL SURFACE. PROVIDE FACTORY-PAINTED SPRINKLER HEADS TO MATCH ADJACENT SURFACE.

PAINT ALL GYPSUM BOARD CEILINGS CP1A UNLESS NOTED OTHERWISE ON REFLECTED CEILING PLAN. WHERE ACCENT PAINT COLORS ARE INDICATED, PAINT THE VERTICAL AND HORIZONTAL SURFACES OF GYPSUM BOARD SOFFITS WITH SPECIFIED ACCENT COLOR (REFER TO FINISH LEGEND). PAINT ALL HOLLOW METAL DOORS, INTERIOR DOOR FRAMES, AND INTERIOR WINDOW FRAMES WITH WS1C (REFER TO FINISH LEGEND) SEMI-GLOSS LATEX PAINT. ALUMINUM DOOR AND WINDOW FRAMES ARE CLEAR

ALIGN FT1A FLOOR TILE GROUT JOINTS WITH WT1A WALL TILE GROUT JOINTS IN TOILET ROOMS.

APPLY USG FIRST COAT SHEETROCK PRIMER PRIOR TO PAINTING WALLS IN CORRIDORS LONGER THAN 50'. PROVIDE RESILIENT TOP CAPS AT TERMINATION OF INTEGRAL COVE BASE. CAULK TOP EDGE TO WALL WITH

COLOR MATCHED SEALANT. AT TASK WORK AREAS, PROVIDE LIGHTING UNDER UPPER CABINETS. PROVIDE SEISMIC BRACING AT ALL ACOUSTICAL CEILING TILE/PANEL INSTALLATIONS.

ALL ADHESIVES SHALL BE LOW voc. INSTALL BACKSPLASHES AND SIDESPLASHES AT ALL COUNTERTOP LOCATIONS. ALL ELECTRICAL SWITCHES USED THROUGHOUT BUILDING SHALL BE WHITE WITH COVER PLATE TO MATCH. REVISIONS TASK BY

ISSUE FOR PERMIT &



HARRIS HEALTH SYSTEM 2525 Holly Hall Street,

Houston, Tx 77054

ARCHITECT & ENGINEERS:





Firm Registration #:

SPRING BRANCH **HEALTH CENTER**

PROJECT LOCATION:
9801 Long Point, Houston,
Tx 77055

SHEET TITLE: INTERIOR FINISHES
SCHEDULE & GENERAL NOTES

DATE: 11/04/13


SHEET NUMBER:

I-001

SCALE:

As indicated CHECKED BY: Checker

ROOM STYLE	FLOOR - FIELD	BASE	WALL	CEILING	MILLWORK	COMMENTS
						WALL DROTECTION
1	F) /1 A	D) /1 A	WD1C	CA1A		WALL PROTECTION
1	FV1A	BV1A	WP1G	CA1A	=	W/CRASHRAIL 6" AFF
2	F\/1 A	D) /1 A	WD1C	CA1A	N / L 1 / A	WALL PROTECTION
2	FV1A	BV1A	WP1G	CA1A	ML1A	W/CRASHRAIL 6" AFF
3	FV1A	BV1A	WP1G	CA1A	M7	WALL PROTECTION
4	FD1 4	DD1 4	WD1C	C 4 1 4		WALL PROTECTION
4	FR1A	BR1A	WP1G	CA1A	- NAL 1 E	W/CRASHRAIL 6" AFF
5	FC1A	BV1A	WP1G	CA1A	ML1F	
6 7	FC1 A	D) /1 A	W/D1C	6.2	NAO	
8	FC1A	BV1A	WP1G	C-3	M8	
0	FC1A	BV1A	WP1G	C-3	M6	
9	EC1A	D\/1 A	WP1G	CA1A		
	FC1A	BV1A		2004 TO 100 TO 1	- N/I 1 E	
10	FC1B	BV1A	WP1G	CA1A	ML1F	
11	FC1B	BV1A	WP1G	CA1A	ML1F	
12	FC1B	BV1A	WP1G	C-3	_	
13						
14	FC1B	BV1A	WP1G	C-3	M10	
15	FC1B	BV1A	WP1G	CA1A	(40)	
16						
17	FC1B	BV1A	WP1G	CA1A	M3	
18	FR1A	BR1A	WP1G	CA1A	-	ACCENT WALL PAINT AT SINK
19	FT1A	BT1A	W2	CA1A	=	TILE AT WET WALL
20	FT1A	BT1A	W1	CA1A	-	TILE AT WET WALL
21	FV1A	BV1A	WP1G	C-3	en en	
22	FV1A	BV1A	WP1G	CA1A	M3	
23	FV1A	BV1A	WP1G	CA1A	=	ACCENT WALL PAINT AT SINK
24	FV1A	BV1A	WP1G	CA1A	M7	ACCENT WALL PAINT AT SINK
25	FV1A	BV1A	WP1G	CA1A	449	ACCENT WALL PAINT AT SINK
26	FV1A	BV1A	WP1G	CA1A	M5	ACCENT WALL PAINT AT SINK
27	FV1A	BV1A	WP1G	CA1A	M9	ACCENT WALL PAINT AT SINK
28						
29	FV1A	BV1A	WP1G	CA1A	-	
30	FV1A	BV1A	WP1G	C-2	<u> </u>	
31						
32	FV1A	BV1A	WP1H	CA1A	<u> </u>	
33	F2	BV1A	WP1G	C-1		
34	F2	BV1A	WP1G	C-3	M1	
35	F5	BV1A	WP1H	C-3	M2	
36	F4	BV1A	WP1G	C-3	229	
37	F6	BV1A	WP1G	C-3	M4	
38	F6	BV1A	WP1G	C-3	<u>un</u>	
39	F6	BV1A	WP1H	C-3	M4	
40	F3	BV1A	WP1G	C-3	<u>sees</u>	
41	FV1A	BV1A	WP1G	CA1A	=	
42	FV1A	BV1A	WP1G	ETS	-	
43	FV1A	BV1A	WP1G	CP1A		
44	FT1A	BT1A	W2	CA1A	MS1C	
45	F1	BV1A	WP1G	C-3	M3	
46	F7	BV1A	WP1G	CA1A	- 0	
47	F7	BV1A	WP1G	C-3	=	
48	FR1A	BR1A	WP1G	CA1A	M5	
49	FC1C	BV1A	WP1G	C-3	M6	
2000 20	1			_		-
50	FC1C	BV1A	WP1G	CA1A	M5	
2000 20	FC1C FC1C FV1A	BV1A BV1A BV1A	WP1G WP1G WP1G	CA1A CA1A	M5 M3 M5	

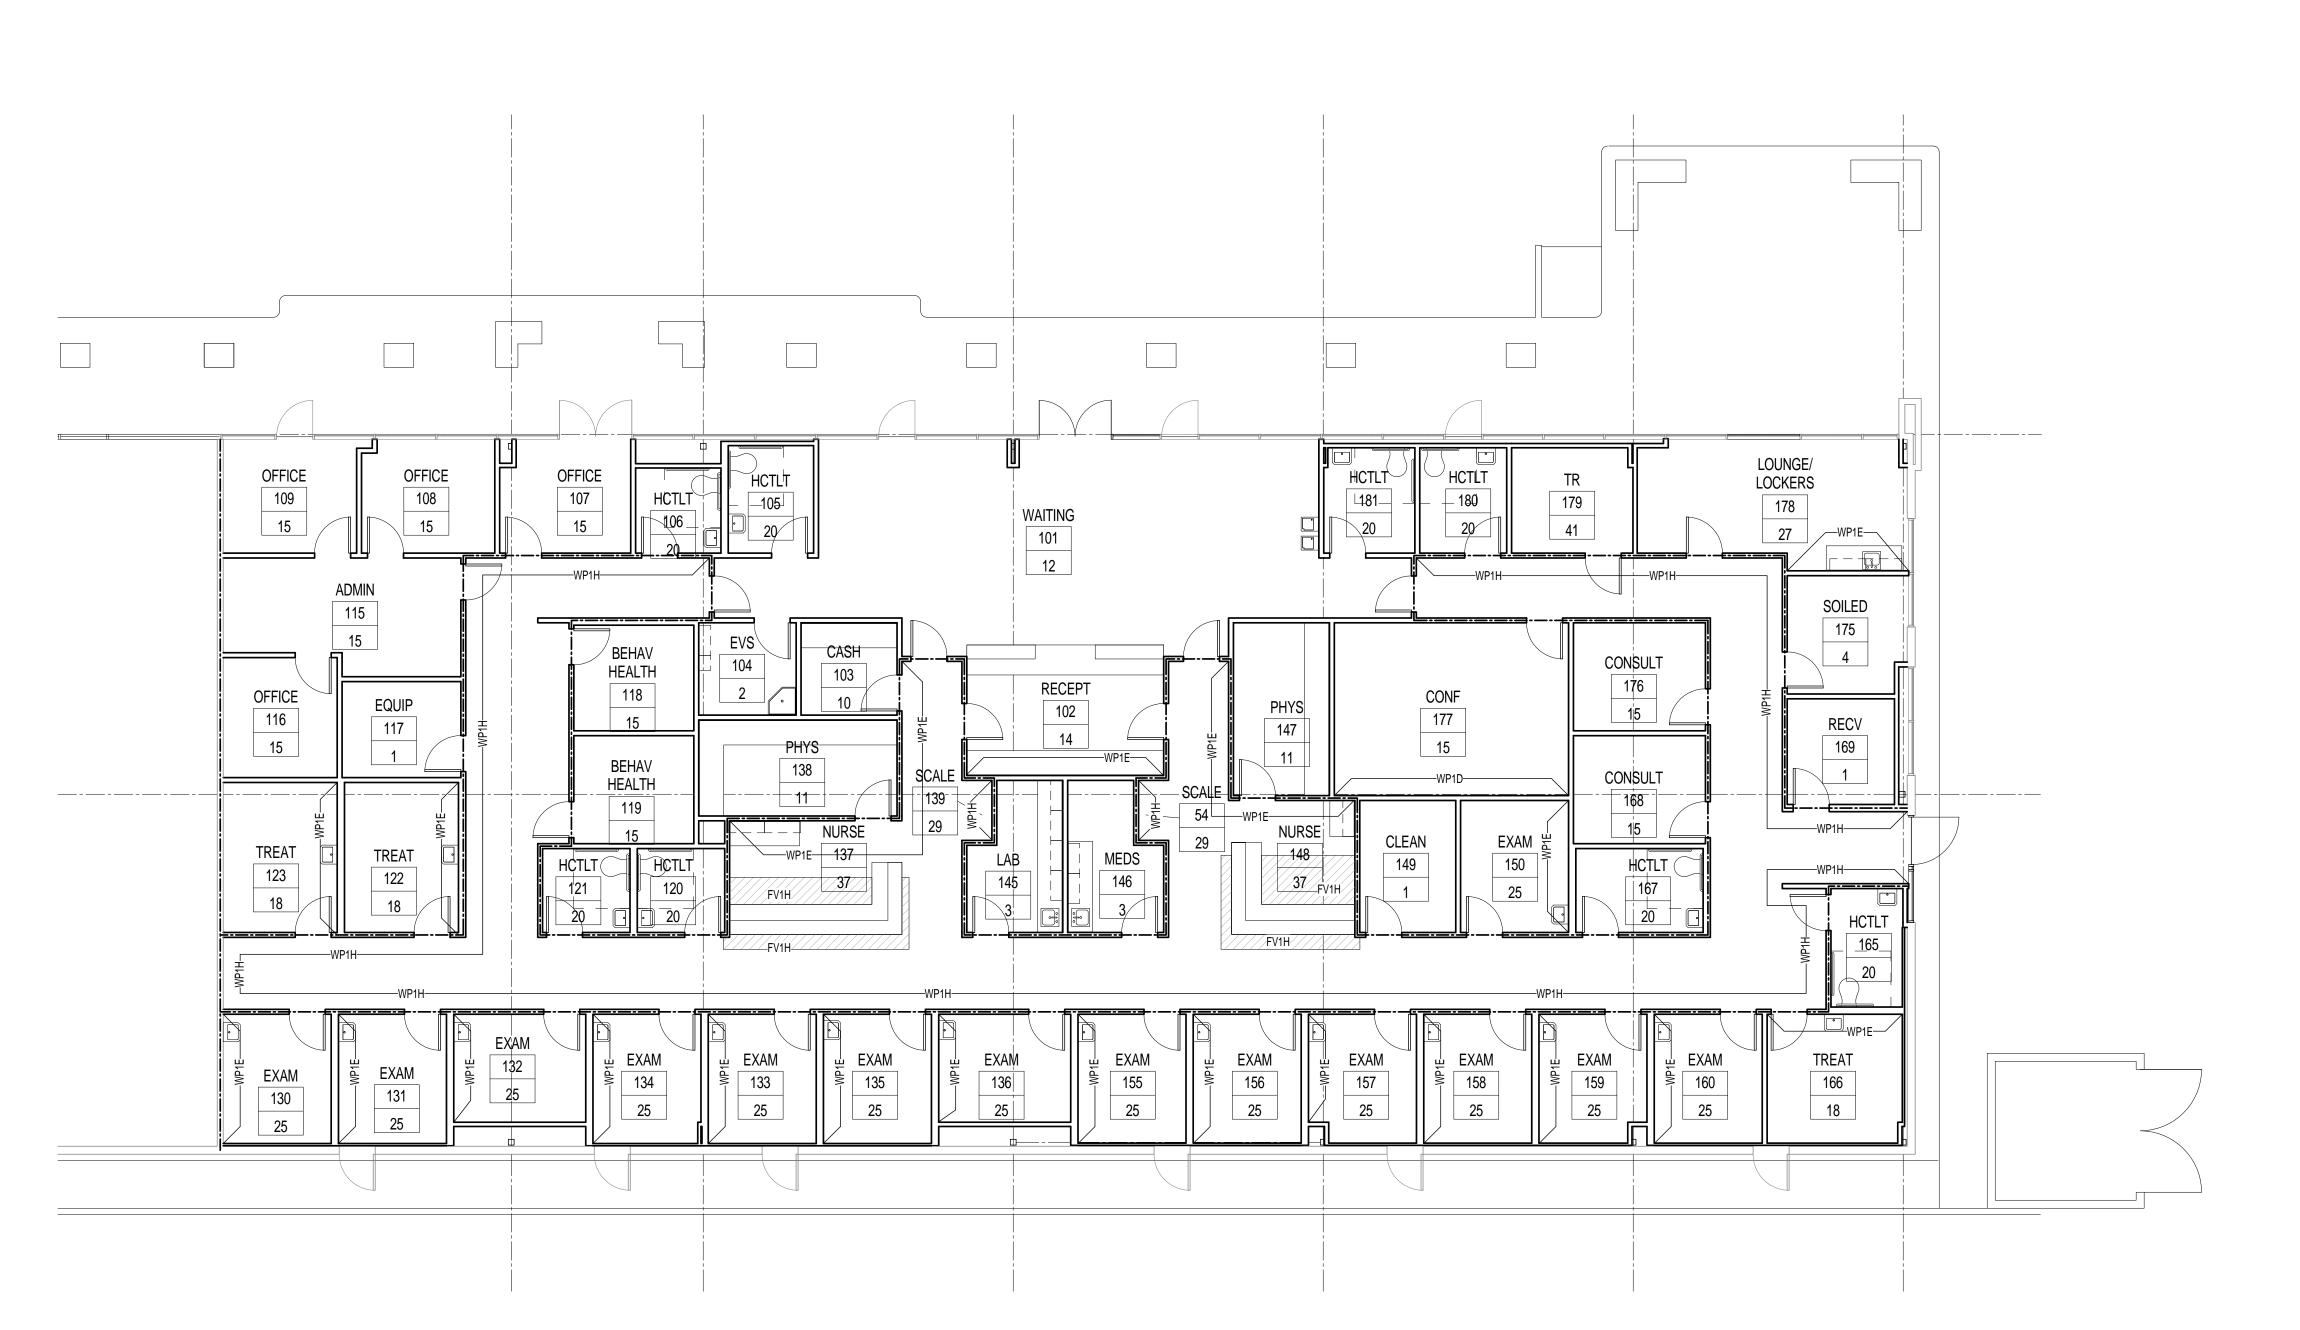



HARRIS HEALTH SYSTEM 2525 Holly Hall Street, Houston, Tx 77054

ARCHITECT & ENGINEERS:



MEP: Johnston, LLC



Firm Registration #: PROJECT TITLE: SPRING BRANCH HEALTH CENTER

PROJECT LOCATION:
9801 Long Point, Houston,
Tx 77055

SHEET TITLE: LEVEL 1 INTERIOR FINISHES PLAN

11/04/13 DATE:

SHEET NUMBER:

I-101

SCALE:


JOB NO:

As indicated

DRAWN BY:

CHECKED BY: Checker

1 LEVEL 1 INTERIOR FINISHES PLAN 1/8" = 1'-0"

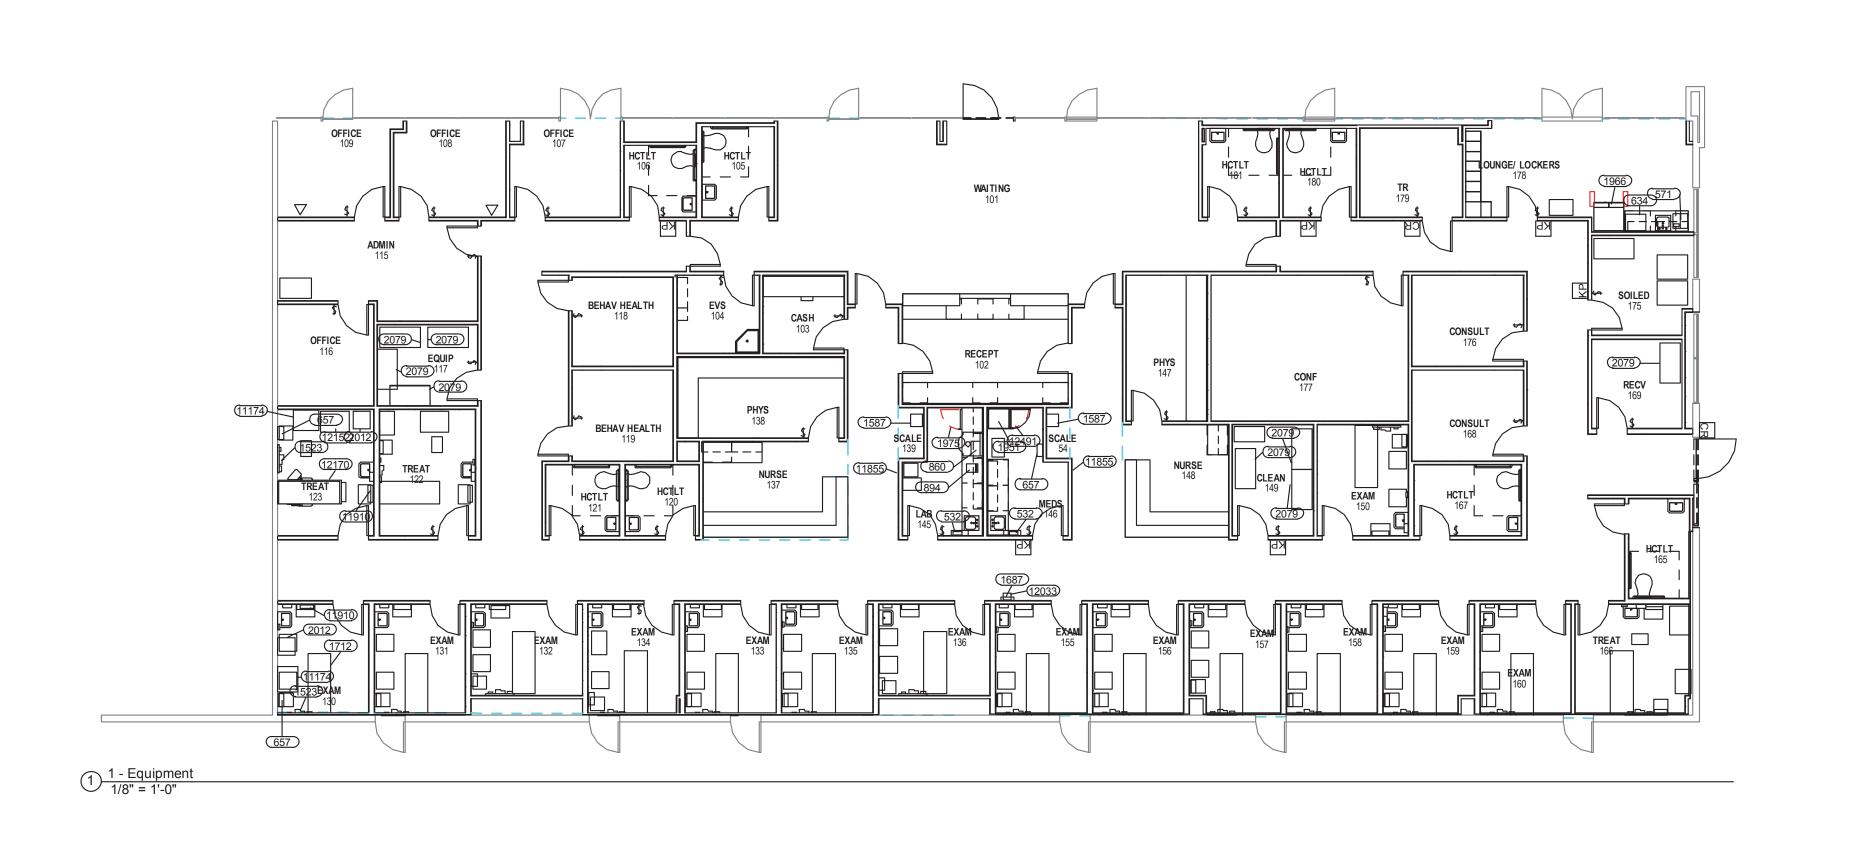

		REVIS	ONS		
		No.	Date	TASK	BY
	EQUIPMENT LIST	$ \longrightarrow$			
					+
532	GLOVE DISPENSER, SINGLE WALL MTD.				
571	COFFEE MAKER, 3 BURNER W/ DECANTERS				
634	MICROWAVE				
657	CONTAINER, "SHARPS" DISPOSER UNIT 5QT				
860	ANALYZER, URINALYSIS	l 			
894	CENTRIFUGE, COUNTERTOP				+
1523	DIAGNOSTIC SET, WALL MTD.				
1587	SCALE				
1687	CABINET, AED. SEMI-RECESSED				
1712	TABLE, EXAM				
1951	FREEZER, SMALL				
1966	REFRIGERATOR, W/ FREEZER, ICEMAKER FRENCH DOORS				
1975	REFRIGERATOR W/ FREEZER, SMALL				+
2012	CART, STORAGE				
2079	SHELVING UNIT, ADJUSTABLE 24 x 48	l			
11174	CART, PRINTER	 			
11855	STADIOMETER				
11910	GLOVE DISPENSER, TRIPLE, WALL MTD				
12033	DEFIBRILLATOR, AED				
12152	CART, PROCEDURE				+
12170	TABLE, EXAM, POWER				
12491	REFRIGERATOR, SMALL (MEDS)				

HARRIS HEALTH SYSTEM 2525 Holly Hall Street, Houston, Tx 77054

ARCHITECT & ENGINEERS:



ARCHITECT:
Johnston, LLC
MEP:
Johnston, LLC
CIVIL:
Johnston, LLC

Firm Registration #: PROJECT TITLE:
SPRING BRANCH
HEALTH CENTER

PROJECT LOCATION: 9801 Long Point, Houston, Tx 77055

12727 Featherwood, Suite 285
Houston, TX 77034
TEL: 281.480.5560
www.mplusmedtech.com
PROJECT NUMBER: 000-000

GENERAL PLAN NOTES This plan is not to be used for Actual construction

This plan is submitted to suggest locations and quantity of medical equipment. In preparing this plan and supporting vendor specification information every effort has been made to indicate the actual equipment to be installed. For details, refer to associated specification information of the referenced equipment item.

Mazzetti expresses no warranty or accepts any liability associated with the use of any vendor's equipment specification and/or installation information.

- Refer to Equipment Specification books for exact quantities and specification of equipment.
 Refer to architectural elevations for exact location of wall mounted equipment.
 Contractor shall coordinate with owner on delivery and installation of owner fumished equipment.

SHEET TITLE: **EQUIPMENT**

11/4/2013

SHEET NUMBER:

DRAWN BY: CHECKED BY:

SCALE: DIANE CHAVERRIA 1/8" = 1'-0" PETI JONES THOMPSON

Company Comp	CHANICAL SYMBOLS (SOME SYMBOLS MAY I BREVIATIONS	NOT BE USED ON THE DRAWINGS) MECHANICAL EQUIPMENT	DUCTWORK			DUCTWORK (CONTINUED)	PIPING SYMBOLS	GENERAL NOTES
The second column 1	AD: ACCESS DOOR	FD SIDE DAMPED	DOUBLE LINE	SINGLE LINE		DIFFUSER FLOW ARROWS (IF NO ARROWS ARE SHOWN,		REFER TO SPECIFICATIONS FOR MATERIALS AND METHODS FOR CONSTRUCTION
Company Comp	AHU: AIR HANDLING UNIT BMCS: BUILDING MANAGEMENT AND CONTROL	. F9D		—	FLEXIBLE DUCT	DIFFUSER IS 4-WAY THROW)		2. ALL DUCT DIMENSIONS INDICATED ON THE DRAWINGS ARE NET
An in the content of the content o	SYSTEM BCU: BLOWER COIL UNIT	COMBINATION FIRE/SMOKE DAMPER			(TYP. FOR ALL UNLESS OTHERWISE	SUPPLY DIFFUSER	` '	ACTUAL SIZE OF SHEETMETAL DUCT TO ALLOW FOR INTERNAL
Company Comp	OP: BOTTOM OF PIPE	SMOKE DAMPER			45° MITERED ELBOW W/ TURNING	RETURN REGISTER	——○—— TEE OUTLET UP	
A	AT: ENTERING AIR TEMPERATURE WT: ENTERING WATER TEMPERATURE	VFD VARIABLE FREQUENCY DRIVE			OTHERWISE NOTED)	EXHAUST REGISTER		POSSIBLE CLEAR HEIGHT UNDERNEATH. (BETWEEN STRUCTURE OR
Column C	: FIRE DAMPER	CP CONTROLLER OR CONTROL PANEL			90° LONG RADIUS ELBOW			4. WHERE APPROVAL CODES HAVE BEEN ESTABLISHED BY OSHA,
Company Comp	TU: FAN-POWERED TERMINAL UNIT	₽₹∅→- UNIT HEATER	\triangleright	/	45° LONG RADIUS ELBOW			ASTM, ARI, NEC, NFPA, SMACNA, OR THE STATE FIRE INSURANCE
Company Comp	AT: LEAVING AIR TEMPERATURE WT: LEAVING WATER TEMPERATURE				CONCENTRIC TRANSITION	SIDEWALL RETURN GRILLE	DIRECTION OF FLOW	
The control and the control	O.: NORMALLY CLOSED	DUCT-MOUNTED FILTER			ECCENTRIC TRANSITION	LOUVER W/ SCREEN (IN WALL)		EQUIPMENT IN OPERATING CONDITION FREE OF OBJECTIONABLE
Total Action	/A: NOT APPLICABLE	DUCT-MOUNTED WATER COIL			RECTANGULAR TO ROUND TRANSITION	SLOT OR LINEAR DIFFUSER		
	A: RETURN AIR AF: RELIEF AIR FAN	DUCT-MOUNTED ELECTRIC COIL			RECTANGULAR BRANCH TAP	RETURN AIR SLOT DEVICE		REVISIONS, AMENDMENTS OR SUPPLEMENTS OF APPLICABLE
): SMOKE DAMPER	DUCT-MOUNTED SOUND ATTENUATOR				DUCT WITH LINER	FLEXIBLE CONNECTION	STATE AND LOCAL AUTHORITIES HAVING JURISDICTION IN EFFECT
100 100	DS: TOP OF STEEL	SINCLE_DUCT		<u>₽</u>	(W/ VOLUME DAMPER)	MANUAL DAMPER		7. COORDINATE WORK SO THAT INTERFERENCES BETWEEN PIPING,
AND	P: TYPICAL V: VARIABLE AIR VOLUME	TERMINAL UNIT	-		DUCT CAP			SERVICE ACCESS AND BUILDING STRUCTURE WILL BE AVOIDED.
		FAN-POWERED			DUCT CONTINUATION - ROUND			8. COORDINATE INSTALLATION OF DUCTWORK WITH FIRE PROTECTION SYSTEMS AND ROOF DRAINAGE SYSTEMS.
PROCESS		IERMINAL UNII		<u> </u>	DUCT CONTINUATION — RECTANGULAR			9. COORDINATE ALL SLAB PENETRATIONS AND SLEEVES PRIOR TO
Continue		SINGLE-DUCT TERMINAL UNIT W/ HEATING COILS	- [AD]	—	DUCT ACCESS DOOR	PIPING LABELS		
## Company of the com	SYMBOLS					cws CONDENSER WATER SUPPLY	<u>[5]</u>	CEILINGS WHERE ACCESS IS REQUIRED TO CONCEALED PLUMBING EQUIPMENT, VALVES, CONTROLS AND OTHER DEVICES. COORDINATE
10 10 10 10 10 10 10 10	YY DETAIL TITLE						اما	
### ACCOUNT AND PART OF THE PA	XX.XX SCALE: 1/?" = 1'-0"	DUAL-DUCT TERMINAL UNIT W/ SOUND ATTENUATOR			RETURN DUCT (UP / DOWN)		1	ARCHITECTURAL AND PLUMBING DRAWINGS AND MECHANICAL
## ACCURAGE OF THE PARTY OF THE		ROOF EXHAUST FAN			EXHAUST DUCT (UP / DOWN)		─────────────────────────────────────	12 ALL RECTANGULAR ELBOWS SHALL BE LONG-RADIUS ELBOWS (MIN.
## A PART OF THE TABLE OF THE T	—DRAWING/DETAIL NUMBER—			<u> </u>	ROUND DUCT (UP / DOWN)	HWR HEATING HOT WATER RETURN		1.5W) UNLESS OTHERWISE SHOWN OR NOTED. PROVIDE TURNING VANES IN ALL ELBOWS EXCEPT TRANSFER DUCTS
Marked Mark	入人				FLAT OVAL DUCT (UP / DOWN)			13. COORDINATE THE DUCTWORK FABRICATION DRAWINGS WITH THE
Part	A	(SIZE. SHAPE WILL VARY)			ŖECTANGULAR DŲCT SIZE			ARCHITECTURAL DRAWINGS. PROVIDE SMOKE AND FIRE—SMOKE DAMPERS AT ALL LOCATIONS WHERE THEY ARE REQUIRED, AS
Wind colors	X XX.XX SECTION			18/14	,			
Control of the cont		(SIZE, SHAPE WILL VARY)		18ø		CR GRAVITY CONDENSATE RETURN		
Control Cont	NORTH ARROW	ARCHITECTURAL BACKGROUND	<u>{ 18/14⊕</u> }	18/14÷	(WIDTH x HEIGHT)			15. VERIFY EXACT LOCATION OF PARTITIONS, WALLS, FIXTURES, ETC. WITH DIMENSIONED ARCHITECTURAL PLANS OR EXISTING BUILDING
TOTAL STATE OF THE PROPERTY OF					FLEXIBLE DUCT CONNECTION			
Company Comp	AIR DEVICE TAG (REFER TO AIR DEVICE SCHEDULE FOR DETAILS)	EXISTING DUCT TO REMAIN] [IN-LINE 90 DEGREE DROP (RISE) IN DUCT (HIDDEN LINE INDICATES			
March Marc	·	│	<u> </u>	— <u>+ UP</u> +		RS REFRIGERANT SUCTION LINE	GAUGE COCK	COORDINATED WITH CEILING GRID PATTERN AND/OR LIGHT
MOCH ANEXON MOCH AND ANEXON MOCH ANEXON MOCH AND ANEXON MOCH A				<u>DN</u>	INCLINED DROP IN DUCT	RL REFRIGERANT LIQUID LINE	DS.	CENTERED IN THE LAY—IN TEE BAR CEILING TILE, UNLESS NOTED OTHERWISE. REFER TO ARCHITECTURAL REFLECTED CEILING PLAN.
## ADDITIONAL CONTRACTOR NOTES ## ADDITIONAL CONTRACTOR NOTES	TYPE OF SERVICE						∡	17. NO NEW DUCTWORK SHALL BE MOUNTED CLOSER THAT 3" BELOW
### 10 CAN THE AREA OF STREET OF STR	RISER BUBBLE	MISCELLANEOUS	·		DUCT EXTRACTOR		<u> </u>	
Fig. 12 Fig.		POINT OF CONNECTION (NEW TO EXISTING)			SPLITTER DAMPER			
SHAPE PARK MONTH PRESSURE PARK MONTH P	<u>AHU-1</u> EQUIPMENT TAG	POINT OF DISCONNECTION			MAJOR SPLIT	BRINE	—————————————————————————————————————	19. CONTRACTOR SHALL MOUNT NEW THERMOSTATS OR TEMPERATURE
ESTABLE AND PROPERTY AND THE PROPERTY AN	1 KEYNOTE	TYPICAL LEADERS		H	SIDEWALL REGISTER TAP			
ADDITIONAL CONTRACTOR NOTES ADDITIONAL CONTR	REVISION		in in	<u> </u>	DUCT MOUNTED HUMIDIFIER	++ AAA ++ EXISTING PIPE TO BE REMOVED, "AAA" DENOTES TYPE		20. CONTRACTOR SHALL VISIT THE SITE PRIOR TO SUBMITTING A BID AND DETERMINE ALL CONDITIONS WHICH MAY AFFECT HIS WORK.
ADDITIONAL CONTRACTOR NOTES DECLAR ASSESSMENT OF THE CONTRACTOR NOTES ADDITIONAL CONTRACTOR NOTES ADDITIONAL CONTRACTOR NOTES A PROMISE OF A SECURITY OF THE CONTRACTOR NOTES A PROMISE OF THE CONTRACTOR NOTES O		→ → AIR FLOW INDICATOR		<u>— M</u>	MOTORIZED DAMPER			AWARD OF CONTRACT AND START OF CONSTRUCTION WHICH
ADDITIONAL CONTRACTOR NOTES 4 PROME MEDICAL PROPERTY DESCRIPTION OF THE PROPERTY OF THE PROPE	ROL INSTRUMENTS				WOTONIZED DAWN EN			CONTRACTOR VISITED THE SITE & OBSERVED CONDITIONS SHALL
A. DRAMINGS ARE DIAGRAMMATIC REFER TO ARGHITCURAL DRAMINGS FOR DIAGRAMINGS FOR DIAGRAMINGS FOR DIAGRAMINGS. BUT AND COMPANY TO SALE DRAMINGS. B. MO CHANGES OF DRAMEOUN TO THE ENDIAGES. C. MUSTING AND COMPANY TO THE DRAMEOUN THE SALE DRAMEOUN TO THE DRAMEOUN FOR THE DRAMEOUN F	HUMIDITY SENSOR/HUMIDISTAT							
DRAWNIS FOR DIVENSIONS. DO NOT SCALE DRAWNINGS. B. NO CHANGES ARE TO BE WARD ON THE ENONEER. AND WINDUIT IN HOWELDED OR CONSIST OF THE ENONEER. C. ALL MATERIALS, PARK THE CONTROL OR HE HAS C								ADDITIONAL CONTRACTOR NOTES:
INDUILEDEC OR CONSENT OF THE ENGINEER. C. ALL PROMISE AND SHALL BY NOW SHALL BE NEW, AND FREE FROM EFFECTS, OUASITY OF WARRS SHALL BE NEW, AND FREE FROM EFFECTS, OUASITY OF WARRS SHALL BE NEW, AND FREE FROM EFFECTS AND FROM SHALL PROMISE AND ACCEPTED STANDARDS. D. CONTRACTOR SHALL ENSURE THAT ALL FINISH MATERIAL PROMISE AND ALL PRISE AND ALL DISTRICT ALL FINISH MATERIAL PROMISE AND ALL PROMISE								
C. ALL MATERIALS, PART AND EQUIPMENT FURNISHED BY THE CONTRACTOR IN THE WORK SHALL BE IN A CORPORATE WITH GENERALLY ACCEPTED STANDARDS. D. CONTRACT WAS AND A CONTRACT WITH GENERAL SHAPE AND ACCEPTED STANDARDS. D. CONTRACT SHAPE AND ACCEPTED STANDARDS. ELISS WITH ADJACENT SURFACES AND JOINTS (EXCEPT WHEN MORCAED OTHERWES). E. IT SHALL BE THE SEPONSBULTY OF THE CONTRACTOR TO CONTRACTOR TO CONTRACT WAS AND ACCEPTED WHEN ACCEPTED AND ACCEPTED WHEN ACCEPTED WHE								B. NO CHANGES ARE TO BE MADE ON THESE PLANS WITHOUT THE KNOWLEDGE OR CONSENT OF THE ENGINEER.
D. CONTRACTOR SHALL ENSURE THAT ALL FINISH MATERIALS WILL FLUSH WITH ADJACENT SURFACES AND JOINTS (EXCEPT WHER MDICATED OTHERWISE). E. IT SHALL ENSURE RESPONSIBILITY OF THE CONTRACTOR TO C THE ARCHITECTURAL DRAWNICS BEFORE THE INSTALLATION OF WORK. SHOULD THERE BE A DISCREPANCY BETWEEN WORK SHOULD THERE BE A DISCREPANCY BETWEEN THE ARCHITECTURAL DRAWNICS WESTERN BUT AND THE ATTENTION OF THE ENGINEER PRIOR TO INSTALLATION. F. THESE ARCHITECTURAL DRAWNING SEPERESENT THE FINISHED MEP SYSTEMS AN NOT INDICATE THE METHODS OF CONSTRUCTION. THE CONTRA								C. ALL MATERIALS, PART AND EQUIPMENT FURNISHED BY THE CONTRACTOR IN THE WORK SHALL BE NEW, AND FREE FROM DEFECTS. QUALITY OF WORK SHALL BE IN ACCORDANCE WITH
E. IT SHALL BE THE RESPONSIBILITY OF THE CONTRACTOR TO C THE ARCHITECTURAL DRAWINGS BEFORE THE INSTALLATION OF WORK, SHOULD AND THE BE A DISCREPANCY BEFORE THE INSTALLATION OF WORK, SHOULD AND THE BE A DISCREPANCY BEFORE THE INSTALL BE WOUGHT TO THE ATTENTION OF THE ENGINEER PRIOR TO INSATLLATION. F. THEORY BRAWINGS REPRESENT THE FINISHED MEP SYSTEMS AN NOT INDICATE THE METHODS OF CONSTRUCTION. THE CONTRA								D. CONTRACTOR SHALL ENSURE THAT ALL FINISH MATERIALS WILL B FLUSH WITH ADJACENT SURFACES AND JOINTS (EXCEPT WHERE
INSATLLATION. F. THESE DRAWINGS REPRESENT THE FINISHED MEP SYSTEMS AN NOT INDICATE THE METHODS OF CONSTRUCTION. THE CONTRA								E. IT SHALL BE THE RESPONSIBILITY OF THE CONTRACTOR TO CHECH THE ARCHITECTURAL DRAWINGS BEFORE THE INSTALLATION OF TH WORK. SHOULD THERE BE A DISCREPANCY BETWEEN THE ARCHITECTURAL AND STRUCTURAL DRAWINGS IT SHALL BE BROUGHT TO THE ATTENTION OF THE ENGINEER PRIOR TO
I DEPONADO E FOR ALL MENTO AND METHODO FOR CORDE								

REVIS	SIONS		
No.	Date	TASK	BY
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HARRIS HEALTH SYSTEM 2525 Holly Hall Street, Houston, Tx 77054

ARCHITECT & ENGINEERS:

JOHNSTON, LLC

Engineers Architects Planners Managers

Firm Registration #:F-421 PROJECT TITLE:
SPRING BRANCH
HEALTH CENTER

PROJECT LOCATION:
9801 Long Point, Houston,
Tx 77055

SHEET TITLE:

MECHANICAL LEGENDS, SYMBOLS & GENERAL NOTES

DATE: NOV 4, 2013 DATE:

SHEET NUMBER:


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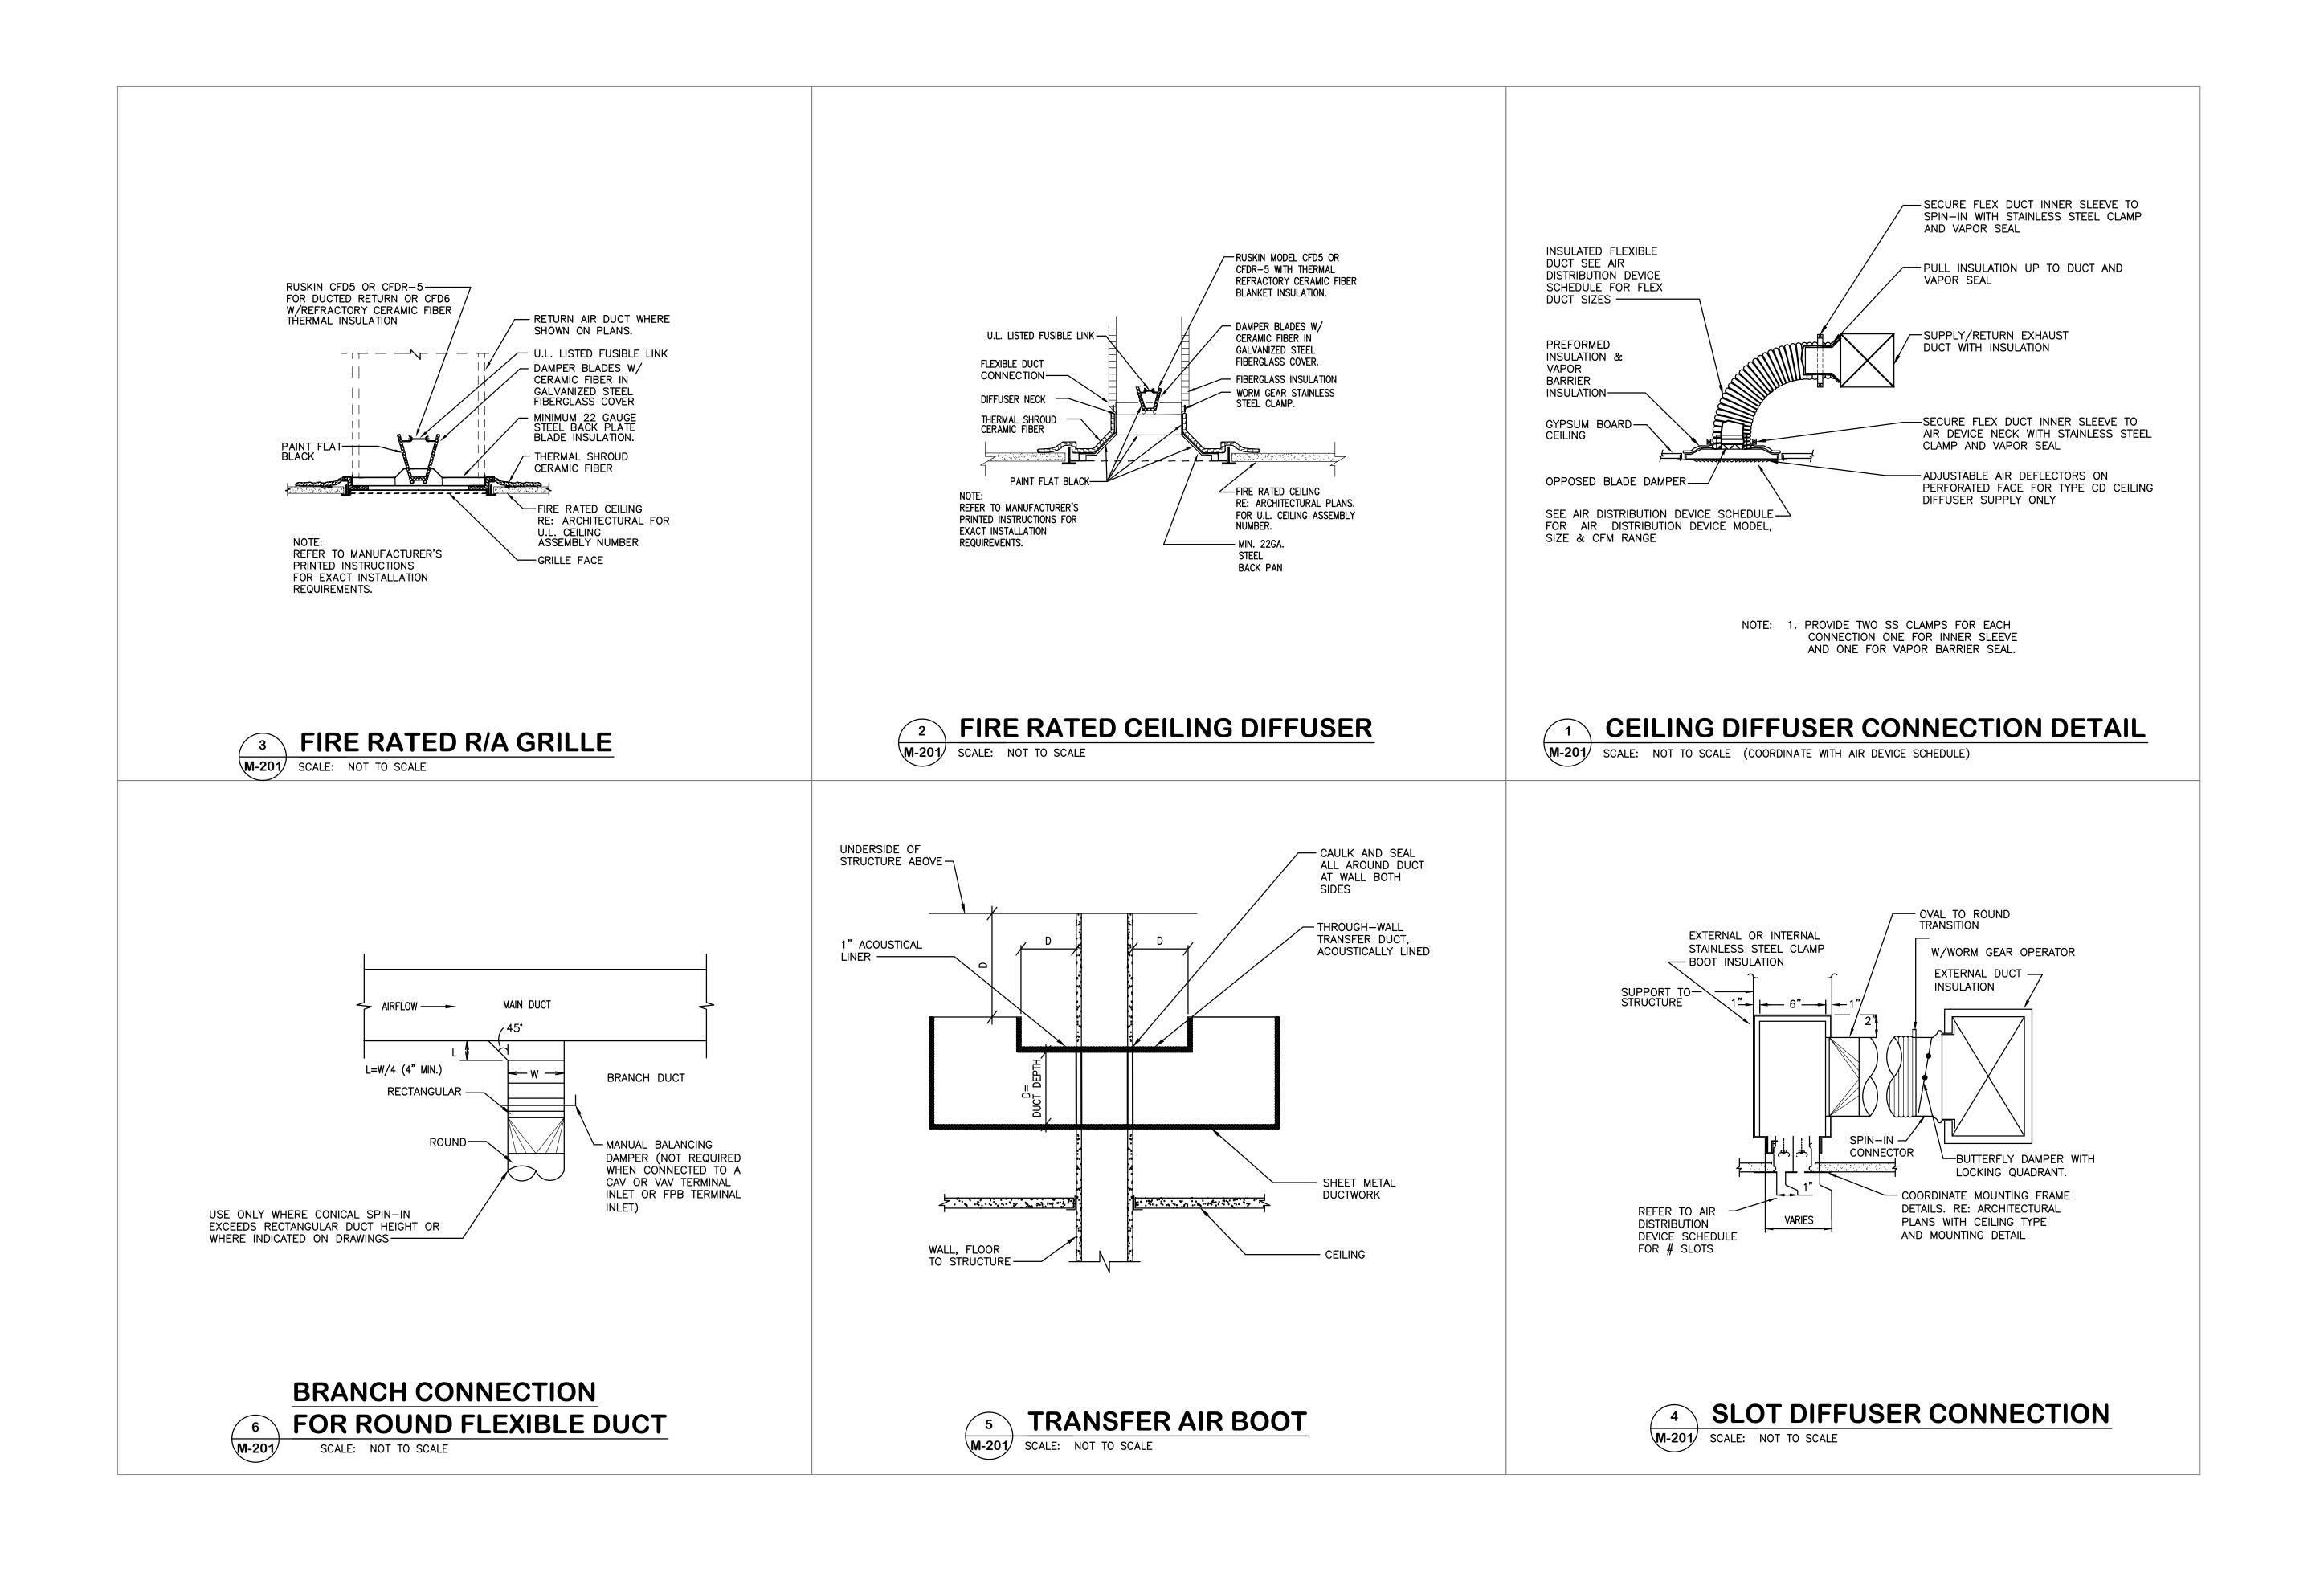
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NONE JOB NO:

SCALE:

2013.020-02



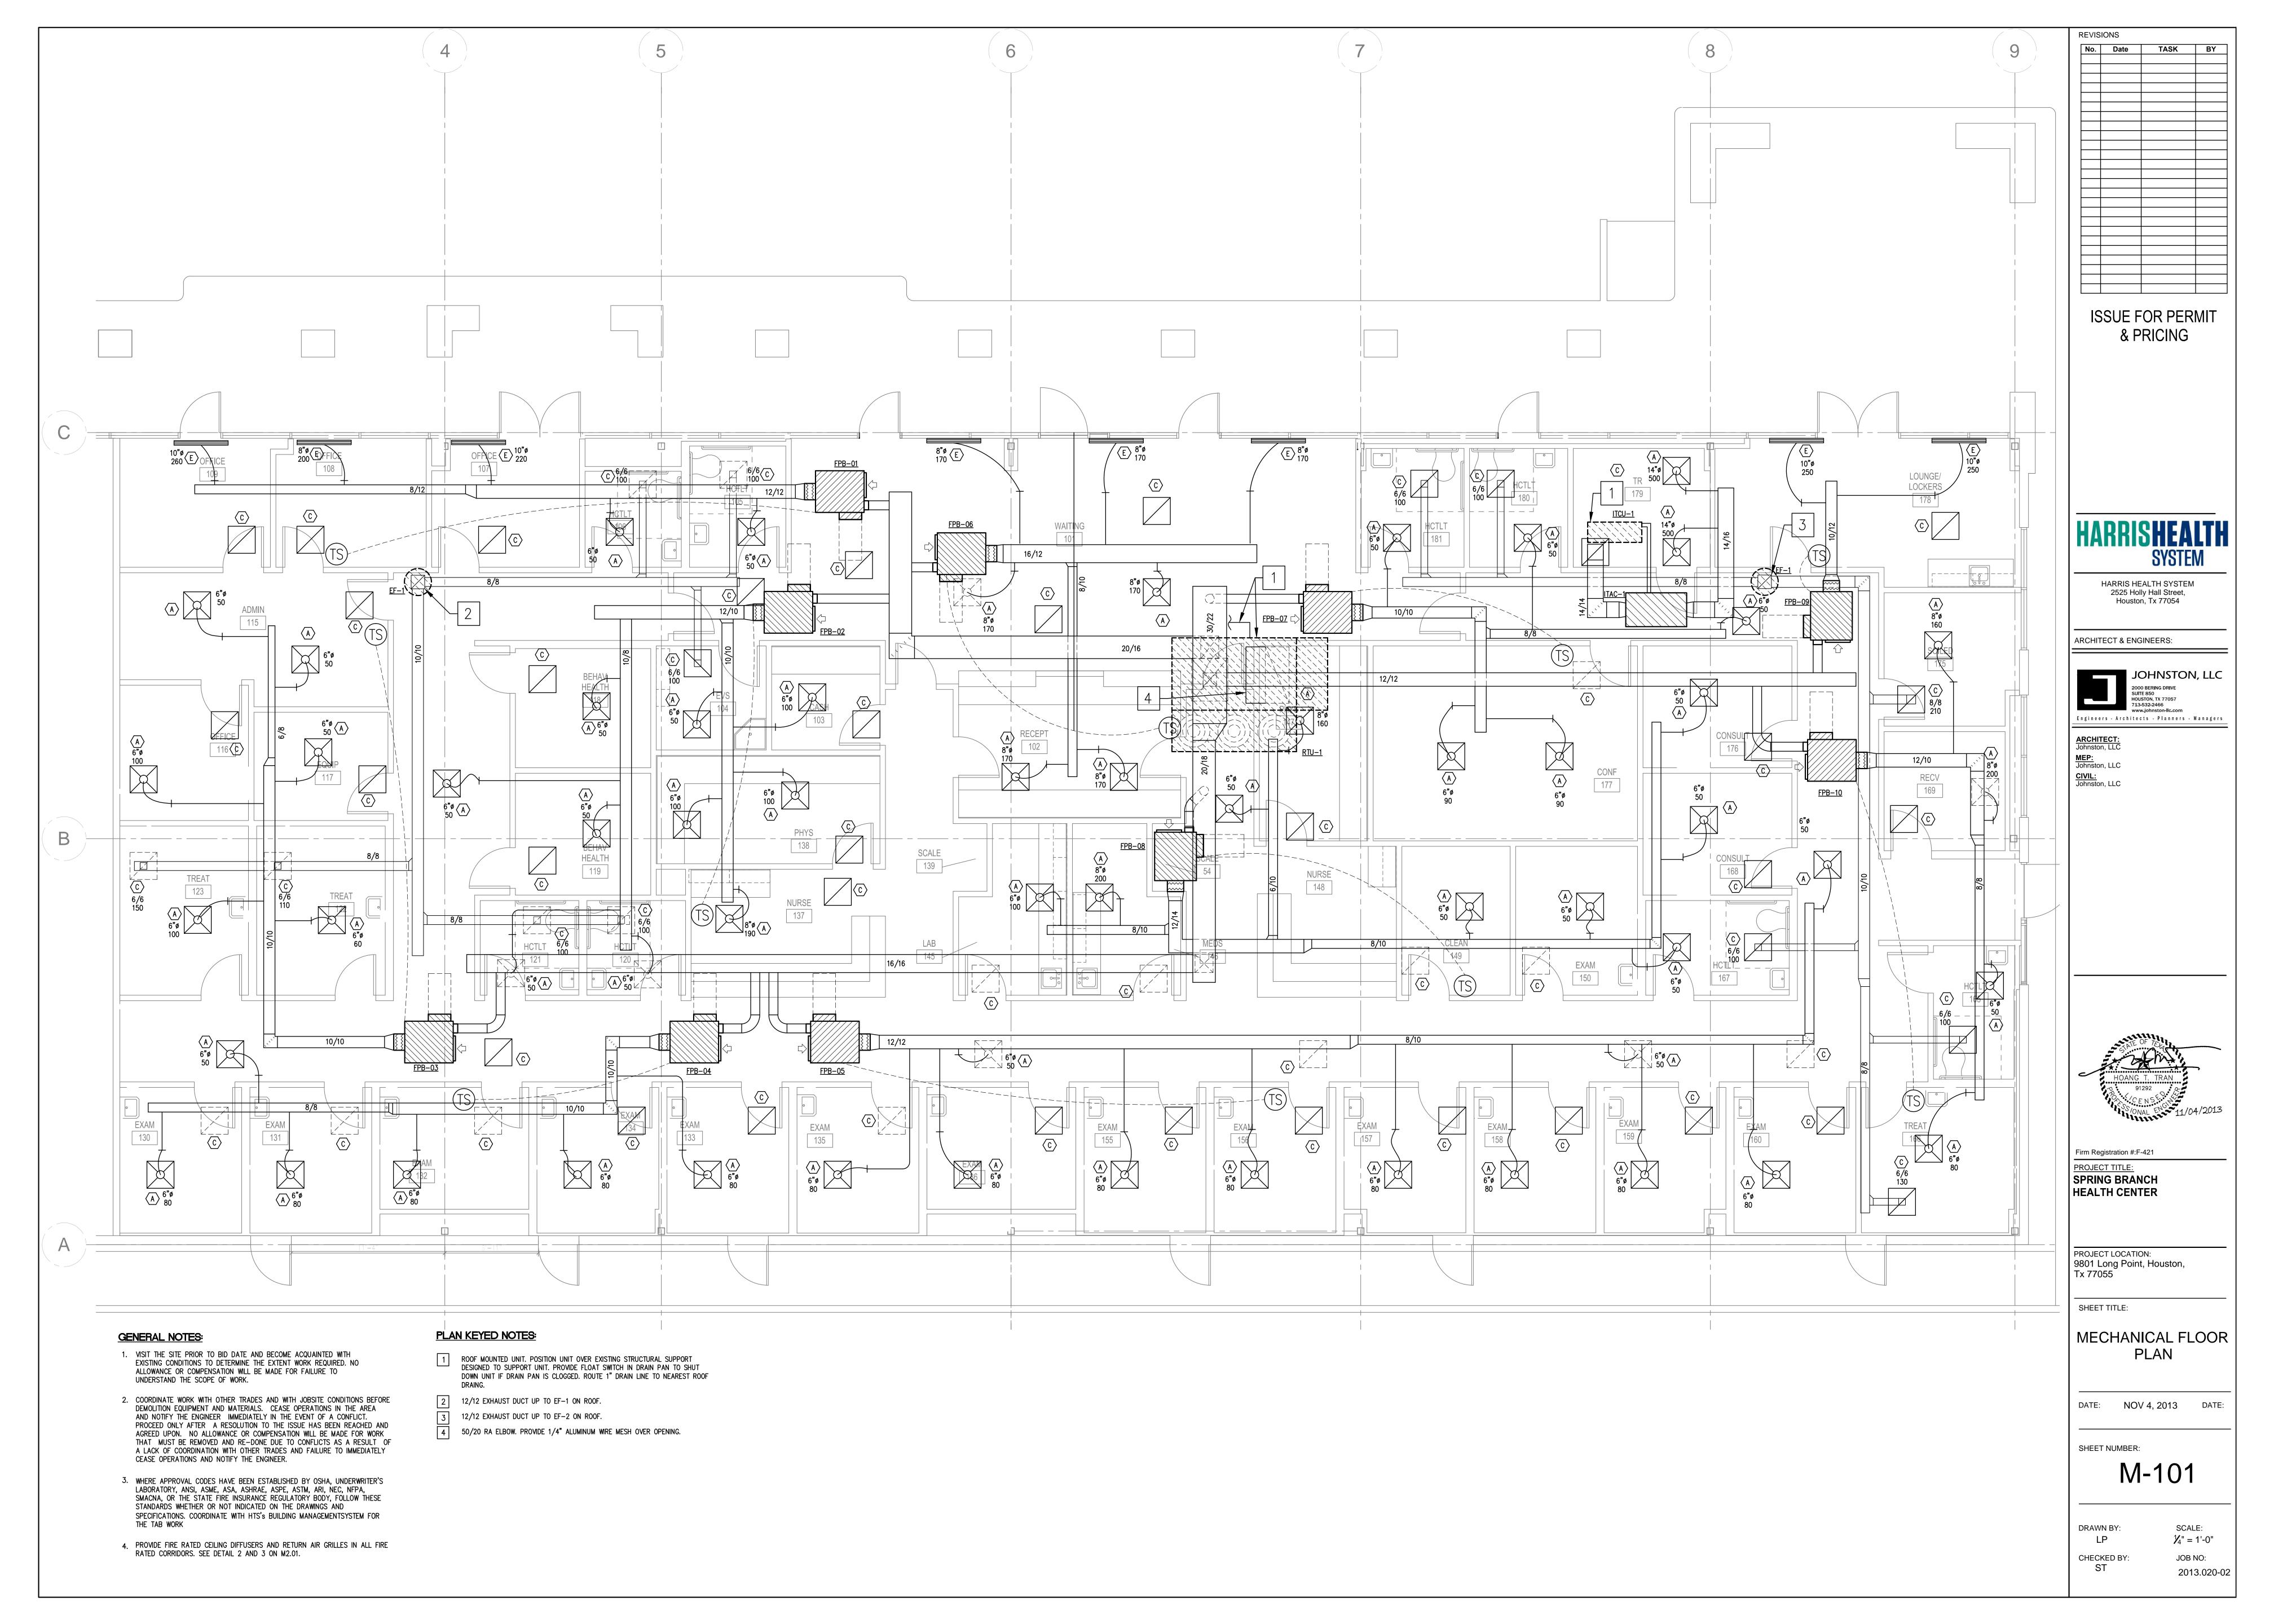

REVISIONS No. Date TASK BY

> **ISSUE FOR PERMIT** & PRICING

HARRIS HEALTH SYSTEM 2525 Holly Hall Street, Houston, Tx 77054

ARCHITECT & ENGINEERS:




2000 BERING DRIVE SUITE 850 HOUSTON, TX 77057 713-532-2466

Engineers Architects Planners Managers

MEP: Johnston, LLC

<u>CIVIL:</u> Johnston, LLC

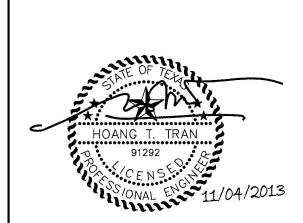

Firm Registration #:F-421 SPRING BRANCH **HEALTH CENTER**

PROJECT LOCATION:
9801 Long Point, Houston,
Tx 77055

SHEET TITLE:

MECHANICAL

DATE: NOV 4, 2013 DATE:


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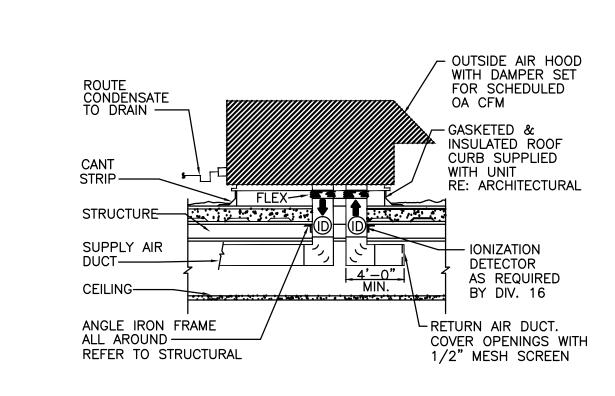
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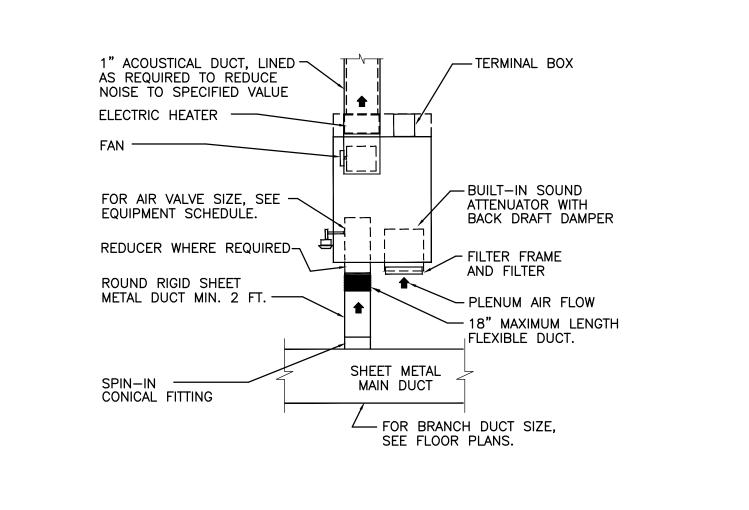
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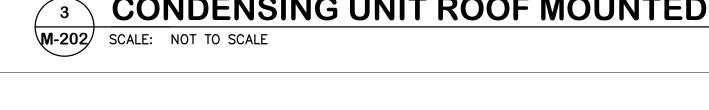
CHECKED BY:

JOB NO: 2013.020-02









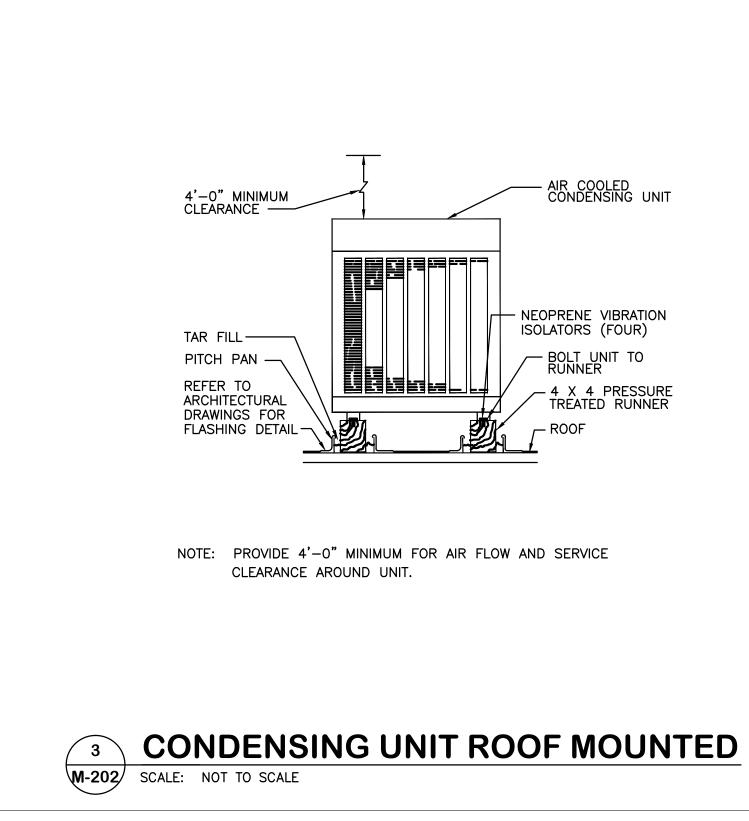







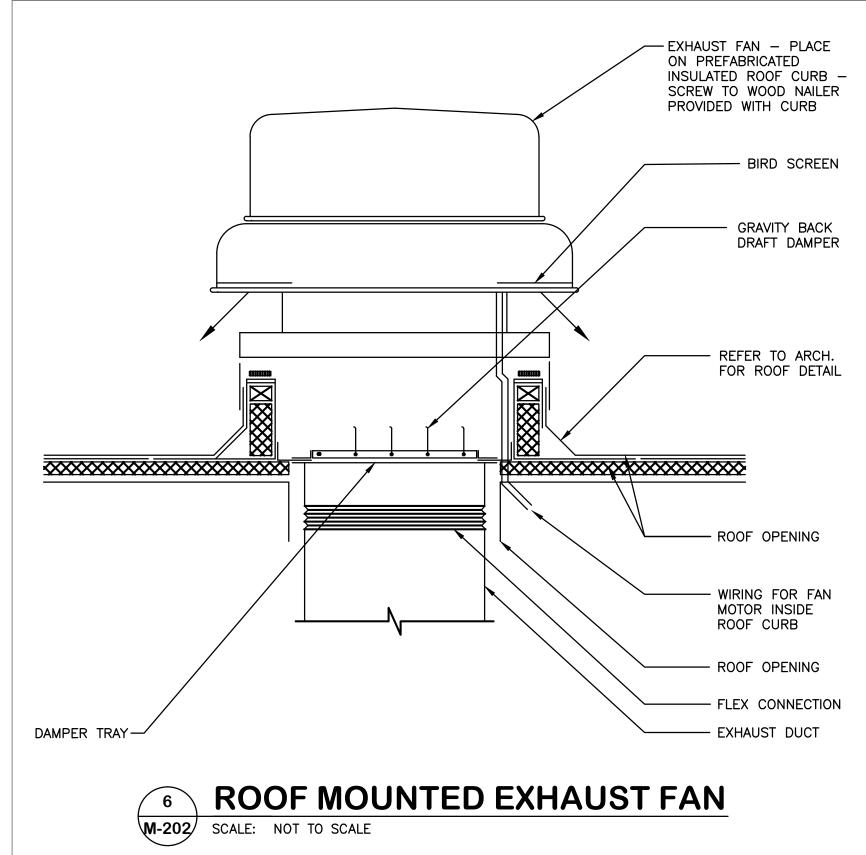

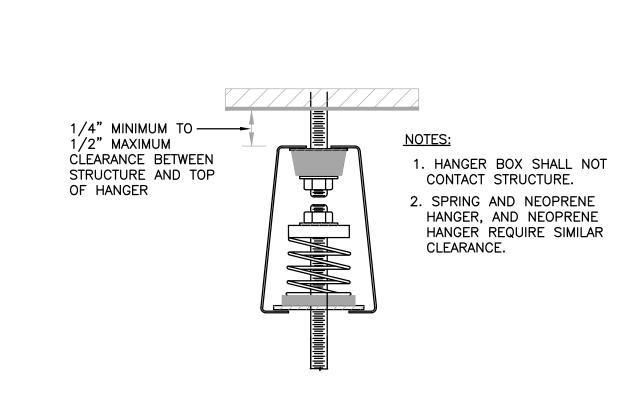



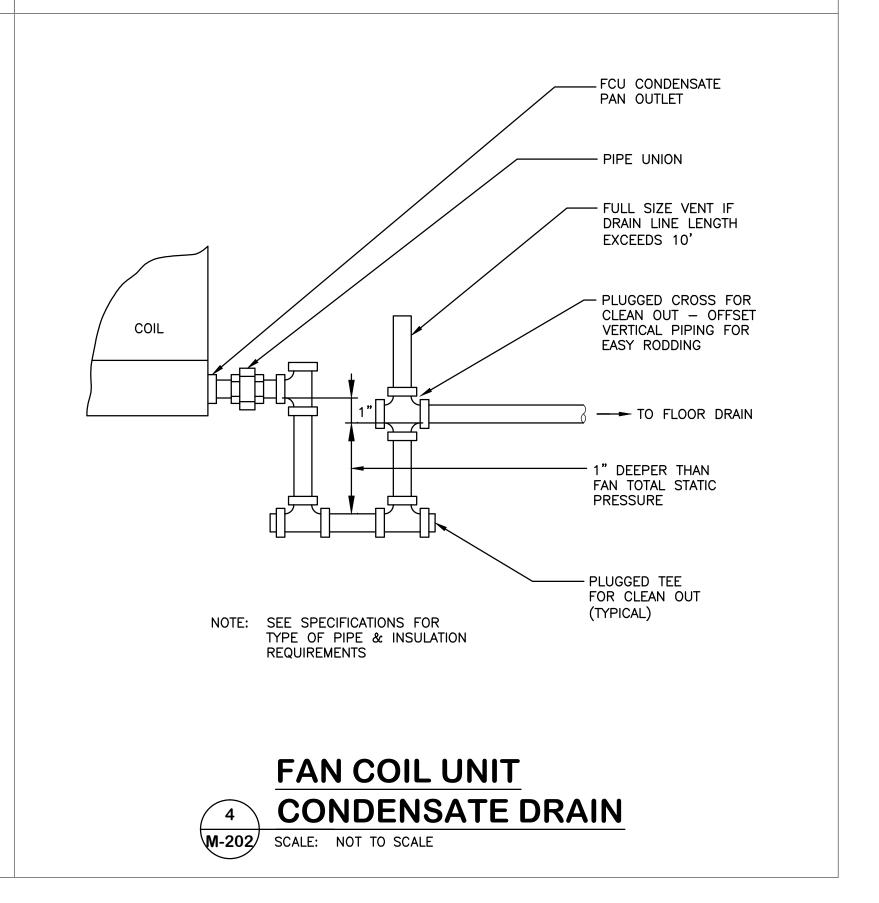

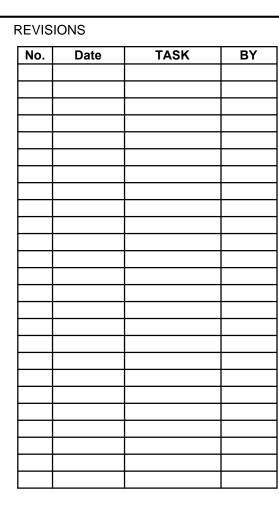



HARRIS HEALTH SYSTEM 2525 Holly Hall Street, Houston, Tx 77054

ARCHITECT & ENGINEERS:



MEP: Johnston, LLC <u>CIVIL:</u> Johnston, LLC

Firm Registration #:F-421 SPRING BRANCH HEALTH CENTER

PROJECT LOCATION:
9801 Long Point, Houston,
Tx 77055

SHEET TITLE:

MECHANICAL

DATE: NOV 4, 2013 DATE:


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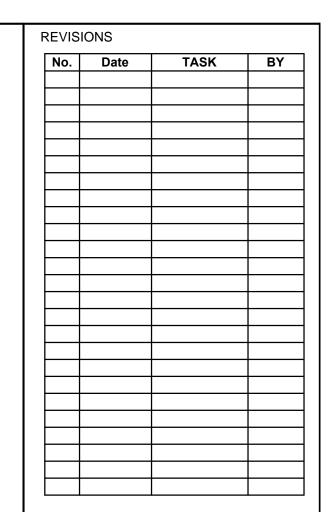
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CHECKED BY:

NONE JOB NO: 2013.020-02

SCALE:





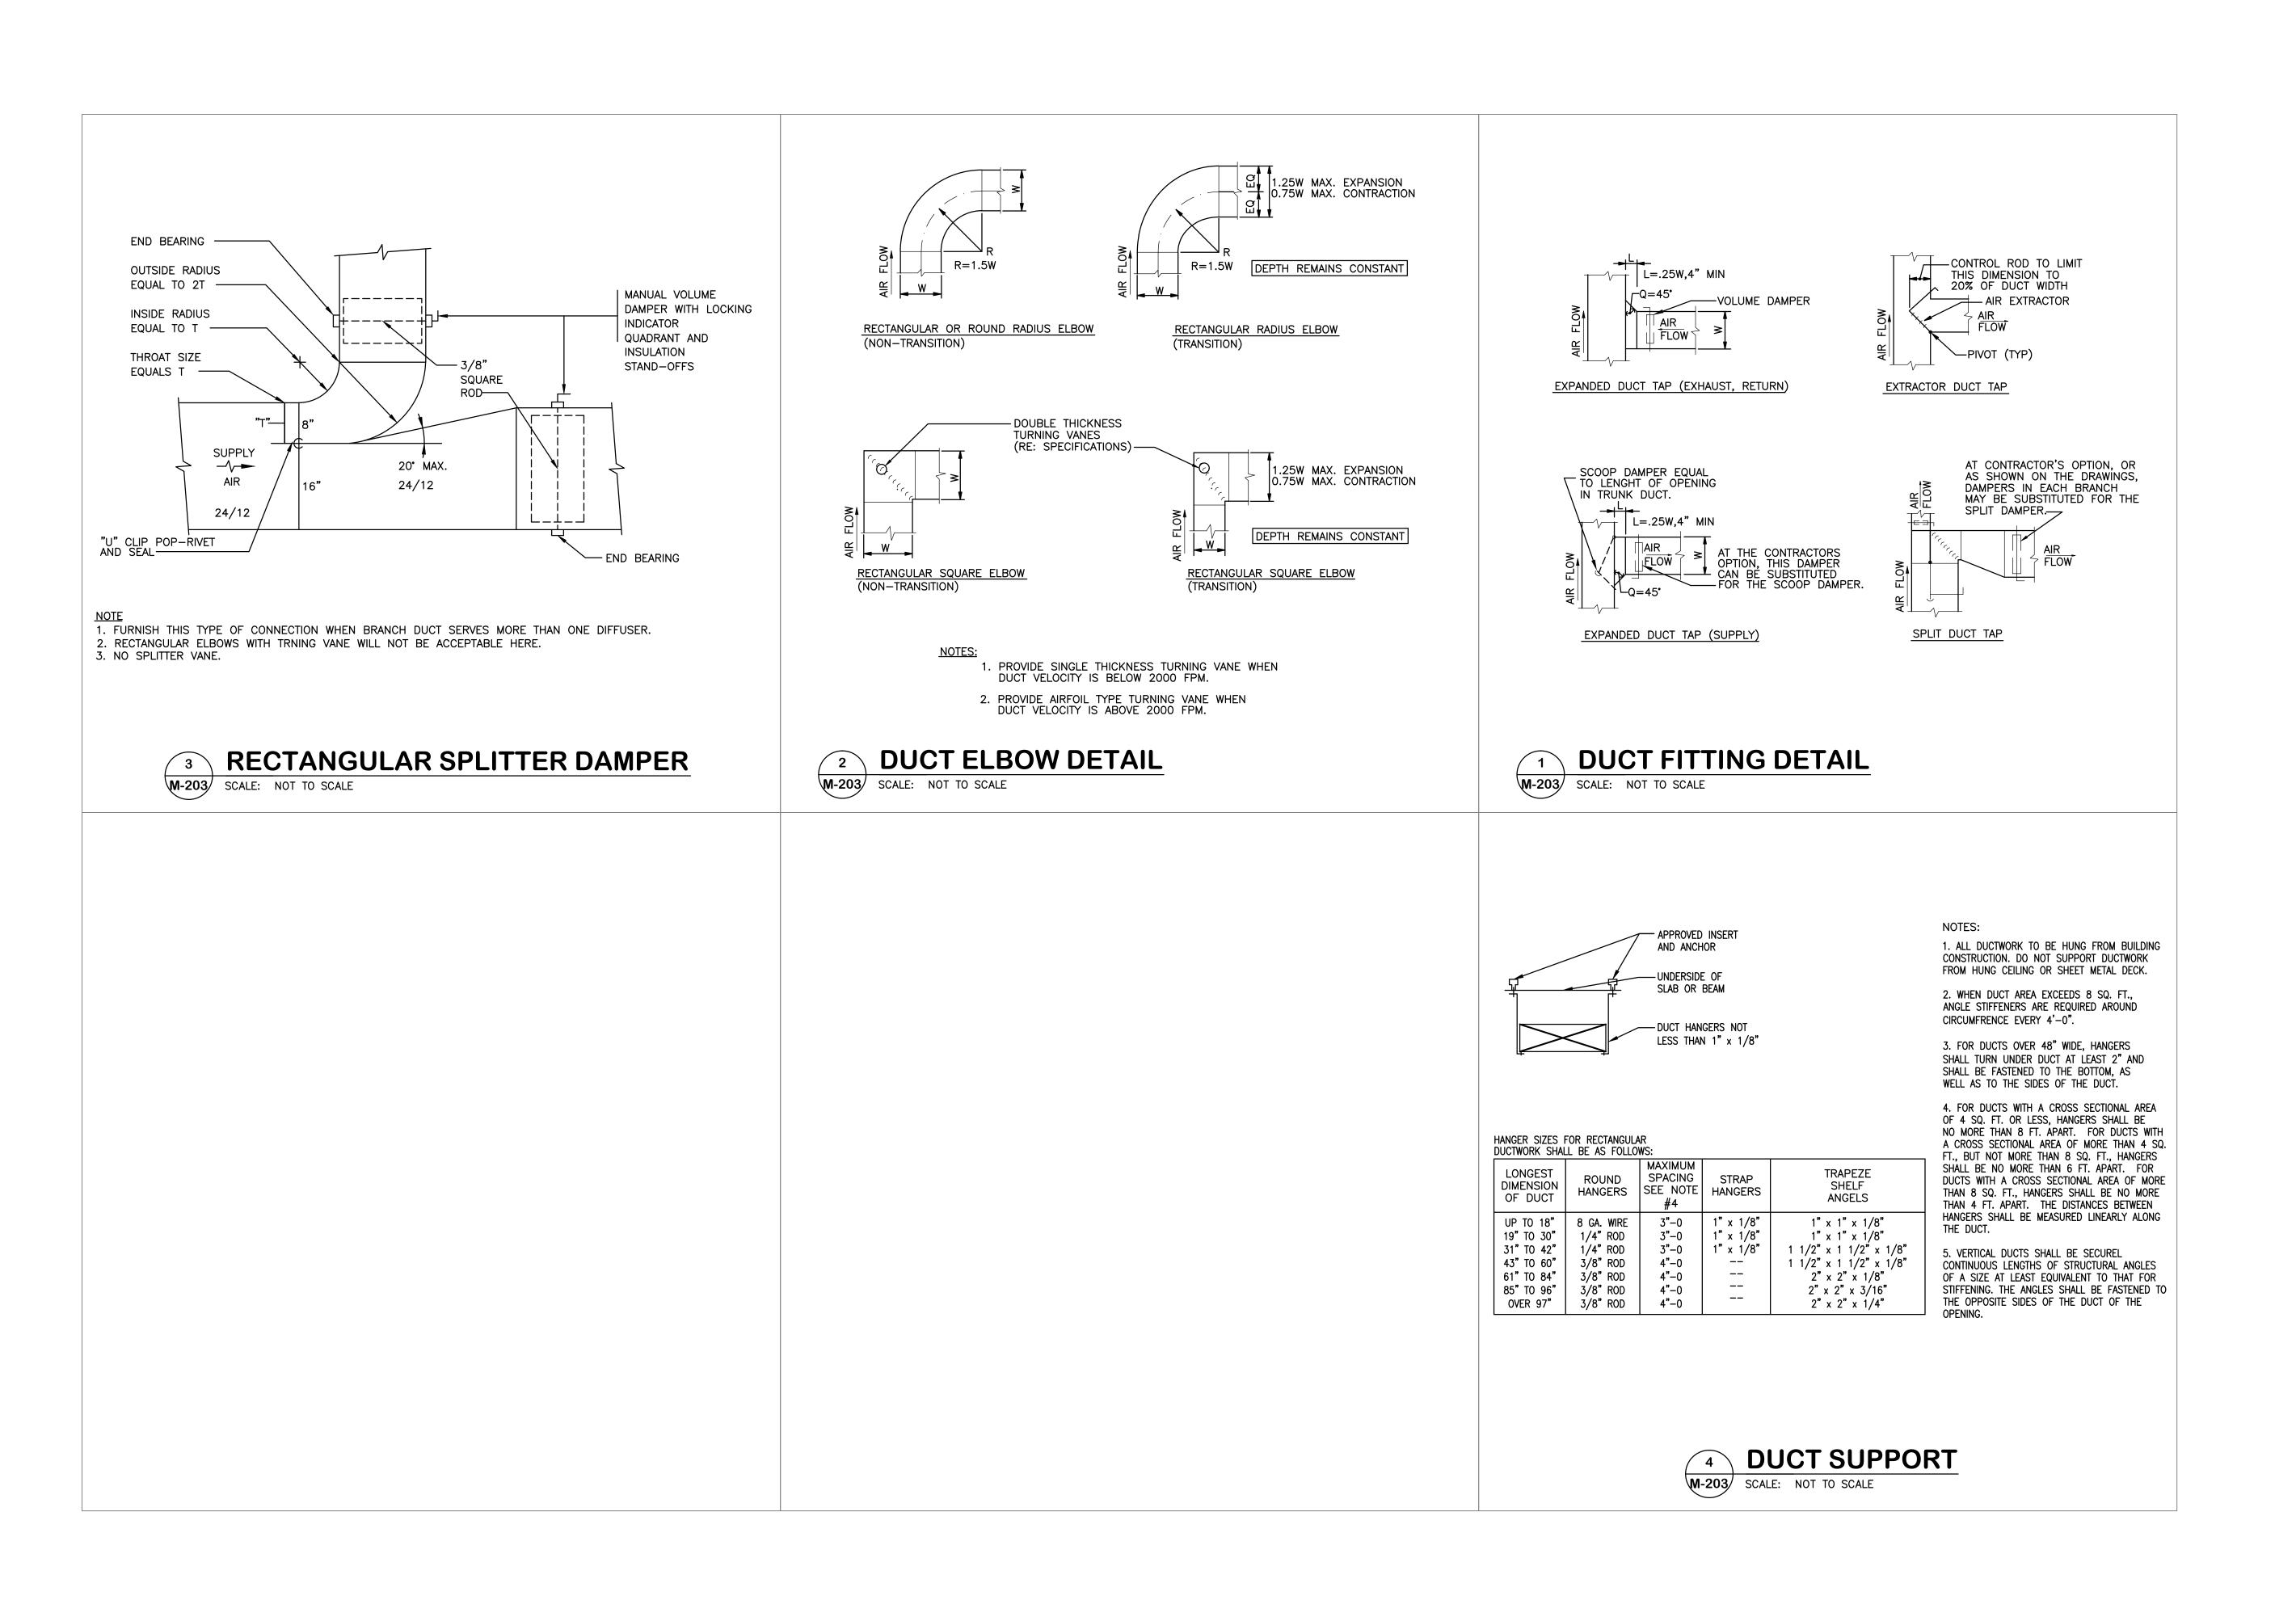

HARRIS HEALTH SYSTEM 2525 Holly Hall Street, Houston, Tx 77054

ARCHITECT & ENGINEERS:



2000 BERING DRIVE SUITE 850 HOUSTON, TX 77057 713-532-2466 Engineers Architects Planners Managers

MEP: Johnston, LLC CIVIL: Johnston, LLC

Firm Registration #:F-421 PROJECT TITLE: SPRING BRANCH HEALTH CENTER

PROJECT LOCATION: 9801 Long Point, Houston, Tx 77055

SHEET TITLE:

MECHANICAL DETAILS

DATE: NOV 4, 2013 DATE:

SHEET NUMBER:

M-203

CHECKED BY:

JOB NO: 2013.020-02

SCALE:

	AIR DEVICE SCHEDULE						
MARK	MANUF. & MODEL	TYPE	REMARKS				
A	TITUS - TMS-AA	24"x24" S/A DIFFUSER	LOUVERED FACE, ALUMINUM CONSTRUCTION. REFER PLANS FOR NECK SIZE.				
B	TITUS - TMS-AA	12"x12" S/A DIFFUSER	LOUVERED FACE, ALUMINUM CONSTRUCTION. REFER PLANS FOR NECK SIZE.				
(c)	TITUS - TDCA-AA	24"x24" R/A DIFFUSER	LOUVERED FACE, ALUMINUM CONSTRUCTION, ADJUSTABLE DISCHARGE REFER PLANS FOR NECK SIZE.				
D	TITUS - TDCA-AA	12"x12" R/A DIFFUSER	LOUVERED FACE, ALUMINUM CONSTRUCTION, ADJUSTABLE DISCHARGE REFER PLANS FOR NECK SIZE.				
E	TITUS - TBDI-80	PLENUM SLOT DIFFUSER	STEEL CONSTRUCTION, 4 FT. LENGTH, 2 SLOTS, 1" SLOT, PROVIDE WITH 11" HEIGHT PLENUM				
NOTES:	<u>.</u>						
	1. PROVIDE FRAME TO MATCH CEILING TYPE. (RE: ARCHITECTURAL REFLECTED CEILING PLANS.) 2. RE: ARCHITECTURAL DRAWINGS FOR FINISH. 3. PROVIDE REMOTE SPIN—IN DAMPER OPERATOR FOR DIFFUSER LOCATED IN GYP BOARD CEILING.						


ROOF TOP AIR C		IG UNIT SCH	I EDULE	
MARK	RTU-1			
CFM	6,045			
OUTSIDE AIR CFM	1,900			
ES.P. (IN W.G.)	2.8			
HP	4.46			
RPM	1,342			
E.E.R.	_			
SENSIBLE BTUH	202,900			
TOTAL BTUH	305,900			
EAT. (DB/WB)	84.9/69.8			
AMB. TEMP (F*)	105			
VOLTS/PHASE	208/3/60			
MANUFACTURER	AAON			
MODEL NO.	RN-030-8			
REMARKS 1. PROVIDE UNIT WITH 14" TALL PREMANUFACTURED ROOF CURB. 2. PROVIDE UNIT WITH OUTDOOR AIR HOOD AND MOTORIZED DAMPER. 3. PROVIDE FLOAT SWITCH IN PRIMARY DRAIN PAN TO DE—ENERGIZE THE UNIT WHEN PRIMARY DRAIN LINE BECOMES RESTRICTED. 4. PROVIDE UNIT WITH WATTMASTER CONTROLLER FOR VAV. 5. PROVIDE UNIT WITH SINGLE POINT CONNECTION. 6. PROVIDE UNIT WITH 2' FOAM FILLED PANELS AND THERMAL BREAK CONSTRUCTION. 7. PROVIDE UNIT WITH STAINLESS STEEL DRAIN PANS AND UVC LIGHTS. 8. PROVIDE DIGITAL COMPRESSOR ON LEAD COMPRESSORS. 9. PROVIDE UNIT WITH VFD ON SUPPLY FAN AND ECM MOTOR OR VFD CONDENSER FAN MOTOR FOR HEAD PRESSURE MODUALTION. 10. CONTACT MARK BRADICICH AT TEXAS AIRSYSTEMS FOR PRICING SUPPORT.				

			/		TOTAL	TOTAL		
ROOM NAME	AREA (SQ. FT.)	NO. OF PEOPLE	CFM/PEOPLE	CFM/SQ. FT.	CFM/PEOPLE	CFM/SQ. FT.	TOTAL CFM	NOTES
CLINIC AREA	8,490	100	5	0.06	500	510	1,010	WITH RTU-1

MARK	MANUF.	MODEL	SIZE	INLET SIZE	CFM	MIN. PRIMARY AIR CFM	EXT. SP IN	FAN MOTOR	ELECTRIC HEATING COIL STEP	MAXIMUN INPUT KW	VOLT/PHASE	REMARKS
FPB-1	TITUS	DTFS	С	12 " ø	780	235	0.4	1/2	2	9	208/3/60	_
FPB-2	TITUS	DTFS	С	12 " ø	790	240	0.4	1/2	2	9	208/3/60	_
FPB-3	TITUS	DTFS	В	08"ø	410	125	0.4	1/2	2	4	208/3/60	ı
FPB-4	TITUS	DTFS	В	08ø	450	135	0.4	1/2	2	4	208/3/60	ı
FPB-5	TITUS	DTFS	С	12 " ø	790	240	0.4	1/2	2	9	208/3/60	ı
FPB-6	TITUS	DTFS	D	14 " ø	1190	360	0.4	1/2	2	10.5	208/3/60	ı
FPB-7	TITUS	DTFS	В	08 " ø	330	100	0.4	1/2	2	3.5	208/3/60	ı
FPB-8	TITUS	DTFS	С	12 " ø	760	230	0.4	1/2	2	9	208/3/60	-
FPB-9	TITUS	DTFS	В	08"ø	500	150	0.4	1/2	2	4	208/3/60	_
FPB-10	TITUS	DTFS	В	08"ø	490	150	0.4	1/2	2	5	208/3/60	-
NOTES:												

FAN S	CHEDULE	
IARK	EF-1	EF-2
ERVICE	TOILET EXHAUST	TOILET. EXHAUST
INIT TYPE	CENTRIFUGAL INLINE	CENTRIFUGAL INLINE
RIVE TYPE	BELT	BELT
OTAL AIRFLOW (CFM)	760	740
XTERNAL STATIC PRESSURE (IN. W.G.)	0.75	0.75
PM	1489	1528
IOTOR SIZE (HP)	0.19	0.21
OLTS / PHASE	115/1/60	115/1/60
IANUFACTURER	GREENHECK	GREENHECK
IODEL	GB-091-4	GB-091-4
/EIGHT (LBS)	58	58

DESIGN CRITERIA AND APPLICABLE CODES
OUTDOOR CONDITIONS:
SUMMER: DRYBULB: 96.0°F, WET BULB: 80.5°F WINTER: DRYBULB: 28°F
INDOOR CONDITIONS:
SUMMER: DRYBULB: 75°F, RELATIVE HUMIDITY: 50% WINTER: DRYBULB: 72°F
APPLICABLE CODES:
-2006 INTERNATINAL BUILDING CODE -2006 UNIFORM MECHANICAL CODE

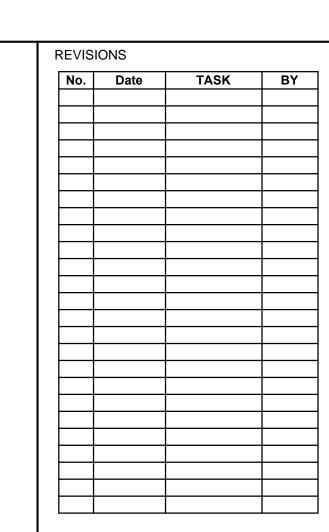



HARRIS HEALTH SYSTEM 2525 Holly Hall Street, Houston, Tx 77054

ARCHITECT & ENGINEERS:



MEP: Johnston, LLC



Firm Registration #:F-421 PROJECT TITLE: SPRING BRANCH HEALTH CENTER

PROJECT LOCATION:
9801 Long Point, Houston,
Tx 77055

SHEET TITLE:

SCHEDULES

DATE: NOV 4, 2013 DATE:

SHEET NUMBER:

M-301

DRAWN BY: CHECKED BY: ST

JOB NO: 2013.020-02

SCALE: NONE

		ELE	CTRICAL SYMBOL LEGEND		
SYMBOL	DESCRIPTION	SYMBOL	DESCRIPTION	SYMBOL	DESCRIPTION
	LIGHTING OR POWER CIRCUIT. ARROW INDICATES HOME RUN, LONGER TICK INDICATES NEUTRAL WIRE, SHORTER STRAIGHT TICK	1	120 OR 277 VOLT, WHITE DECORA 20 AMP SWITCH, MOUNT AT 44" AFF TO CENTER. "P" INDICATES PILOT LIGHT, "WP" INDICATES		TELEPHONE AND/OR NETWORK BACKBOARD, 4' x 8' x 3/4" THICK FIRE RATED PLYWOOD PAINTED GRAY
	INDICATES PHASE WIRE, SLANTED SHORTER TICK INDICATES SWITCH LEG, DOT INDICATES GROUNDING CONDUCTOR, DASHED	\$	WEATHERPROOF, "K" INDICATES KEY OPERATED, "3" INDICATES 3-WAY, "4" INDICATES 4-WAY, "M" INDICATES MANUAL STARTER	U.N.O.	ABBREVIATION FOR "UNLESS NOTED OTHERWISE".
1	WIRING INDICATES WIRING IN OR BELOW SLAB OR GRADE. PROVIDE A SEPARATE NEUTRAL FOR EACH PHASE CONDUCTOR FOR ENTIRE LENGTH OF CIRCUIT FROM PANEL TO OUTLET; COUNT	\$ ^D	DIMMER SWITCH, MOUNT AT 44" AFF TO CENTER. "3D" INDICATES 3-WAY DIMMER. MINIMUM DIMMER RATING SHALL BE 1000W.	F	FOOT, INDICATES WALL MOUNTED DEVICE. SAME DEVICES WITHOUT FOOT SYMBOL REPRESENT CEILING MOUNTED.
	EACH NEUTRAL AS CURRENT-CARRYING AND GROUP A MAXIMUM OF NINE THHN/THWN CONDUCTORS IN A SINGLE RACEWAY;	<u>oş</u>	WALL OCCUPANCY SENSOR SWITCH. DEFAULT TYPE TO BE WATTSTOPPER PW-101 PASSIVE INFRARED. 44" AFF TO CENTER.		
	GROUNDING CONDUCTOR IS NOT COUNTED, PER NOTE 11 NEC TABLE 310.16. ALL FLEXIBLE CONDUIT SERVING PATIENT CARE	A	2' x 4' RECESSED LED LIGHT FIXTURE, LETTER INDICATES LIGHT FIXTURE TYPE		
	ROOMS SUCH AS EXAM, PROCEDURE AND TREATMENT SHALL USE HCF GRADE CONDUIT. HCF CABLE SHALL NOT EXCEED 10'-0". LOCATE JUNCTION BOX DIRECTLY ABOVE CEILING FOR CONDUIT DROP TO NEW OUTLET.	AEM	LIGHTING FIXTURE WITH EMERGENCY BATTERY PACK. FIXTURE SHALL BE WIRED SO THAT BATTERY PACK WILL ONLY OPERATE DURING POWER FAILURE. CORRIDOR FIXTURES SHALL NOT BE SWITCHED. FIXTURES LOCATED IN DEDICATED ROOMS SHALL BE SWITCHED AND NOT AFFECT EMERGENCY BATTERY OPERATION.		
Ф	WHITE DUPLEX DECORA CONVENIENCE RECEPTACLE, 20A, 120 VOLT, 1-POLE, MOUNTED AT 18" AFF TO CENTER, UNLESS				
"	OTHERWISE NOTED. FOR ALL PATIENT CARE ROOMS, EXAM, PROCEDURE AND TREATMENT, RECEPTACLE SHALL BE HOSPITAL GRADE. GROUNDING TERMINALS OF ALL	ОВ	6" LED DOWNLIGHT, LETTER INDICATES LIGHT FIXTURE TYPE		
	RECEPTACLES SHALL BE GROUNDED INSULATED COPPER CONDUCTOR AS WELL AS ALL NON-CURRENT CARRYING	1 ⊠l×	EXIT LIGHT FIXTURE WITH EMERGENCY BATTERY PACK, LETTER INDICATES TYPE, ARROW OR ARROWS INDICATE EXIT PATHWAYS		
	CONDUCTIVE SURFACES OF FIXED ELECTRICAL EQUIPMENT. PROVIDE 1/4 " HIGH ENGRAVED NAMEPLATE WITH PANEL AND	•	POINT OF BRANCH CIRCUIT TAP FOR SWITCHED FIXTURE GROUP		
	CIRCUIT NUMBER. EMBOSSED PLASTIC TAPE LABELS "ARE NOT" ACCEPTABLE.	(cos)	NEW CEILING MOUNTED WATTSTOPPER #W-1000A OCCUPANCY SENSOR WHITE. ALL SENSORS SHALL BE PROPERLY PLACED		
#	SAME AS ABOVE EXCEPT MOUNTED 44"AFF.		AND COMMISSIONED TO BE FULLY FUNCTIONING CONTROL SYSTEM. ALL SENSORS SHALL BE INSTALLED AND LOCATED PER MANUFACTURER INSTRUCTIONS. SET TIME FOR MAXIMUM		
 	QUADRAPLEX CONVENIENCE RECEPTACLE, SAME AS ABOVE EXCEPT WITH 2- 20 A, 120 VOLT, 1-POLE, MOUNTED AT 18" AFF		OPERATION. WIRE AND CONNECT TO POWER PACK.		
	TO CENTER, UNLESS OTHERWISE NOTED.	PP	NEW POWER PACK FOR CEILING OCCUPANCY SENSOR MOUNTED ABOVE ACCESSIBLE CEILING ON JUNCTION BOX. WATTSTOPPER		NOTES:
GF	INDICATES GROUND FAULT CIRCUIT INTERRUPTER		#BZ-50. WIRE AND CONNECT TO CEILING OCCUPANCY SENSOR.		NOT EVERY SYMBOL IN THIS LEGEND MAY APPEAR ON THE DRAWINGS.
Ф	SPECIAL PURPOSE POWER RECEPTACLE, NEMA RATING AS INDICATED	①	JUNCTION BOX		FURNISH AND INSTALL 1" EMPTY CONDUIT WITH PULL CORD, ROUTED TO ABOVE CEILING AND BACK
0	FLOOR DEVICE, REFER TO PLANS FOR TYPE.	<i>∕∨</i>	MOTOR BY OTHERS - ELECTRICAL CONTRACTOR TO CONNECT		TO I.T. ROOM, FOR ALL NEW TEL/ DATA OUTLETS, UNLESS OTHERWISE NOTED ON PLANS. SEE PLANS
	PANELBOARD	라	DISCONNECT SWITCH. FRAME SIZE/FUSE SIZE/POLES AS INDICATED. "NF" INDICATES NON-FUSIBLE, 72" AFF TO TOP.		FOR LOCATION OF I.T. ROOM. REFER TO LOW VOLTAGE COMMUNICATION DRAWINGS BY OTHERS FOR DEVICE LOCATIONS AND NOTES.
Т	TRANSFORMER	\boxtimes_1	COMBINATION DISCONNECT SWITCH/MOTOR CONTROLLER, SIZE AS NOTED ON PLANS	1	OTHERS FOR DEVICE LOCATIONS AND NOTES.

GENERAL ELECTRICAL NOTES

REFER TO ARCHITECTURAL DRAWINGS FOR EXACT MOUNTING HEIGHTS OF THE FOLLOWING ELECTRICAL DEVICES. IF NOT SHOWN ON ARCHITECTURAL DRAWINGS OR INSTRUCTED BY THE ARCHITECT, DEVICES SHALL HAVE THE FOLLOWING MOUNTING HEIGHTS TO CENTER OF BOX:


WALL SWITCHES 44" AFF WALL CONVENIENCE RECEPTACLES 18" AFF WALL GFCI RECEPTACLES NEAR SINKS 44" AFF WALL SECURITY SYSTEM CARD READER 44" AFF 44" AFF MANUAL FIRE ALARM STATIONS


- WHERE AFF = ABOVE FINISHED FLOOR
- UNLESS SPECIFICALLY INDICATED ON THE DRAWINGS, OUTLETS LOCATED AT COUNTERS AND CABINETS SHALL BE
- MOUNTED AS SHOWN ON ARCHITECTURAL DETAILS AND ELEVATIONS.
- 4. BRANCH CIRCUITING IS A DIAGRAMMATIC REPRESENTATION OF CIRCUIT LOADING AND CONTROL ONLY. IT IS NOT A METHOD OF INSTALLATION. REFER TO SPECIFICATIONS FOR METHODS OF INSTALLATION AND MATERIALS.

3. REFER TO MECHANICAL DRAWINGS FOR EXACT LOCATION OF ALL HVAC AND PLUMBING EQUIPMENT.

- . WITHIN CIRCUITS PROVIDE QUANTITY OF CONDUCTORS AS NEEDED TO ACCOMMODATE CIRCUITING AND SWITCHING REQUIREMENTS SHOWN.
- WHEN REMOVING EXISTING ELECTRICAL WORK FOR WHICH THERE ARE OTHER ITEMS ON THE SAME CIRCUIT, THE CONTRACTOR SHALL TAKE WHATEVER STEPS ARE NECESSARY TO ASSURE THAT CIRCUIT CONTINUITY IS KEPT.
- ALL ITEMS NOTED TO BE REMOVED ARE TO REMAIN THE PROPERTY OF THE OWNER; HOWEVER, CONTRACTOR SHALL REMOVE ALL MATERIAL FROM JOBSITE AS REQUIRED BY OWNER.
- CONTRACTOR SHALL FIELD VERIFY CONDITIONS OF ALL EXISTING ELECTRICAL FIXTURES, PANELS, WIRING, ETC. BEFORE MAKING ANY MODIFICATIONS OR ADDITIONS TO THE ELECTRICAL SYSTEM.
- 9. WHEN EXISTING ELECTRICAL WORK IS REMOVED, ALL EXPOSED CONDUIT, WIRING, CONTROL AND JUNCTION BOXES ALONG WALLS, FLOOR AND CEILING SHALL BE REMOVED.

	LIGHT FIXTURE SCHEDULE			
TYPE	MANUFACTURER/DESCRIPTION	VOLTAGE	LAMPS	MOUNTING
Α	2X4 LED WITH DUAL OPAL DIFFUSERS DAY-BRITE #2DLG58L840DUNV.	120/277 DUAL	LED 61W 4000K	RECESSED
AEM	2X4 LENSED LED FIXTURE WITH EMERGENCY BATTERY PACK DAY—BRITE #2DLG58L8340DUNV—EMLED16. SELF—DIAGNOSTIC/SELF—TEST.	120/277 DUAL	LED 61W 4000K	RECESSED
В	6" APERTURE LED DOWNLIGHT WITH SPECULAR CLEAR REFLECTOR LIGHTOLIER #C6L1520DL40KMCLW-VB/C6L15NU-VB-Z10V.	120/277 DUAL	LED 27W 4000K	RECESSED
С	48" UNDERCABINET FLUORESCENT FIXTURE WITH ROCKER SWITCH. DAY—BRITE #8UC132S12ORS.	120	1-T8 32W 4100K	SURFACE
D	24" UNDERCABINET FLUORESCENT FIXTURE WITH ROCKER SWITCH. DAY-BRITE #8UC117S120RS.	120	1-T8 17W 4100K	SURFACE
X	EXIT SIGN SINGLE OR DOUBLE FACE, LED, WHITE THERMOPLASTIC HOUSING, RED LETTERS AND EMERGENCY BATTERY. CHLORIDE #CXXL3RW. WITH X-TEST DIAGNOSTICS.	120/277 DUAL	LED 3.7W	UNIVERSAL

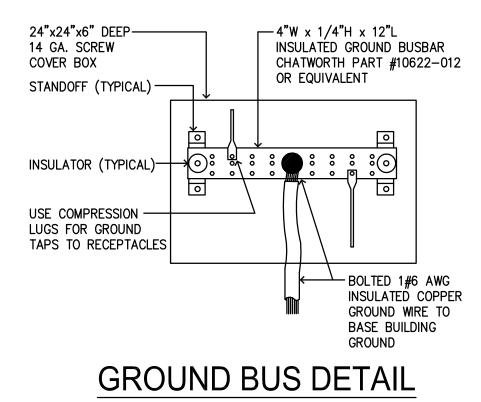

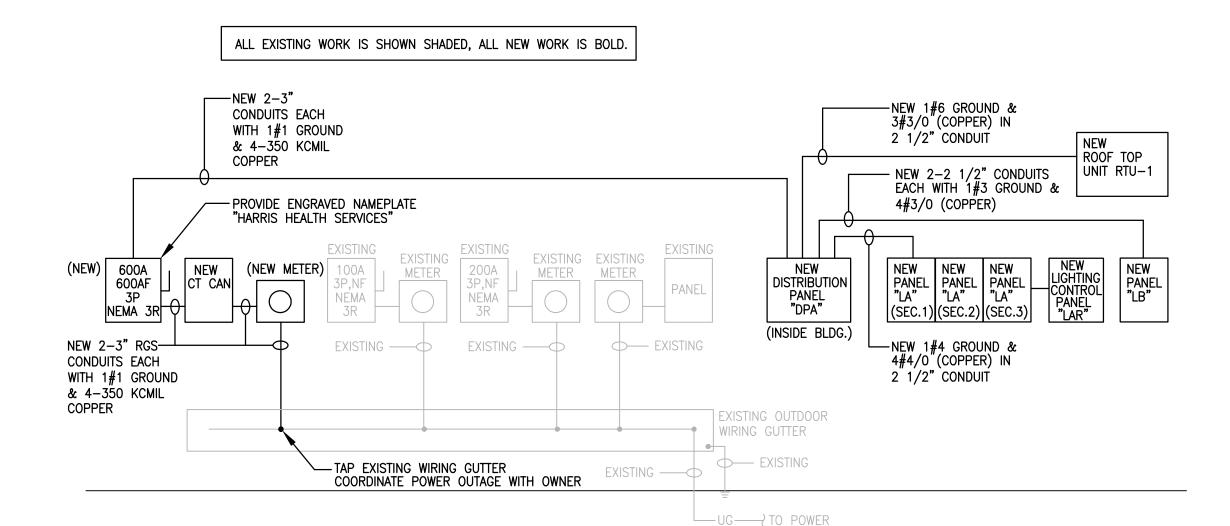

COMPANY TRANSFORMER

LIGHTING 8,299VA +25%		AMPS AMPS
RECEPTACLES 265 REC X 180VA EACH = 47,700VA 1st 10 KW AT 100% -10,000VA 10,000VA	4	
REMAINDER AT 50% 37,700VA +18,850V/ 28,850V/	_	AMPS
MECHANICAL 93,456VA (ROOF TOP UNIT RTU-1, 150 AMPS IS FOR COOLING, HEATING LOAD IS LARGER SO 259.6 AMPS WILL BE USED)	259.6	AMPS
PLUMBING 12,000VA	33.3	AMPS
MISCELLANEOUS 22,294VA	+61.9	AMPS
TOTAL	463.6	AMPS

NEW	DISTRIBUTIO	N PA	NEL	"D	PA	"					
120/208	8 3PH 4W		6	600 AI	MP M	ILO				MOUNTING: 2	SURFACE 5,000 AIC
LOAD VA	SERVES	WIRE	СВ	CKT F	HASE	СКТ	СВ	WIRE		SERVES	LOAD V
19814	PANEL "LA"	#4/0	225/3	1	Α	2	200/3	#3/0	RTU-1	(150 AMPS)	18000
19814	-	_	225/3	3	В	4	200/3	-	_	-	18000
19814	-	–	225/3	5	С	6	200/3	-	_	-	18000
35152	PANEL "LB"	#3/0	400/3	7	Α	8			SPACE		
35152	-	_	400/3	9	В	10			SPACE		
35152	-	T -	400/3	11	С	12			SPACE		
	SPACE			13	Α	14			SPACE		
	SPACE			15	В	16			SPACE		
	SPACE			17	С	18			SPACE		
	SPACE			19	Α	20			SPACE		
	SPACE			21	В	22			SPACE		
	SPACE			23	С	24			SPACE		

PROVIDE ENGRAVED NAMEPLATE WITH TYPED INDEX CARD.

NO SCALE

NEW	PANEL "LA"								(SECTION	1)
· -	8 3PH 4W ED THRU LUGS		2	225 A	MP M	ILO			MOUNTING: SU 10,0	RFACE 00 AIC
LOAD VA	SERVES	WIRE	СВ	CKT F	PHASE	СКТ	СВ	WIRE	SERVES	LOAD VA
360	2 REC	#12	20/1	1	Α	2	20/1	#12	NURSE CALL CABINET	200
1620	9 REC	#12	20/1	3	В	4	20/1	#12	ACCESS CONTROL PANEL	200
420	1 REC PRINTER	#12	20/1	5	С	6	20/1	#12	FIRE ALARM PANEL	200
720	4 REC	#12	20/1	7	Α	8	20/1	#10	EXIT SIGNS	52
420	1 REC PRINTER	#12	20/1	9	В	10	20/1	#10	EMERGENCY LIGHTS	1708
540	3 REC	#12	20/1	11	С	12	20/1	#10	LIGHTS	1464
850	1 REC REFRIG.	#12	20/1	13	Α	14	20/1	#10	LIGHTS	1524
180	1 REC	#12	20/1	15	В	16	20/1	#10	LIGHTS	1782
540	3 REC	#12	20/1	17	С	18	20/1	#10	LIGHTS	1769
180	1 REC	#12	20/1	19	Α	20	20/1	#12	LIGHTING CONTROL PANEL	200
1200	1 REC FREEZER	#12	20/1	21	В	22	20/1	#10	7 REC	1260
1080	6 REC	#12	20/1	23	С	24	20/1	#10	4 REC	720
900	5 REC	#12	20/1	25	Α	26	20/1	#12	1 REC COPIER	420
360	2 REC	#12	20/1	27	В	28	20/1	#12	2 REC	360
540	3 REC	#12	20/1	29	С	30	20/1	#12	6 REC	1080
540	1 REC PRINTER	#12	20/1	31	Α	32	20/1	#12	1 REC PROJECTOR	180
360	2 REC	#12	20/1	33	В	34	20/1	#12	4 REC	720
420	1 REC COPIER	#12	20/1	35	С	36		#10	1 REC I.T.	2496
540	3 REC	#12	20/1	37	Α		30/2	_	-	2496
2880	1 REC I.T.	#10	30/1	39	В		30/2	#10	1 REC I.T.	2496
2880	1 REC I.T.	#10	30/1	41	С	42	30/2	_	-	2496

ELECTRICAL RISER DIAGRAM

ROVIDE	ENGRAVED	NAMEPLATE	WITH	TYPED	INDEX	CARD.	


PROVIDE	ENGRAVED NAMEPLATE	WITH T	(PED II	1DEX	CARD.							
NEW	PANEL "LA"									(SECTION 2)		
•	8 3PH 4W EED THRU LUGS		2	225 AMP MLO						MOUNTING: 1	SURFACE 10,000 AIC	
LOAD VA	SERVES	WIRE	СВ	СКТ	PHASE (СКТ	СВ	WIRE		SERVES	LOAD VA	
1080	6 REC	#10	20/1	43	Α	44	20/1	#10	4 REC		720	
360	2 REC	#10	20/1	45	В	46		#10	1 REC		180	
540	3 REC	# 10	20/1	47	С	48	20/1	# 10	4 REC		720	
1080	8 REC	# 10	20/1	49	Α	50	20/1	# 10	4 REC		720	
360	2 REC	#10	20/1	51	В	52	20/1	# 10	1 REC		180	
540	3 REC	#10	20/1	53	С	54	20/1	#10	4 REC		720	
720	4 REC	# 10	20/1	55	Α	56	20/1	# 10	1 REC		180	
1080	6 REC	# 10	20/1	57	В	58	20/1	# 10	4 REC		720	
1080	6 REC	# 10	20/1	59	С	60	20/1	# 10	4 REC		720	
180	1 REC	# 10	20/1	61	Α	62	20/1	# 10	1 REC		180	
180	1 REC	# 10	20/1	63	В	64	20/1	# 10	4 REC		720	
720	4 REC	# 10	20/1	65	С	66	20/1	# 10	1 REC		180	
180	1 REC	# 10	20/1	67	Α	68	20/1	# 10	4 REC		720	
720	4 REC	# 10	20/1	69	В	70	20/1	# 10	4 REC		720	
720	4 REC	#10	20/1	71	С	72	20/1	#10	1 REC		180	
180	1 REC	# 10	20/1	73	Α	74	20/1	# 10	4 REC		720	
720	4 REC	# 10	20/1	75	В	76	20/1	# 10	1 REC		180	
180	1 REC	#10	20/1		С	78	20/1	# 10	4 REC		720	
720	4 REC	#10	20/1	_	Α	80		#10	4 REC		720	
720	4 REC	#10	20/1	81	В	82	20/1	#10	1 REC		180	
180	1 REC	# 10	20/1	83	С	84	20/1	# 10	4 REC		720	

PROVIDE ENGRAVED NAMEPLATE WITH TYPED INDEX CARD.

	PANEL "LA"								(SECTION 3)		
120/20	8 3PH 4W		:	225	AMP N		MOUNTING: SURFACE 10,000 AIC				
LOAD VA	SERVES	WIRE	СВ	СКТ	PHASE	CKT	СВ	WIRE	SERVES	LOAD V	
180	1 REC	#12	20/1	85	Α	86	20/1	#12	RECIRCULATION PUMP	300	
720	4 REC	#12	20/1	87	В	88	20/1	#12	1 REC EDF	1200	
180	1 REC	#12	20/1	89	С	90	20/1	#12	1 REC EDF	1200	
900	5 REC	#12	20/1	91	Α	92	20/1	#12	1 REC ON ROOF	180	
900	5 REC	#12	20/1	93	В	94	20/1	#12	EF-1 1/3HP	830	
180	1 REC	#12	20/1	95	С	96	20/1	#12	EF-2 1/3HP	830	
360	2 REC	#12	20/1	97	Α	98	20/3	#12	ITAC-1	336	
720	4 REC	#12	20/1	99	В	100	20/3	_	_	336	
900	5 REC	#12	20/1	101	С	102	20/3	_	_	336	
720	4 REC	#12	20/1	103	Α	104	25/3	#12	ITCU-1	1536	
1260	7 REC	#12	20/1	105	В	106	25/3	_	_	1536	
540	3 REC	#12	20/1	107	С	108	25/3	_	-	1536	
1620	9 REC	#12	20/1	109	Α	110	20/1		SPARE		
180	1 REC I.T.	#12	20/1	111	В	112	20/1		SPARE		
540	3 REC	#12	20/1	113	С	114	20/1		SPARE		
850	1 REC REFRIG.	#12	20/1	115	Α	116	20/1		SPARE		
1200	1 REC MICROWAVE	#12	20/1	117	В	118	20/1		SPARE		
1200	1 REC COFFEE	#12	20/1	119	С	120	20/1		SPARE		
1080	6 REC	#12	20/1	121	Α	122	20/1		SPARE		
720	4 REC	#12	20/1	123	В	124	20/1		SPARE		
200	DDC CONTROL PANEL	#12	20/1	125	С	126	20/1		SPARE		

PROVIDE ENGRAVED NAMEPLATE WITH TYPED INDEX CARD.

120/20		4	100	AMP N	MOUNTING: SURFACE 10,000 AIC						
LOAD VA	SERVES	WIRE	СВ	СКТ	PHASE	CKT	СВ	WIRE		SERVES	LOAD VA
4152	FPB-01 34.6A	#8	35/3	1	Α	2	40/3	#8	FPB-06	40.4A	4848
4152	_	_	35/3	3	В	4		1	_		4848
4152	_	_	35/3	5	С	6	40/3	ı	-		4848
3948	FPB-02 32.9A	#8	35/3	7	Α	8	20/3	#12	FPB-07	14.4A	1728
3948	_	_	35/3	9	В	10	20/3	-	_		1728
3948	_	_	35/3	11	С	12	20/3	_	_		1728
2352	FPB-03 19.6A	#12	20/3	13	Α	14	30/3	#10	FPB-08	29.4A	3528
2352	-		20/3	15	В	16	30/3	_	_		3528
2352	-	_	20/3	17	С	18	30/3	-	_		3528
2148	FPB-04 17.9A	#12	20/3	19	Α	20	20/3	#12	FPB-09	17.9A	2148
2148	_	_	20/3	21	В		20/3	_	-		2148
2148	-	_	20/3	23	С	24	20/3	-	_		2148
3948	FPB-05 32.9A	#8	35/3	25	Α	26	20/3	#12	FPB-10	19.6A	2352
3948	-	_	35/3	27	В		20/3	_	_		2352
3948	_	_	35/3	29	С		20/3	-	-		2352
4000	EWH-1 12KW	#8	50/3	31	Α	32			SPACE		
4000	-	_	50/3	33	В	34			SPACE		
4000	-	-	50/3	35	С	36			SPACE		
	SPACE			37	Α	38			SPACE		
	SPACE			39	В	40			SPACE		
	SPACE			41	С	42			SPACE		

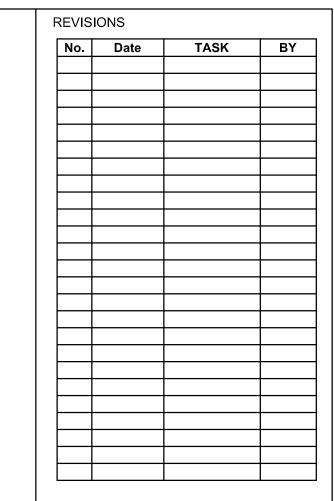

ISSUE FOR PERMIT & PRICING



HARRIS HEALTH SYSTEM 2525 Holly Hall Street, Houston, Tx 77054

ARCHITECT & ENGINEERS:



MEP: Johnston, LLC CIVIL: Johnston, LLC



Firm Registration #:F-421 SPRING BRANCH HEALTH CENTER

PROJECT LOCATION: 9801 Long Point, Houston, Tx 77055

SHEET TITLE: SYMBOLS LEGEND & PANEL SCHEDULES


DATE: NOV 4, 2013 DATE:

SHEET NUMBER:

E - 001

CHECKED BY:

JOB NO: 2013.020-02

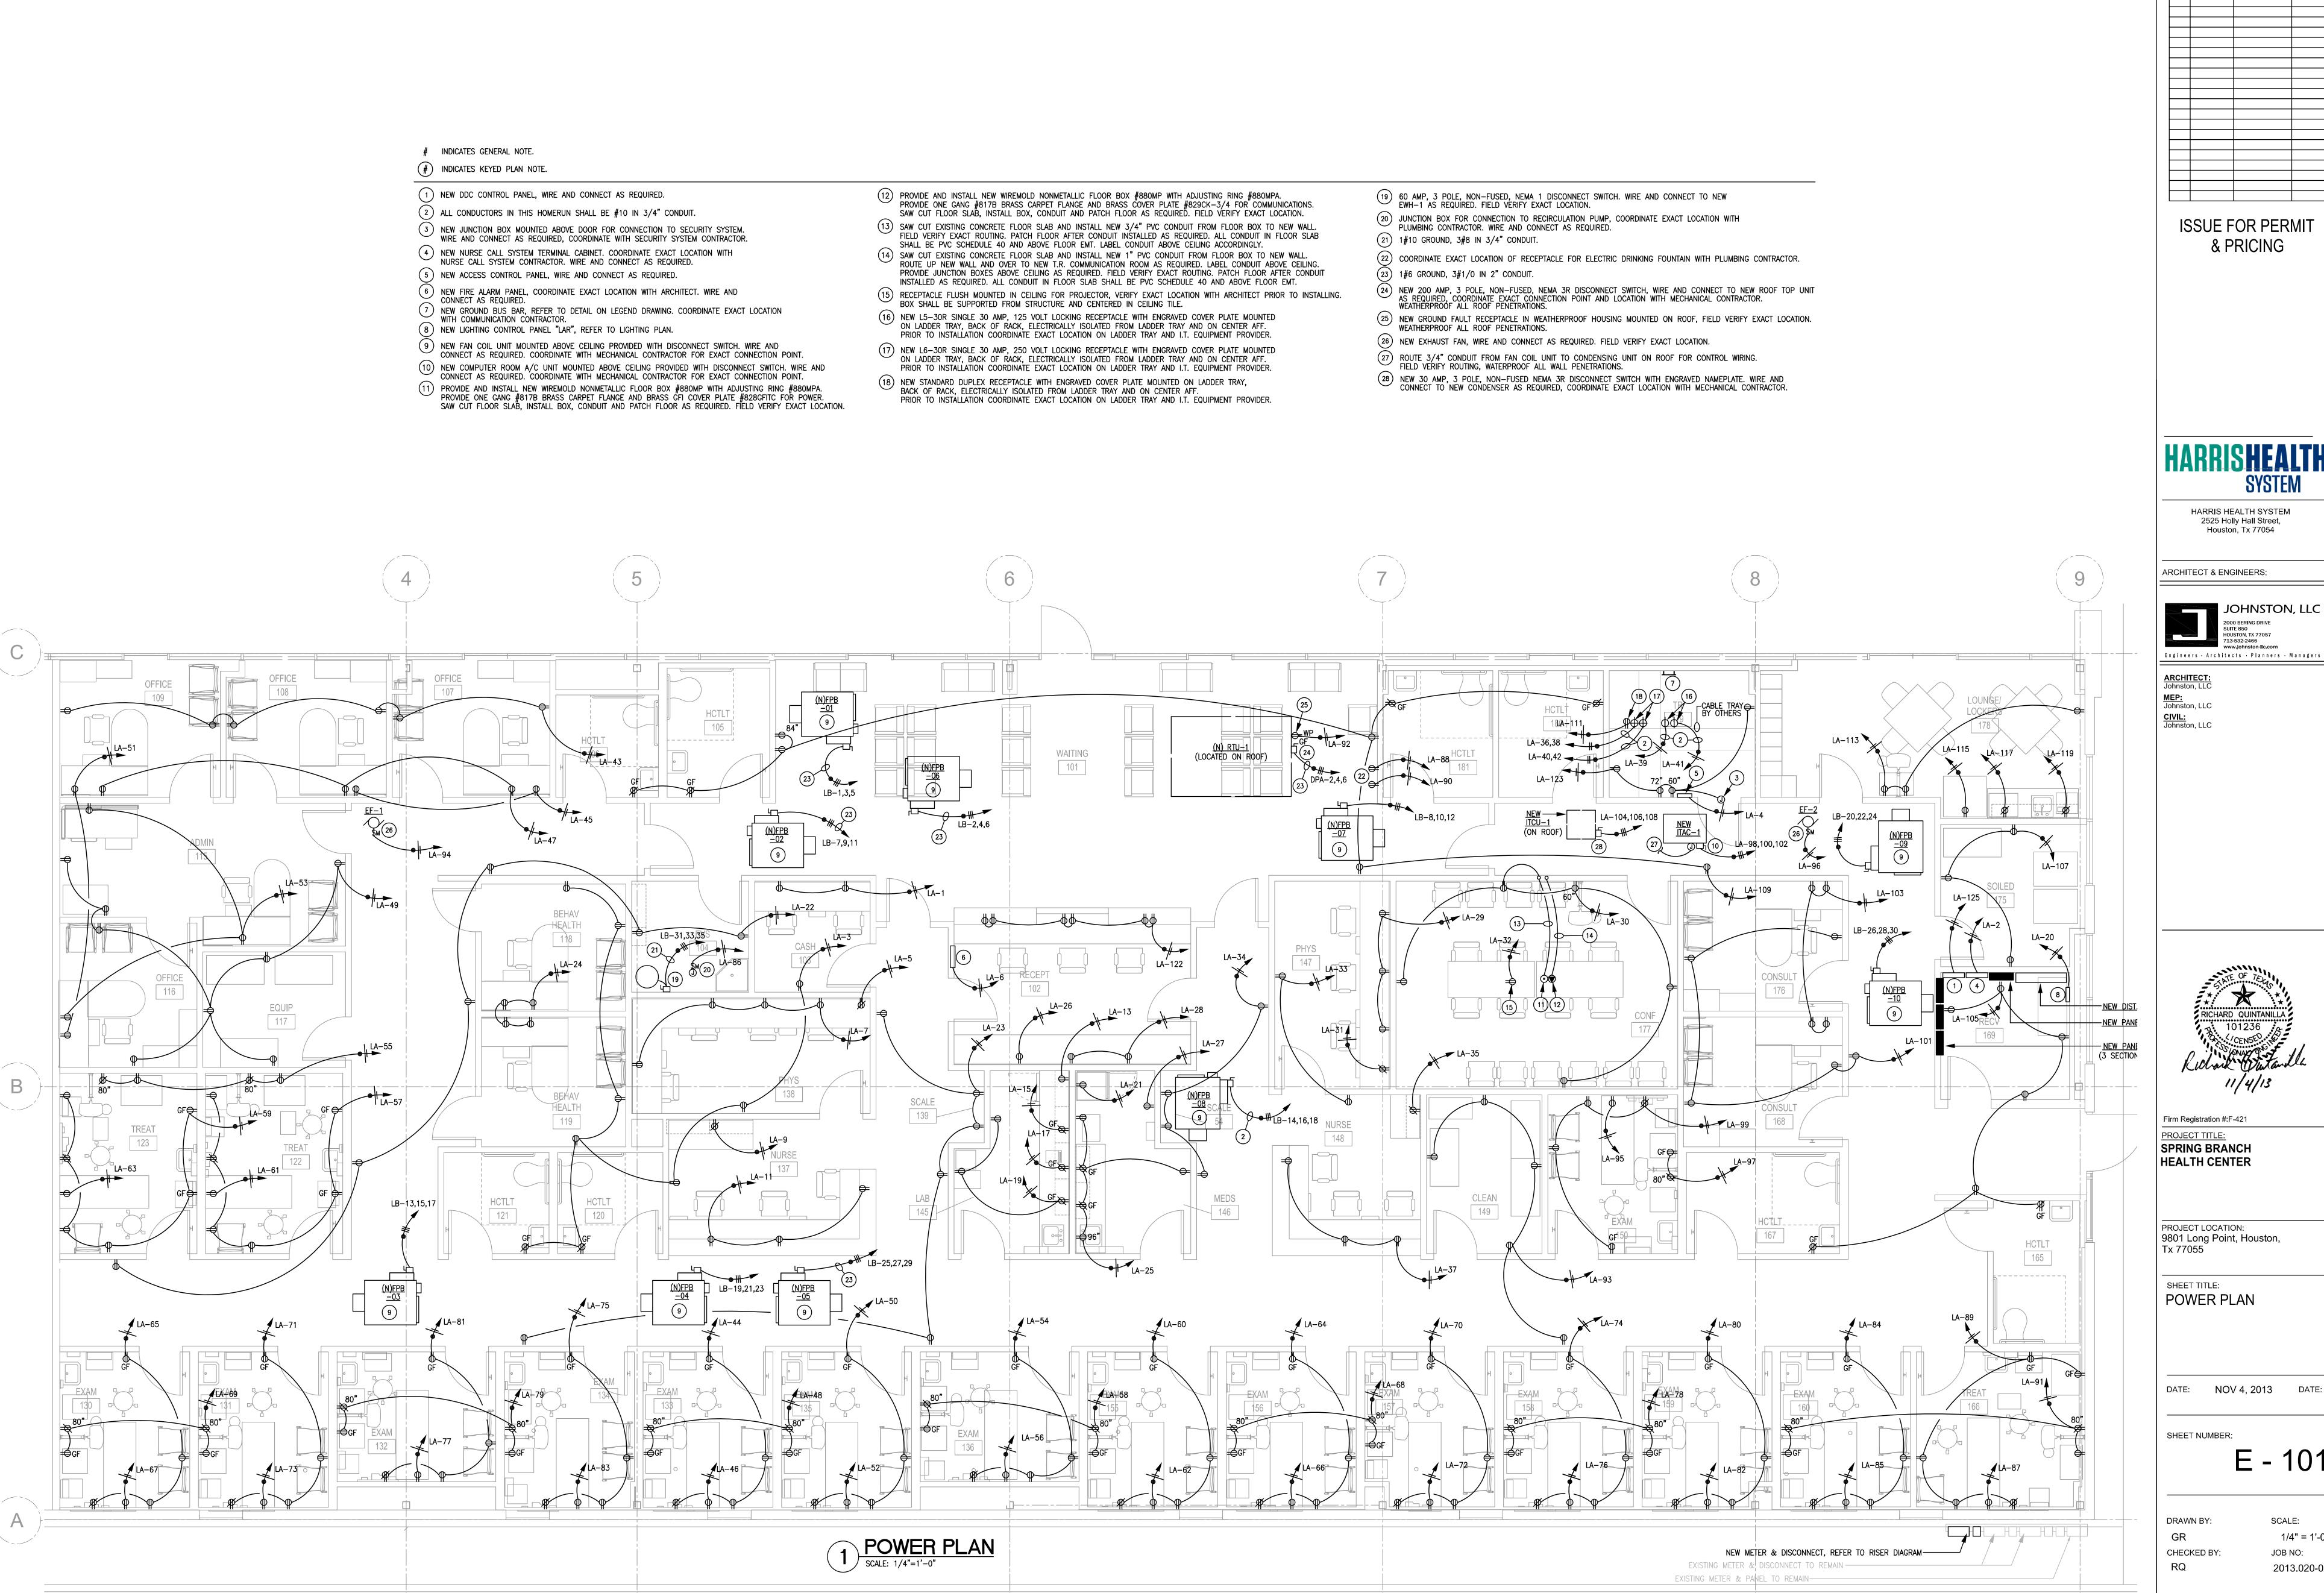

REVISIONS No. Date TASK BY

ISSUE FOR PERMIT & PRICING


Firm Registration #:F-421 SPRING BRANCH

PROJECT LOCATION: 9801 Long Point, Houston,


POWER PLAN


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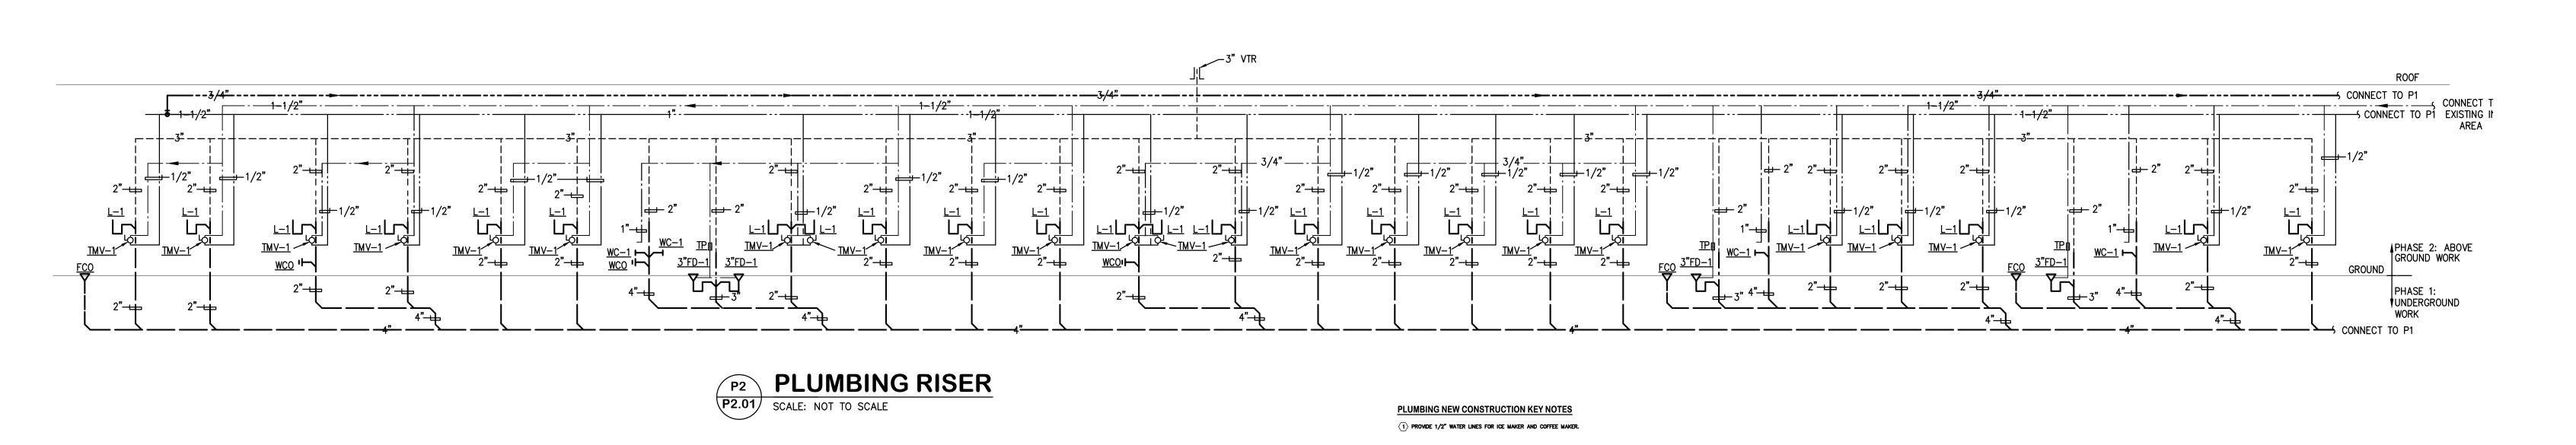
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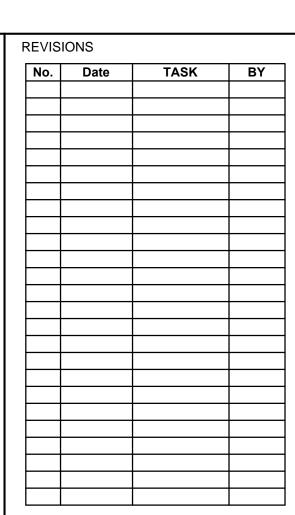


	FIRE ALARM SYMBOL LEGEND STORE STORED STORE	No. Date TASK BY No. Date TASK BY Date TASK BY B
(C)-=		HARRIS HEALTH SYSTEM 2525 Holly Hall Street, Houston, Tx 77054 ARCHITECT & ENGINEERS: JOHNSTON, LLC 2000 BERING DRIVE SUITE 850 HOUSTON, TX 77057 713-532-2466 www.johnston-IIc.com Engineers · Architects · Planners · Managers ARCHITECT: Johnston, LLC MEP: Johnston, LLC CIVIL: Johnston, LLC
B		RICHARD QUINTANILLA 101236 CENSE CONNECTION 101236 CONNECTION 11/4/IS Firm Registration #:F-421 PROJECT TITLE: SPRING BRANCH HEALTH CENTER
	₹SSCC ¥SSCC	PROJECT LOCATION: 9801 Long Point, Houston, Tx 77055 SHEET TITLE: FIRE ALARM PLAN DATE: NOV 4, 2013 DATE: SHEET NUMBER: E - 301 DRAWN BY: SCALE: GR 1/4"=1'-0" CHECKED BY: JOB NO: RQ 2013.020-02

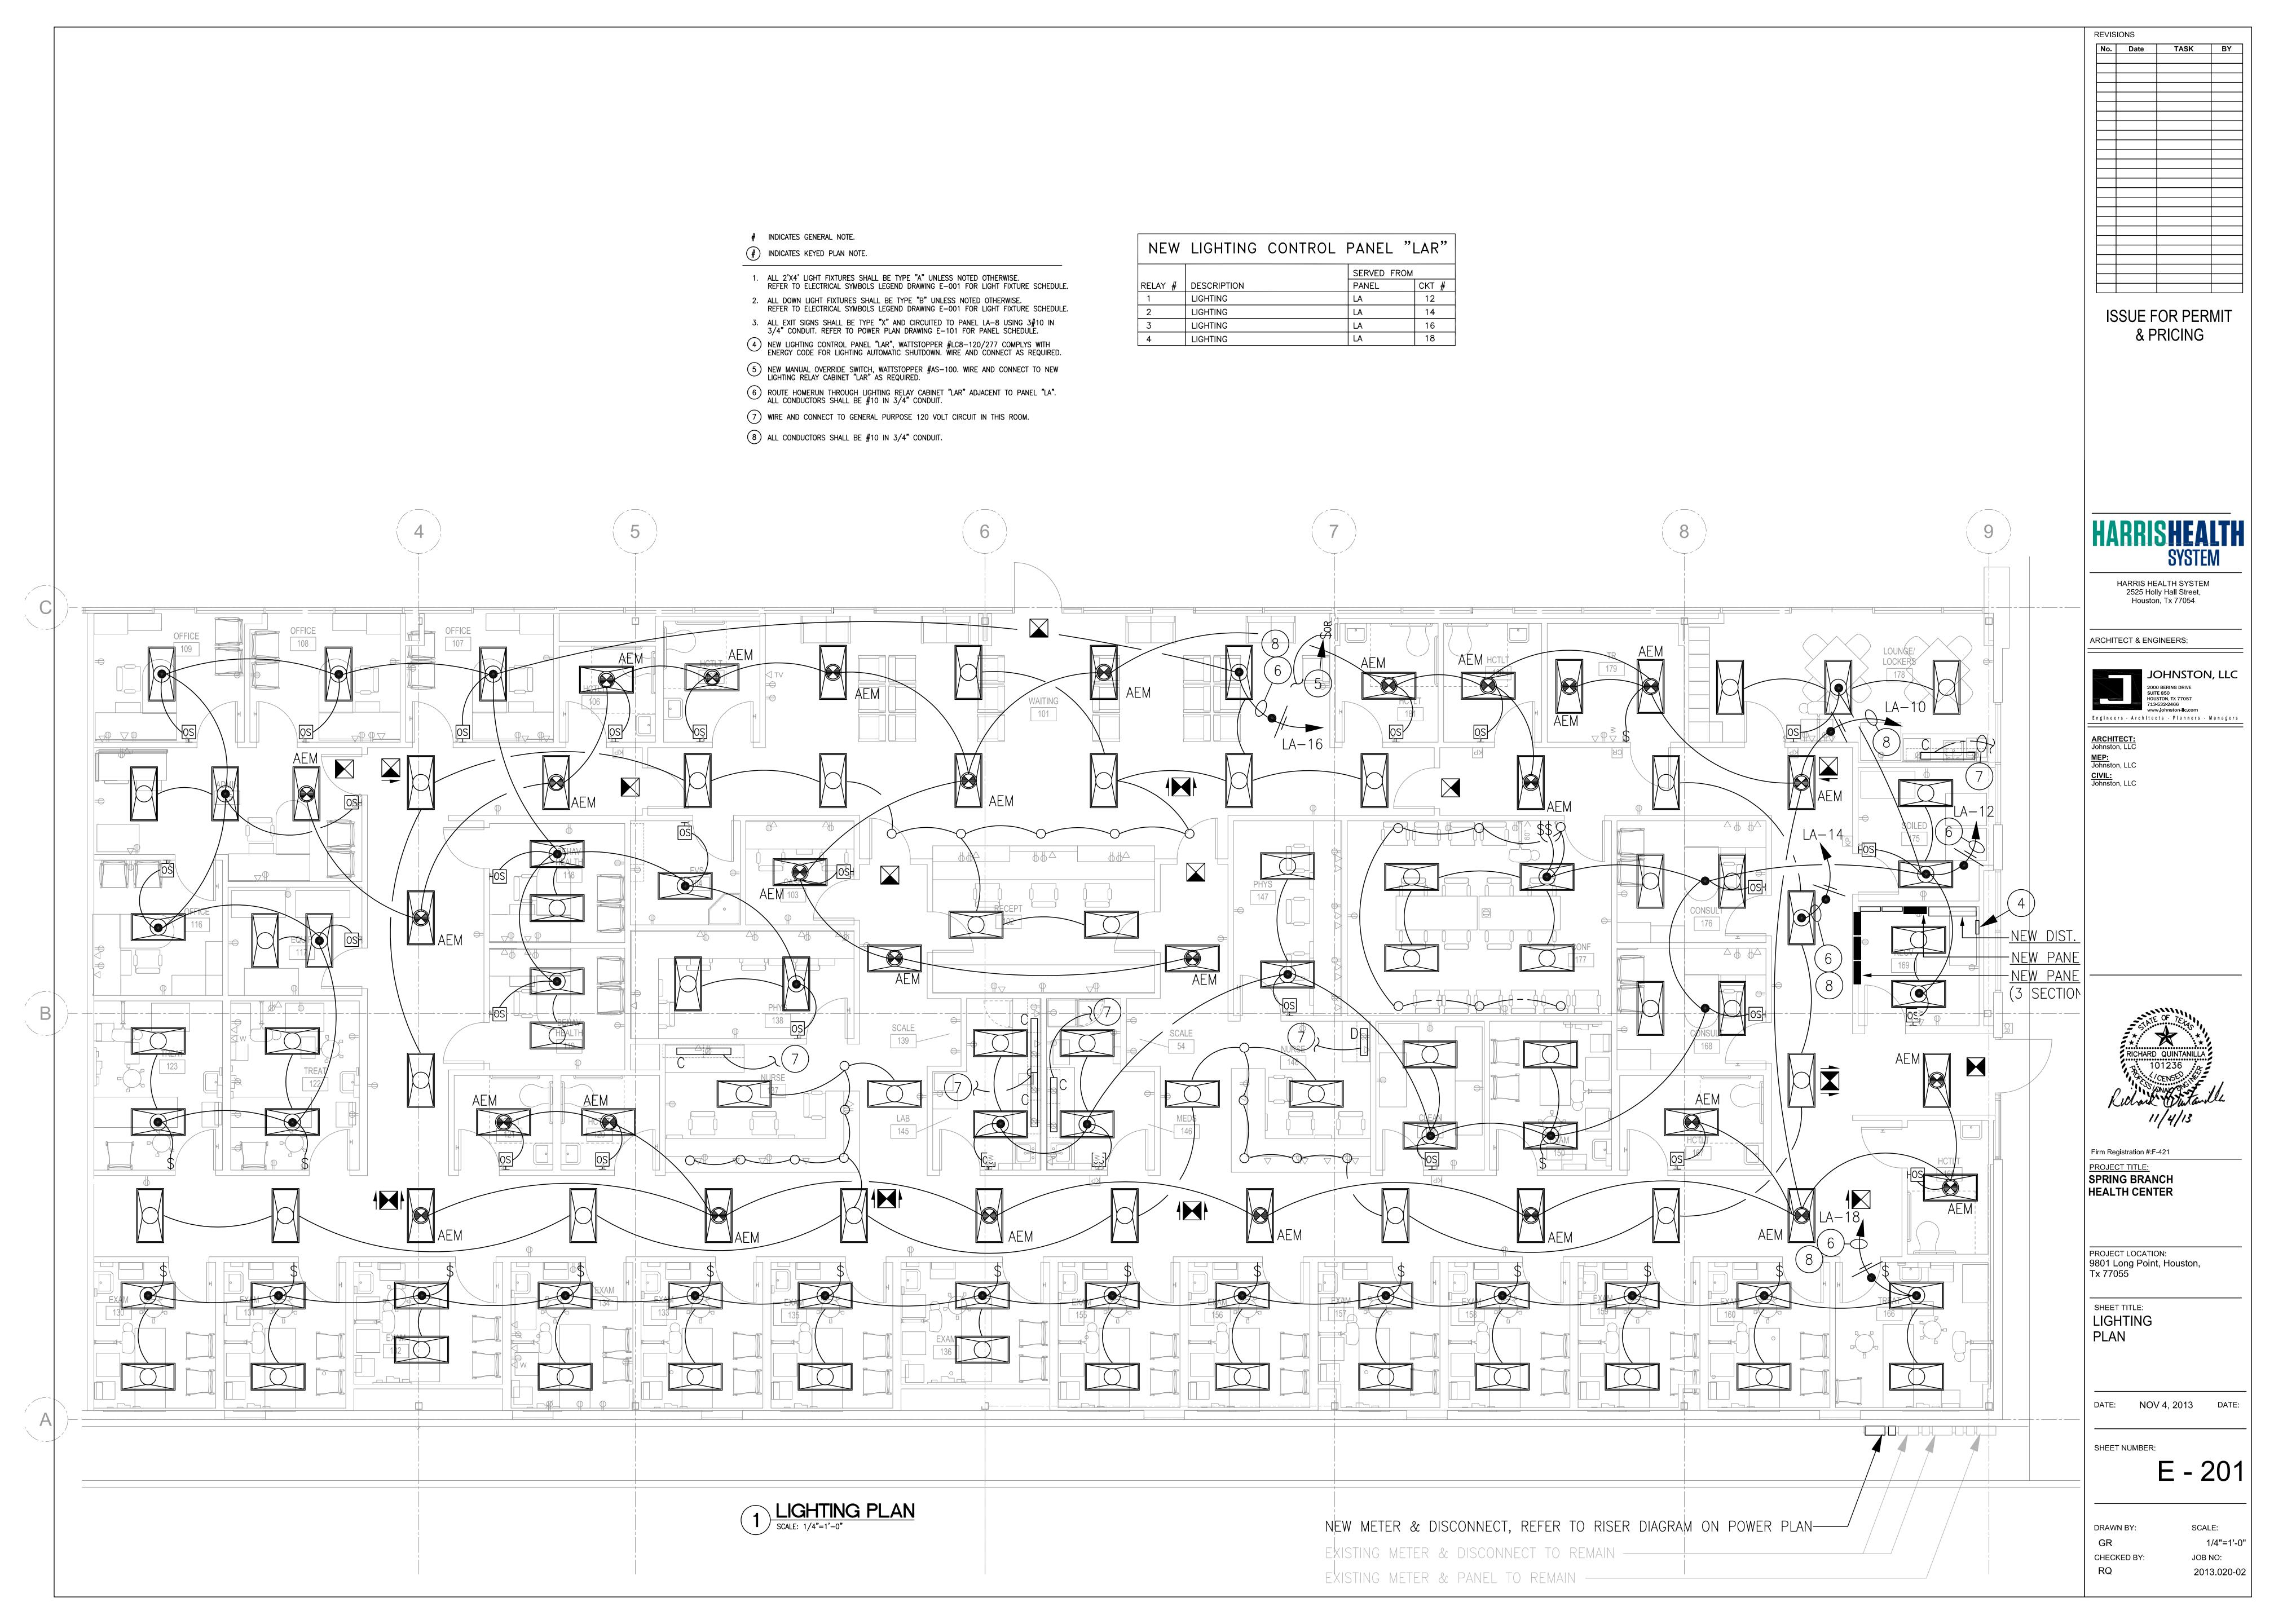



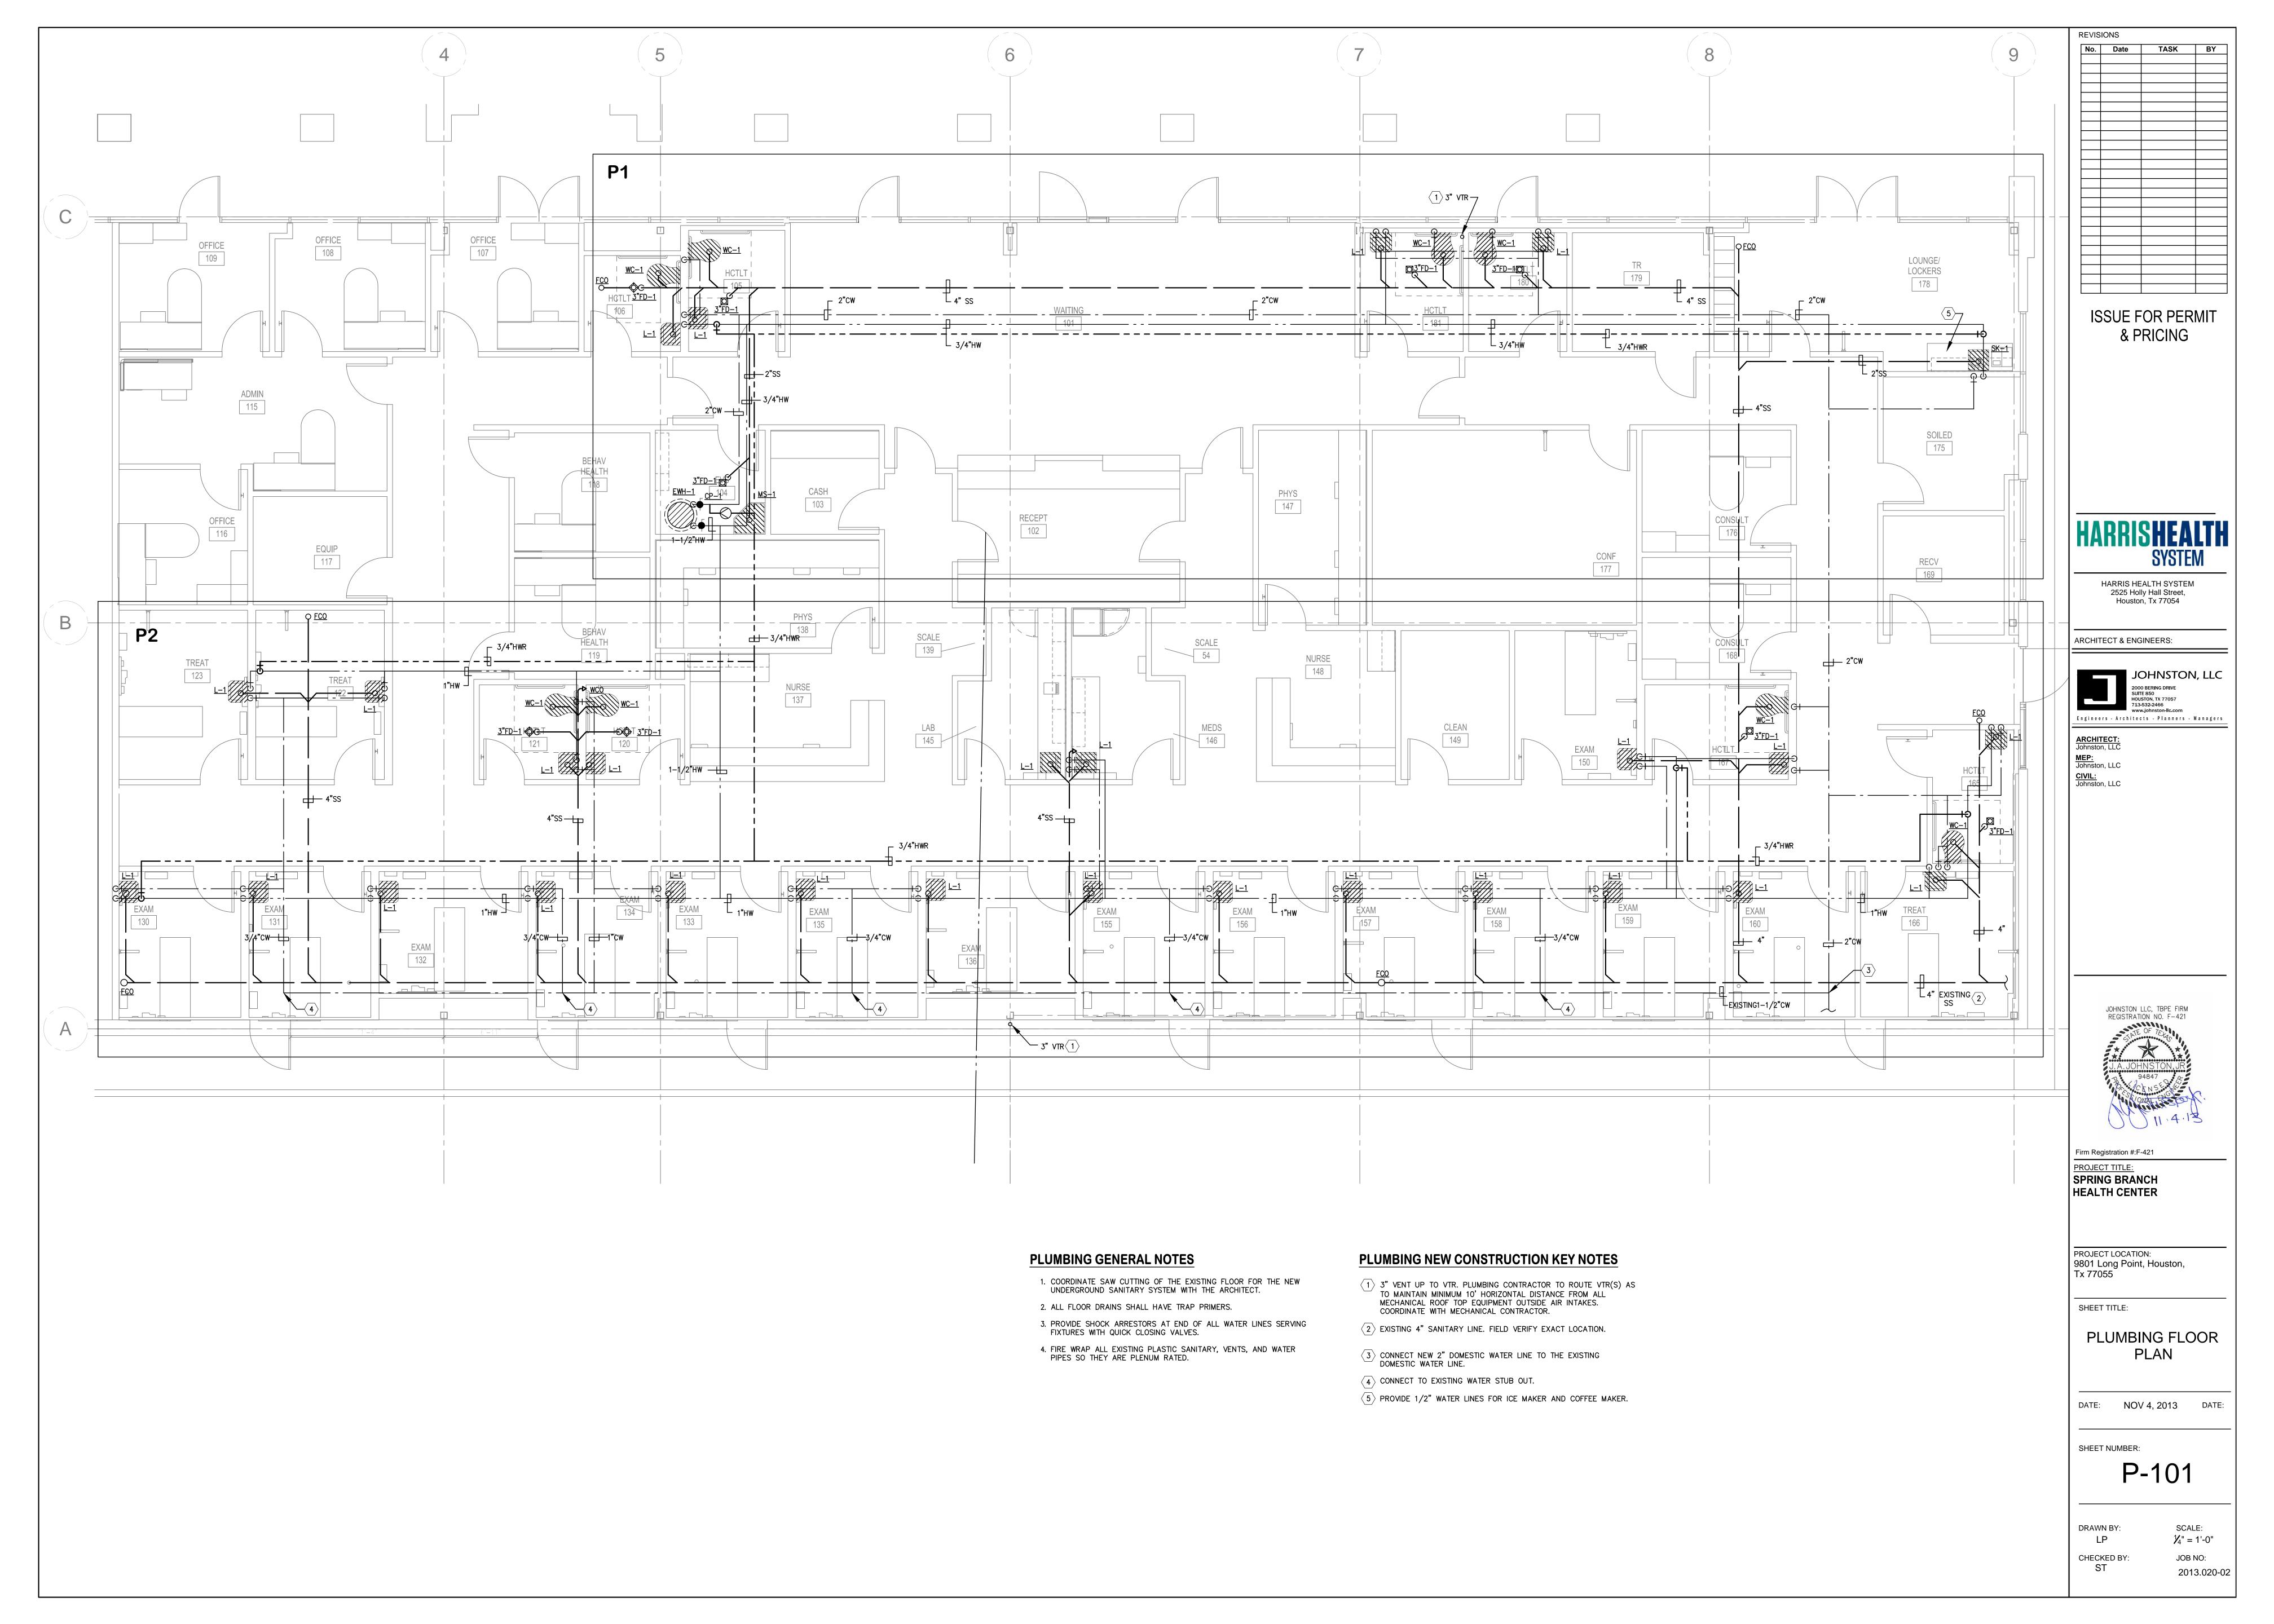

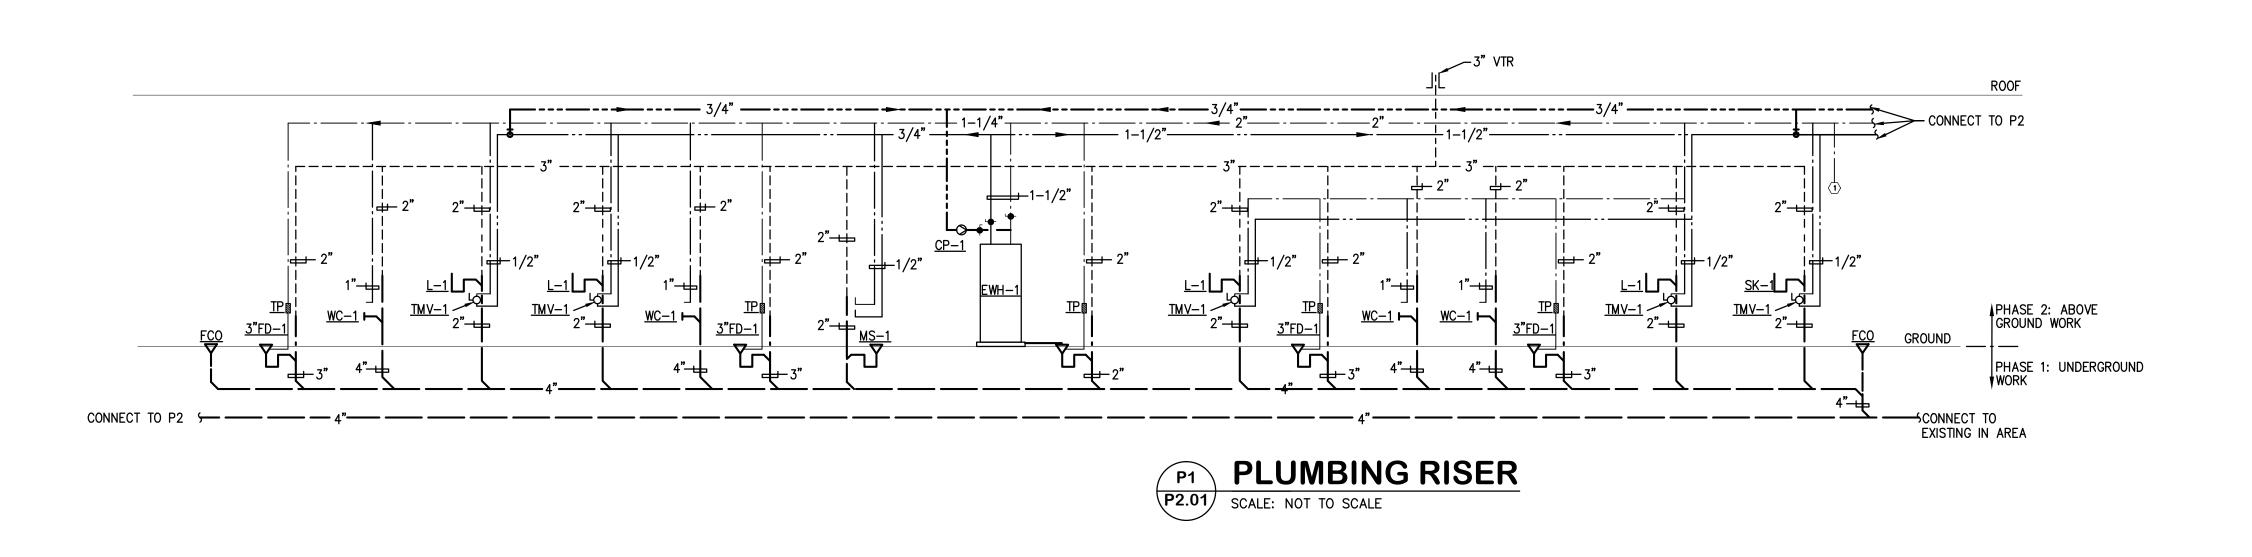



HARRIS HEALTH SYSTEM 2525 Holly Hall Street, Houston, Tx 77054

ARCHITECT & ENGINEERS:



ARCHITECT:
Johnston, LLC
MEP:
Johnston, LLC
CIVIL:
Johnston, LLC

JOHNSTON LLC, TBPE FIRM REGISTRATION NO. F-421

J. A. JOHNSTON, JR

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Firm Registration #:F-421

PROJECT TITLE:

SPRING BRANCH
HEALTH CENTER

PROJECT LOCATION:
9801 Long Point, Houston,
Tx 77055

SHEET TITLE:

PLUMBING RISERS

DATE: NOV 4, 2013 DATE:


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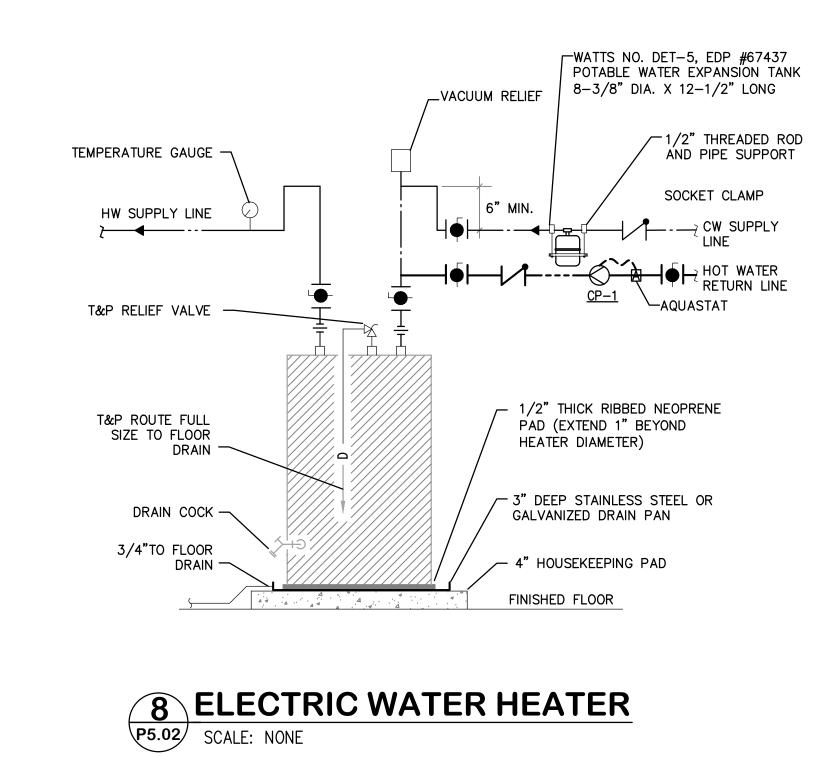
P-201


DRAWN BY:
LP
CHECKED BY:

NONE
JOB NO:
2013.020-02


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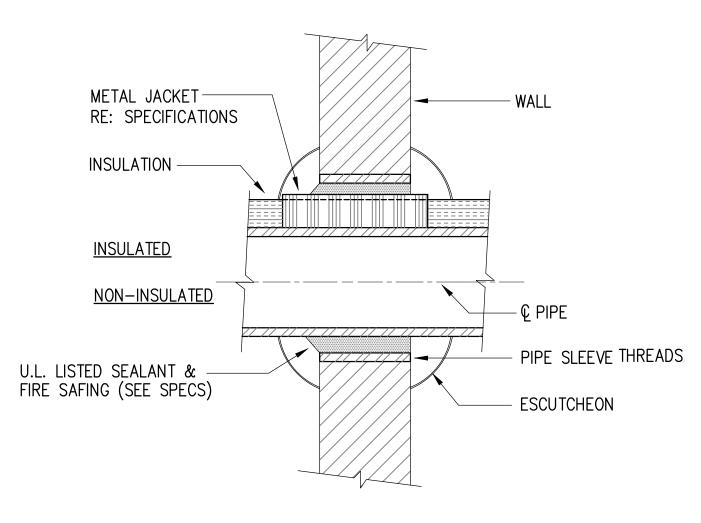




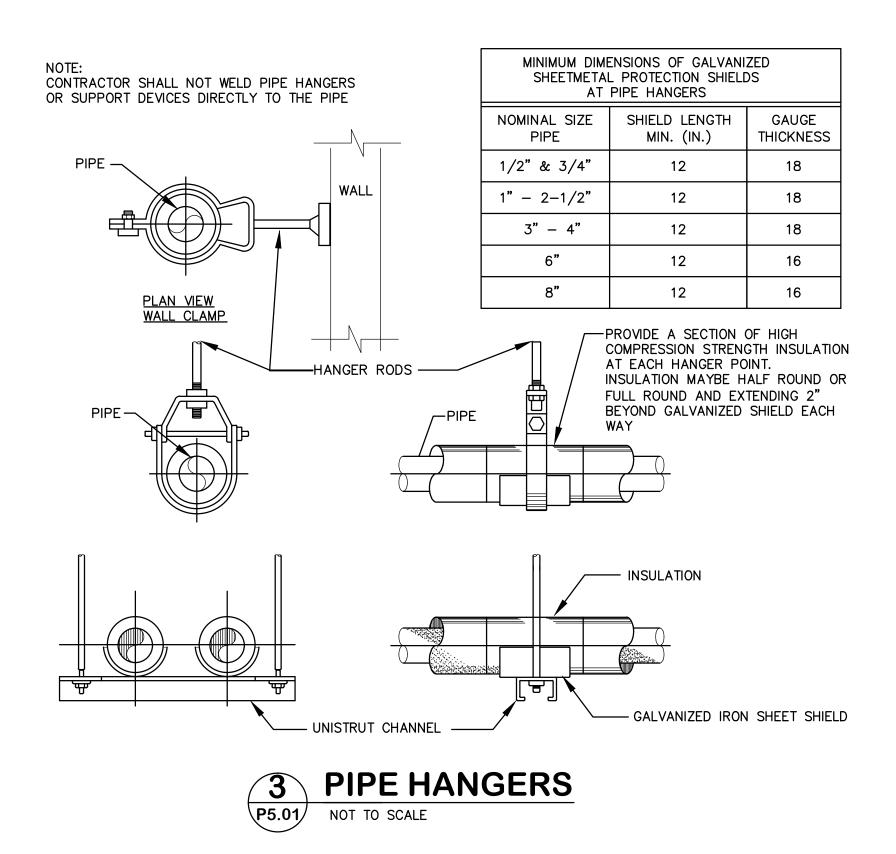


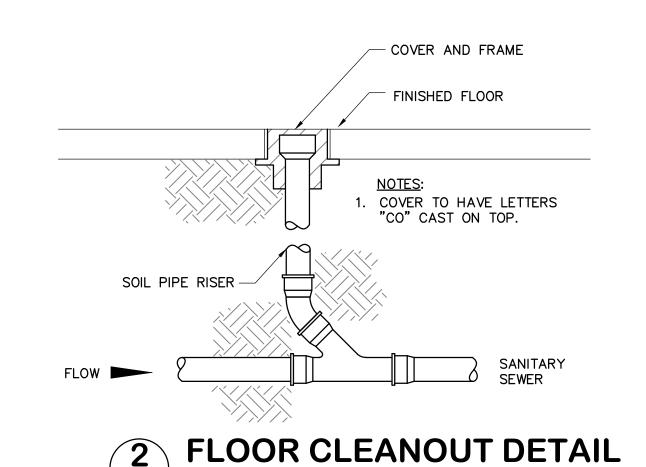NOT TO SCALE




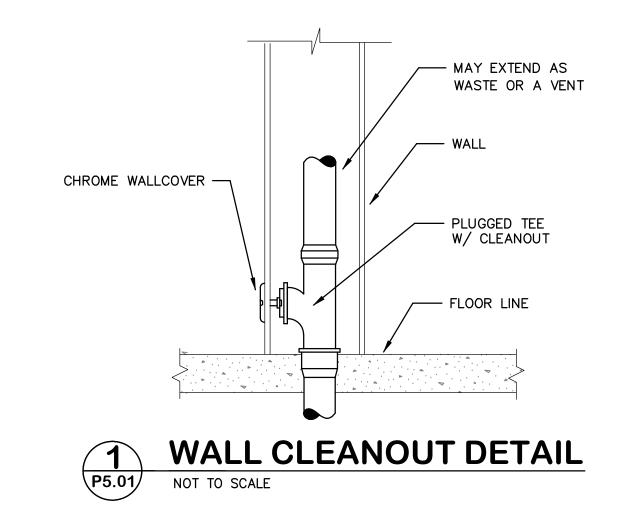




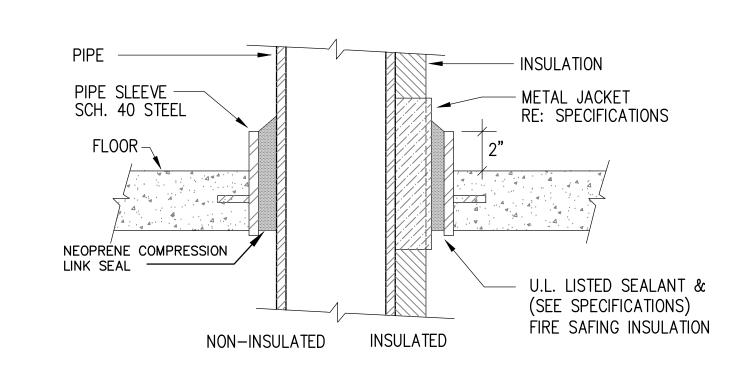




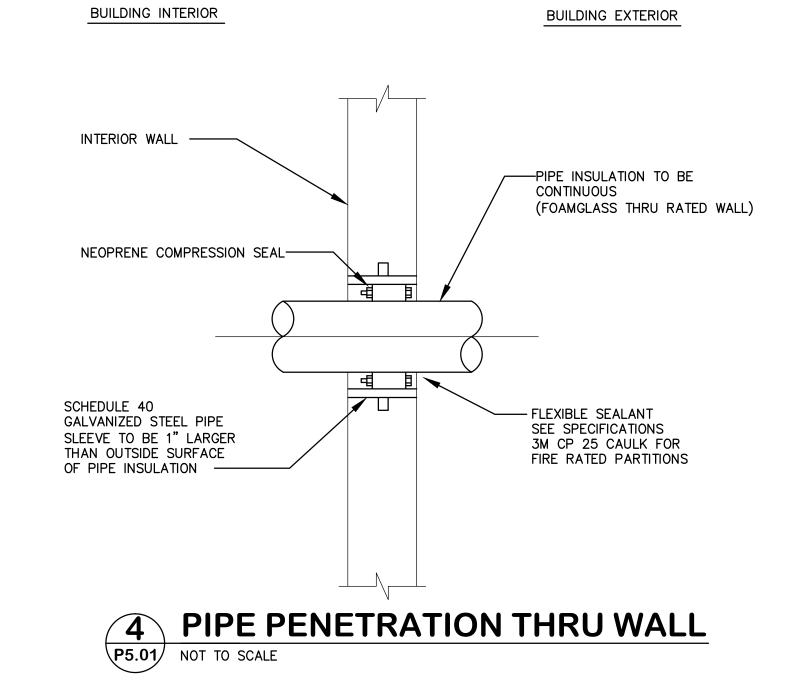

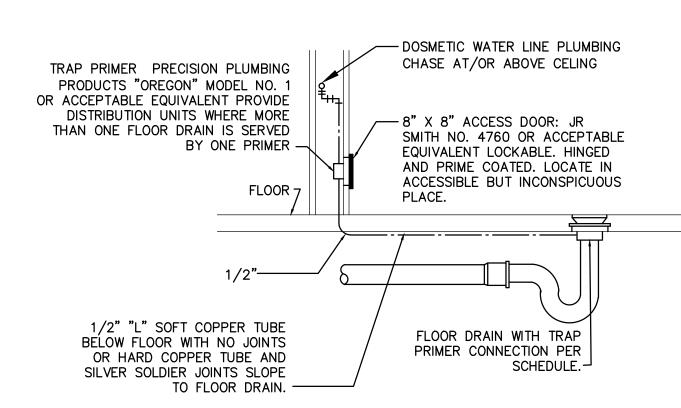

TYPICAL TRAP PRIMER 6 MOUNTING DETAIL P5.01 NOT TO SCALE

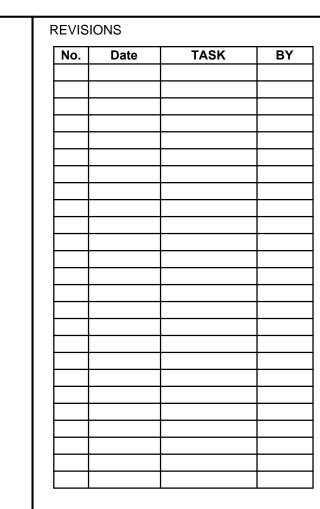

ISSUE FOR PERMIT & PRICING



HARRIS HEALTH SYSTEM 2525 Holly Hall Street, Houston, Tx 77054

ARCHITECT & ENGINEERS:



MEP: Johnston, LLC <u>CIVIL:</u> Johnston, LLC



Firm Registration #:F-421 PROJECT TITLE: SPRING BRANCH HEALTH CENTER

PROJECT LOCATION:
9801 Long Point, Houston,
Tx 77055

SHEET TITLE:

PLUMBING DETAILS

DATE: NOV 4, 2013 DATE:

SHEET NUMBER:

P-301

CHECKED BY:

JOB NO: 2013.020-02

SCALE: NONE

PLUMBING SYMBOLS

(ALL SYMBOLS SHOWN ARE NOT NECESSARILY USED ON THE DRAWINGS)

•			•
SYMBOL	DESCRIPTION	SYMBOL	DESCRIPTION
₩C	WATER CLOSET	20	P-TRAP
Ø UR	URINAL	@ @	ROOF DRAIN W/OVERFLOW DRA
ZZ SK	SINK	©	ROOF DRAIN
Ø L	LAVATORY	+	HOSE BIBB/WALL HYDRANT
<u> </u>	LAVATORY		COLD WATER (CW)
Ø MS	MOP SINK		HOT WATER (HW)
EWC	ELEC. WATER COOLER BI-LEVEL		HOT WATER RETURN
	FLOOR SINK		SANITARY DRAIN (S) ABOVE FLOOR
•	POINT OF NEW CONNECTION		SANITARY DRAIN (S) BELOW FLOOR
•	SHUT OFF VALVE		SANITARY VENT (V)
(E)	EXISTING		EXISTING COLD WATER

PIPING MATERIALS SCHEDULE							
PLUMBING SYSTEM	PLUMBING MATERIAL DESCRIPTION						
VENT PIPING	STANDARD WEIGHT CAST IRON, W/ NO-HUB JOINTS						
SANITARY DRAIN PIPING	STANDARD WEIGHT CAST IRON, W/ HUB JOINTS (BELOW SLAB)						
SANITARY DRAIN PIPING	STANDARD WEIGHT CAST IRON, W/ NO-HUB JOINTS (ABOVE SLAB)						
DOMESTIC WATER PIPING	TYPE "L" COPPER TUBING, W/ WROUGHT COPPER FITTINGS						
FIRE PROTECTION PIPING	STANDARD 40 BLACK STEEL PIPE, W/ CAST IRON FITTINGS						

HOT WATER RETURN BALANCING VALVE

SHOCK ARRESTOR SCHEDULE									
P.D.I. SYMBOL	FIXTURE UNITS	SIZE							
A	1–11	1/2" NPT							
B	12-32	3/4" NPT							
©	33–60	1" NPT							
D	61–113	1 1/4" NPT							
Œ	114–154	1 1/2" NPT							
F	155-330	2" NPT							

1. ALL ARRESTORS ARE TO HAVE ACCESS PANELS WHERE INACCESSIBLE.
2. ALL FIXTURE WATER SUPPLIES SHALL BE INSTALLED WITH APPROXIMATELY SIZED ARRESTORS IN COMPLIANCE WITH MANUFACTURER'S INSTALLATION RECOMMENDATIONS.

THERMOSTATIC MIXING VALVE							
UNIT NO.	INLET HOT WATER (DEGREE F)	OULET MIXED WATER (DEGREE F)	MINIMUM FLOW (GPM)	MAXIMUM FLOW (GPM)	VALVE FINISH	MANUFACTURER / MODEL	
TMV-1	120	110	0.5	2.5	ROUGH BRONZE	WATTS LFUSG-B	

MAKE WATER CONNECTIONS TO THERMOSTATIC MIXING VALVE(S) IN ACCORDANCE WITH THE MANUFACTURER'S RECOMENDATIONS.
 PROVIDE PIPE INCREASERS AND/OR VALVES AS REQUIRED.
 PROVIDE UNION CONECTIONS.

	PLU	JMB	ING	FIX	TUF	RE SCHEDULE
MARK	DESCRIPTION	SIZ	E OF C	ONNECT SAN	TON VENT	REMARKS
WC-1	WATER CLOSET FLUSH VALVE	1"		4"	2"	AMERICAN STANDARD MADERA 3043.102, WHITE, FLOOR MOUNTED, FLUSH VALVE, 1.28 GPF. ADA 17" RIM HEIGHT. BEMIS MANUFACTURING #1955SSC, WHITE OPEN FRONT SEAT LESS COVER, SLOAN #111-1.28 SMO HIGH EFFICIENCY FLUSH VALVE WITH SIZE C BATTERY JR SMITH CARRIER, MOUNT AT HANDICAP HEIGHT. FIELD VERIFY CARRIER TYPE AND ORIENTATION.
L-1	LAVATORY	1/2"	1/2"	2"	2"	AMERICAN STANDARD LUCERNE 0355.012, LAVATORY — WALL MOUNTED. CHICAGO FAUCET 116.212.21.1 WITH 6V LITHIUM CRP2 BATTERY GRID STRAINER, McGUIRE P—TRAP, MCGUIRE #2165 ANGLE STOPS, TEMPERATURE MIXING VALVE, TRUEBRO INSTALLATION KIT, JR SMITH CARRIER (FIELD VERIFY TYPE AND ORIENTATION). P—TRAP AND SUPPLIES TO BE WRAPPED WITH TRUEBRO INSULATION KIT
SK-1	SINGLE COMPARTMENT SINK	1/2"	1/2"	2"	2"	ELKAY #LRAD2022, SINGLE BOWL SINK ADA COMPLIANT, 18 GA 20"x22"x6", STAINLESS STEEL, DRAIN OFF CENTER, ADA, CHICAGO 1100—GN2AE3—317CP DOUBLE LEVER FAUCET AND LK—35 CRUMB STRAINER, ANGLE STOP
SK-2	DOUBLE COMPARTMENT SINK	1/2"	1/2"	2"	2"	ELKAY #LRAD(Q)3722, SINGLE BOWL SINK ADA COMPLIANT, 18 GA 20"x22"x6", STAINLESS STEEL, DRAIN OFF CENTER, ADA, CHICAGO 1100—GN2AE3—317CP DOUBLE LEVER FAUCET AND LK—35 CRUMB STRAINER, ANGLE STOP
MS-1	MOP SINK	1/2"	1/2"	3"	2"	OP-40 FLOOR MOUNTED MOP SINK, STAINLESS STEEL, FIAT 830-AA FAUCET; 832-AA HOSE AND HOSE BRACKET, BOBRICK B-223x36 STAINLESS STEEL MOP HANGER.
EW-1	EYEWAS/DRENCH HOSE UNIT	1/2"	1/2"			GUARDIAN G5022, DECK MOUNTED. PROVIDE THERMOSTATIC MIXING VALVE G3600. MOUNT AT HANDICAP HEIGHT.
FD	FLOOR DRAIN			as noted	2"	JR SMITH 2005A, FLOOR DRAIN, ROUND TOP, NICKEL BRONZE STRAINER
WCO	WALL CLEAN OUT					JAY R. SMITH #4472 WALL CLEAN OUT, TAPER THREAD PLUG WITH ROUND COVER
FCO	FLOOR CLEAN OUT					JAY R. SMITH 4020 SERIES, ROUND WITH NIKEL BRONZE TOP
A	SHOCK ABSORBER					WADE MODEL WATER HAMMER ARRESTER, ALL STAINLESS STEEL BELLOWS AND CASING. APPROVED FOR CONCEALED WALL CONSTRUCTION, PDI CERTIFIED FOR WH-201 STANDARD.
TP	TRAP PRIMER	1/2"	_	_	_	PPP MO# CPO-500, PRECISION PLUMBING PRODUCTS "DUAL FLOW" AUTOMATIC FLOOR DRAIN TRAP PRIMER. SINGLE SERVICE FD TRAP ACTIVE FIXTURE. DO NOT SUBJECT TRAP PRIMER VALVE TO ROUGH IN PRESSURE TEST.
IM-1	VALVE IN WALL BOX WITH FINAL CONNECTION	1/2"	_	_	_	GUY GRAY BIM875
WF-1	IN LINE WATER FILTER	1/2"				AQUA-PURE #AP717
BP-1	DOUBLE CHECK VALVE	1/2"	_	_	-	WATTS #7

^{1.} ALL PIPES, FIXTURES, VALVES AND FITTINGS SHALL BE MADE IN THE USA.

	ELECTRIC WATER HEATER SCHEDULE							
UNIT NO.	STORAGE CAPACITY (GALLONS)	RECOVERY AT 80 deg.F TEMP. RISE (GPH)	KW	VOLTAGE	PHASE	TEMP RISE	MANUFACTURER / MODEL	REMARKS
EWH-1	80	-	12	208	3	-	A.O. SMITH/MODEL DEN-80	

PUMP								
UNIT NO.	DESCRIPTON	MANUFACTURER	MODEL NO	MATERIAL	V/HP	REMARKS		
CP-1	RECIRCULATION PUMP	GRUNFOS	UPS-15-35SFC	BRONZE	115/0.15	3 SPEED, FLANGE CONNECTIONS ON 3/4" LINE, WITH NO COUPLING PROVIDE TIMER KIT AND THERMOSTAT AQUASTAT		

No. Date TASK BY

ISSUE FOR PERMIT & PRICING

HARRIS HEALTH SYSTEM 2525 Holly Hall Street, Houston, Tx 77054

ARCHITECT & ENGINEERS:



MEP: Johnston, LLC <u>CIVIL:</u> Johnston, LLC

JOHNSTON LLC, TBPE FIRM REGISTRATION NO. F-421

Firm Registration #:F-421 PROJECT TITLE: SPRING BRANCH HEALTH CENTER

PROJECT LOCATION:
9801 Long Point, Houston,
Tx 77055

SHEET TITLE:

PLUMBING SCHEDULES

DATE: NOV 4, 2013 DATE:

SHEET NUMBER:

P-401

DRAWN BY: CHECKED BY: ST SCALE: NONE JOB NO: 2013.020-02

(FO	R REQUIREMENTS, REFER TO "FACE PLATE, BACK BOX, AND CONDUIT REQU	IREMENTS," SHEET T001)
SYMBOL	DESCRIPTION	MOUNTING HEIGHT TO TOP OF OUTLET COVER
∢x	DATA OUTLET (SUB-SCRIPT REPRESENTES NUMBER OF OUTLETS IN FACEPLATE)	18" ABOVE FINISHED FLOOR
∢×	DATA OUTLET (SPECIAL MOUNTING HEIGHT) (SUB-SCRIPT REPRESENTES NUMBER OF OUTLETS IN FACEPLATE)	PER ARCH. ELEVATIONS
	DATA OUTLET (FLOOR - FLUSH OR BELOW FLOOR) (SUB-SCRIPT REPRESENTES NUMBER OF OUTLETS IN FACEPLATE)	FLUSH FLOOR OR SURFACE MOUNT BOX
⊘ X	DATA OUTLET (CEILING - FLUSH OR ABOVE CEILING) (SUB-SCRIPT REPRESENTES NUMBER OF OUTLETS IN FACEPLATE)	FLUSH CEILING OR ABOVE CEILING (AC)
-	WIRELESS ACCESS POINT CONNECTION	ABOVE CEILING
⋖ W	WALL PHONE VOICE OUTLET	45" ABOVE FINISHED FLOOR
	AUDIO/VISUAL	
SYMBOL		
AV	AUDIO/VISUAL WALL INTERFACE (CONFIGURATION DETERMINED BY OWNER)	WALL
DV	DVD PLAYER	PER ARCH. ELEVATIONS
Pd	OVERHEAD PROJECTOR	CEILING
	INTERCOM	
SYMBOL	DESCRIPTION	MOUNTING HEIGHT TO TOP OF OUTLET COVER
\bigcirc V	INTERCOM MASTER WITH VIDEO	DESK OR WALL
(ID) _{VR}	INTERCOM MASTER WITH VIDEO AND DOOR RELEASE	DESK OR WALL
(F)	INTERCOM STATION	FLUSH IN WALL
\mathbb{F}_{V}	INTERCOM STATION WITH VIDEO	FLUSH IN WALL
(IV)	INTERCOM STATION	SURFACE MOUNT - WALL
\mathbb{W}_{\vee}	INTERCOM STATION WITH VIDEO	SURFACE MOUNT - WALL
	PAGING SYSTEM	
SYMBOL	DESCRIPTION	MOUNTING HEIGHT TO TOP OF OUTLET COVER
PS	PAGING SPEAKER	CEILING
V	VOLUME CONTROL	PER ARCHITECT WALL ELEVATION
(FO	NURSE CALL R REQUIREMENTS, REFER TO "NURSE CALL BACK BOX AND CONDUIT REQUI	REMENTS," SHEET T001.)
SYMBOL	DESCRIPTION	MOUNTING HEIGHT TO TOP OF OUTLET COVER
(EP)	EMERGENCY PULL CORD STATION	PER ARCH. WALL ELEVATIONS
NM	NURSE MASTER STATION CONNECTION	PER ARCH. WALL ELEVATIONS
<u></u>	AUDIBLE AND VISUAL DOME LIGHT	CEILING MOUNTED
₹ Z	AUDIBLE AND VISUAL ZONE LIGHT	CEILING MOUNTED
		-

	R REQUIREMENTS, REFER TO "TELEVISION BACK BOX AND CONDUIT REC	MOUNTING HEIGHT TO
SYMBOL	DESCRIPTION	TOP OF OUTLET COVER
TV	TV OUTLET	MATCH POWER, OR PER ARCH. ELEVATIONS
TV D	COMBINATION TV/DATA OUTLET	MATCH POWER, OR PER ARCH. ELEVATIONS
	SECURITY	
SYMBOL	DESCRIPTION	MOUNTING HEIGHT TO TOP OF OUTLET COVER
CR	SECURITY CARD READER	PER ARCH. WALL ELEVATION
KP	SECURITY KEY PAD	PER ARCH. WALL ELEVATION
DR	SECURITY DOOR RELEASE BUTTON	WALL OR CASEWORK, OWNER DIRECTION
DC	SECURITY DOOR CONTACT	IN DOOR FRAME
РВ	SECURITY PANIC BUTTON	WALL OR CASEWORK, OWNER DIRECTION
GB	GLASS BREAK SENSOR	PER ARCH. WALL ELEVATION
MD	MOTION DETECTOR	PER ARCH. WALL ELEVATION
PC⊲ _C	SECURITY CCTV CAMERA - PAN/TILT/ZOOM - CEILING MOUNT	CEILING MOUNTED
PCM W	SECURITY CCTV CAMERA - PAN/TILT/ZOOM - WALL MOUNT	WALL MOUNTED
PCM WP	SECURITY CCTV CAMERA - PAN/TILT/ZOOM, WEATHER PROOF	WALL, POLE, OR PARAPET
FCA F	SECURITY CCTV CAMERA - FIXED - CEILING MOUNT	CEILING MOUNTED
FC1 W	SECURITY CCTV CAMERA - FIXED - WALL MOUNT	WALL MOUNTED
FCM WP	SECURITY CCTV CAMERA - FIXED, WEATHER PROOF	WALL, POLE, OR PARAPET

	SHEET INDEX
SHEET#	DESCRIPTION
T-000	LEGENDS, INDEX AND NOTES - TELECOM
T-001	FACEPLATE, BACKBOX, AND CONDUIT REQUIREMENTS - TELECOM
T-201	LEVEL 1 FLOOR PLAN - TELECOM
T-401	ENLARGED PLANS AND ELEVATIONS - TELECOM

TELECOMMUNICATIONS/LOW VOLTAGE SYSTEMS GENERAL CONSTRUCTION NOTES

CEILING OR ABOVE CEILING MOUNTED EQUIPMENT.

G1. COORDINATE LOCATION AND MOUNTING REQUIREMENTS OF ALL CEILING MOUNTED OR ABOVE CEILING MOUNTED DEVICES WITH REFLECTED CEILING PLAN, LIGHTING LAYOUT, AND OTHER

G2. ALL ABOVE CEILING WORK IN EXISTING FACILITY IS TO BE CONDUCTED IN ACCORDANCE WITH FACILITY I.C.R.A. POLICIES.

G3. REFER TO SHEET T001 FOR ALL FACE PLATE, BACK BOX, AND CONDUIT SIZE REQUIREMENTS FOR ALL VOICE/DATA OUTLETS.

G4. PATIENT ROOM HEADWALL DEVICES - PRIOR TO ROUGH-IN, COORDINATE EXACT DEVICE LOCATIONS, BACKBOX, AND CONDUIT REQUIREMENTS WITH ARCHITECTURAL HEADWALL ELEVATIONS AND OWNER FURNISHED PRE-FABRICATED HEADWALL REQUIREMENTS.

G5. DEVICES MOUNTED IN/ADJACENT TO CASEWORK - PRIOR TO ROUGH-IN, COORDINATE EXACT DEVICE LOCATIONS WITH ARCHITECTURAL CASEWORK ELEVATIONS. COORDINATE WITH CASEWORK SHOP DRAWINGS FOR CABLING PATHWAY AND ROUGH-IN REQUIREMENTS.

G6. TELEVISION OUTLETS - COORDINATE EXACT DEVICE LOCATION WITH TV BRACKET/MOUNTING LOCATION AND ADJACENT TO POWER OUTLET AS INDICATED ON ARCHITECTURAL FLOOR PLANS, ARCHITECTURAL WALL ELEVATIONS, AND ELECTRICAL POWER DRAWINGS.

G7. DRAWINGS ARE SCHEMATIC IN NATURE AND ARE NOT DRAWN TO SCALE. CONTRACTOR IS RESPONSIBLE FOR COORDINATING EXACT ROUTING OF ALL SERVICES AND DISTANCES WITH EXISTING CONDITIONS AND WITH ALL OTHER TRADES.

G8. CONDUITS ARE TO HAVE A MAXIMUM 40% FILL RATIO.

G9. IN THE INSTALLATION OF THIS WORK, THE CONTRACTOR IS TO COMPLY WITH THE REQUIREMENTS OF LOCAL LAWS AND ORDINANCES, THE LAWS OF THE STATE OF TEXAS, THE NATIONAL BOARD OF FIRE UNDERWRITERS, AND THE NATIONAL ELECTRIC CODE.

G10. CAREFULLY EXAMINE THE PREMISES TO DETERMINE THE EXTENT OF WORK AND THE CONDITION UNDER WHICH IT MUST BE DONE. IF THERE ARE ANY QUESTIONS REGARDING THE PROJECT, THE CONTRACTOR IS RESPONSIBLE FOR OBTAINING CLARIFICATIONS FROM THE ENGINEER OR DESIGNATED REPRESENTATIVE BEFORE PROCEEDING WITH WORK OR RELATED WORK IN QUESTION.

G11. ANY DISCREPANCIES BETWEEN THE PLANS AND ACTUAL FIELD CONDITIONS MUST BE BROUGHT TO THE IMMEDIATE ATTENTION OF THE ENGINEER OR DESIGNATED REPRESENTATIVE FOR CLARIFICATION.

G12. ALL WORK IS TO BE DONE IN A THOROUGH AND PROFESSIONAL MANNER ACCORDING TO INDUSTRY AND MANUFACTURERS' STANDARDS AND WILL BE SUBJECT TO INSPECTION AND ACCEPTANCE. WORK THAT IS DEEMED SUB- STANDARD WILL BE SUBJECT TO REPLACEMENT OR REPAIR AT NO ADDITIONAL COST TO THE OWNER OR GENERAL CONTRACTOR.

G13. THE CONTRACTOR IS REQUIRED TO PROPERLY FIRE-STOP ANY CORES UTILIZED FOR THE PLACEMENT OF COMMUNICATIONS CABLING WITH APPROVED FIRE-STOPPING COMPOUND AND ACCORDING TO LOCAL AND NATIONAL CODES.

G14. ANY DISCREPANCIES BETWEEN THE PLANS AND ACTUAL PROJECT SPECIFICATIONS MUST BE BROUGHT TO THE IMMEDIATE ATTENTION OF THE ENGINEER OR DESIGNATED REPRESENTATIVE FOR CLARIFICATION.

G15. ALL PENETRATED STRUCTURES ARE TO BE RETURNED TO ORIGINAL CONDITION AND FIRE

G16. REPRESENTATION OF OUTSIDE PLANT CABLE, PATHWAY, AND FACILITIES IS APPROXIMATE AND SCHEMATIC IN NATURE. DO NOT RELY ON PLANS FOR DETERMINATION AND COORDINATION OF EXACT LOCATIONS. VERIFY ALL PERTINENT CONDITIONS AND LOCATIONS WITH THE CIVIL ENGINEER AND UTILITY LOCATION SERVICES PRIOR TO PERFORMING WORK.

G17. THE CONTRACTOR SHALL BE RESPONSIBLE FOR PROPER BONDING AND GROUNDING OF THE SYSTEMS IN COMPLIANCE WITH ANSI JSTD 607-A.

G18. ALL CABLING SHALL BE RUN IN EITHER PROJECT PROVIDED CONDUIT OR CABLE TRAY SYSTEM FOR MAJOR CABLING PATHS. WHEN INSTALLING UTP STATION CABLES TO THE CABLE TRAY SYSTEM, DO NOT EXCEED BUNDLES OF 3" DIAMETER. WHEN DEVIATING FROM THE MAIN CABLE PATHWAY, CONTRACTOR SHALL UTILIZE PROPER SUPPORT COMPONENTS FOR ATTACHMENT TO DECK. PROPER SUPPORTS SHOULD BE ALL-THREAD TYPE RODS ATTACHED TO DECK. DO NOT USE CEILING GRID SUPPORTS OR SUPPORTS OF OTHER TRADES. DO NOT EXCEED FIFTY (50) UTP STATION CABLES PER J-HOOK.

G19. THE CONTRACTOR SHALL PROVIDE, INSTALL, TERMINATE, PATCH, CROSS-CONNECT, LABEL AND DOCUMENT COMMUNICATIONS CABLING SYSTEM BASED ON THE PROJECT SPECIFICATIONS AND ACCOMPANYING DRAWINGS. THE STRUCTURED CABLING SYSTEM (SCS) SHALL INCLUDE COPPER AND FIBER OPTIC DISTRIBUTION SYSTEMS AS SPECIFIED.

G20. THE CONTRACTOR SHALL PROVIDE AND INSTALL AN INTRABUILDING COPPER AND FIBER OPTIC BACKBONE CABLING SYSTEM FROM THE MAIN DISTRIBUTION FRAME (MDF), TO THE INTERMEDIATE DISTRIBUTION FRAMES (IDF).

G21. PROVIDE, INSTALL, AND TERMINATE HORIZONTAL UNSHIELDED TWISTED PAIR (UTP) COPPER CABLING FOR VOICE AND DATA SERVICES THROUGHOUT THE PROJECT. THE INFORMATION OUTLETS WILL ACCOMMODATE TELEPHONES, COMPUTERS, FACSIMILES AND OTHER SUCH COMMUNICATIONS DEVICES.

G22. NO STATION CABLE SHALL BE LONGER THAN NINETY (90) METERS. IF THE CONTRACTOR BELIEVES ANY STATION CABLE WILL BE LONGER THAN NINETY-(90) METERS, WRITTEN APPROVAL FROM THE OWNER'S ARCHITECT/ENGINEER WILL BE REQUIRED PRIOR TO INSTALLATION OF STATION CABLE.

G23. PRIOR TO STARTING THE INSTALLATION, THE ASSIGNED INSTALLATION SUPERVISOR OR LEAD TECHNICIAN SHALL PARTICIPATE IN A WALK-THROUGH OF THE PROJECT LOCATION WITH THE ENGINEER, OR THEIR DESIGNATED REPRESENTATIVE, TO REVIEW THE INSTALLATION DOCUMENTATION.

G24. FOR ALL NURSE CALL DEVICES, REFER TO EQUIPMENT PLANS FOR EXACT REQUIREMENTS PRIOR TO ROUGH IN. COORDINATE WITH NURSE CALL VENDOR.

G25. LOCATE LOW VOLTAGE BACKBOX WITHIN 6-8 INCHES OF DUPLEX RECEPTACLE WHEN

G26. ALL OVERHEAD PAGING SPEAKERS NOT IN SPECIFIED PAGING ZONES ARE TO BE DAISY CHAINED BACK TO IDF. ALL ZONE PAGING TO BE HOME-RUNNED BACK TO IDF.

TELECOMMUNICATIONS/LOW VOLTAGE SYSTEMS GENERAL INFECTION CONTROL NOTES

1. OBTAIN FROM THE OWNER A COPY OF THE INFECTION CONTROL RISK ASSESMENT (ICRA) PREPARED FOR THIS PROJECT. REVIEW THE REQUIREMENTS IN THE REPORT AND PERFORM ALL WORK IN ACCORDANCE WITH THOSE PROTOCOLS. STRICTLY ADHERE TO THE LIMITS OF THE CONSTRUCTION AREA, AND WHERE PHASING APPLIES, ADHERE TO PHASING PLAN. COORDINATE ANY WORK OUTSIDE THE CONSTRUCTION AREA WITH THE OWNER AND PERFORM IT IN ACCORDANCE WITH THE ICRA REPORT, UNDER THE SUPERVISION OF THE OWNER'S REPRESENTATIVE OR OTHER DESIGNATED ICRA COMMITTEE OFFICER.

2. TO THE EXTENT THAT IS REQUIRED BY THE ICRA, ENDEAVOR TO MAINTAIN EXISTING LEVELS OF INDOOR AIR QUALITY IN AREAS SURROUNDING AND ADJACENT TO THE CONSTRUCTION WORK ZONE, AND ELSEWHERE IN THE FACILITY. IT SHOULD BE ANTICIPATED THAT THE ICRA REPORT WILL REQUIRE MEASURES TO THIS EFFECT, INCLUDING THE ASSEMBLY OF THE CONSTRUCTION ZONE BARRIERS.

3. PERFORM CONSTRUCTION ACTIVITIES IN AREAS THAT ARE OCCUPIED BY THE HOSPITAL STAFF, THE GENERAL PUBLIC, OR HOSPITAL PATIENTS PER THE REQUIREMENTS OF THE OWNER'S ICRA. WHERE CONSTRUCTION ACTIVITIES HAVE BEEN COMPLETED, RETURN THE AREA TO "CLEAN" CONDITIONS, AS DEFINED BY THE OWNER'S PROTOCOLS, BEFORE IT IS OCCUPIED BY THE HOSPITAL STAFF, THE GENERAL PUBLIC, OR HOSPITAL PATIENTS.

REVISIONS TASK BY No. Date

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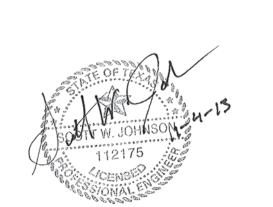
HARRIS HEALTH SYSTEM 2525 Holly Hall Street, Houston, Tx 77054

ARCHITECT & ENGINEERS:



Houston, TX 77042 (713) 784-8211 FAX: (713) 952-8655

www.ssr-inc.com TEXAS FIRM REGISTRATION NUMBER: F-2874 PROJECT # 13150540



Firm Registration #: PROJECT TITLE: SPRING BRANCH

HEALTH CENTER

PROJECT LOCATION:

9801 Long Point, Houston,

Tx 77055

SHEET TITLE:

NOTES - TELECOM

SHEET NUMBER:

A/V BACK BOX & CONDUIT REQUIREMENTS				
SYMBOL	BACK BOX AND PLASER RING SIZE	CONDUIT SIZE		
TV	4- 11/16" x 4- 11/16" x 2-1/4" BACK BOX WITH SINGLE GANG RING	1"		
TV_D	4- 11/16" x 4- 11/16" x 2-1/4" BACK BOX WITH SINGLE GANG RING	1"		
AV	COORDINATE EXACT BACK BOX AND CONDUIT REQUIREMENTS WITH ELECTRICAL DRAWINGS AND A/V VENDOR PRIOR TO INSTALLATION	2 - 1 1/4"		

PAGING SYSTEM BACK BOX & CONDUIT REQUIREMENTS


SYMBOL	BACK BOX AND PLASER RING SIZE	CONDUIT SIZE
PS	PAGING VENDOR PROVIDED SPEAKER ASSEMBLY	3/4"
NOTE:		

NURSE CALL BACK BOX & CONDUIT REQUIREMENTS


SYMBOL	BACK BOX AND PLASER RING SIZE	CONDUIT SIZE
(EP)	4" x 4" x 2 1/4" BACK BOX WITH SINGLE GANG RING	3/4"
D	4 11/16" x 4 11/16" x 2 1/4" BACK BOX WITH SINGLE GANG RING	3/4"
⟨Z⟩	4 11/16" x 4 11/16" x 2 1/4" BACK BOX WITH SINGLE GANG RING	3/4"
(NM)	4" x 4" x 2 1/4" BACK BOX WITH SINGLE GANG RING	3/4"

SECURITY BACK BOX & CONDUIT REQUIREMENTS


SYMBOL	BACK BOX AND PLASER RING SIZE	CONDUIT SIZE
CR	4- 11/16" x 4- 11/16" x 2-1/4" BACK BOX WITH SINGLE GANG RING	3/4"
DR	4- 11/16" x 4- 11/16" x 2-1/4" BACK BOX WITH SINGLE GANG RING	3/4"
DC	NO BACK BOX REQUIRED (DOOR PREPED BY OTHERS)	3/4"
\bigcirc	4" x 4" x 2-1/4" BACK BOX WITH SINGLE GANG RING	3/4"
РВ	BACK BOX AND-OR MOUNTING REQUIREMENTS AS SPECIFIED BY SECURITY VENDOR	3/4"
(ID)	4- 11/16" x 4- 11/16" x 2-1/4" BACK BOX WITH SINGLE GANG RING	3/4"
(IF)	BACK BOX AND-OR MOUNTING REQUIREMENTS AS SPECIFIED BY SECURITY VENDOR	3/4"

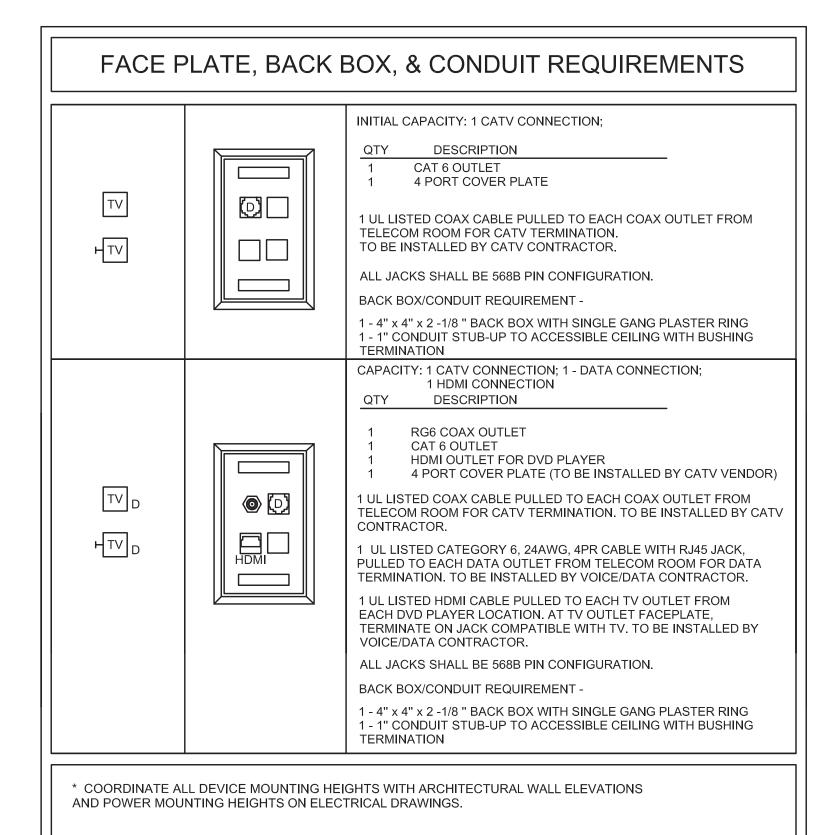



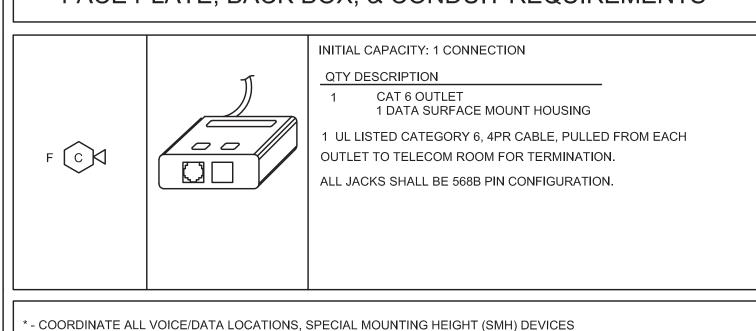

WITH ARCHITECTURAL WALL ELEVATIONS AND/OR MOUNTING HEIGHTS OF POWER DEVICES ON ELECTRICAL DRAWINGS. REFER TO "MOUNTING HEIGHT TO CENTER LINE", SHEET T0.1.

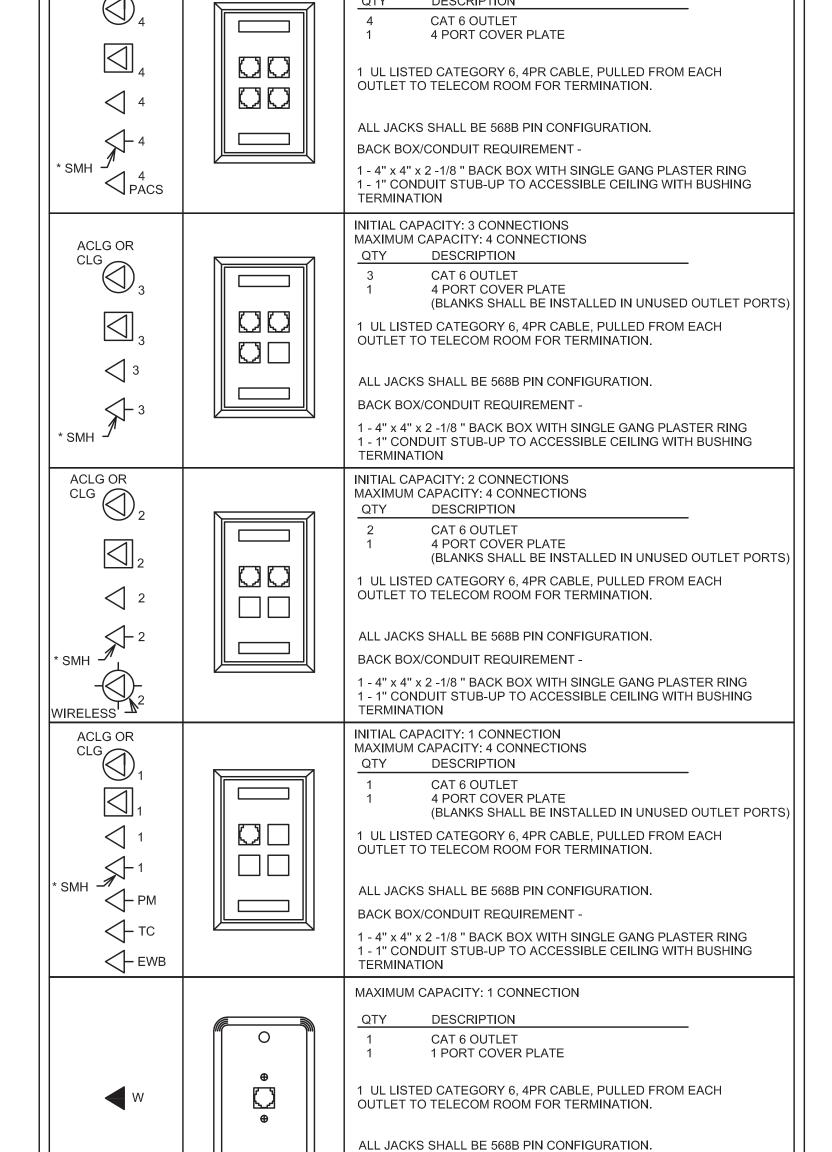

FACE PLATE, BACK BOX, & CONDUIT REQUIREMENTS

INITIAL CAPACITY: 4 CONNECTIONS

MAXIMUM CAPACITY: 4 CONNECTIONS




TERMINATION

* - COORDINATE ALL VOICE/DATA LOCATIONS, SPECIAL MOUNTING HEIGHT (SMH) DEVICES

WITH ARCHITECTURAL WALL ELEVATIONS AND/OR MOUNTING HEIGHTS OF POWER DEVICES

BACK BOX/CONDUIT REQUIREMENT -

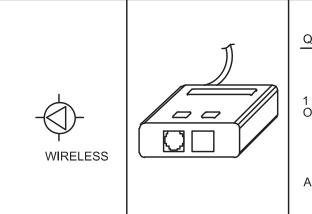

ON ELECTRICAL DRAWINGS.

STANDARD 630A

TYPE WALL JACK

QTY DESCRIPTION

1 CAT 6 OUTLET
1 DATA SURFACE MOUNT HOUSING


1 UL LISTED CATEGORY 6, 4PR CABLE, PULLED FROM EACH OUTLET TO TELECOM ROOM FOR TERMINATION.

1 - 4" x 4" x 2 -1/8 " BACK BOX WITH SINGLE GANG PLASTER RING

1 - 1" CONDUIT STUB-UP TO ACCESSIBLE CEILING WITH BUSHING

ALL JACKS SHALL BE 568B PIN CONFIGURATION.

* - COORDINATE ALL VOICE/DATA LOCATIONS, SPECIAL MOUNTING HEIGHT (SMH) DEVICES WITH ARCHITECTURAL WALL ELEVATIONS AND/OR MOUNTING HEIGHTS OF POWER DEVICES ON ELECTRICAL DRAWINGS.

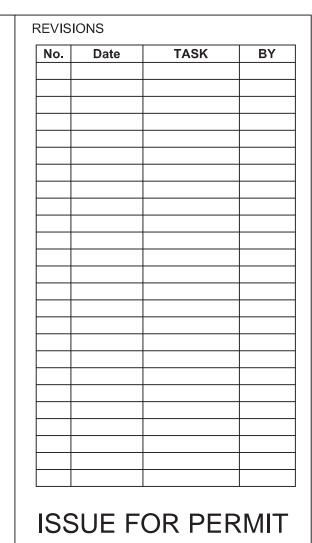

SUE FOR PERMIT & PRICING



2525 Holly Hall Street, Houston, Tx 77054

HARRIS HEALTH SYSTEM

ARCHITECT & ENGINEERS:



ARCHITECT:
Johnston, LLC

MEP:
Johnston, LLC

CIVIL:

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Houston, TX 77042 (713) 784-8211 FAX: (713) 952-8655 www.ssr-inc.com TEXAS FIRM REGISTRATION NUMBER: F-2874 PROJECT # 13150540

BOUTY W. JOHNSON 112175

Firm Registration #:

PROJECT TITLE:

SPRING BRANCH
HEALTH CENTER

PROJECT LOCATION:
9801 Long Point, Houston,
Tx 77055

SHEET TITLE:

FACEPLATE, BACKBOX, AND CONDUIT REQUIREMENTS -

DATE: 11/04/13 DATE:

SHEET NUMBER:


T-001

DRAWN BY:

CAP

CHECKED BY:

SCALE: 1/8" = 1'-0" JOB NO: 13150540

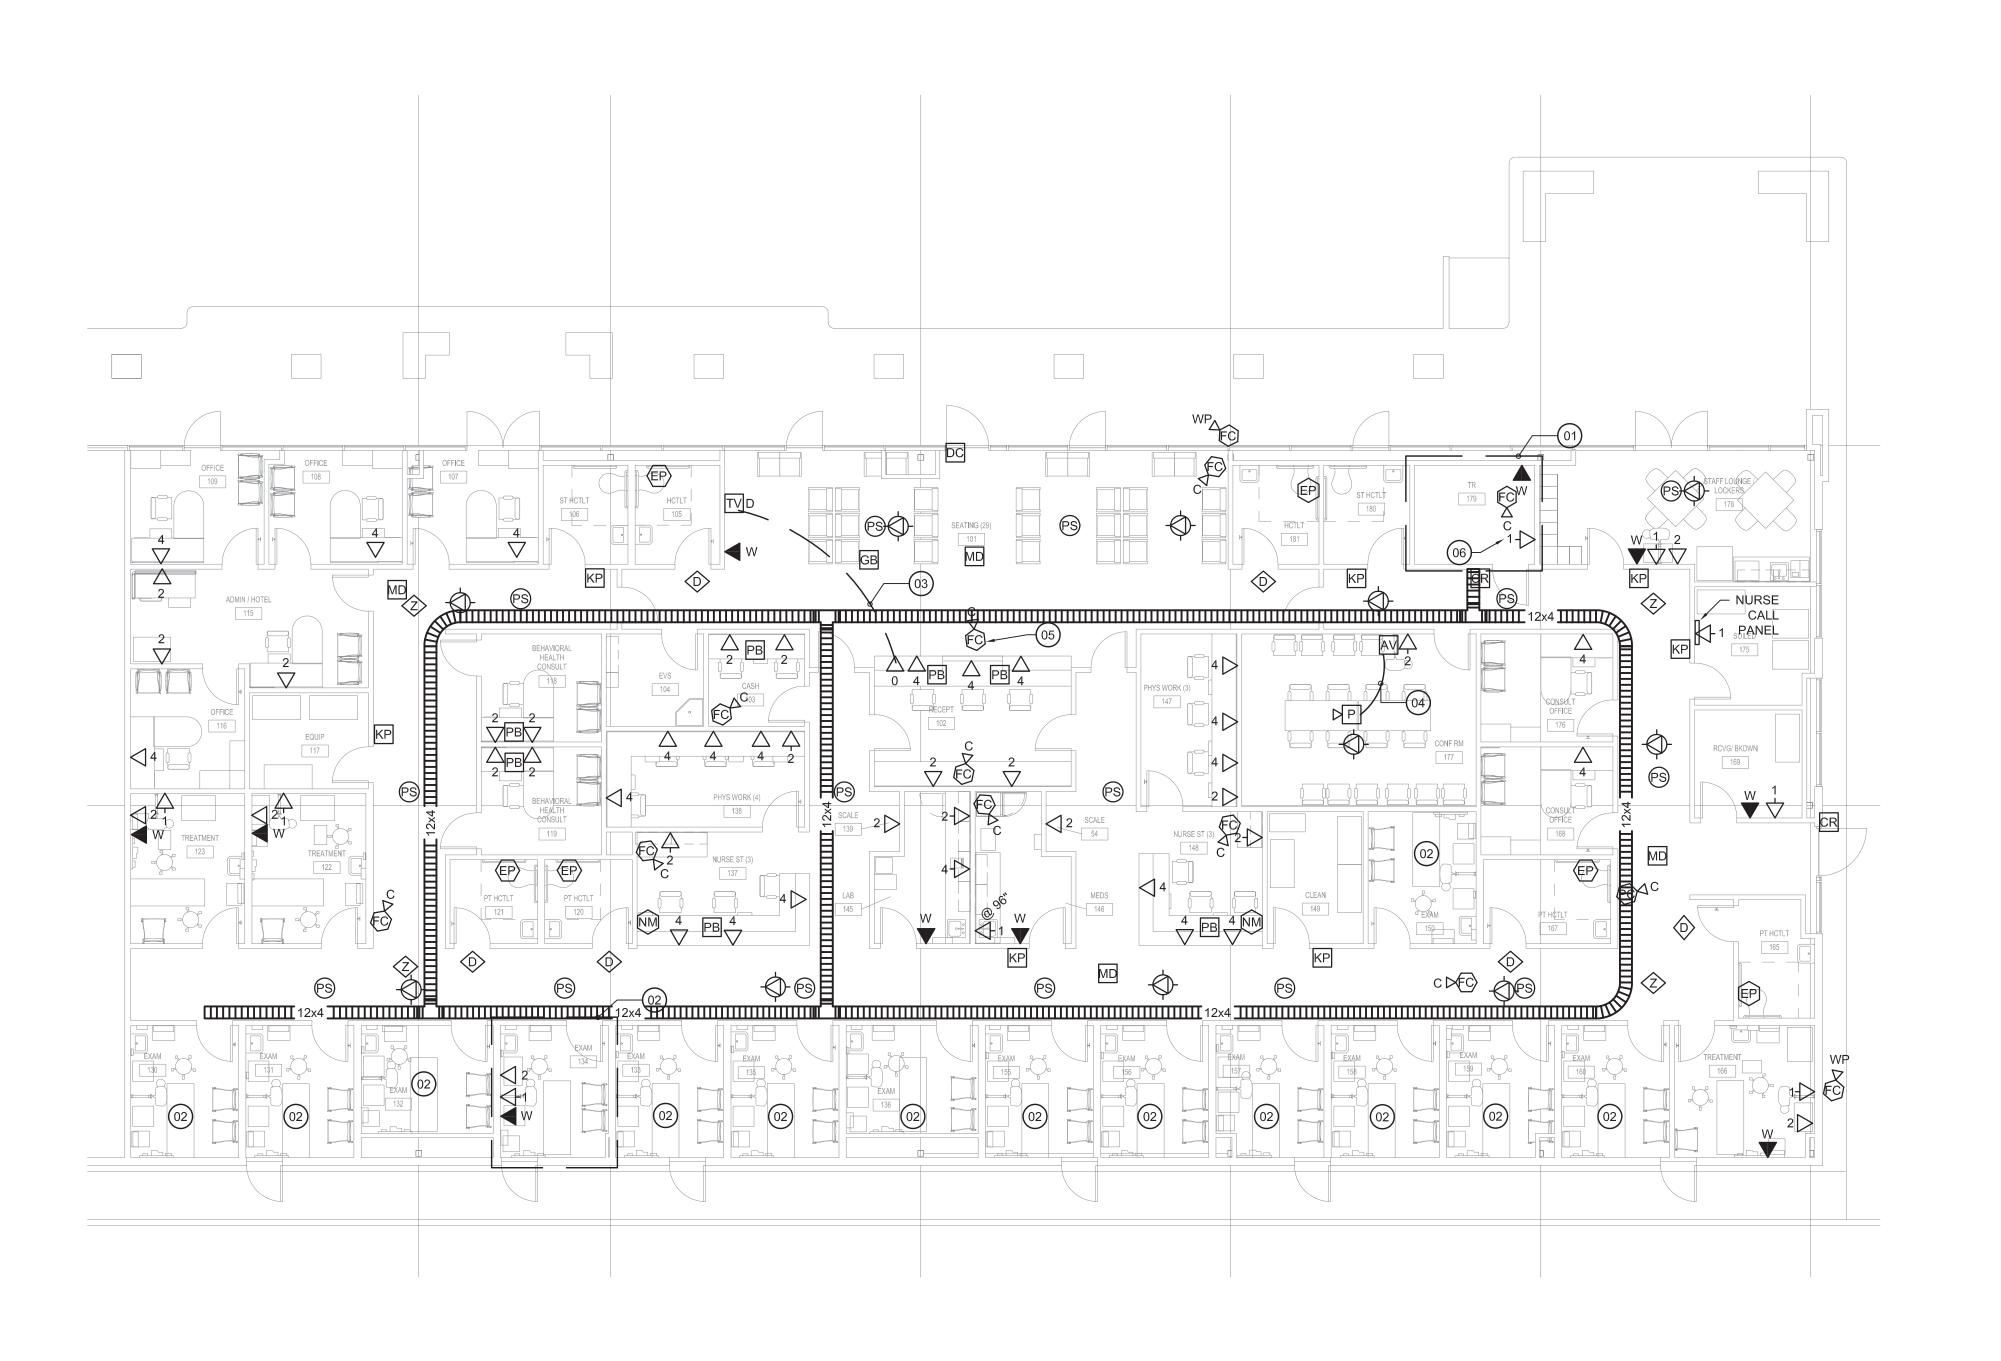


PLAN KEYED NOTES

- (01) TR ROOM. REFER TO SHEET T401 FOR DETAILS.
- (02) TYPICAL CONSULT/ EXAM ROOM.
- 03) 1-1/2" CONDUIT FOR (1) HDMI CABLE FOR CONNECTION FROM TV TO DVD PLAYER AND (1) RG6 AND (1) CAT6 FOR CONNECTION FROM TV TO RECEIVER.
- 04) PROVIDE (1) CAT 6 CABLE, (1) VGA CABLE, AND (1) 3.5MM CONNECTION BETWEEN OUTLET AND PROJECTOR.
- 05 CAMERA FOR IDENTIFICATION VIEW. MOUNT WHERE NECESSARY FOR REQUIRED VIEW.
- 06) PROVIDE (1) CAT6 CABLE FOR ACCESS CONTROL PANEL. REFER TO T401 FOR LOCATION.

GENERAL NOTES

- . CONTRACTOR MUST ALLOW FOR 6" CLEARANCE SURROUNDING WALL PHONE WALL PLATE.
- REFER TO ARCHITECTURAL ELEVATIONS FOR EXACT ELEVATIONS AND LOCATIONS OF ALL TECHNOLOGY DEVICES.
- 3. CABLE FOR WALL MOUNTED COMPUTERS SHALL BE MOUNTED AT 80" AFF TO
- 4. PROVIDE (1) CAT6 CABLE FOR JOHNSON CONTROL BAS PANEL. REFER TO MECHANICAL PLAN FOR LOCATION.
- 5. PROVIDE (1) CAT6 CABLE FOR ALARM PANEL PANEL. REFER TO ELECTRICAL PLAN FOR LOCATION.
- 6. ALL PANIC BUTTONS TO RING BACK TO HARRIS HEALTH DISPATCH CENTER THEN TO HOLLY HALL AS A BACKUP.
- ALL CABLE TRAY TRAVELING THROUGH FIRE RATED WALLS SHALL UTILIZE EZ PATH 44 SERIES.

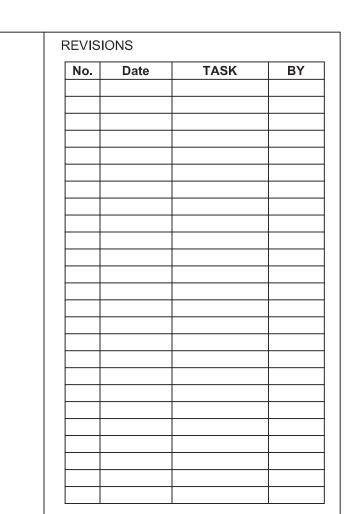

ISSUE FOR PERMIT & PRICING



HARRIS HEALTH SYSTEM 2525 Holly Hall Street,

Houston, Tx 77054

ARCHITECT & ENGINEERS:



3700 W. Sam Houston Pkwy. S., Suite 200 Houston, TX 77042 (713) 784-8211

FAX: (713) 952-8655 www.ssr-inc.com TEXAS FIRM REGISTRATION NUMBER: F-2874 PROJECT # 13150540



Firm Registration #:

SPRING BRANCH **HEALTH CENTER**

PROJECT LOCATION:
9801 Long Point, Houston,
Tx 77055

SHEET TITLE:

LEVEL 1 FLOOR PLAN -TELECOM

DATE: 11/04/13


SHEET NUMBER:


T-201

SCALE:

CHECKED BY:

1 Level 1 Telecom Floor Plan 1/8" = 1'-0"

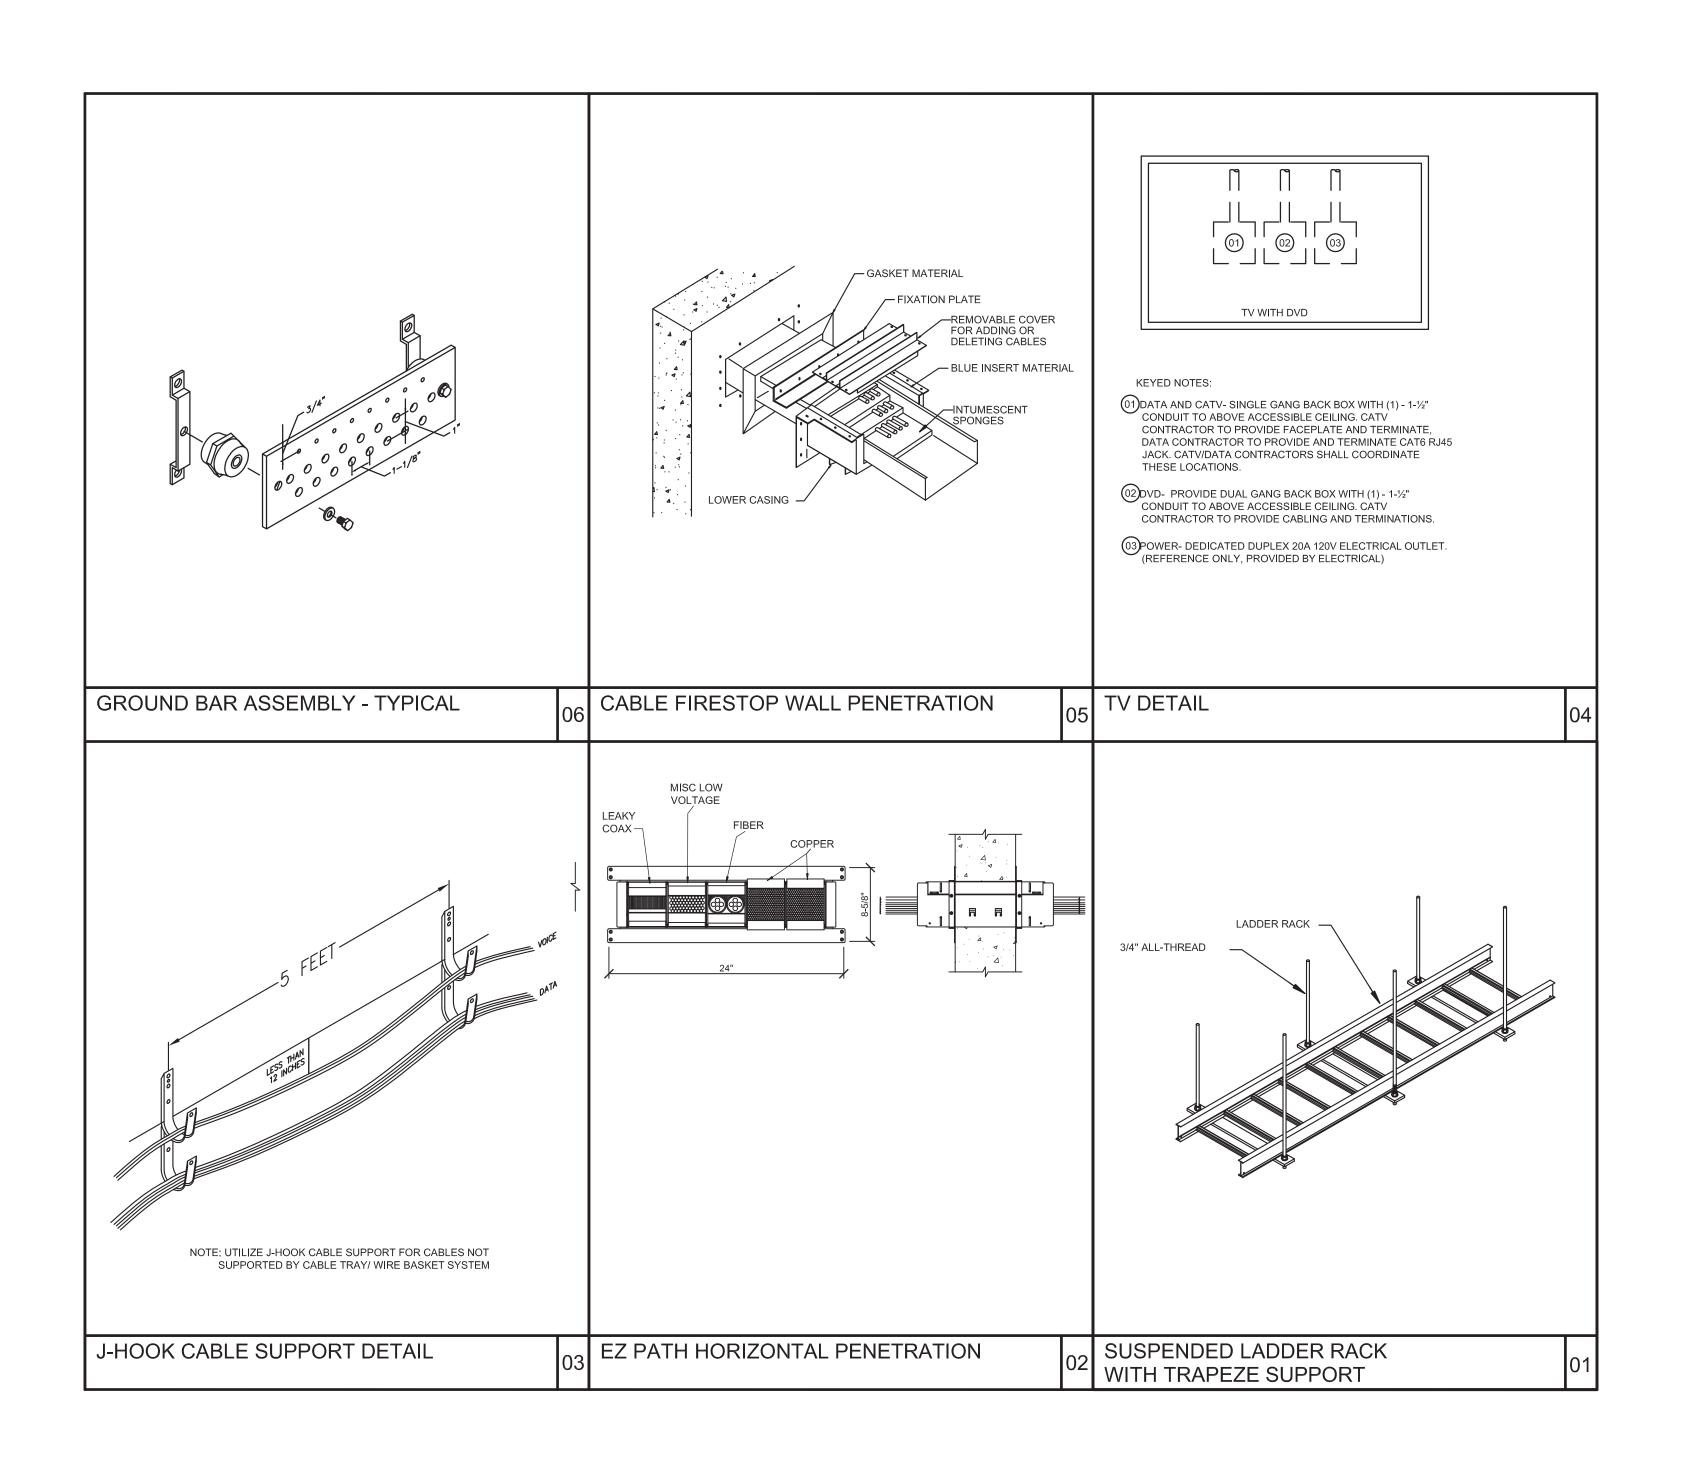

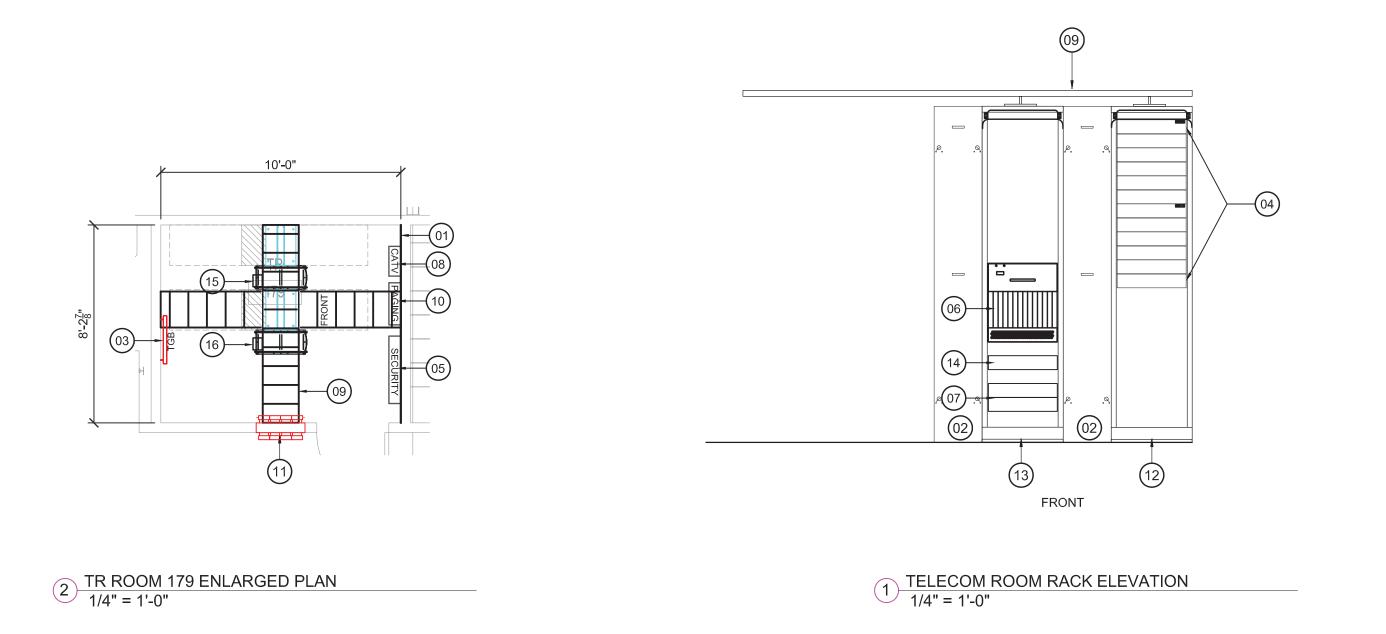

PLAN KEYED NOTES

- 01) 8' X 4' X 3/4"THICK, FIRE RETARDANT PLYWOOD, WITH (2) COATS OF BRIGHT WHITE FIRE RETARDANT PAINT. (1) FIRE RATED STAMP MUST REMAIN VISIBLE AT
- 02) 12" VERTICAL WIRE MANAGER.
- (03) SOLID COPPER TELECOM GROUNDING BUS BAR.
- (04) VISIPATCH 360 COPPER PATCH PANEL SYSTEM (TYPICAL).
- 05) ACCESS CONTROL PANEL.
- 06) CISCO SWITCH.(OFOI)
- 07) UPS
- (08) CATV/MATV SYSTEM IDF EQUIPMENT.
- 09) 18" WIDE LADDER RACK MOUNTED AT 90" AFF.(TYPICAL)
- 10) PAGING EQUIPMENT. (11) EZ PATH 44 SERIES.
- (12) IT CABLING TERMINATION RACK.
- (13) NETWORK EQUIPMENT RACK.
- (14) SECURITY NVR.
- (1) 110V/20A DUPLEX OUTLET AND (2) L6-30R OUTLETS MOUNTED TO SIDE OF LADDER RACK. FOR REFERENCE ONLY. REFER TO ELECTRICAL.
- (2) L5-30R OUTLETS MOUNTED TO SIDE OF LADDER RACK. FOR REFERENCE ONLY. REFER TO ELECTRICAL.

GENERAL NOTES

- PROVIDE RACK ISOLATION KIT FOR ALL 19" RACKS.
- PROVIDE INSULATOR BAR KIT FOR ALL LADDER RACK.
- PROVIDE AND INSTALL CABLE RUNWAY ELEVATION KIT FOR LADDER RACK ABOVE EACH RACK..
- PROVIDE AND INSTALL WATERFALL CABLE SUPPORTS FOR CABLE TRANSITION FROM LADDER RACK TO EACH EQUIPMENT RACK.

REVISIONS TASK BY

ISSUE FOR PERMIT & PRICING



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Firm Registration #:

SPRING BRANCH **HEALTH CENTER**

PROJECT LOCATION: 9801 Long Point, Houston, Tx 77055

ENLARGED PLANS AND **ELEVATIONS - TELECOM**

DATE: 11/04/13

SHEET NUMBER:

T-401

SCALE: DRAWN BY: 1/8" = 1'-0" CHECKED BY:

JOB NO: 13150540