MAINTENANCE AND REPAIRS.

IN FINISHED AREAS, UON, CONCEAL PIPES, DUCTS, AND WIRING WITHIN THE CONSTRUCTION. COORDINATE LOCATIONS OF FIXTURES AND OUTLETS WITH FINISH ELEMENTS.

TRANSPORT AND HANDLE PRODUCTS IN ACCORDANCE W/ MFR

PROMPTLY INSPECT SHIPMENTS TO ASSURE THAT PRODUCTS

COMPLY W/ REQUIREMENTS, QUANTITIES ARE CORRECT, AND PRODUCTS ARE UNDAMAGED. SHOULD MFR INSTRUCTIONS CONFLICT W/ THE DWGS, REQUEST

CLARIFICATION FROM ARCHITECT/ENGINEER BEFORE ALL THRESHOLDS SHALL COMPLY WITH FLORIDA

ACCESSIBILITY CODE, 40425 AS FOLLOWS: THRESHOLDS AT DOORWAYS SHALL NOT EXCEED 1/2 B. EXISTING OR ALTERED THRESHOLDS 3/4" MAX WITH A BEVELED EDGE ON EACH SIDE & A SLOPE NO STEEPER THAN 1:2 SHALL NOT BE REQUIRED TO COMPLY WITH 40425

G.C. SHALL FURNISH AND INSTALL CONT. WOOD BLOCK'G IN STUD PARTITIONS FOR ANCHORAGE OF WALL ATTACHED ITEMS, INCLUDING BUT NOT LIMITED TO THE FOLLOWING: GRAB BARS, TOILET ACCESSORIES, HANDRAIL BRACKETS, WALL CABINETS, WALL-MOUNTED FIXTURES ETC.

THE OWNER SHALL BE RESPONSIBLE FOR PROVIDING THE CONTRACTOR W/ ROUGH-IN INFO. NECESSARY TO ACCOMMODATE THE INSTALLATIONS OF OWNER FURNISHED AND INSTALLED ITEMS.

THE CONTRACTOR SHALL INCLUDE ALL OWNER FURNISHED AND INSTALLED ITEMS IN THE CONSTRUCTION SCHEDULE, AND SHALL COORDINATE W/ THE OWNER TO ACCOMMODATE THESE

COORDINATE ALL DEMOLITION EFFORTS W/ THE OWNER EVERY EFFORT SHALL BE MADE TO MINIMIZE DISRUPTION OF OPERATION AND TO PROVIDE PATRON SAFETY. EXCESSIVE NOISE OR VIBRATION SHALL BE PRE-APPROVED AND COORDINATED WITHE OWNER.

COORDINATE W/ THE OWNER THE PRE-APPROVED DISRUPTION AND VERIFICATION OF SERVICE WITHIN THE EXISTING BUILDING SO AS TO MINIMIZE THE DISPUPTION OF SERVICE.

CONSTRUCT TEMPORARY CONSTRUCTION PARTITIONS WITHIN THE EXISTING BUILDING WHICH OFFER AN ENCLOSURE TO ISOLATE ANY DEMOLITION/ CONSTRUCTION WORK FROM THE GENERAL PUBLIC AND AS DEEMED NECESSARY BY THE

BUILDING CODE SUMMARY BUILDING DATA : OCCUPANCY: ☐ ASSEMBLY ☐ BUSINESS ☐ EDUCATIONAL ☐ FACTORY ☐ HIGH HAZARD ☐ INSTITUTIONAL ☐ MERCANTILE ☐ RESIDENTIAL ☐ STORAGE ☐ UTILITY/MISC ☐ DAY CARE M - FURNITURE SALES USE CONDITION VACANT SHELL CHANGE OF OCCUPANCY: ☐ YES ☐ YES OCCUPANCY CONSTRUCTION □ IA □ IB SEPERATION □ IIA ☑ IIIB MIXED ☐ YES CONSTRUCTION: □ VB ☐ VA ⊠ NO SPRINKLED: ☐ YES (13 13R 13D): ☐ PRESCRIPTIVE ☑ WORK AREA ☐ PERFORMANCE COMPLIANCE METHOD: \(\Backslash\) N/A LEVEL OF ALTERATION: \(\square\) N/A LIFE SAFETY SYSTEM: EMER. LIGHTING & EXIT SIGNAGE ⊠ NO FIRE ALARM & SMOKE DETECT. SYSTEM _ YES

APPLICABLE CODES

2017 FLORIDA BUILDING CODE - ENERGY

2017 FLORIDA BUILDING CODE - TEST PROTOCOL

6TH EDITION 2017 FLORIDA BUILDING CODE - RESIDENTIAL

6TH EDITION 2017 FLORIDA BUILDING CODE - BUILDING

6TH EDITION 2017 FLORIDA BUILDING CODE - PLUMBING

6TH EDITION 2017 FLORIDA BUILDING CODE - FUEL GAS

FAIR HOUSING GUIDELINES

DESIGNED IN ACCORDANCE WITH THE 6TH EDITION FLORIDA

BUILDING CODE 2017, SECTION 1609 FOR DESIGN PRESSURES.

6TH EDITION 2017 FLORIDA FIRE PREVENTION CODE

CITY OF ST. PETERSBURG BUILDING DEPARTMENT

6TH EDITION 2017 FLORIDA BUILDING CODE - ACCESSIBILITY

6TH EDITION 2017 FLORIDA BUILDING CODE - MECHANICAL

6TH EDITION 2017 FLORIDA BUILDING CODE - EXISTING BUILDING

NATIONAL ELECTRIC CODE - NFPA 10

PANIC HARDWARE

NEC 2014

PERMITTING AGENCY:

SECTION OR DETAIL KEY

SECTION NO.

FACE BRICK

CONCRETE

PLYWOOD

ELEVATION

SECTION CUT

- SHEET NUMBER

PARTITION TYPE

ELEVATION SYMBOL

LEVATION NUMBER

NORTH ARROW

OR MAGNETIC NORTH.

(XXX) DOOR TYPE SYMBOL

PLAN SYMBOL & MATERIAL INDICATIONS

EXXXXX CONCRETE BLOCK - C.M.U.

MITERIOR FRAME WALL

DASSAS WASHED GRAVEL

GYPSUMBOARD

RIGID INSULATION

BLANKET INSULATION

DIMENSIONAL LUMBER

WIIIII METAL - LARGE SCALE

INSULATING SHEATHING

METAL IN ELEVATION

PLYWOOD

ACOUSTIC PANELS

FACE BRICK

CONCRETE

WINDOW TYPE SYMBOL

ELEGATION UNDISTURBED SOIL OR COMPACTED FILL

NOTE THAT NORTH ARROWS SHOWN IN

THESE DRAWINGS IS FOR "REFERENCE"

REVISION CLOUD:

- AREA REVISED

- REVISION *

ONLY AND DO NOT REPRESENT TRUE

 \otimes

□ N/A

□ N/A

 \square NO

CONSTRUCTION DOCUMENTS FOR:

MATTHEW COMMERICAL 200 16TH STREET N ST. PETERSBURG, FL

EXIT REQUIREMENTS:

ALL EXIT DOORS THAT REQUIRE PANIC HARDWARE WILL MEET THE CRITERIA OF NFPA 101 12.1.1

PER NFPA 101 12.15, DOORS SHALL BE ARRANGED TO BE OPENED READILY FROM THE EGRESS SIDE WHENEVER THE BUILDING IS OCCUPIED.

FLORIDA FIRE PREVENTION CODES:

ALL CONSTRUCTION MUST MEET THE REQUIREMENTS OF NFPA 241, 2013 STANDARD OF SAFEGUARDING CONSTRUCTION, ALTERATION, AND DEMOLITION

ALL CONSTRUCTION MUST COMPLY WITH 2017, 6TH EDITION FLORIDA FIRE PREVENTION CODE (NFPA 1 AND NFPA 101).

ALL CONSTRUCTION MUST MEET THE CONDITIONS OF

NFPA-101 2015 CHAPTER 10, INTERIOR FINISH, CONTENTS, AND FURNISHINGS MUST MEET THE REQUIREMENTS OF NFPA-10 2013

EDITION AND NFPA 101, SECTION 9.9, PORTABLE FIRE

ALL FIRE EXTINGUISHERS MUST BE CERTIFIED BY FIRE EXTINGUISHER COMPANY.

375 4th Ave N 4th Ave N 00 16th Street North 7 min walk - work



OCCUPANCY SQUARE FOOTAGE (NET): TOTAL SOFT FURNITURE SALES (MERCANTILE)

EXIT REQUIREMENTS 6 x Ø2" = 12"

TOTAL NUMBER OF EXITS PROVIDED

TOTAL EXIT WIDTH REQUIRED 34 x Ø2" = 6.8" TOTAL EXIT WIDTH PROVIDED (1)6'-0" = 72"TOTAL NUMBER OF EXITS REQUIRED TOTAL NUMBER OF EXITS PROVIDED MAX TRAVEL DISTANCE 75'-0" FIXTURE COUNT SUMMARY:

NUMBER OF FIXTURES REQUIRED:

NUMBER OF FIXTURES PROVIDED:

06 (PER GENDER)

OCCUPANCY SQUARE FOOTAGE (NET): TOTAL SOFT FURNITURE SALES (MERCANTILE) TOTAL SQFT VANILLA SHELL (MERCANTILE)

TOTAL EXIT WIDTH REQUIRED

67 x Ø.2" = 13.4" (1) 6'-0" = 72"

PROJECT RECORD ISSUE DATE: REVISION DATE REMARKS Ø7/23/19 REV-I CITY COMMENTS 08/06/19 REV-2 CITY COMMENTS

ISSUE DATE

REY.

REY.

REY.

REY.

REY.

REY.

REVIEW | 05/21/19 MF

REY. 1 07/23/19 MF

Ø5/21/19 MF

PROJECT SUMMARY

THIS PROJECT CONSISTS OF:

- DEMOLITION OF INTERIOR WALLS, DOORS, ₹ PLUMBING FIXTURES, AS SHOWN ON PLANS - CONSTRUCTION OF NEW DEMISING WALLS, RESTROOMS, WINDOWS & YANILLA SHELL AS SHOWN ON PLAN. STOREFRONT WINDOWS BEING

REPLACED AS WELL AS WINDOW NOTED ON PLANS.

SHEET INDEX

ARCHITECTURAL
A-1 COVER/ GENERAL NOTES/ VICINITY MAP

LS-I LIFE SAFETY PLAN A-2 DEMOLITION PLAN

A-3 RENO PLAN, DOOR & WINDOW SCHED, & PARTITION TYPES A-4 UL U301 & U419 2 HOUR FIRE RATED WALL DETAILS

A-5 REFLECTED CEILING PLAN & RESTROOM DETAILS A-6 ELEVATIONS

A-1 RESTROOM DETAIL & ROOF PLAN

M-1 MECHANICAL PLAN

E-I ELECTRICAL COVER SHEET

E-2 ELECTRICAL POWER FLOOR PLAN E-3 ELECTRICAL POWER FLOOR PLAN

E-4 RISER PARTIAL & CIRCUIT SCHEDULE E-5 ELECTRICAL SPECIFICATIONS

P-I PLUMBING COVER SHEET P-2 WATER HEATER PLAN, FIXTURE & GAS SCHEDULES

> PROFESSIONAL SEAL AR0014705 ORA FRANKLIN FRAZE, IV

MMERIC

TTHE

UR

ST

M/A 200 ST.

WIND TABLE

ALL EXTERIOR WINDOWS & GLASS DOORS ARE REQUIRED TO BE TESTED IN ACCORDANCE WITH ANSI/AMMA/NUWDA 101/152 STANDARD & BEAR AN AMMA OR WOMA LABEL IDENTIFYING THE MANUFACTURER, PERFORMANCE CHARACTERISTICS & APPROVED PRODUCT TESTING ENTITY.

ALL WINDOWS & WALK DOORS SHALL HAVE MINIMUM DESIGN PRESSURES OF +42.6 /-51.0 PSF

ALL GARAGE DOORS SHALL HAVE MINIMUM DESIGN PRESSURES OF +38.1 /-48.0 PSF

<u>145 MPH</u>

<u>115 MPH</u>

<u>+/- Ø.18</u>

<u>- 133.4 PSF</u>

WIND DESIGN METHOD = ALTERNATE ALL HGT METHOD ULTIMATE WIND SPEED (3 SEC WIND GUST)

NOMINAL WIND SPEED WIND IMPORTANCE FACTOR RISK CATEGORY OF STRUCTURE WIND EXPOSURE WIND ENCLOSURE COEFFICIENT (ENCLOSED)

DESIGN CLADDING PRESSURE FOR WALL/ROOF ZONES I THRU 5 PER ASCE 1.

COMPONENTS & CLADDING

910 SQFT <u> 124,5 / -82,2 PSF</u> 920 SQFT <u>+22.4 / -75.6 PSF</u> 950 SQFT <u>+19,5 / -54,3 PSF</u> +17.4 / -57.0 PSI @100 SQFT 910 SQFT <u>+42.6 / -57.0 PSF</u> 920 SQFT <u>+406 / -532 PSF</u> <u>+38.1 / -48.0 PSF</u> +36.3 / -44.2 PSF **050 SQFT** 9100 SQFT

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ALL DIMENSIONS AND JOB CONDITIONS SHALL BE VERIFIED BY THE CONTRACTOR, ANY AND ALL DISCREPANCIES SHALL BE REPORTED TO THE ARCHITECT PRIOR TO COMMENCEMENT OF CONSTRUCTION.

SHEET TITLE

COVER, <u>SPECIFICATIONS,</u> **\$ VICINITY MAP**

SHEET NUMBER

ABBREVIATIONS: MODIFIED MOUNT(ED) (IN MOUNTING ABOVE FINISH FLOOR METAL MULLION MILLWORK ACCESS FLOORING ACOUSTICAL CEILING TILE AREA DRAIN ADDENDUM ADJACENT ADJUSTABLE NOT APPLICABLE NOT REQUIRED NOT IN CONTRACT ADJUSTABLE AIR HANDLING UNIT ALTERNATE ALUTINIM ANODIZED ACCESS PANEL APPROXIMATE ARCHITECT(URE) (URAL. ASPHALT AUTOMATIC AUXILIARY AVERAGE AUNING NOMINAL NOISE REDUCTION COEFFICIENT NOT TO SCALE ON CENTER OUTSIDE DIAMETER OPPOSITE HAND OPENING OPPOSITE BOARD BI-FOLD BELOW FINISHED FLOOR BITUMINOUS BOLLARD BUILDING BLOCKING BELOW BEAM/BENCHMARK PEDASTAL/STAND PROPERTY LINE PLASTIC LAMINATE PLASTIC PLYWOOD PANEL PAINT BENCH BRICK BEARING BRACKET BOTH SIDES BOTTOM PARTITION POUNDS PER SQUARE INCH BETWEEN BUILT-UP ROOF PRESSURE TREATED PAPER TOWEL DISPENSER/DISPOSAL CERAMIC CORNER GUARD RETURN AIR RESILIENT BASE CAST IRON CONTROL JOINT REINFORCED CONCRETE PIPE RECEIVING REFER / REFERENCE REFRIGERATION / REFRIGERATOR REINFORCE(D) (ING) RESILIENT REVISION CONNECT(ION) CONTINUOUS RIGID GALYANIZED STEE CONTRACTOR CONST CONSTRUCTION CERAMIC TILE / COUNTER TOP DIRECT APPLIED SYNTHETIC STUCCO DOUBLE DEMOLITION DEPARTMENT SOUTHERN YELLOW PINE DETAIL DRINKING FOUNTAIN SUPPLY AIR SOUND ATTENUATION BLANKET DIAMETER DIMENSION DISPENSER DIVISION DOWN DOOR SLIDING GLASS DOOR EXTERIOR INSULATION FINISH SYSTEM EXPANSION JOINT SIMILAR - OPPOSITE HAND ELECTRIC ELEVATOR EMERGENCY ENCLOSURE ELASTOMERIC PAIN STRUCTURAL/STRUCTURE SUSPENDED SW SWITCH EXPOSED/ EXPANSION EXISTING EXTERIOR TONGUE & GROOVE FABRICATION FACE OF BRICK FILE CABRICT FILE CABRICT FLOOR DRAIN FOUNDATION FIRE EXTINGUISHER FIRE EXTINGUISHER CABINE FINISHED FLOOR TELEPHONE TEMPERATURE / TEMPERED TERRAZZO THICK(NESS) THRESHOLD TOOLED JOINT TOP OF SLAB FLOOR MOUNTED FLUORESCENT TOP OF STEEL TOILET PAPER DISPENSER FINISHED OPENIN FACE OF BLOCK FACE OF STUD FIREPROOF(ING) FRAME FULL SIZE FEET/FOOT FOOTING FUTURE UNDERWRITER'S LABORATORY UNLESS OTHERWISE NOTED VERIFY IN FIELD VENEER GROSS SQUARE FOOTAGE GYPSUM WALLBOARD GYPSUM WOOD BASE HANDICAP HOLLOW CORE HARDWARE HARDWOOD HEIGHT HOLLOW METAL WOOD/ WOOD VENEER WEIGHT WATER HEATER/ HYDRAN WROUGHT IRON WALK-IN CLOSET WINDOW WALL BUMPER WALLPAPER WIRE MESH HEATING HEATING, VENTILATING & AIR CONDITIONING INSIDE DIAMETER/ INSIDE DIMENSION INCANDESCENT INCLUDE(D) (ING) INFORMATION INSULATION INTERIOR INVERT IRON PIPE SIZE JUNCTION BOX

JANITOR CLOSET JOIST JOINT

KNOCKOUT KICK PLATE


LAVATORY
POUND
LABEL
LINEAR FOOT/FEET

LIGHTWEIGH1

MATERIAL MAXIMUM MEDICINE CABINET

MECHANICAL
MANUFACTURER
MIDDLE
MINIMUM
MINUTES
MISCELLANEOUS

LEFT HAND REVERSE

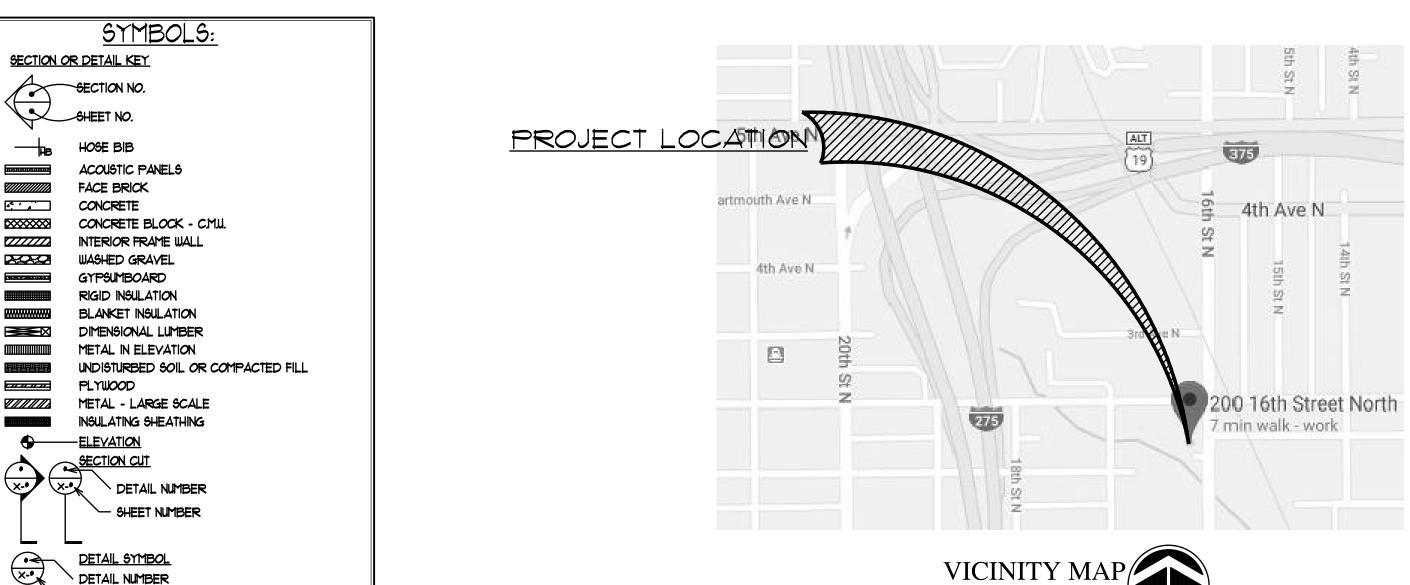

OCCUPANT LOAD BUILDING CODE SQUARE FOOTAGE CALCULATIONS: TOTAL SQUARE FOOTAGE OF BUILDING (GROSS) 3600 SQFT

1,104 SQ. FT. / 60 = 19 PERSONS 2,004 SQ. FT. / 60 = 34 PERSONS TOTAL SQFT VANILLA SHELL (MERCANTILE) TOTAL OCCUPANT LOAD (BUILDING CODE) 53 PEOPLE

TOTAL EXIT WIDTH REQUIRED TOTAL EXIT WIDTH PROVIDED (1) 3'-0" = 36" TOTAL NUMBER OF EXITS REQUIRED

MAX TRAVEL DISTANCE EXIT REQUIREMENT (VANILLA SHELL)

TOTAL NUMBER OF OCCUPANTS:

2 (PER GENDER)

OCCUPANT LOAD FIRE CODE SQUARE FOOTAGE CALCULATIONS: TOTAL SQUARE FOOTAGE OF BUILDING (GROSS) 3600 SQFT

1,104 SQ. FT. / 30 = 37 PERSONS 2,004 SQ. FT. / 30 = 61 PERSONS TOTAL OCCUPANT LOAD (BUILDING CODE) 104 PERSONS


EXIT REQUIREMENTS $11 \times \emptyset.2$ " = 2.2"

TOTAL EXIT WIDTH PROVIDED TOTAL NUMBER OF EXITS REQUIRED TOTAL NUMBER OF EXITS PROVIDED


EXIT REQUIREMENT (VANILLA SHELL

(1) 3'-Ø" = 36"

TOTAL EXIT WIDTH REQUIRED TOTAL EXIT WIDTH PROVIDED TOTAL NUMBER OF EXITS REQUIRED TOTAL NUMBER OF EXITS PROVIDED

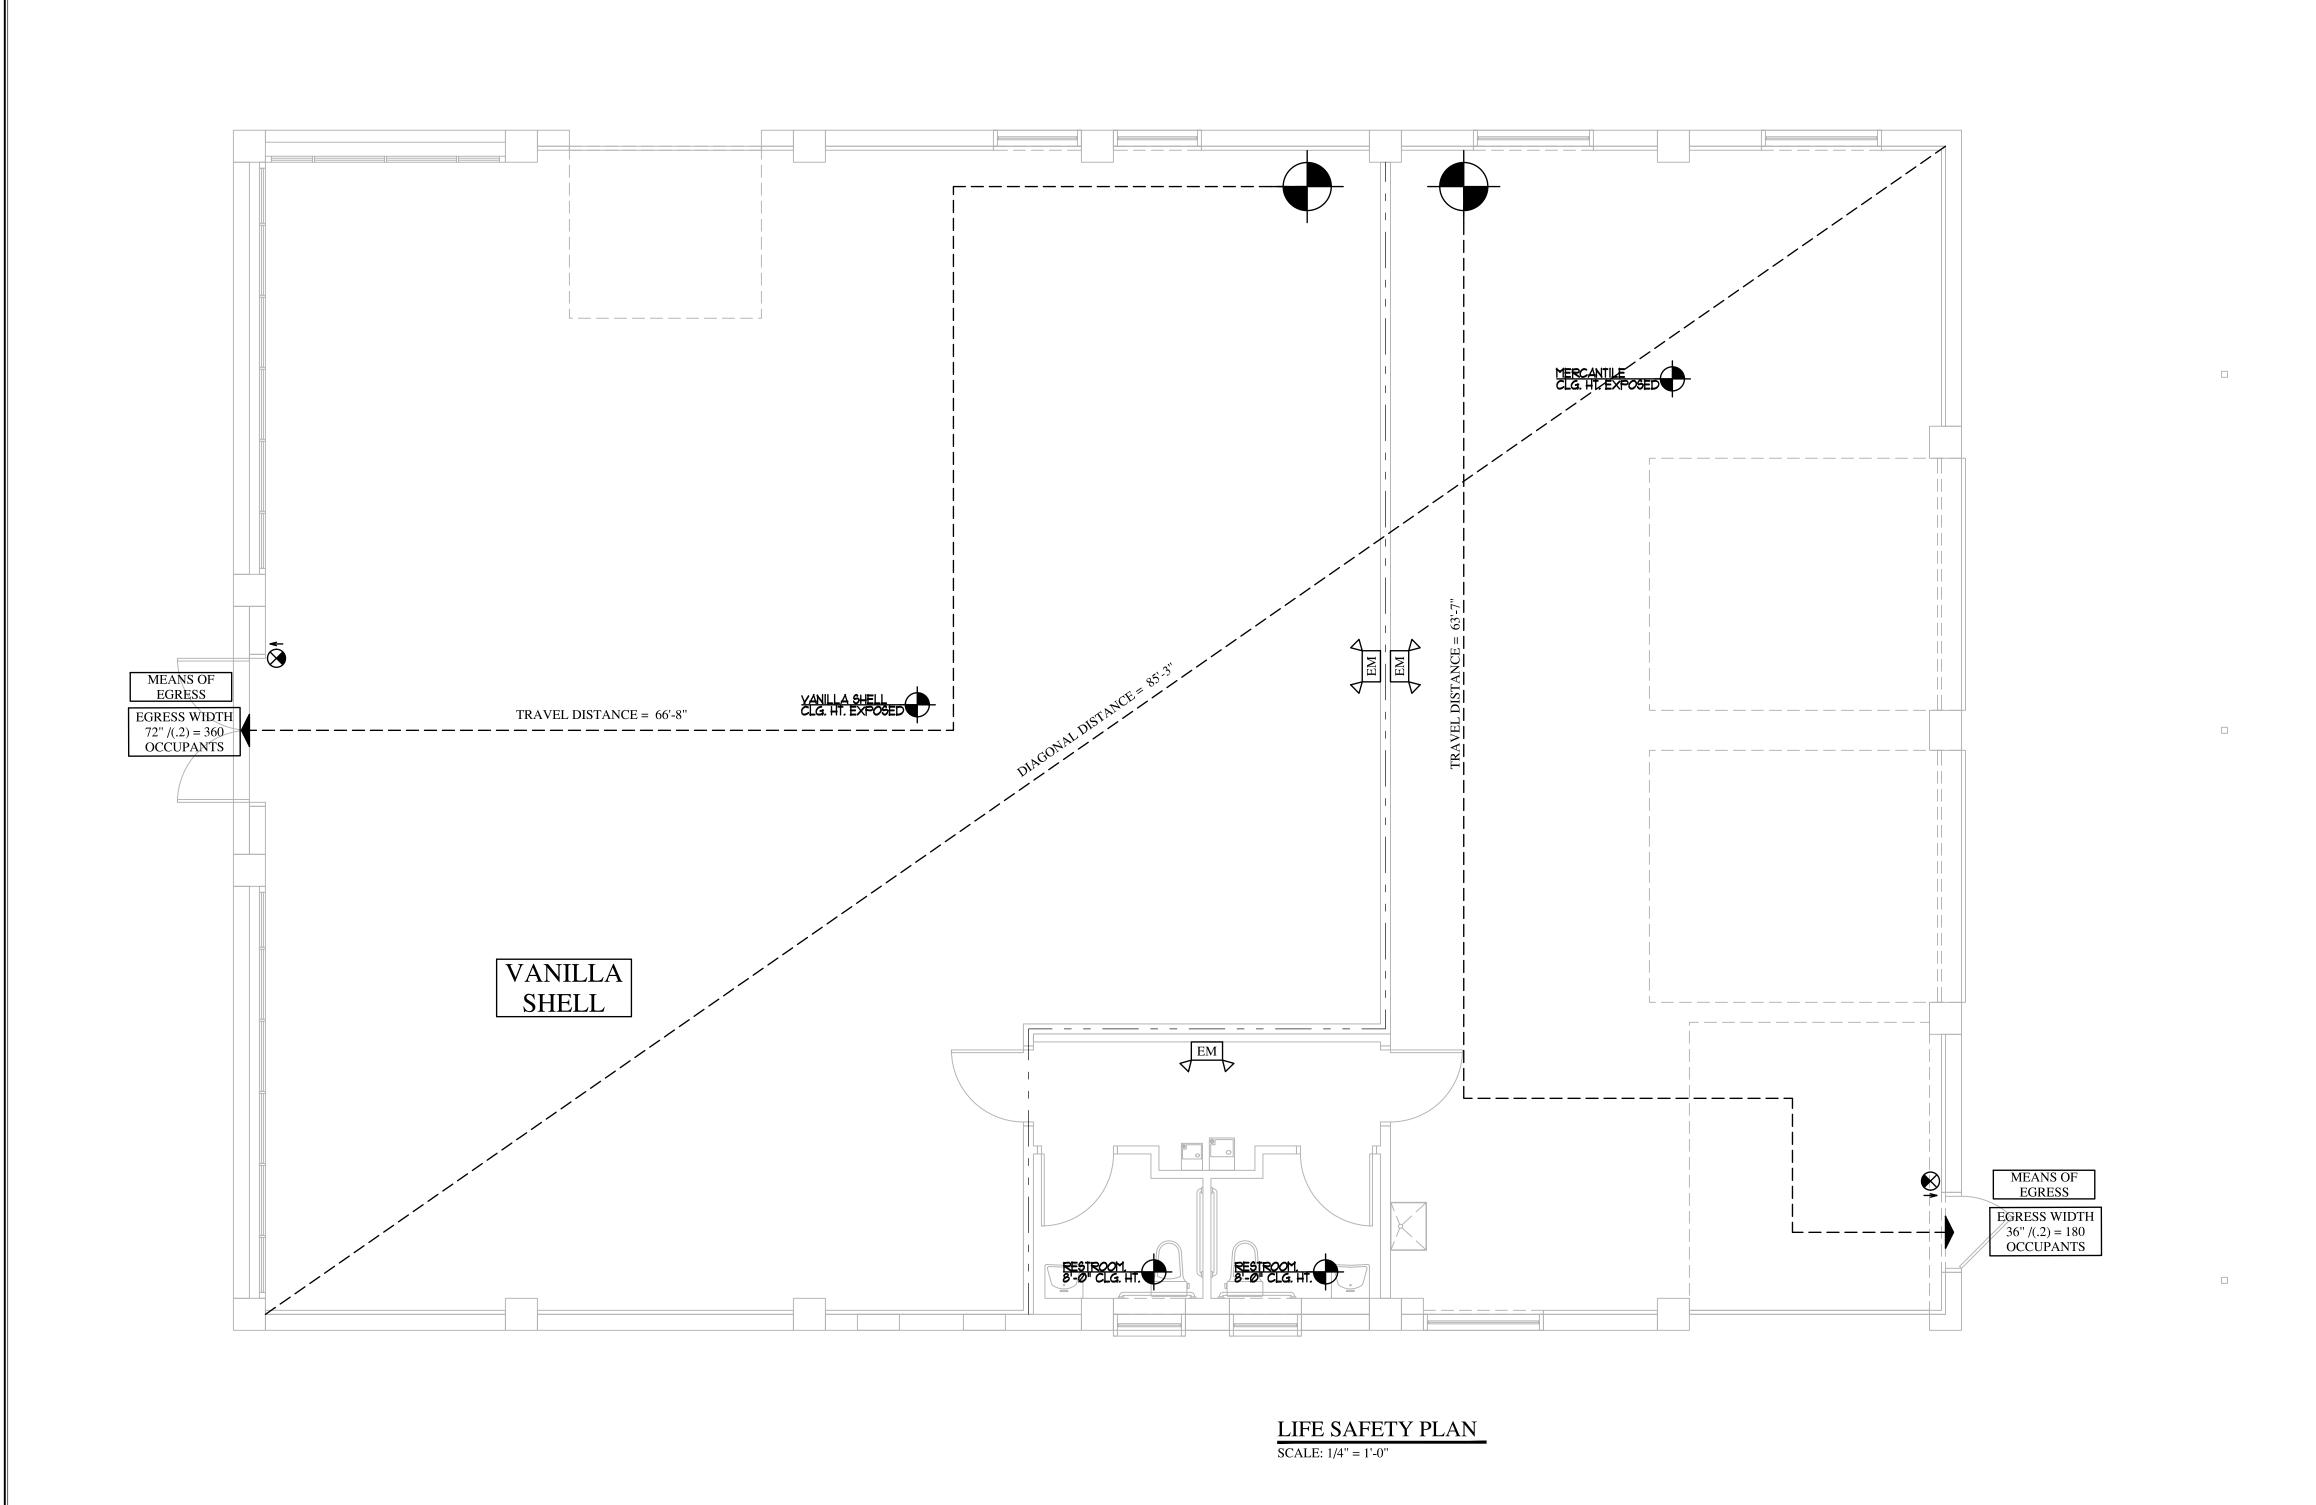

PERMIT Ø5/21/19 MF REV. 1 Ø1/23/19 MF REY.

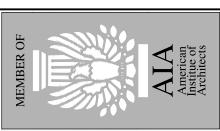

PROFESSIONAL SEAL



SHEET TITLE LIFE SAFETY PLAN

SHEET NUMBER


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ALL DIMENSIONS AND JOB CONDITIONS SHALL BE VERIFIED BY THE CONTRACTOR, ANY AND ALL DISCREPANCIES SHALL BE REPORTED TO THE ARCHITECT PRIOR TO COMMENCEMENT OF CONSTRUCTION.



DEMOLITION NOTES:


- IN COMPANY WITH THE OWNER, VISIT THE SITE AND VERIFY THE EXTENT AND LOCATION OF SELECTIVE DEMOLITION REQUIRED.
- 1.1. CAREFULLY IDENTIFY LIMITS OF SELECTIVE DEMOLITION.
- 12. MARK INTERFACE SURFACES AS REQUIRED TO ENABLE WORKMEN ALSO TO IDENTIFY ITEMS TO BE REMOVED AND ITEMS TO BE LEFT IN PLACE.
- SHUT OFF, CAP, AND OTHERWISE PROTECT EXISTING PUBLIC UTILITY LINES IN ACCORDANCE WITH THE REQUIREMENTS OF THE PUBLIC AGENCY OR UTILITY HAYING JURISDICTION.
- COMPLETELY REMOVE ITEMS SCHEDULED TO BE SO DEMOLISHED AND REMOVED, LEAVING SURFACES CLEAN, SOLID, AND READY TO RECEIVE NEW MATERIALS SPECIFIED ELSEWHERE.
- . IN ALL ACTIVITIES, COMPLY WITH PERTINENT REGULATIONS OF GOVERNMENTAL AGENCIES HAVING JURISDICTION.
- DEMOLISHED MATERIAL SHALL BE CONSIDERED TO BE PROPERTY OF THE CONTRACTOR AND SHALL BE COMPLETELY REMOVED FROM THE JOB SITE.
- 6. ASBESTOS AND HAZARDOUS MATERIALS DEMOLITION OR REMOVAL WORK IS NOT PART OF THIS CONTRACT.
- THE DEMOLITION WORK IS NOT LIMITED TO DEMOLITION ITEMS LISTED OR SPECIFICALLY IDENTIFIED ON THE CONSTRUCTION DOCUMENTS, BUT SHALL INCLUDE THOSE ITEMS NECESSARY FOR A FINISHED AND COMPLETE PROJECT.
- GENERAL CONTRACTOR SHALL INCLUDE ALL INTERIOR AND EXTERIOR PATCHING, PREPARING AND PAINTING TO PROVIDE A PROFESSIONAL AND COMPLETELY FINISHED PROJECT.

DEMOLITION NOTES:

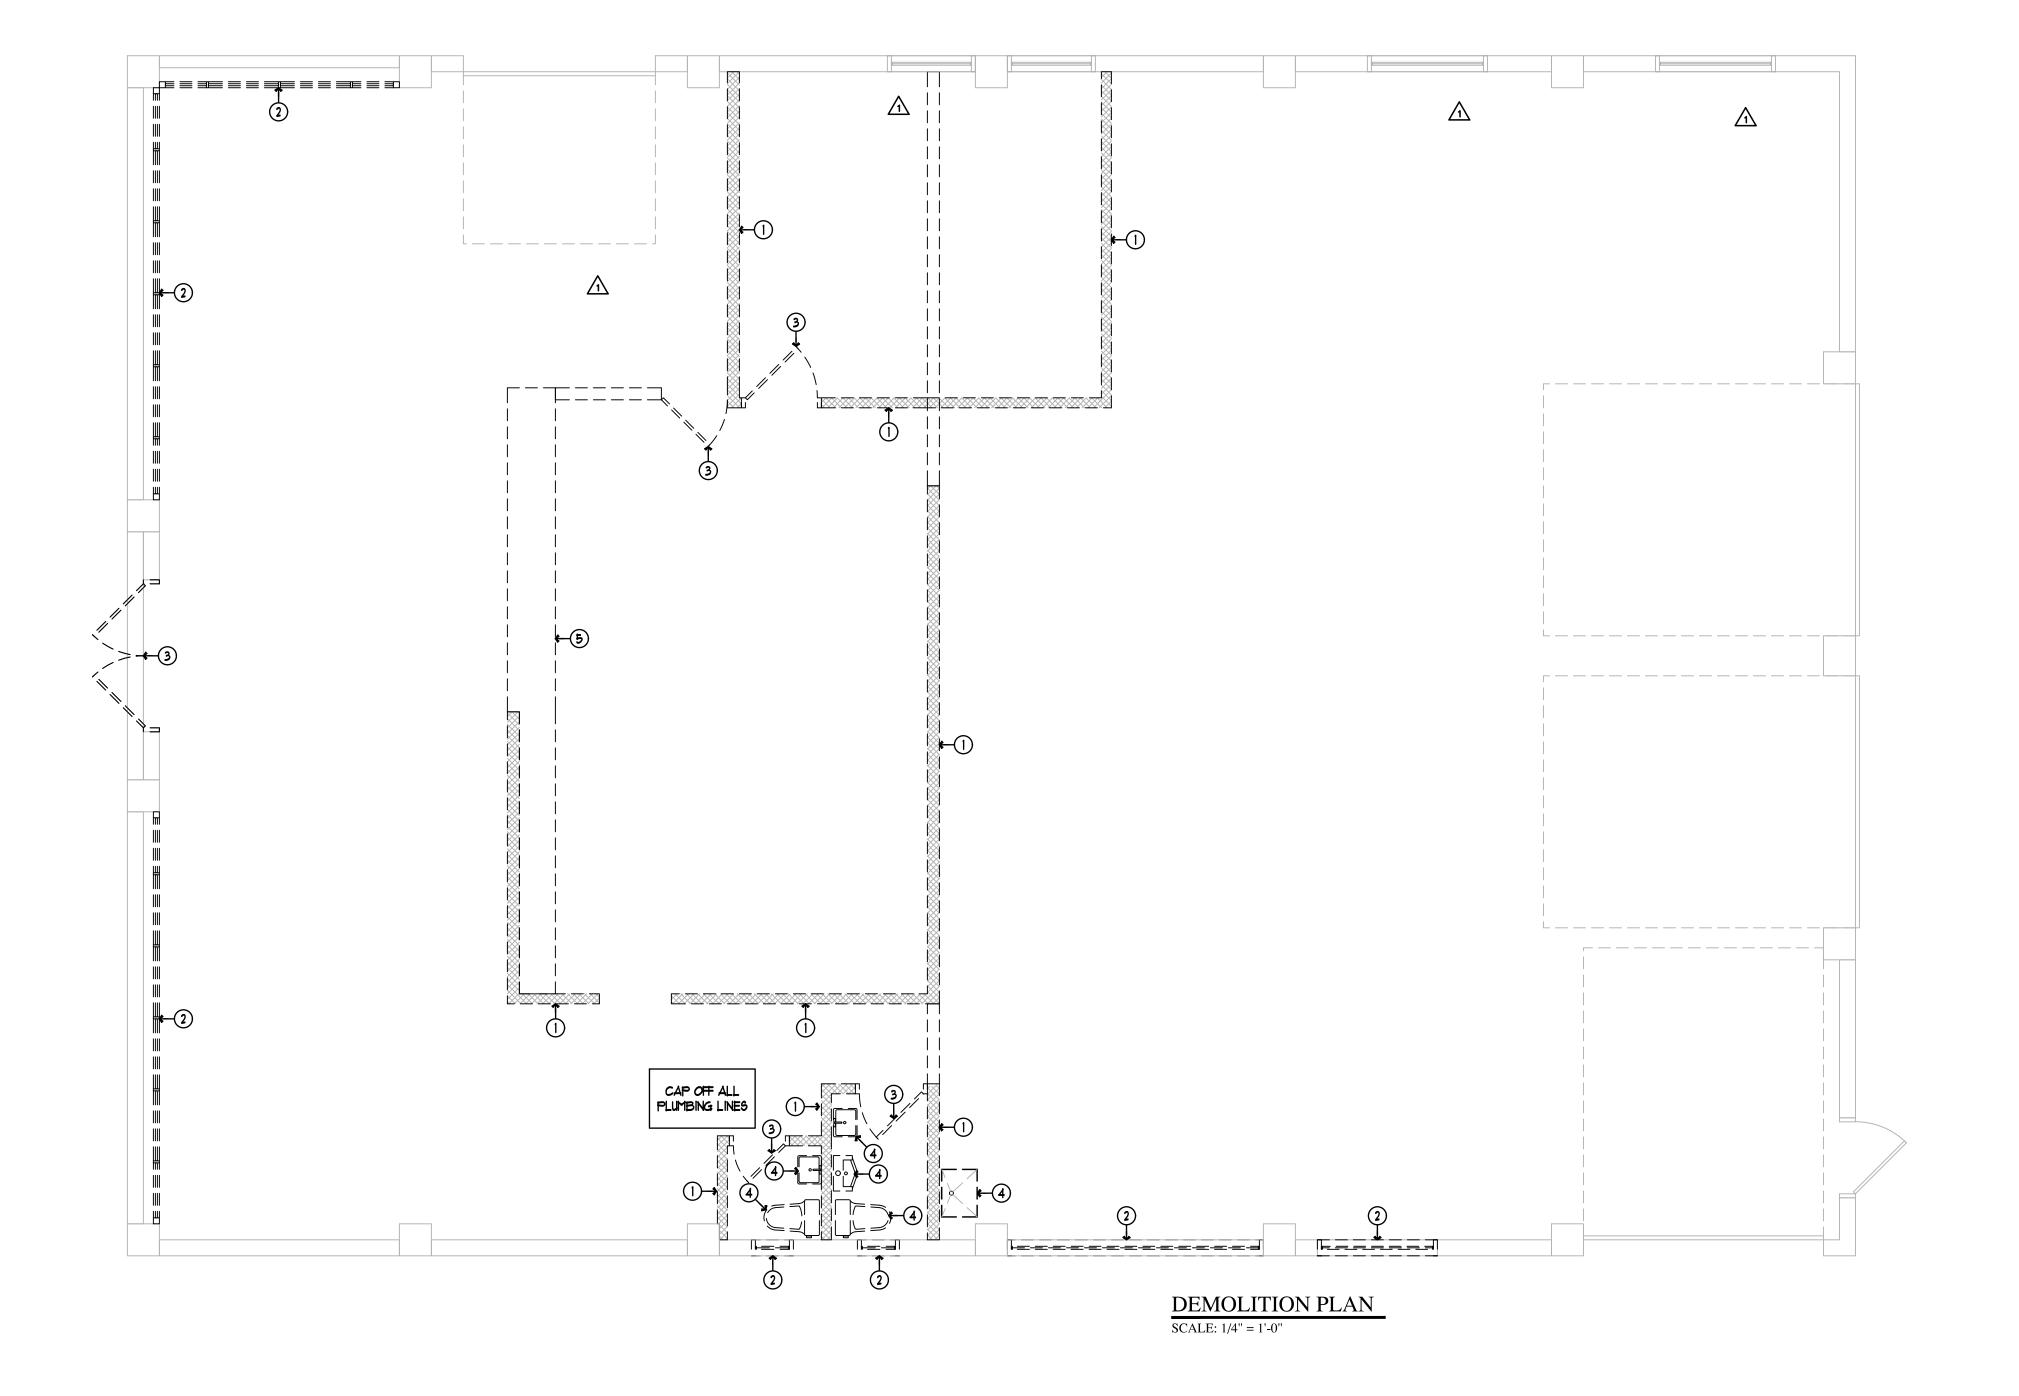- 1 REMOVE EXISTING WALL
- 2 REMOVE EXISTING WINDOW
- 3 REMOVE EXISTING DOORS
- 4 REMOVE & CAP EXISTING PLUMBING FIXTURES
- 5 REMOVE EXISTING MILLWORK

PERMIT | 05/21/19 MF REV. 1 07/23/19 MF REY. REY. REY.

REY.

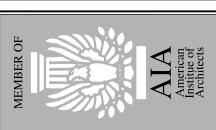


ISSUE DATE BY: REVIEW | 05/21/19 MF

OMMERIC

MA 200 ST. PROFESSIONAL SEAL

ORA FRANKLIN FRAZE, IV

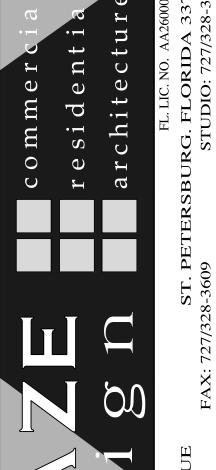

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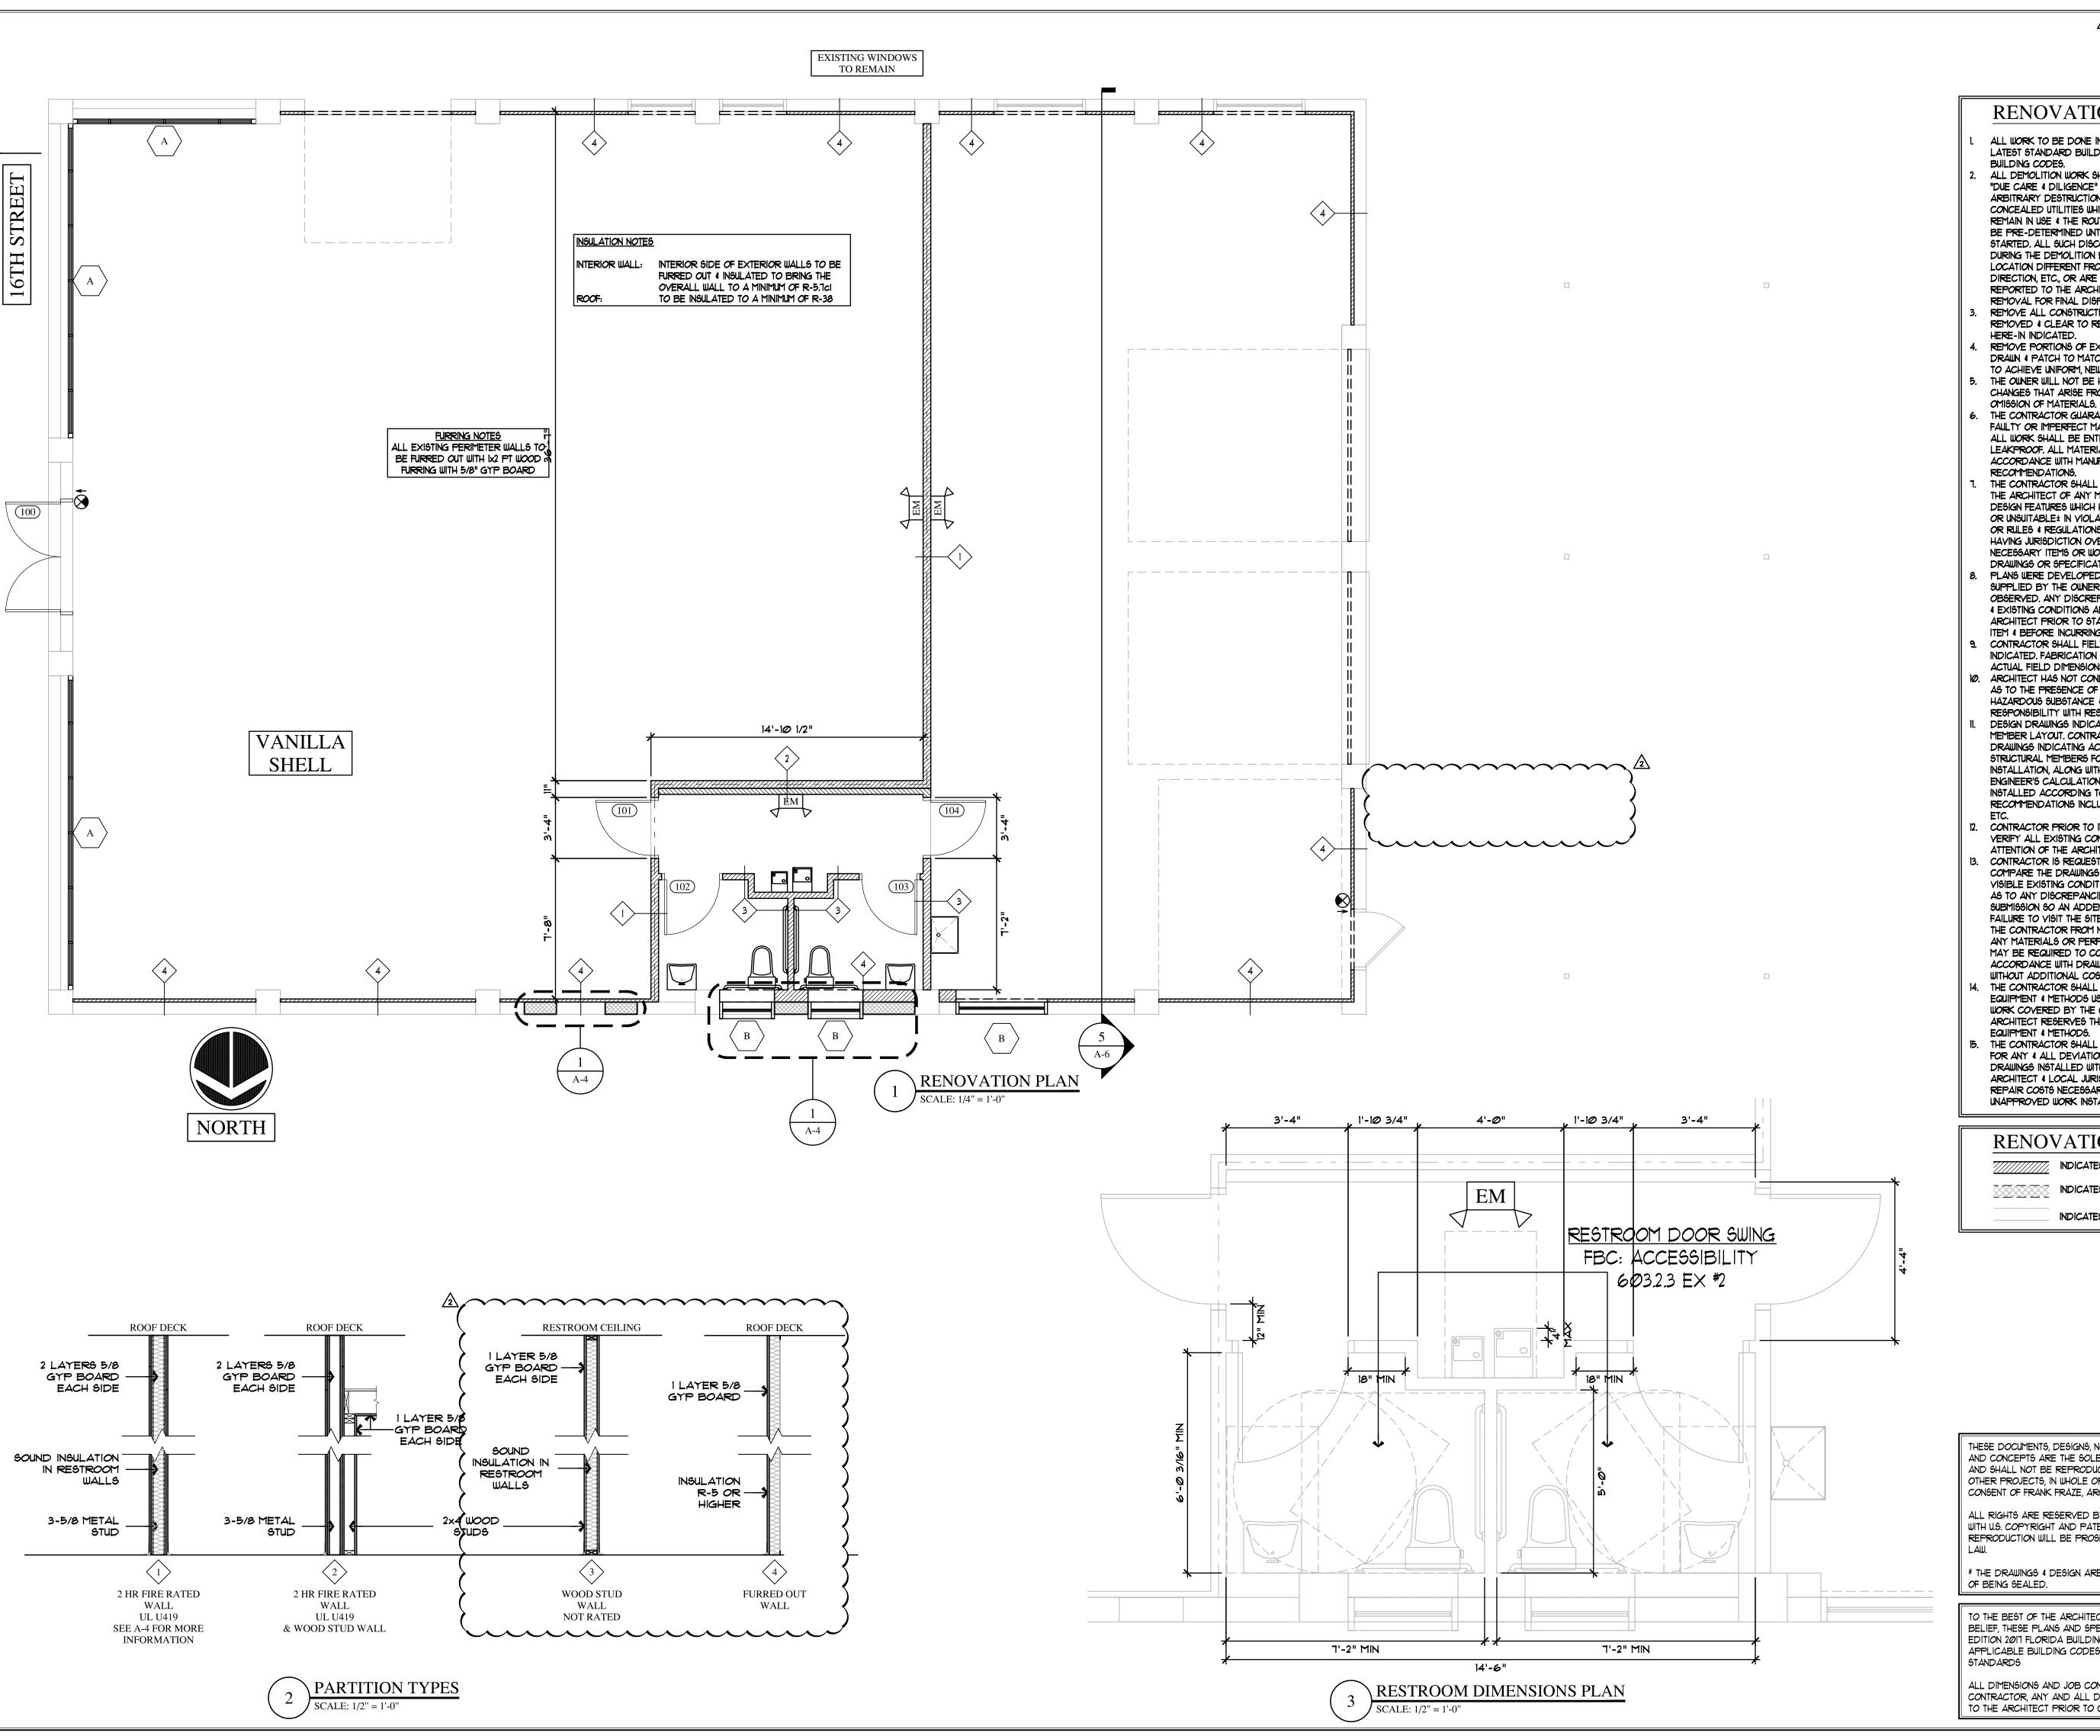
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SHEET NUMBER

SHEET TITLE

DEMOLITION PLAN



RENOVATION NOTES:

ALL WORK TO BE DONE IN ACCORDANCE WITH THE LATEST STANDARD BUILDING CODE & ALL LOCAL BUILDING CODES.

ALL DEMOLITION WORK SHALL BE PERFORMED WITH "DUE CARE & DILIGENCE" SO AS TO PREVENT THE ARBITRARY DESTRUCTION OF INTERRUPTION OF CONCEALED UTILITIES WHICH ARE INTENDED TO REMAIN IN USE & THE ROUTING OF WHICH COULD NOT BE PRE-DETERMINED UNTIL DEMOLITION WAS STARTED. ALL SUCH DISCOVERIES OF UTILITIES DURING THE DEMOLITION PROCESS WHICH ARE IN A LOCATION DIFFERENT FROM THAT INDICATED, CHANGE DIRECTION, ETC., OR ARE UNIDENTIFIED, SHALL BE REPORTED TO THE ARCHITECT / OWNER BEFORE REMOVAL FOR FINAL DISPOSITION.

REMOVE ALL CONSTRUCTION DESIGNATED TO BE REMOVED & CLEAR TO RECEIVE NEW WORK AS HERE-IN INDICATED.

REMOVE PORTIONS OF EXISTING CONSTRUCTION AS DRAWN & PATCH TO MATCH ADJACENT CONSTRUCTION

TO ACHIEVE UNIFORM, NEW APPEARANCE. THE OWNER WILL NOT BE HELD LIABLE FOR FIELD CHANGES THAT ARISE FROM CONTRACTOR ERROR OR

THE CONTRACTOR GUARANTEES ALL WORK AGAINST FAULTY OR IMPERFECT MATERIALS OR WORKMANSHIP ALL WORK SHALL BE ENTIRELY WATERTIGHT & LEAKPROOF, ALL MATERIALS ARE INSTALLED IN ACCORDANCE WITH MANUFACTURER'S RECOMMENDATIONS.

THE CONTRACTOR SHALL GIVE WRITTEN NOTICE TO THE ARCHITECT OF ANY MATERIALS, EQUIPMENT OR DESIGN FEATURES WHICH HE BELIEVES INADEQUATE OR UNGUITABLE IN VIOLATION OF LAWS, ORDINANCES, OR RULES & REGULATIONS OF ALL AUTHORITIES HAYING JURISDICTION OVER THE WORK! & OF ANY NECESSARY ITEMS OR WORK OMITTED FROM THE

DRAWINGS OR SPECIFICATIONS. PLANS WERE DEVELOPED FROM INFORMATION SUPPLIED BY THE OWNER & EXISTING CONDITIONS OBSERVED. ANY DISCREPANCIES BETWEEN DRAWINGS 4 EXISTING CONDITIONS ARE TO BE REPORTED TO ARCHITECT PRIOR TO STARTING WORK ON A GIVEN ITEM & BEFORE INCURRING ANY ADDITIONAL COSTS. CONTRACTOR SHALL FIELD VERIFY ALL DIMENSIONS

INDICATED. FABRICATION SHALL BE BASED ON THE ACTUAL FIELD DIMENSIONS ONLY. O. ARCHITECT HAS NOT CONDUCTED ANY INVESTIGATION AS TO THE PRESENCE OF ASBESTOS OR ANY OTHER HAZARDOUS SUBSTANCE & ASSUMES NO

RESPONSIBILITY WITH RESPECT TO SAME. DESIGN DRAWINGS INDICATE SCHEMATIC STRUCTURAL MEMBER LAYOUT. CONTRACTOR SHALL SUBMIT SHOP DRAWINGS INDICATING ACTUAL LAYOUT OF ALL STRUCTURAL MEMBERS FOR APPROVAL PRIOR TO INSTALLATION, ALONG WITH REGISTERED STRUCTURAL ENGINEER'S CALCULATIONS. ALL MEMBERS SHALL BE INSTALLED ACCORDING TO MANUFACTURERS RECOMMENDATIONS INCLUDING BRACING, SPACING,

CONTRACTOR PRIOR TO INSTALLATION SHALL FIELD VERIFY ALL EXISTING CONDITIONS & BRING TO THE

ATTENTION OF THE ARCHITECT ANY DISCREPANCIES. CONTRACTOR IS REQUESTED TO VISIT THE SITE, COMPARE THE DRAWINGS & SPECIFICATIONS WITH VISIBLE EXISTING CONDITIONS & INFORM ARCHITECT AS TO ANY DISCREPANCIES PRIOR TO BID FAILURE TO VISIT THE SITE WILL IN NO WAY RELIEVE THE CONTRACTOR FROM NECESSITY OF FURNISHING ANY MATERIALS OR PERFORMING ANY WORK THAT MAY BE REQUIRED TO COMPLETE WORK IN ACCORDANCE WITH DRAWINGS & SPECIFICATIONS WITHOUT ADDITIONAL COSTS TO THE OWNER.

THE CONTRACTOR SHALL BE RESPONSIBLE FOR THE EQUIPMENT & METHODS USED IN THE ERECTION OF HIS WORK COVERED BY THE CONTRACT, BUT THE ARCHITECT RESERVES THE RIGHT TO APPROVE SUCH

EQUIPMENT & METHODS. THE CONTRACTOR SHALL BE TOTALLY RESPONSIBLE FOR ANY & ALL DEVIATIONS FROM THE CONSTRUCTION DRAWINGS INSTALLED WITHOUT APPROYAL OF ARCHITECT & LOCAL JURISDICTION. THIS INCLUDES REPAIR COSTS NECESSARY TO CORRECT UNAPPROVED WORK INSTALLED.

RENOVATION LEGEND:

INDICATES NEW WALL

INDICATES NEW EXTERIOR IN-FILL WALL

INDICATES EXISTING WALL

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ALL DIMENSIONS AND JOB CONDITIONS SHALL BE VERIFIED BY THE CONTRACTOR, ANY AND ALL DISCREPANCIES SHALL BE REPORTED TO THE ARCHITECT PRIOR TO COMMENCEMENT OF CONSTRUCTION.

ISSUE DATE REVIEW | 05/21/19 MF PERMIT | 05/21/19 MF REV. 1 07/23/19 MF REV. /2 08/06/19 MF REY. REY. REY.

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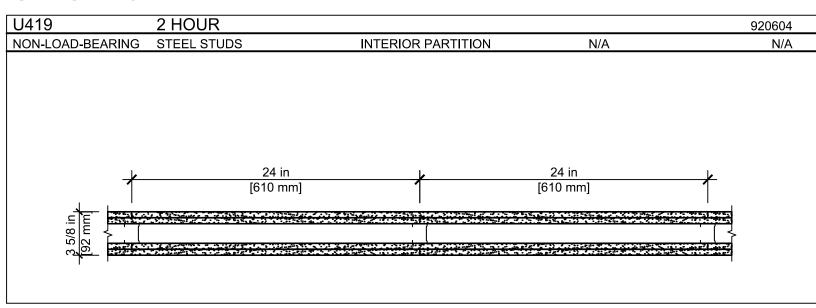


MERIC



SHEET TITLE RENO PLAN, DOOR \$ WINDOW SCHED. \$ PARTITIONS TYPES

UL U419



INTERIOR PARTITIONS: STEEL STUD (NON-LOAD-BEARING)


FIRE RATING: 2 HOUR STC: N/A SOUND TEST: N/A SYSTEM THICKNESS: 3-5/8"

ASSEMBLY OPTIONS:


GYPSUM BOARD: TWO LAYERS OF 5/8 IN. THICK GYPSUM BOARD APPLIED HORIZONTALLY OR VERTICALLY.

STEEL STUDS: MINIMUM 1-5/8 IN. DEEP, 25 GA. SPACED 24 IN. O.C.

GYPSUM BOARD: TWO LAYERS OF 5/8 IN. THICK GYPSUM BOARD APPLIED HORIZONTALLY OR VERTICALLY.

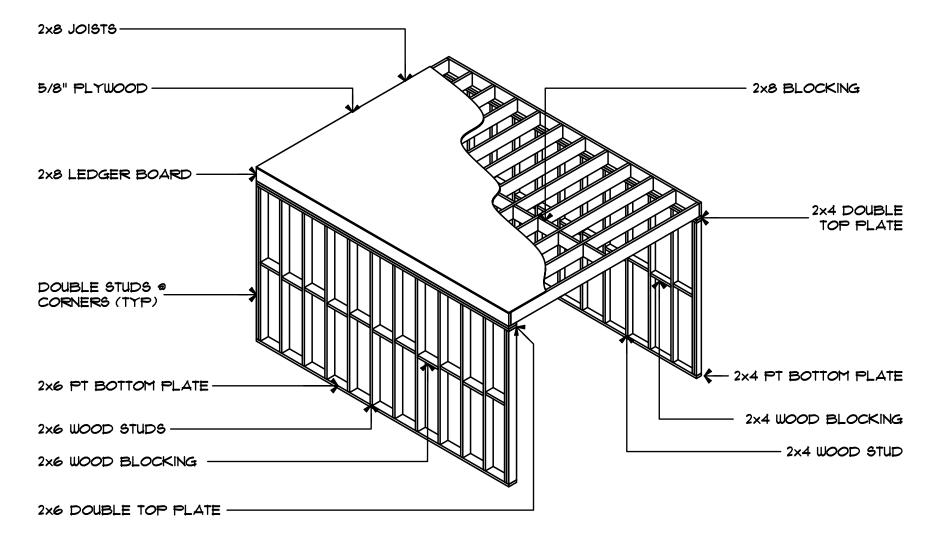

2 RESTROOM CEILING FRAMING DETAIL
SCALE: NTS

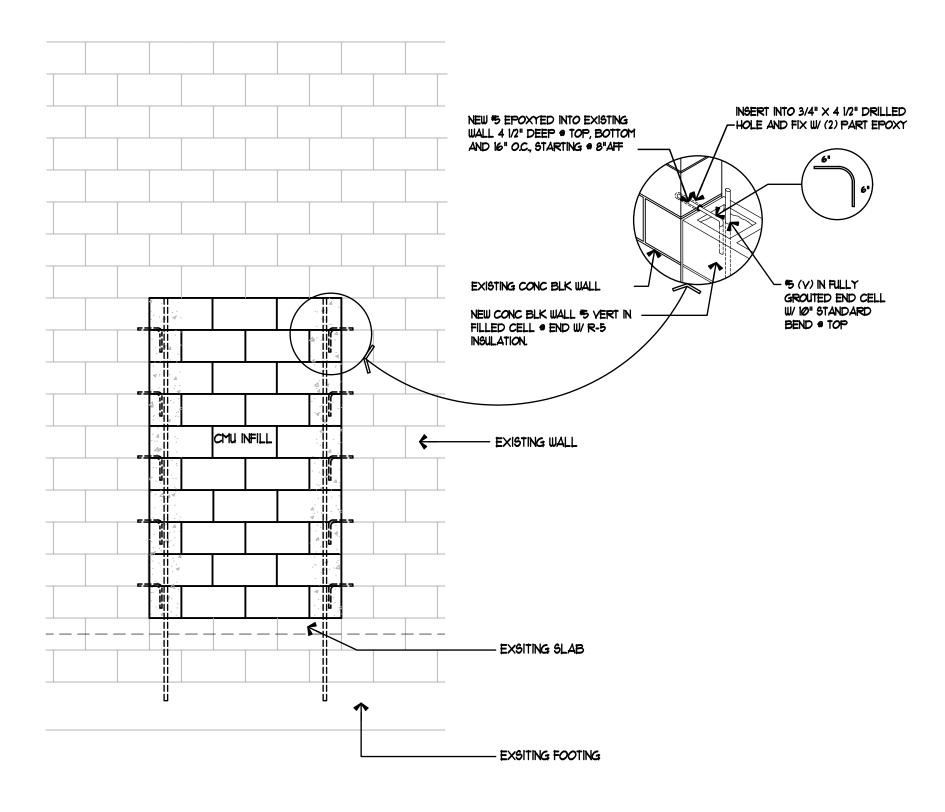



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REVIEW 05/21/19 MF

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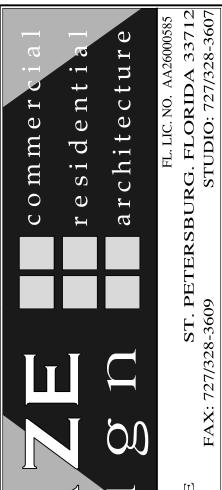
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PROFESSIONAL SEAL

OF FRANKLIN FRAZE, IV




E-MAIL: fdi@frazedesign.cc 1750 CENTRAL 4 PHONE: 727/328-36

SHEET TITLE
UL U300 & U419
2 HOUR FIRE RATED
WALL DETAILS

SHEET NUMBER

A-4

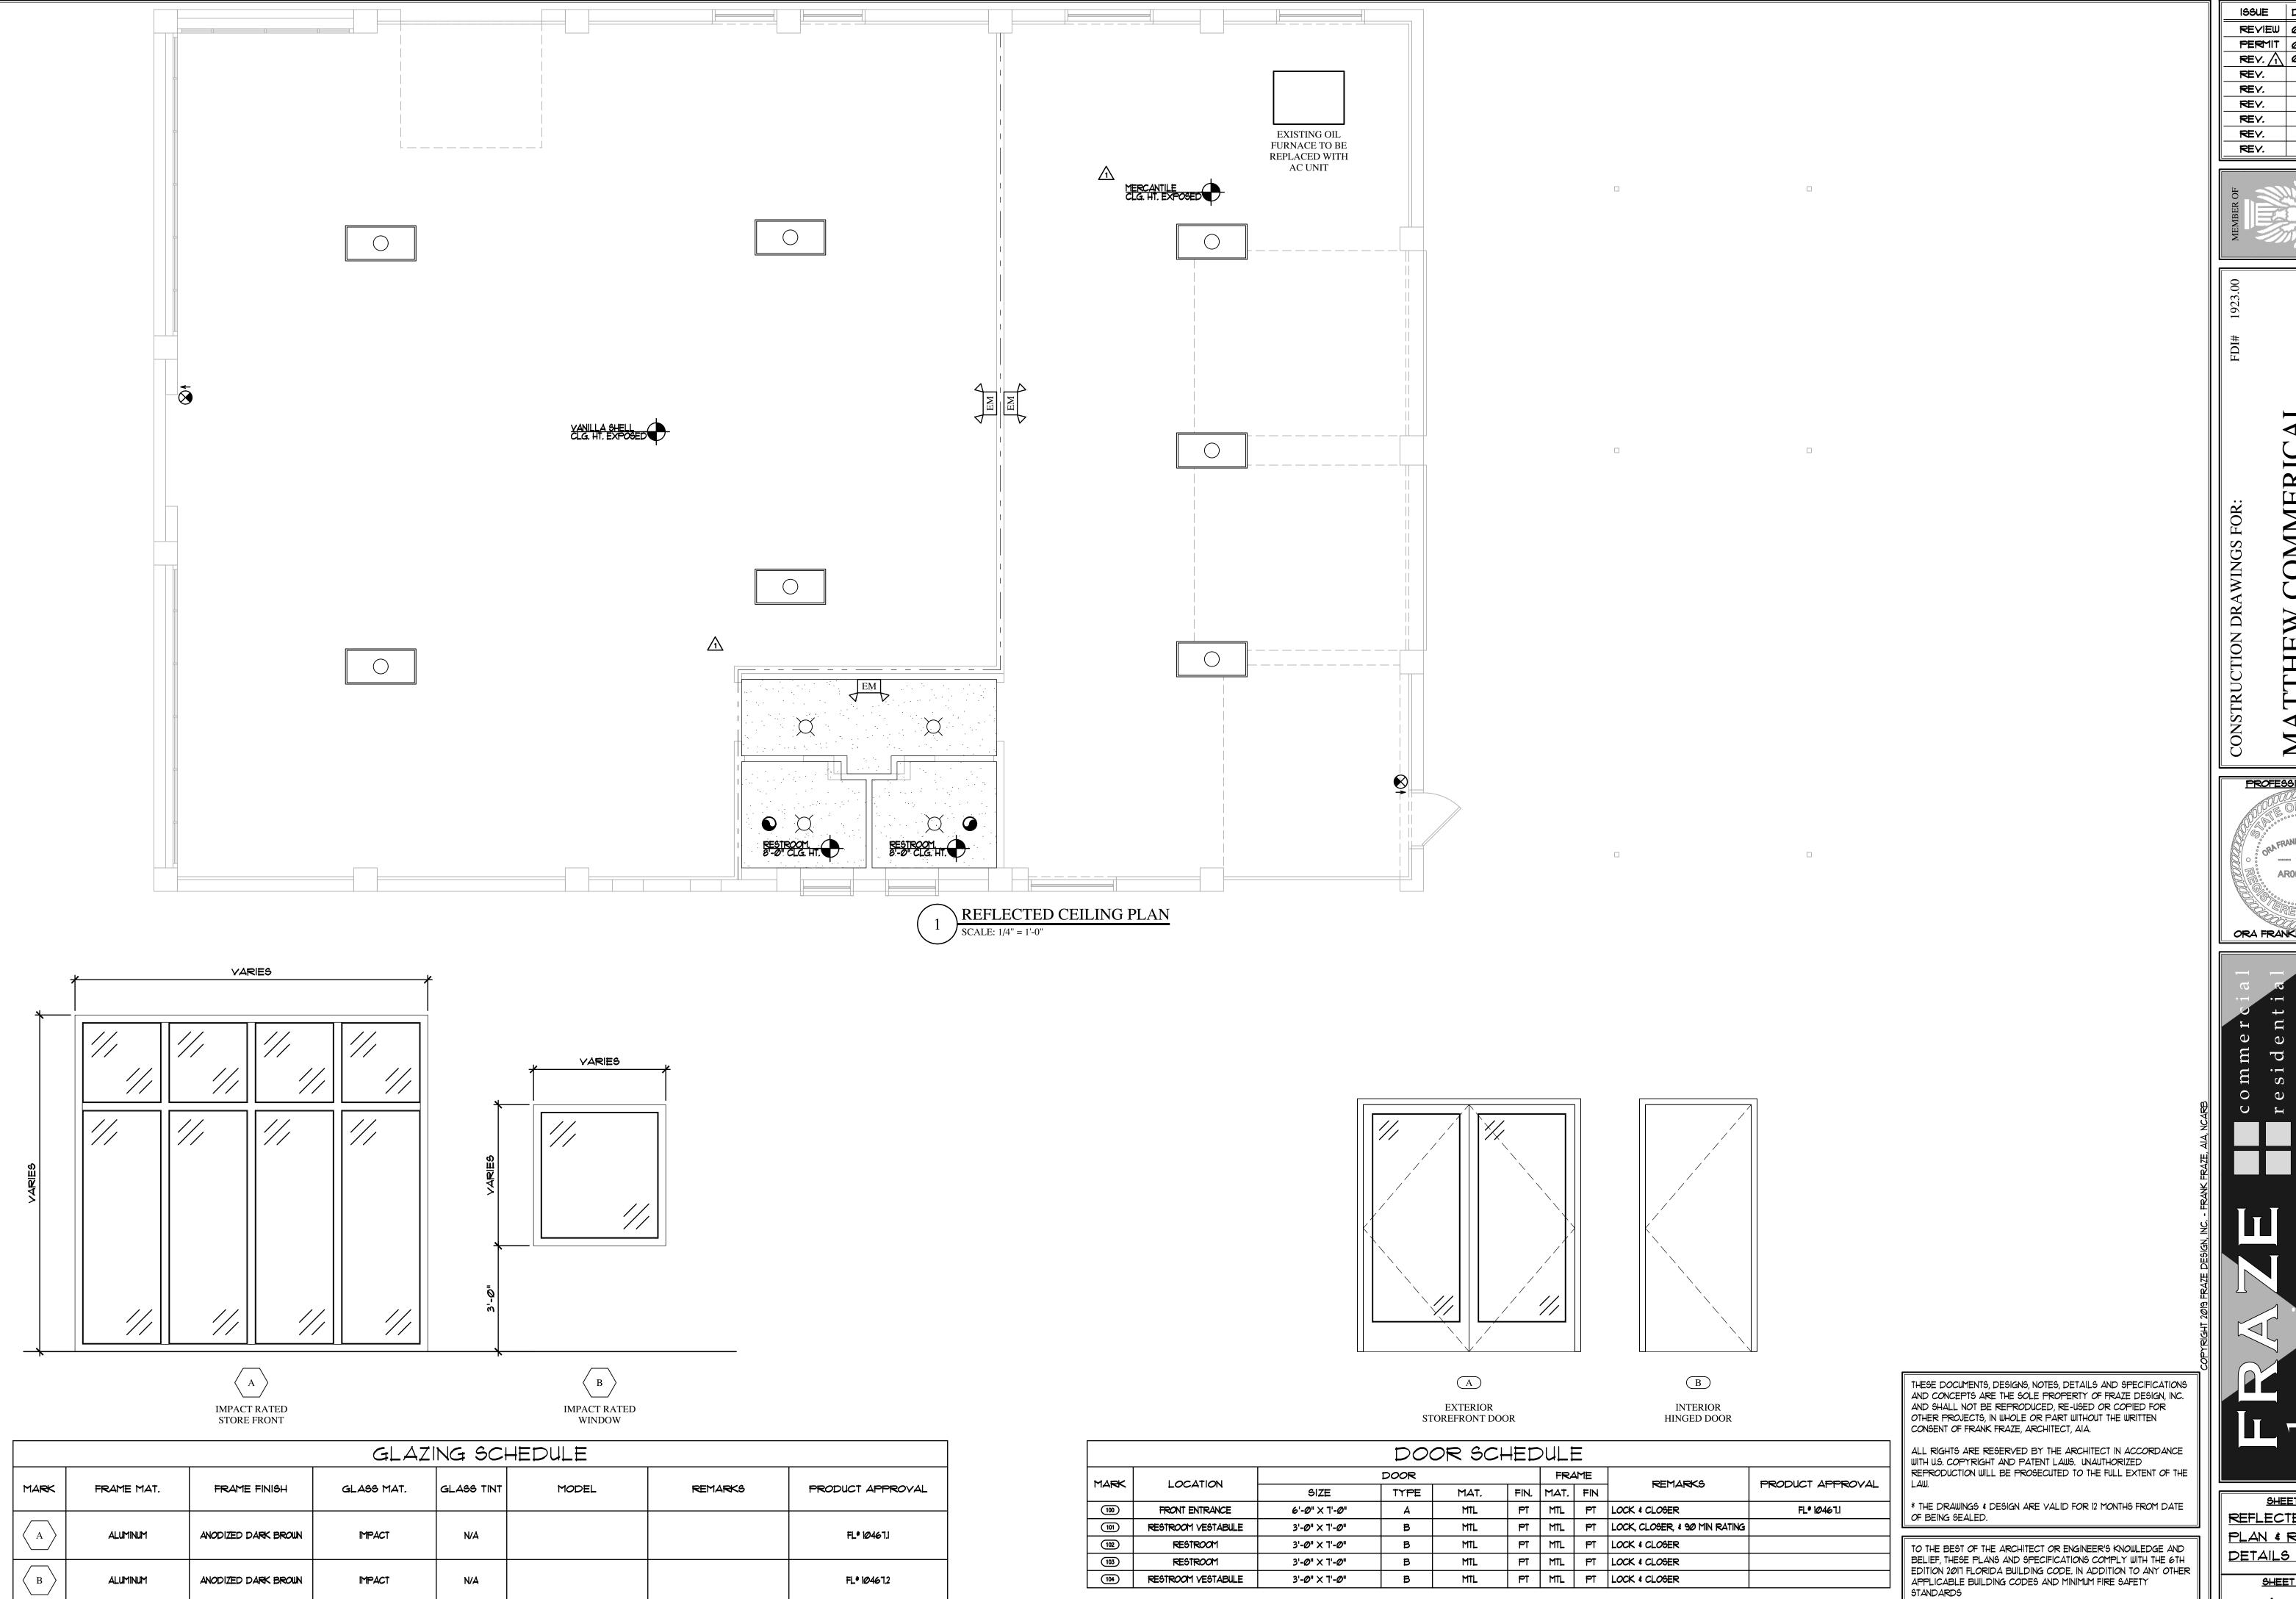



ALL EXTERIOR GLAZING IS IMPACT RESISTANT MEETING THE REQUIREMENTS OF SSTD 12, ASTM E 1886 AND ASTM E 1996, AND SHALL MEET THE REQUIREMENTS OF THE

LARGE MISSILE TEST IN ACCORDANCE WITH 1606.1.4, 2007 FBC, AND HAVE MIAMI-DADE PRODUCT APPROVALS.

PERMIT Ø5/21/19 MF REV. 1 Ø1/23/19 MF



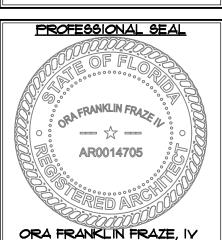

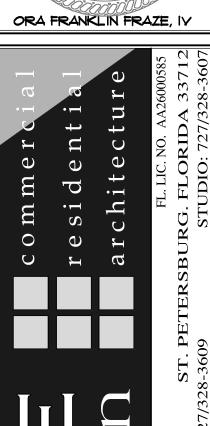


SHEET TITLE REFLECTED CEILING PLAN & RESTROOM

SHEET NUMBER

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CONTRACTOR, ANY AND ALL DISCREPANCIES SHALL BE REPORTED

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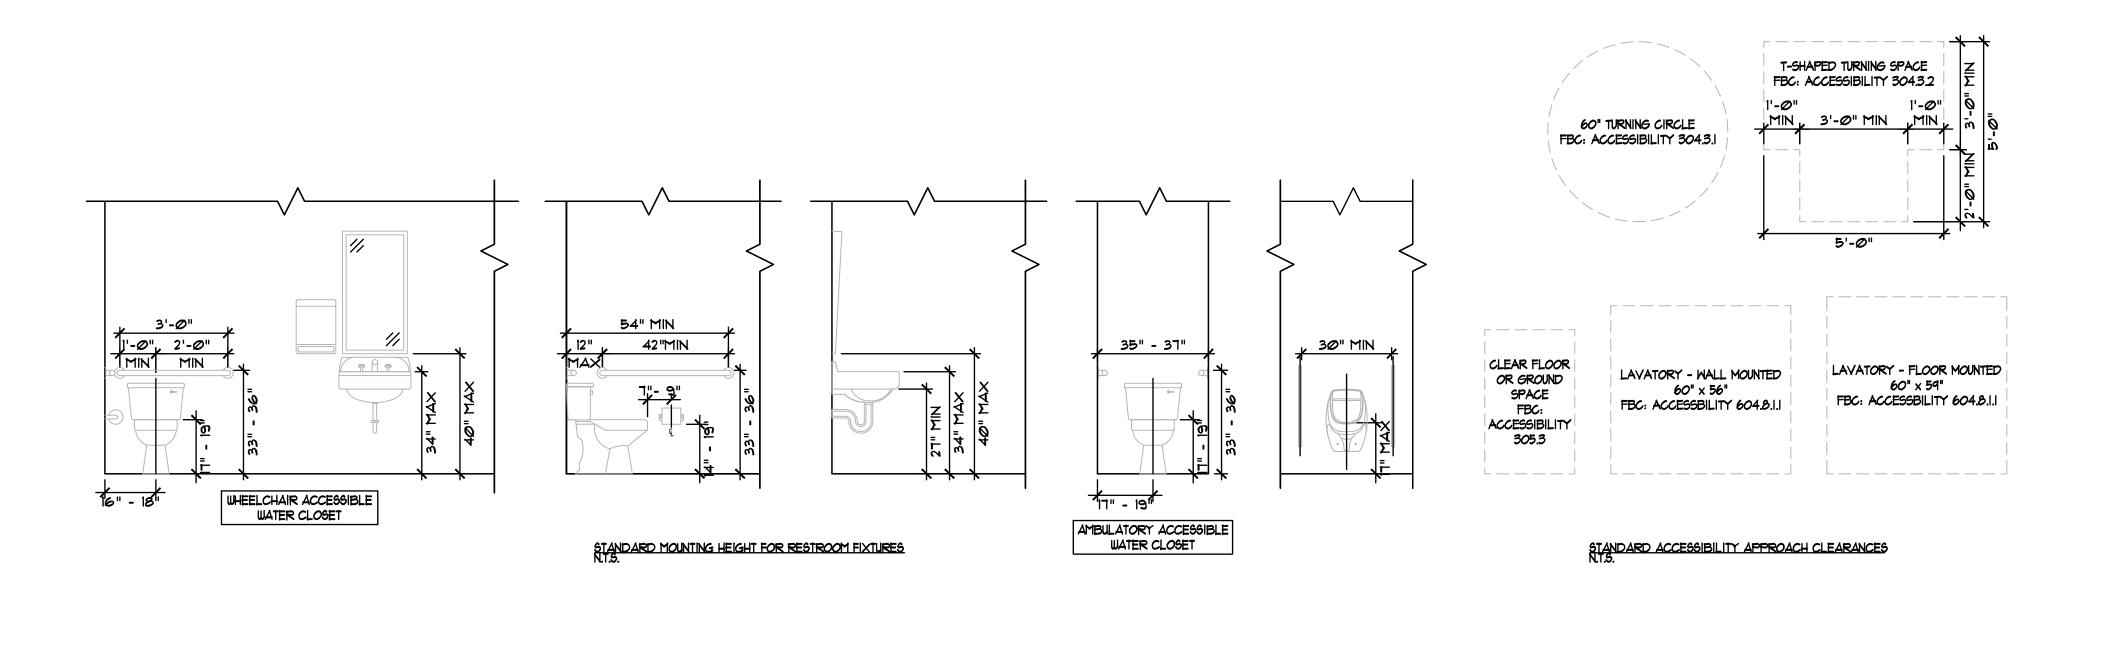
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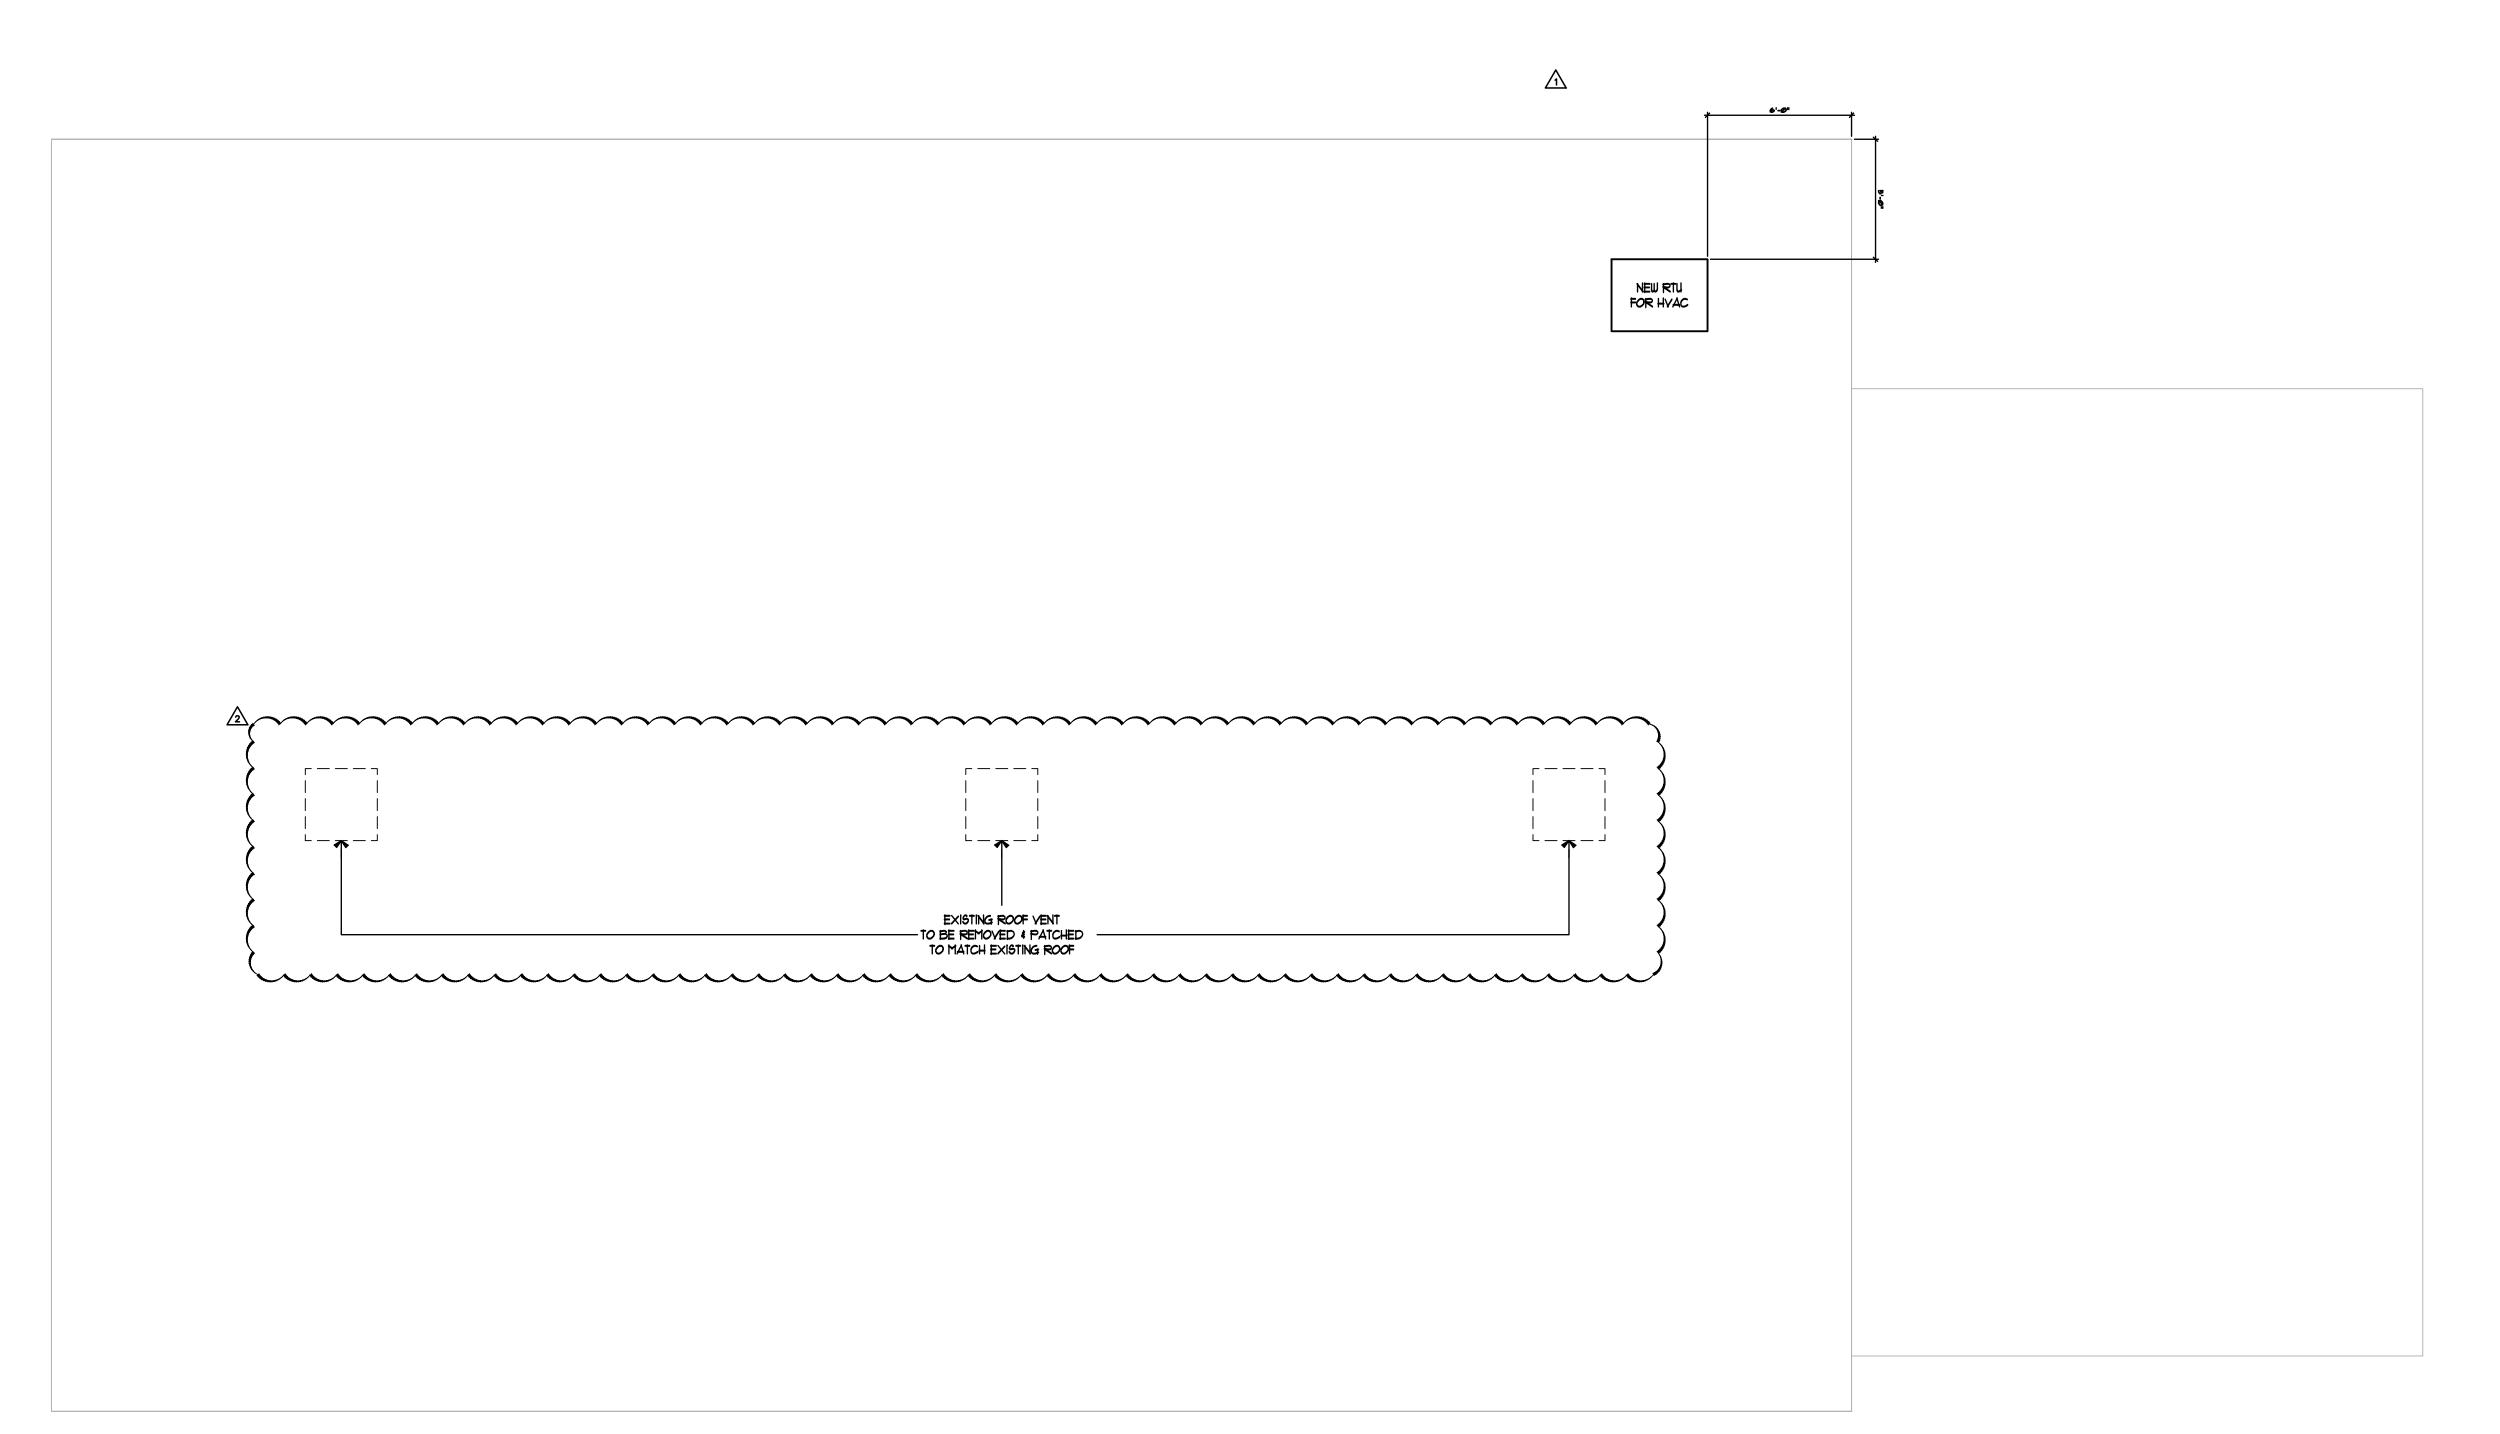


PROFESSIONAL SEAL AR0014705 ORA FRANKLIN FRAZE, IV

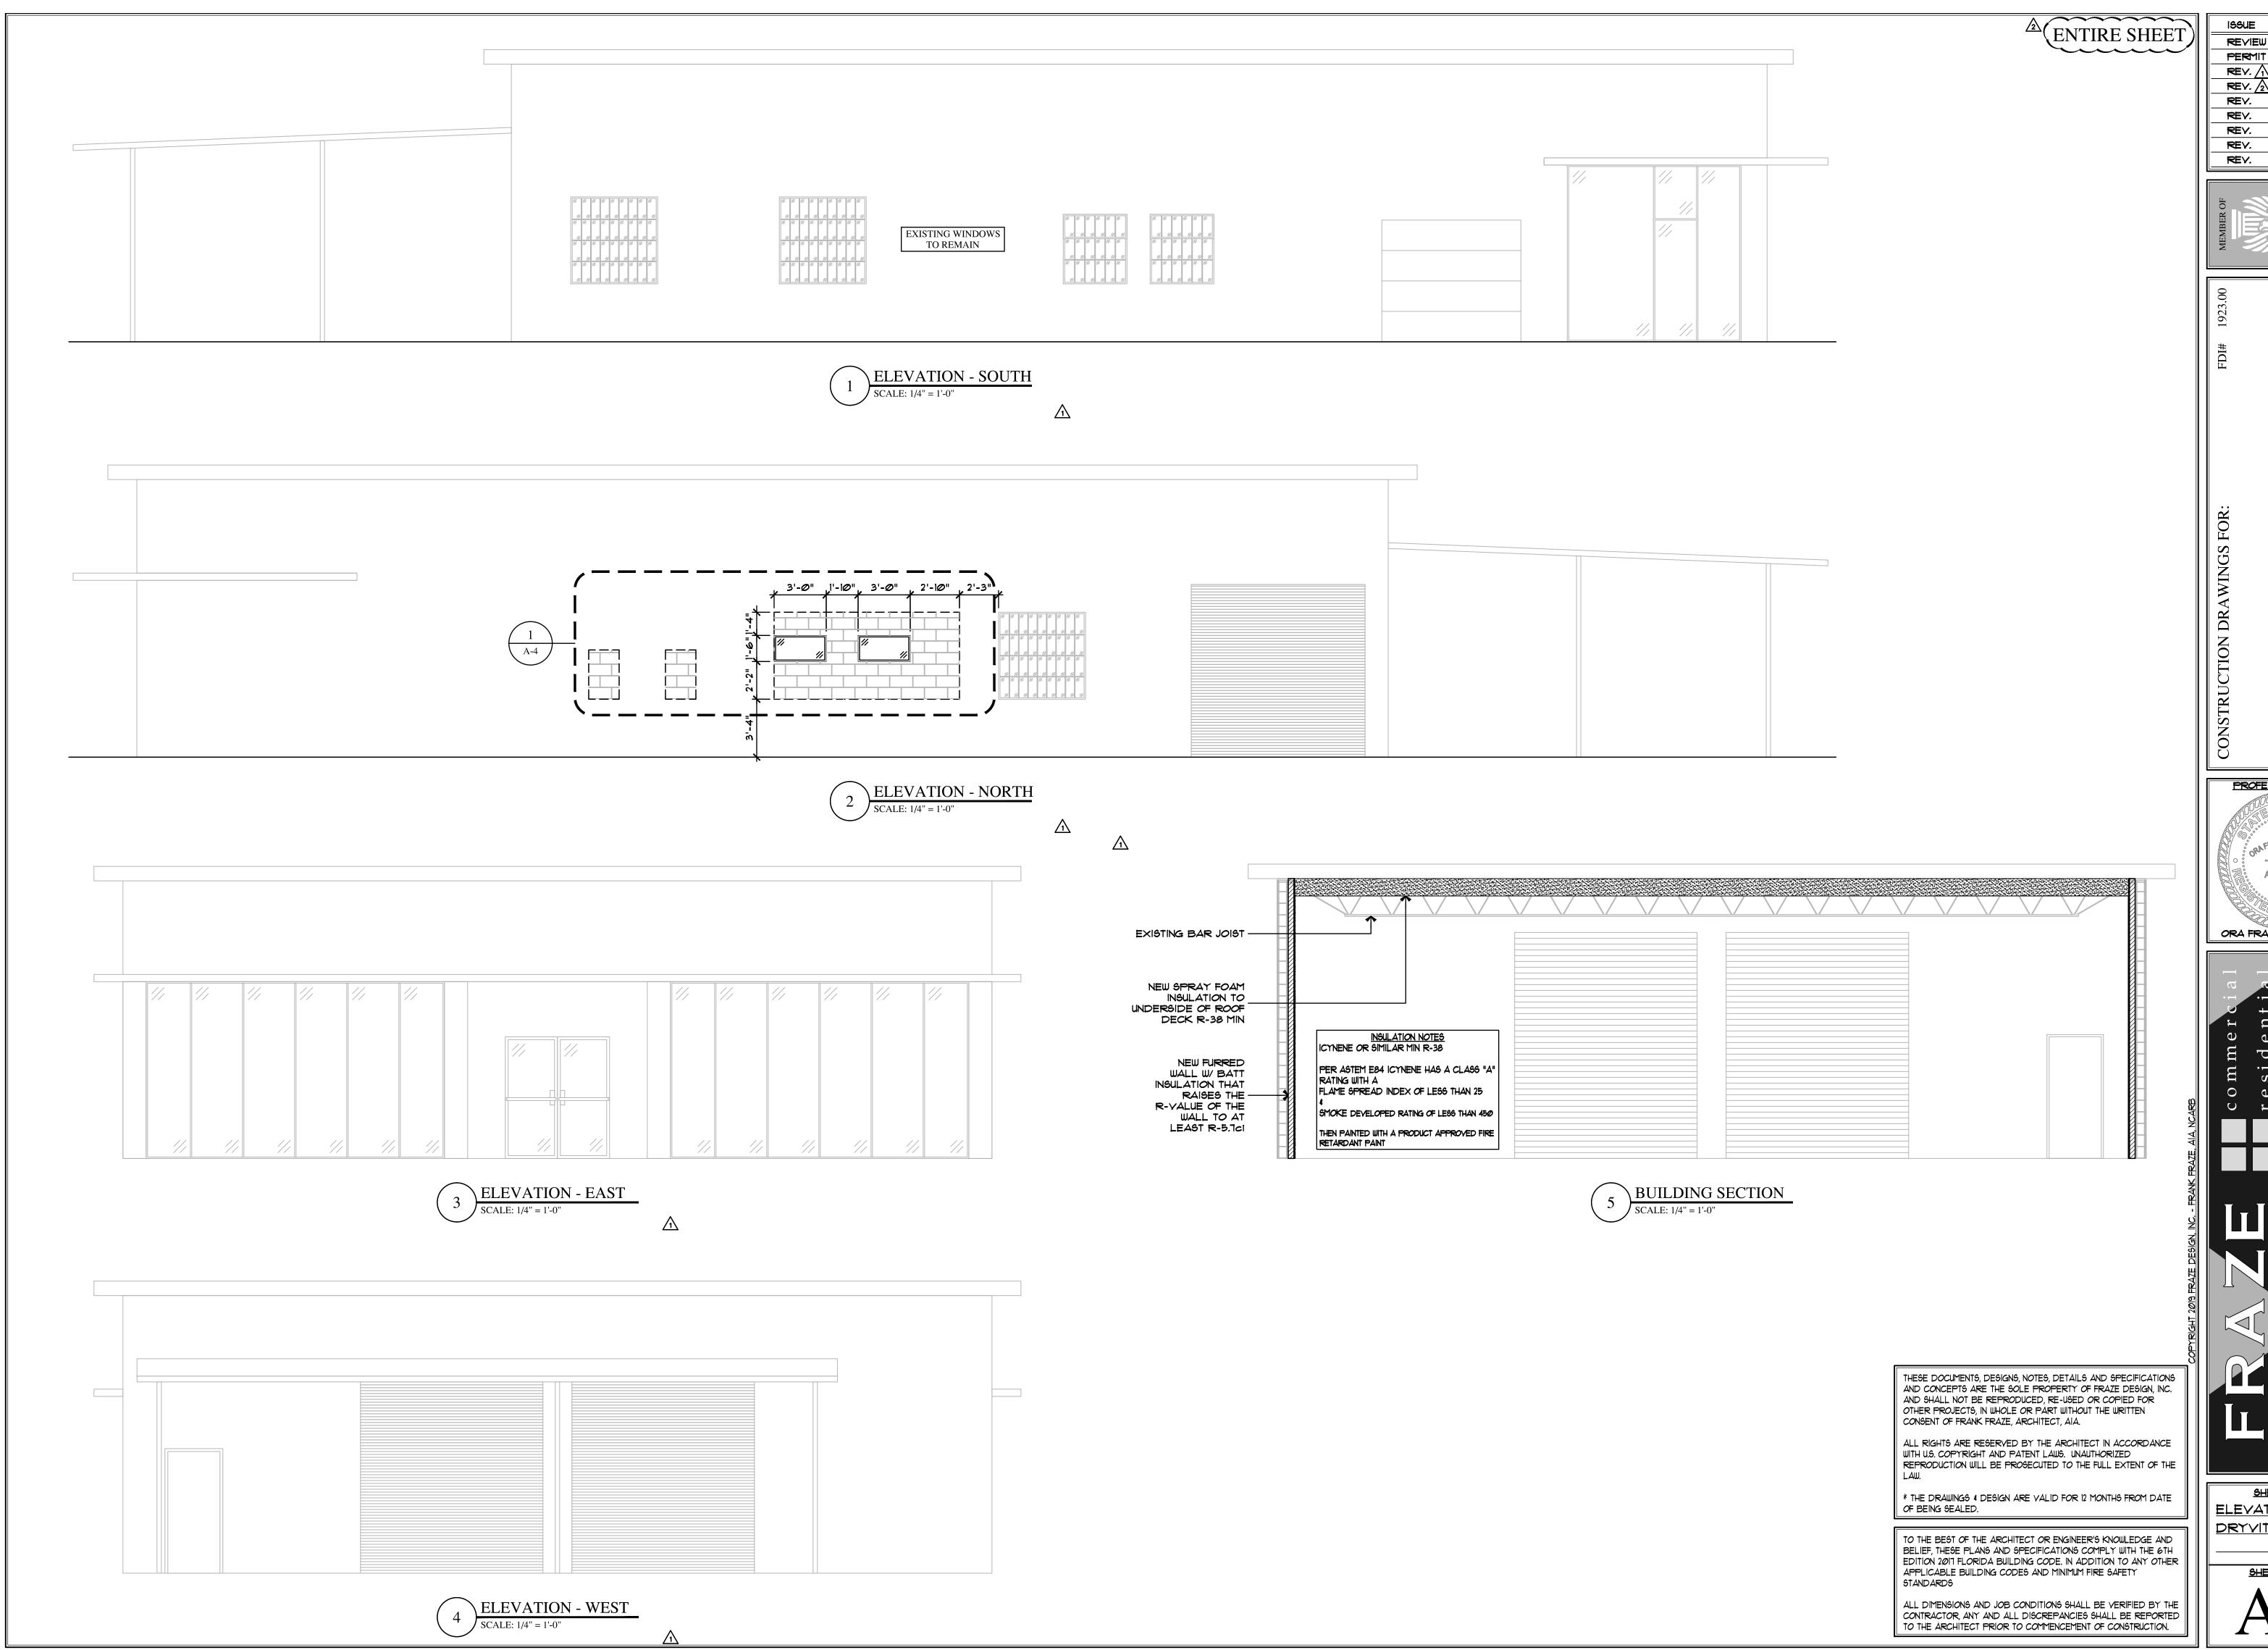SHEET TITLE

ELEVATIONS & DRYVIT DETAILS





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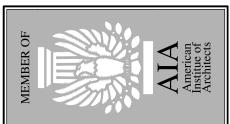
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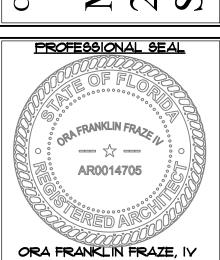
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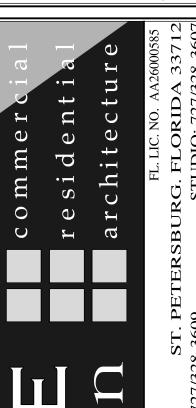
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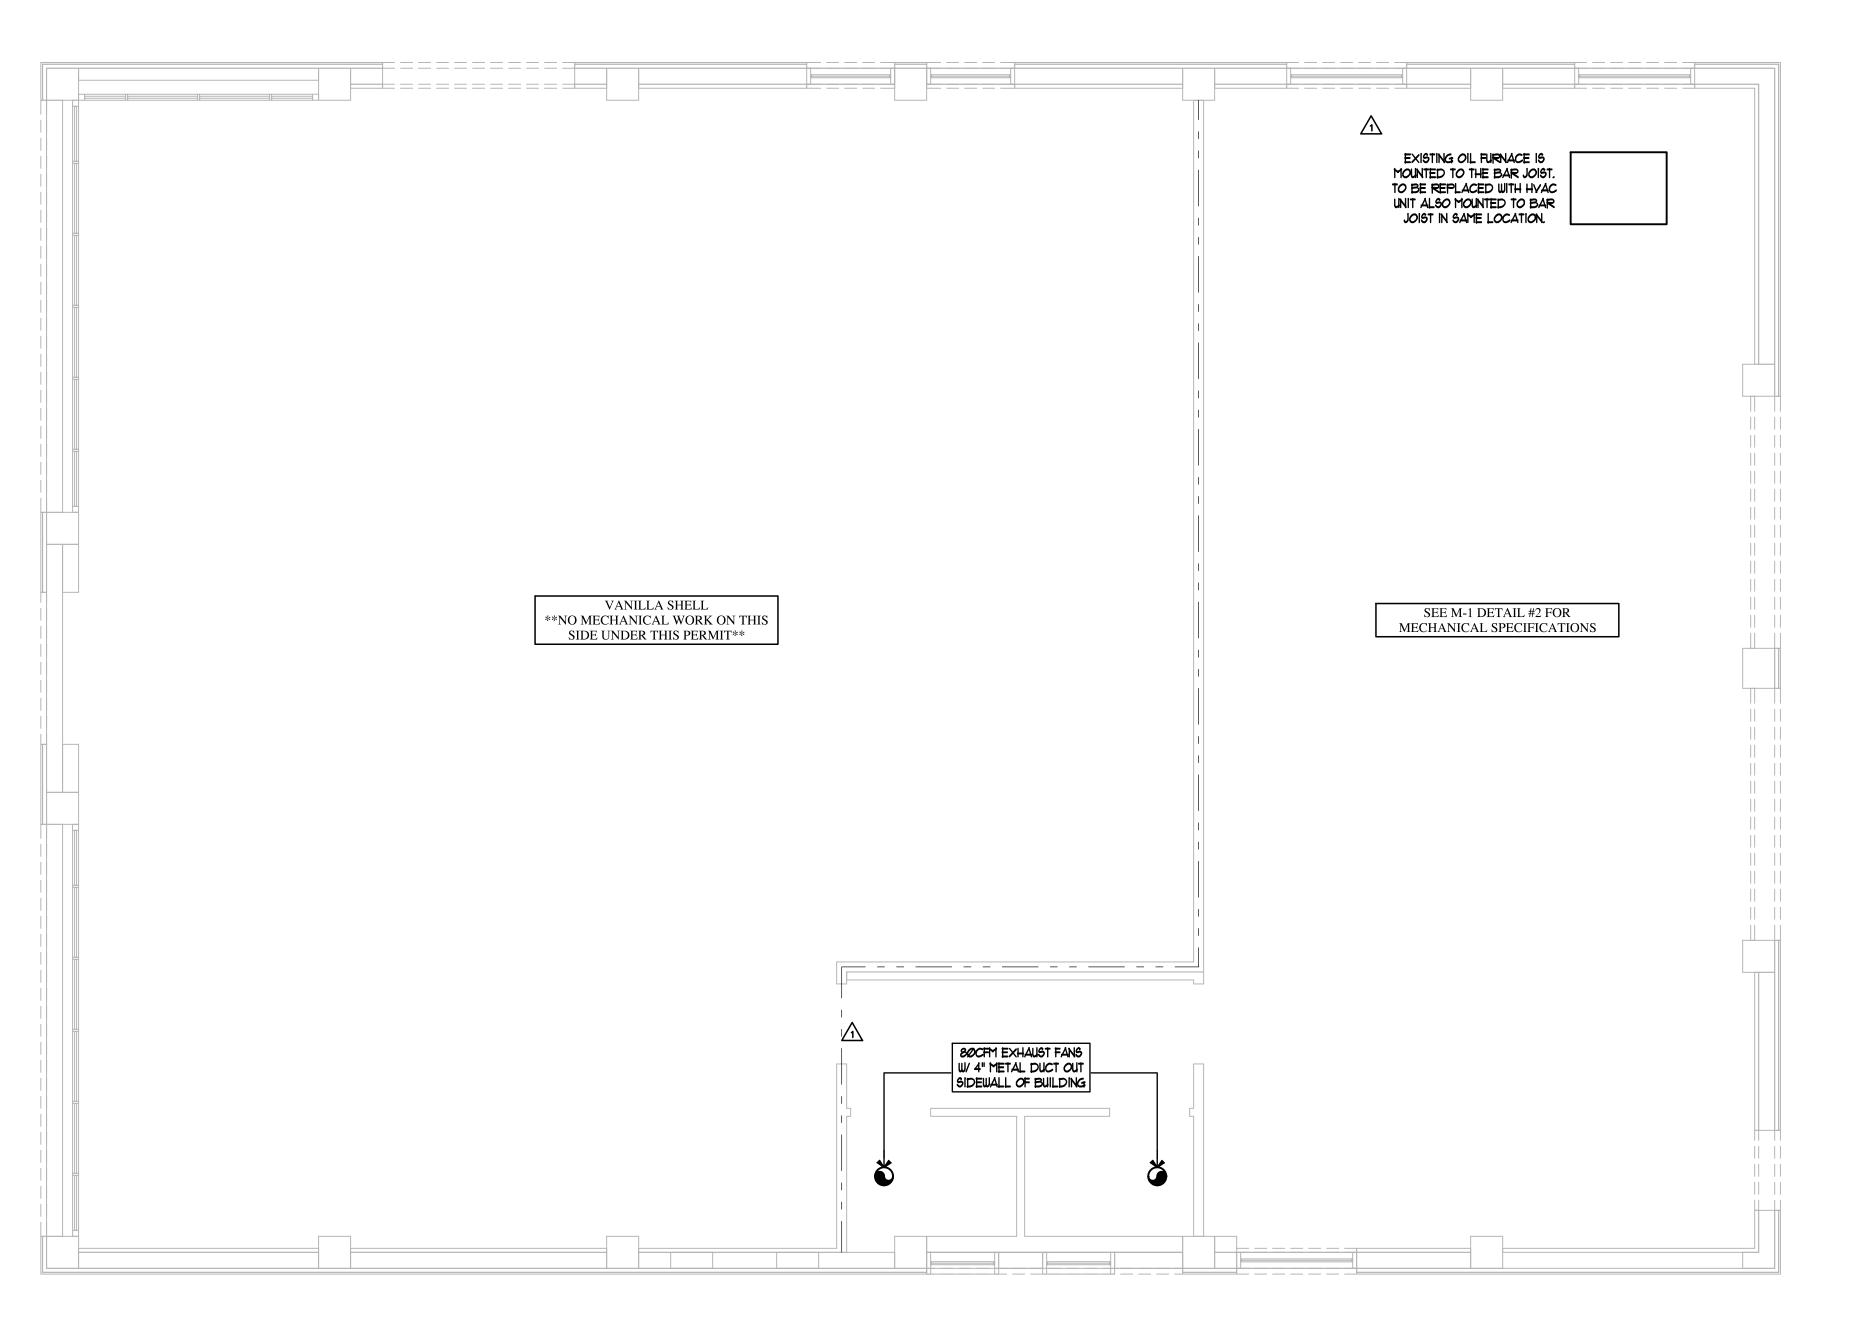
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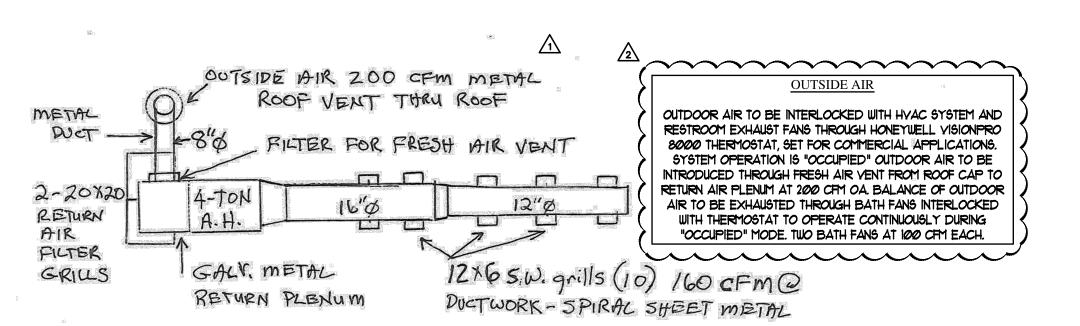


SHEET TITLE

RESTROOM DETAILS # ROOF PLAN



MECHANICAL PLAN



INSTALL AIR HANDLER IN SIME LOCATION EXISTING OIL FURNACE, SET COMPRESSOR UNIT ON ALUMINUM WIND RATED BRACKET ATTACH TO ROOF JOIST. 2- MIAMI TECH AS1418 W/ 2-A514 I-6 BEAMS EQUIPMENT: CARRIER COMPORT SERIES WITH PURON 14.0 SEER ZA ABB348A---5 208/230 VOLT 3 Ø
FX 4DN FOGIL - AIR HANDLER 7.5 KW 208/230 V. 1 Ø I- BROAN QTR50 50 CFM BATH FAN + VENTWE-

\ MECHANICAL EQUIPMENT DETAILS

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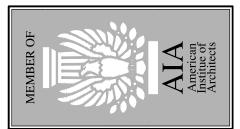
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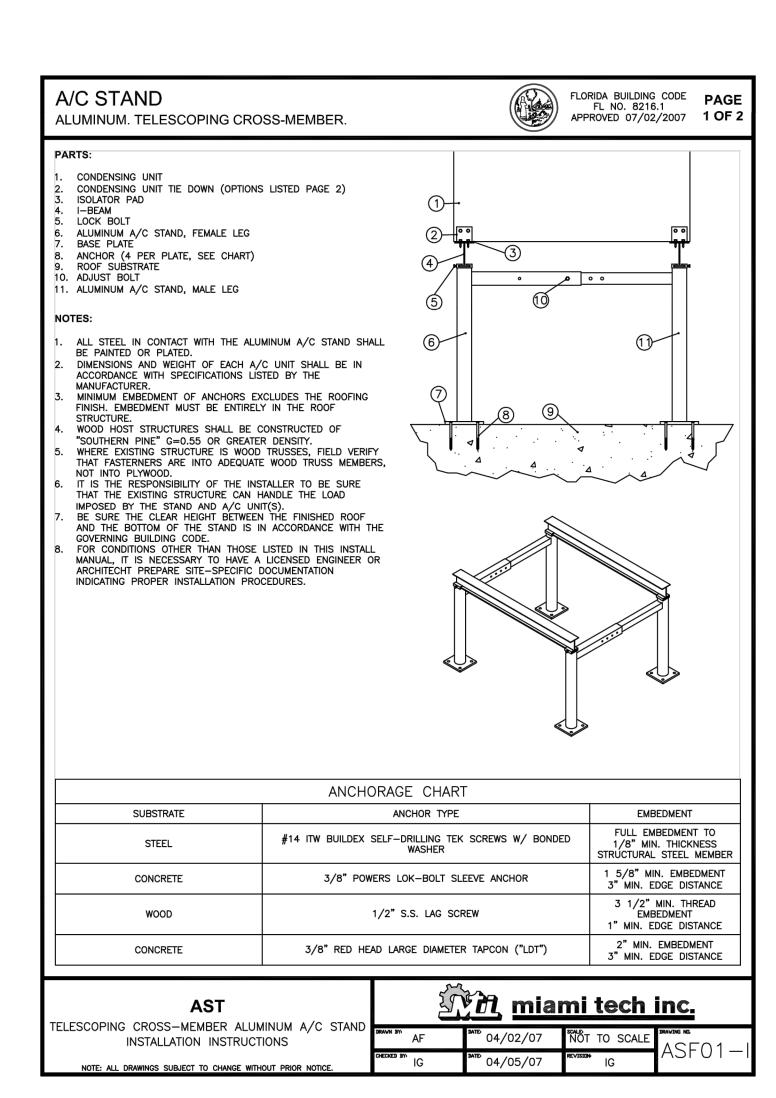



PROFESSIONAL SEAL

ORA FRANKLIN FRAZE, IV

SHEET TITLE

MECHANICAL PLAN



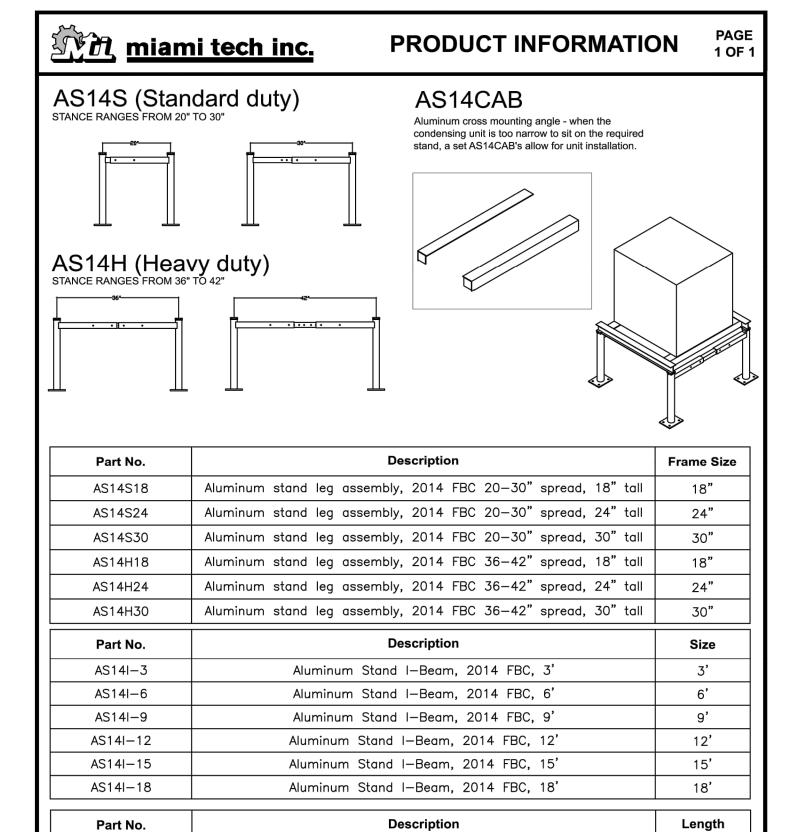

3"x3"x1/8" In—Beam Cross Mount Angle for 30" spread

3"x3"x1/8" In—Beam Cross Mount Angle for 36" spread

3"x3"x1/8" In—Beam Cross Mount Angle for 42" spread

CG

30"

36"

42"

miami tech inc.

NOT TO SCALE

10/13/15

AS14CAB-30

AS14CAB-36


AS14CAB-42

AS14S/AS14H


ALUMINUM CONDENSING UNIT STAND

PRODUCT INFORMATION SHEET

NOTE: ALL DRAWINGS SUBJECT TO CHANGE WITHOUT PRIOR NOTICE

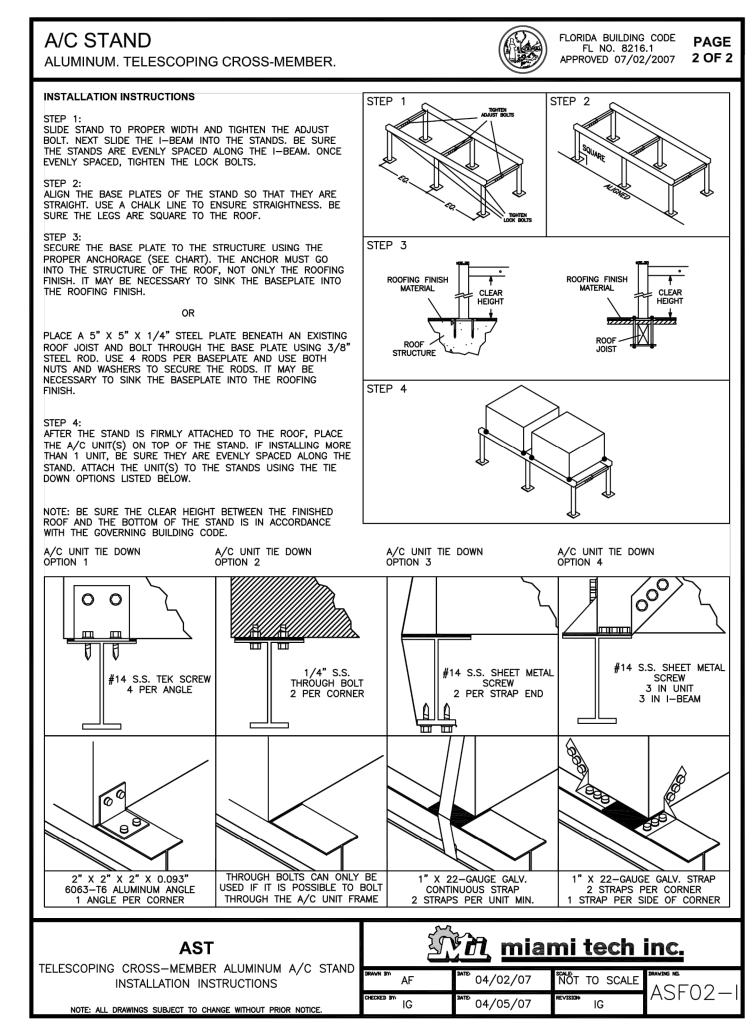


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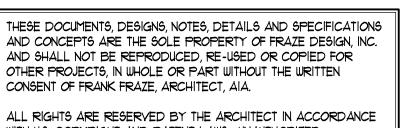

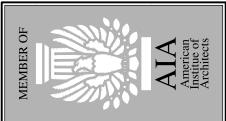
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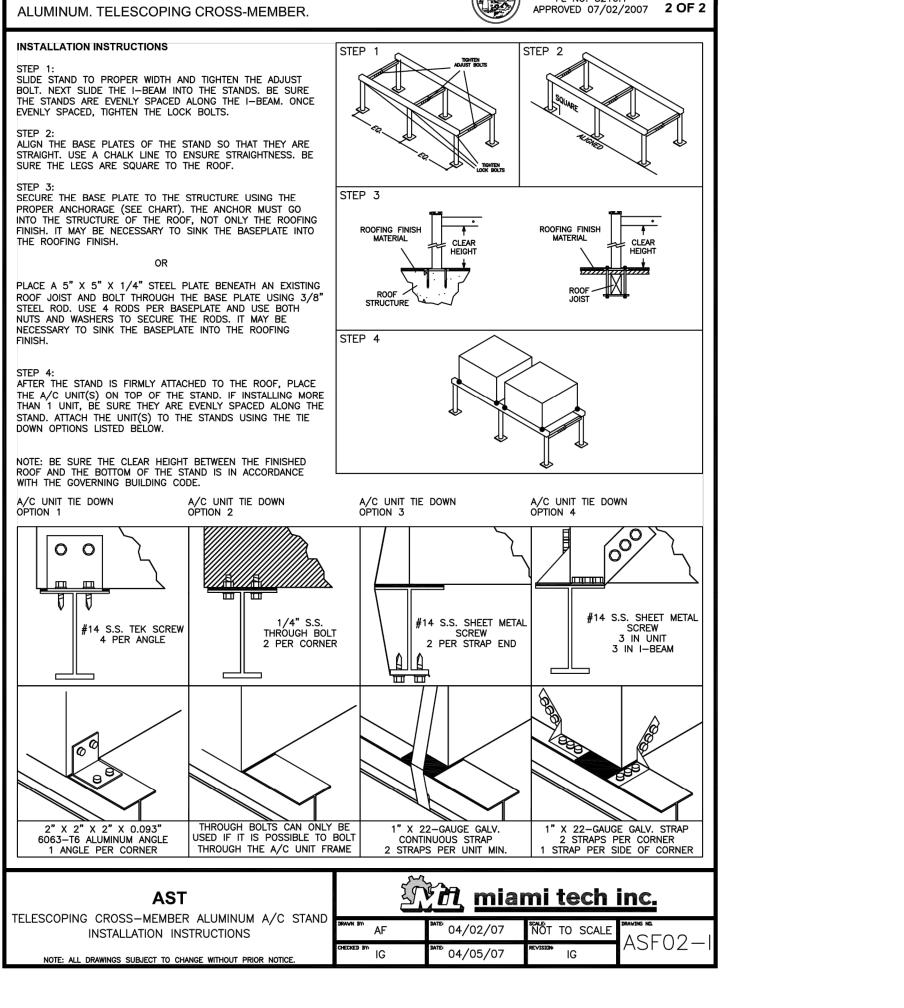
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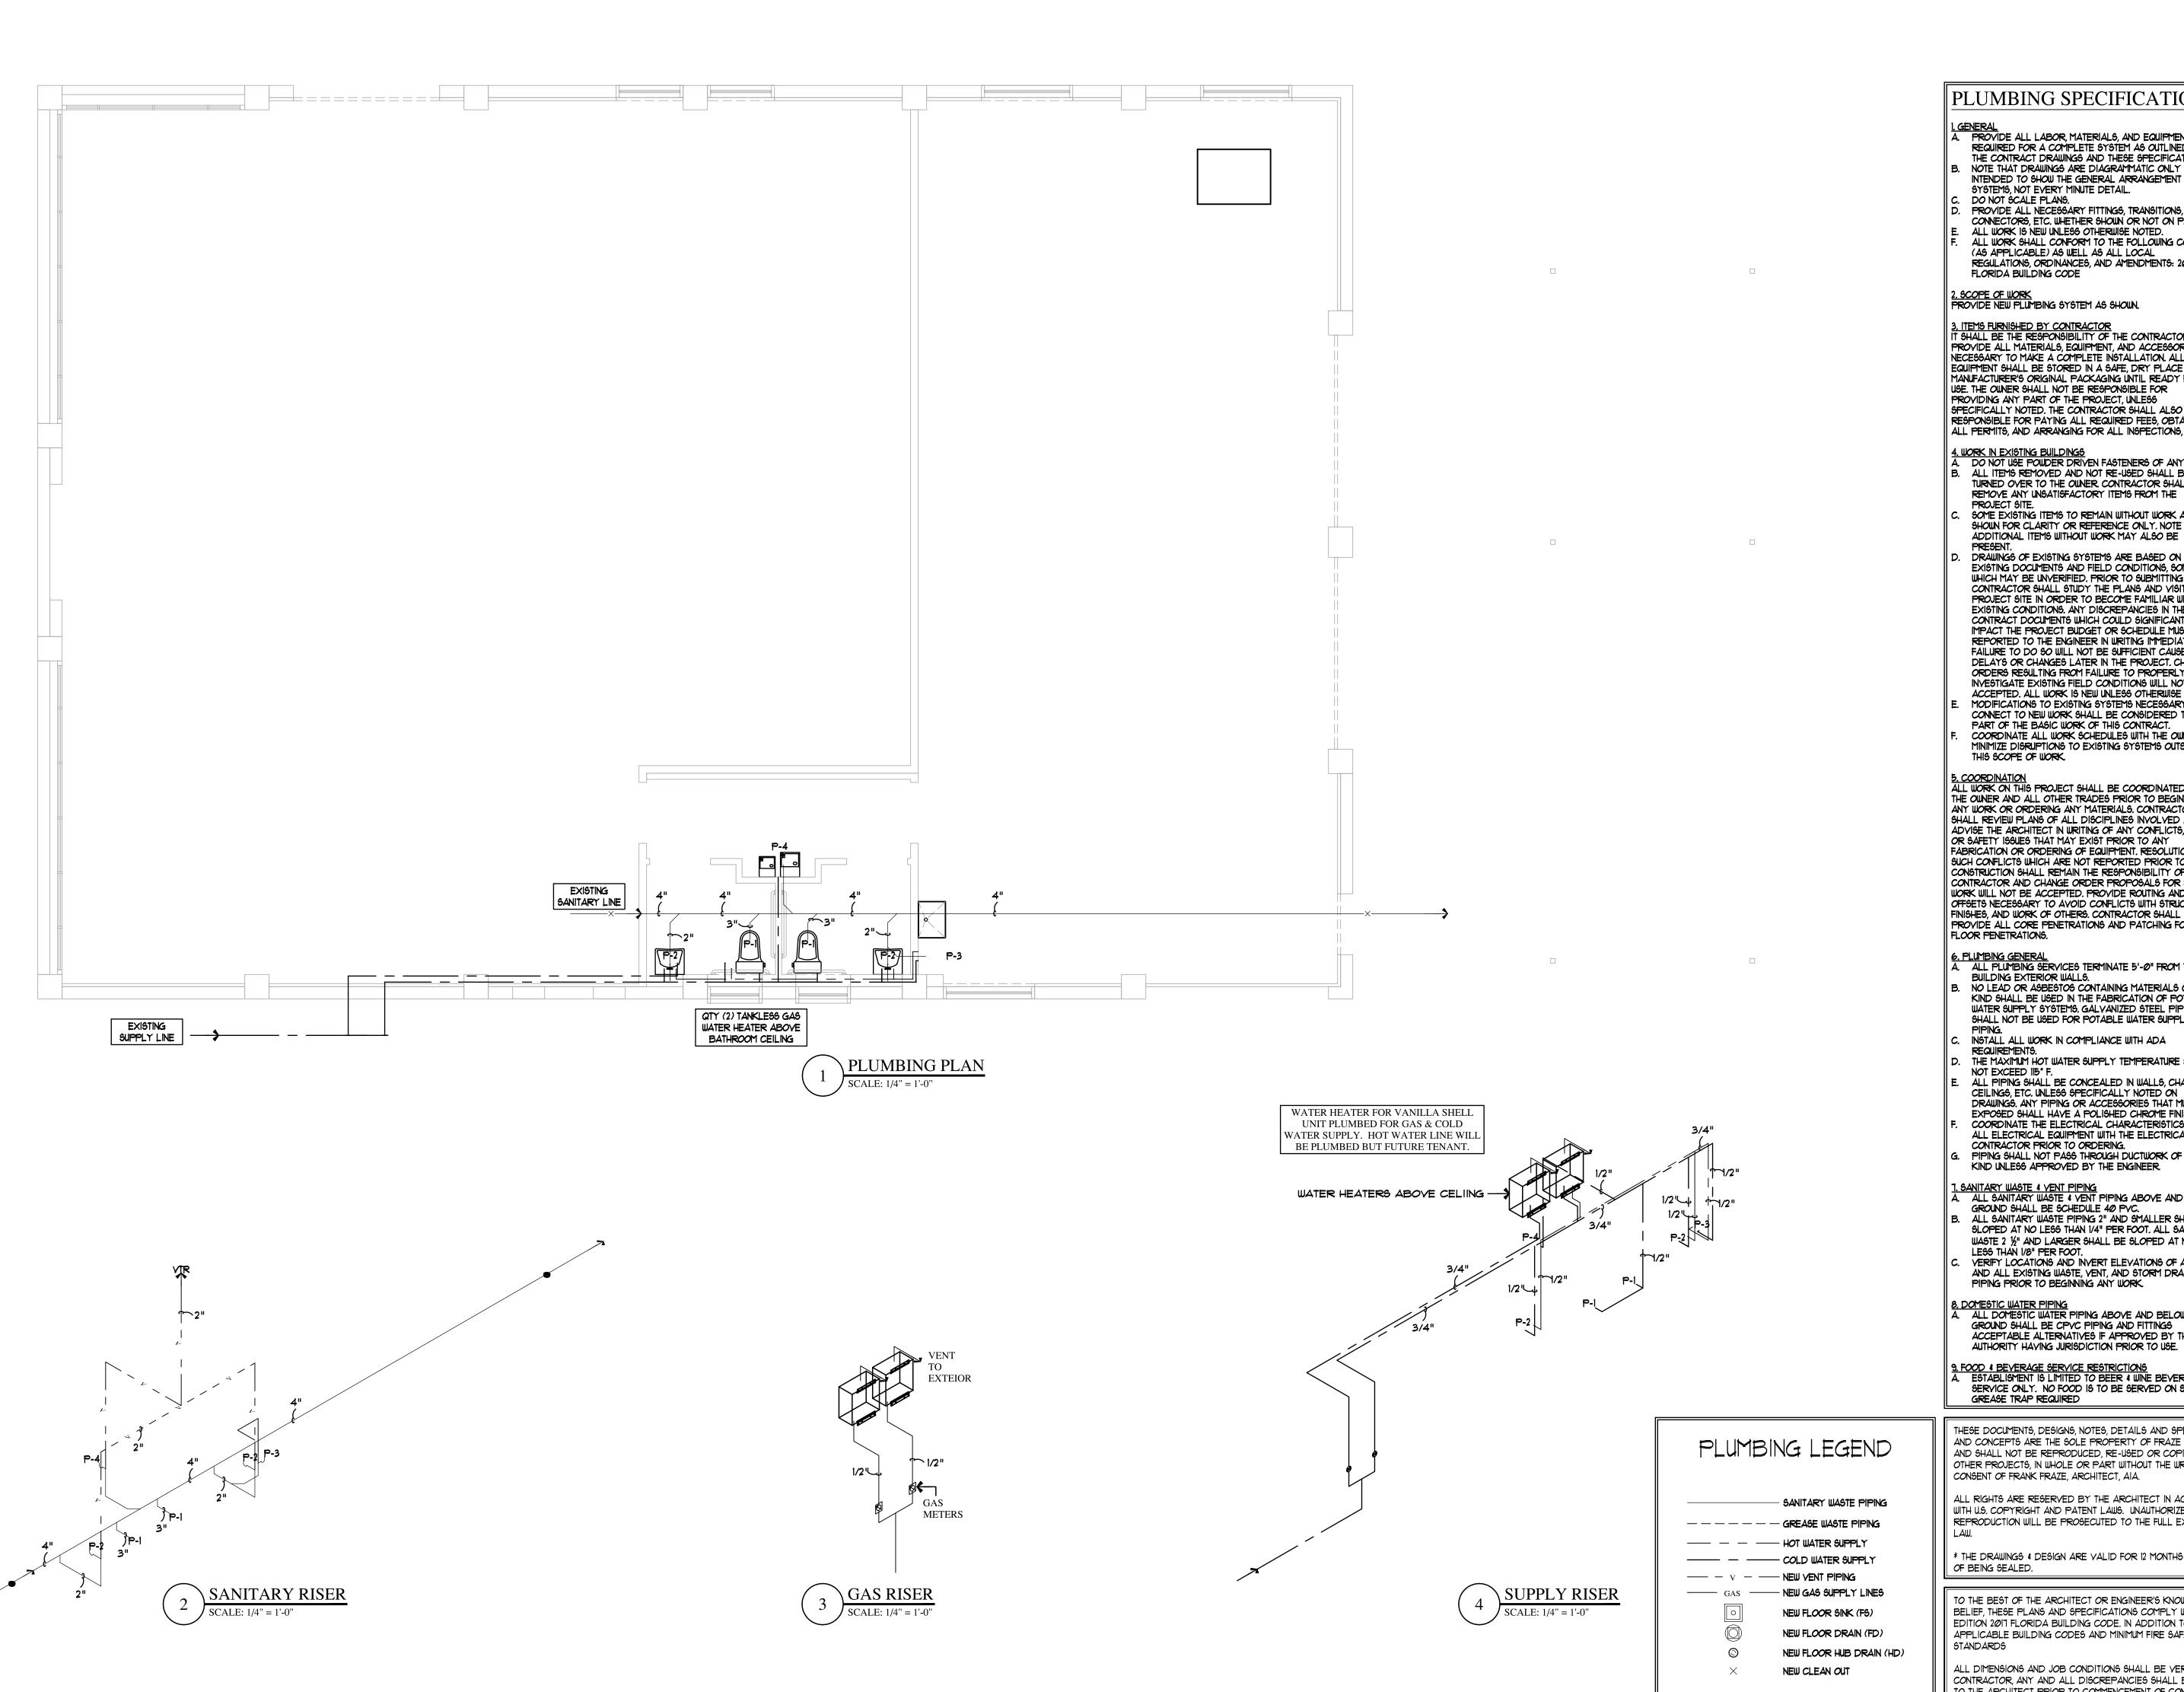
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PLUMBING SPECIFICATIONS

<u>I. GENERAL</u>
A. PROVIDE ALL LABOR, MATERIALS, AND EQUIPMENT REQUIRED FOR A COMPLETE SYSTEM AS OUTLINED IN

THE CONTRACT DRAWINGS AND THESE SPECIFICATIONS. NOTE THAT DRAWINGS ARE DIAGRAMMATIC ONLY AND INTENDED TO SHOW THE GENERAL ARRANGEMENT OF SYSTEMS, NOT EVERY MINUTE DETAIL.

PROVIDE ALL NECESSARY FITTINGS, TRANSITIONS, CONNECTORS, ETC. WHETHER SHOWN OR NOT ON PLANS. ALL WORK IS NEW UNLESS OTHERWISE NOTED. ALL WORK SHALL CONFORM TO THE FOLLOWING CODES (AS APPLICABLE) AS WELL AS ALL LOCAL

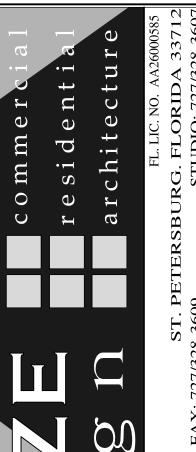REGULATIONS, ORDINANCES, AND AMENDMENTS: 2010 FLORIDA BUILDING CODE

2. SCOPE OF WORK PROVIDE NEW PLUMBING SYSTEM AS SHOWN.

3. ITEMS FURNISHED BY CONTRACTOR
IT SHALL BE THE RESPONSIBILITY OF THE CONTRACTOR TO
PROVIDE ALL MATERIALS, EQUIPMENT, AND ACCESSORIES NECESSARY TO MAKE A COMPLETE INSTALLATION, ALL EQUIPMENT SHALL BE STORED IN A SAFE, DRY PLACE IN THE MANUFACTURER'S ORIGINAL PACKAGING UNTIL READY FOR USE. THE OWNER SHALL NOT BE RESPONSIBLE FOR PROVIDING ANY PART OF THE PROJECT, UNLESS SPECIFICALLY NOTED. THE CONTRACTOR SHALL ALSO BE RESPONSIBLE FOR PAYING ALL REQUIRED FEES, OBTAINING ALL PERMITS, AND ARRANGING FOR ALL INSPECTIONS,

4. WORK IN EXISTING BUILDINGS
A. DO NOT USE POWDER DRIVEN FASTENERS OF ANY TYPE. ALL ITEMS REMOVED AND NOT RE-USED SHALL BE TURNED OVER TO THE OWNER CONTRACTOR SHALL REMOVE ANY UNSATISFACTORY ITEMS FROM THE

SOME EXISTING ITEMS TO REMAIN WITHOUT WORK ARE SHOWN FOR CLARITY OR REFERENCE ONLY. NOTE THAT ADDITIONAL ITEMS WITHOUT WORK MAY ALSO BE

DRAWINGS OF EXISTING SYSTEMS ARE BASED ON EXISTING DOCUMENTS AND FIELD CONDITIONS, SOME OF WHICH MAY BE UNVERIFIED. PRIOR TO SUBMITTING A BID, CONTRACTOR SHALL STUDY THE PLANS AND VISIT THE PROJECT SITE IN ORDER TO BECOME FAMILIAR WITH EXISTING CONDITIONS. ANY DISCREPANCIES IN THE CONTRACT DOCUMENTS WHICH COULD SIGNIFICANTLY IMPACT THE PROJECT BUDGET OR SCHEDULE MUST BE REPORTED TO THE ENGINEER IN WRITING IMMEDIATELY. FAILURE TO DO SO WILL NOT BE SUFFICIENT CAUSE FOR DELAYS OR CHANGES LATER IN THE PROJECT. CHANGE ORDERS RESULTING FROM FAILURE TO PROPERLY INVESTIGATE EXISTING FIELD CONDITIONS WILL NOT BE

MODIFICATIONS TO EXISTING SYSTEMS NECESSARY TO CONNECT TO NEW WORK SHALL BE CONSIDERED TO BE PART OF THE BASIC WORK OF THIS CONTRACT. COORDINATE ALL WORK SCHEDULES WITH THE OWNER TO MINIMIZE DISRUPTIONS TO EXISTING SYSTEMS OUTSIDE THIS SCOPE OF WORK

5. COORDINATION
ALL WORK ON THIS PROJECT SHALL BE COORDINATED WITH THE OWNER AND ALL OTHER TRADES PRIOR TO BEGINNING ANY WORK OR ORDERING ANY MATERIALS. CONTRACTOR SHALL REVIEW PLANS OF ALL DISCIPLINES INVOLVED AND ADVISE THE ARCHITECT IN WRITING OF ANY CONFLICTS, CODE OR SAFETY ISSUES THAT MAY EXIST PRIOR TO ANY FABRICATION OR ORDERING OF EQUIPMENT. RESOLUTION OF SUCH CONFLICTS WHICH ARE NOT REPORTED PRIOR TO CONSTRUCTION SHALL REMAIN THE RESPONSIBILITY OF THE CONTRACTOR AND CHANGE ORDER PROPOSALS FOR SUCH WORK WILL NOT BE ACCEPTED. PROVIDE ROUTING AND OFFSETS NECESSARY TO AVOID CONFLICTS WITH STRUCTURE, FINISHES, AND WORK OF OTHERS. CONTRACTOR SHALL PROVIDE ALL CORE PENETRATIONS AND PATCHING FOR FLOOR PENETRATIONS.

6. PLUMBING GENERAL
A. ALL PLUMBING SERVICES TERMINATE 5'-0" FROM THE BUILDING EXTERIOR WALLS. NO LEAD OR ASBESTOS CONTAINING MATERIALS OF ANY KIND SHALL BE USED IN THE FABRICATION OF POTABLE WATER SUPPLY SYSTEMS. GALVANIZED STEEL PIPING SHALL NOT BE USED FOR POTABLE WATER SUPPLY

INSTALL ALL WORK IN COMPLIANCE WITH ADA

REQUIREMENTS. THE MAXIMUM HOT WATER SUPPLY TEMPERATURE SHALL NOT EXCEED 115° F.

ALL PIPING SHALL BE CONCEALED IN WALLS, CHASES, CEILINGS, ETC. UNLESS SPECIFICALLY NOTED ON DRAWINGS. ANY PIPING OR ACCESSORIES THAT MUST BE EXPOSED SHALL HAVE A POLISHED CHROME FINISH. COORDINATE THE ELECTRICAL CHARACTERISTICS OF

ALL ELECTRICAL EQUIPMENT WITH THE ELECTRICAL CONTRACTOR PRIOR TO ORDERING. PIPING SHALL NOT PASS THROUGH DUCTWORK OF ANY KIND UNLESS APPROVED BY THE ENGINEER

<u>1. SANITARY WASTE & VENT PIPING</u> A. ALL SANITARY WASTE & VENT PIPING ABOVE AND BELOW

GROUND SHALL BE SCHEDULE 40 PVC. ALL SANITARY WASTE PIPING 2" AND SMALLER SHALL BE SLOPED AT NO LESS THAN 1/4" PER FOOT. ALL SANITARY WASTE 2 1/2" AND LARGER SHALL BE SLOPED AT NO

LESS THAN 1/8" PER FOOT. VERIFY LOCATIONS AND INVERT ELEVATIONS OF ANY AND ALL EXISTING WASTE, VENT, AND STORM DRAIN PIPING PRIOR TO BEGINNING ANY WORK

<u>8. DOMESTIC WATER PIPING</u> A. ALL DOMESTIC WATER PIPING ABOVE AND BELOW GROUND SHALL BE CPVC PIPING AND FITTINGS ACCEPTABLE ALTERNATIVES IF APPROVED BY THE

9. FOOD & BEVERAGE SERVICE RESTRICTIONS
A. ESTABLISMENT IS LIMITED TO BEER & WINE BEVERAGE SERVICE ONLY. NO FOOD IS TO BE SERVED ON SITE. NO GREASE TRAP REQUIRED

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MMERIC STREET TESBUR

ACCEPTED. ALL WORK IS NEW UNLESS OTHERWISE NOTED.

MA 200 ST. PROFESSIONAL SEAL AR0014705

ORA FRANKLIN FRAZE, IV

SHEET TITLE PLUMBING PLAN





PLUMBING FIXTURE AND CONNECTION SCHEDULE												
	GENERAL	CONNECTIONS				NOTES						
TAG	DESCRIPTION	MTG. HEIGHT	WASTE	VENT	cw	HW	NOTES					
P-1 (ADA)	WATER CLOSET - H/C FLOOR MOUNTED 2 PIECE FLUSH TANK	FLOOR TO RIM IT!"	3"	2"	1/2"	-	PROFLO MODEL 1403JWH ADA ELONGATED BOWL W/ PROFLO PF5112WHM 1.6 GPF TANK IN WHITE. PROFLO TSCOF200WH ELONGATED BOWL WHITE OPEN FRONT LESS COVER SEAT.					
P-2 (ADA)	LAYATORY WALL HUNG	FLOOR TO RIM 34" MAX	1 ½"	2"	1/2"	1/2"	PROFLO 5514WH WALL HUNG LAVATORY WITH PROFLO W64744CP SINGLE LEVER FAUCET. PVD SLIP-JOINT P-TRAP. CRI912CP ANGLE STOP AND PEX SUPPLIES. ALL FAUCETS ATTACHED TO PUBLIC USE LAVATORIES SHALL HAVE WATER TEMPERATURE LIMITING DEVICES THAT ARE IN ACCORDANCE WITH ASSE 10/70 OR CSA B125.3					
P-3	SERVICE SINK	N/A	1 ½"	2"	1/2"	1/2"	PROFLO \$RI51562 I5 X I5 \$TAINLESS STEEL BAR SINK W/ PROFLO W\$336M CHROME PLATED, TWO HANDLE, METAL WING BAR FAUCET. PVD \$LIP-JOINT P-TRAP. CR!912CP ANGLE STOP AND PEX SUPPLIES.					
P-4	DRINKING FOUNTAIN	FLOOR TO RIM IT!"	1 ½"	2"	1/2"	-	PROFLO PF1805WH ADA 0.5/1.0 GALLONS PER FLUSH ₹ TSPUD LESS URINAL					

GENERAL NOTES

PROVIDE MCGUIRE PRO-WRAP INSULATION KIT FOR DRAIN, TRAP, & SUPPLY ON ALL ADA SINKS AND LAVATORIES.

2. ALL DRAIN AND VENT LINES TO BE PYC

TANKLESS WATERHEATER

B. PROVIDE ALL BOLT CAPS, STRAINERS, STOPS, SUPPLIES, TRAPS, ETC. FOR A COMPLETE INSTALLATION. 4. PROVIDE DEEP SEAL TRAPS FOR ALL DRAINS AND FLOOR SINKS.

N/A

5. PROVIDE TRAP PRIMERS FOR ALL FLOOR DRAINS. 6. ALL WATER LINES TO BE PEX (CROSS-LINKED POLYETHYLENE)

1. ALL ICE MACHINES, DISHWASHERS, & BEVERAGE DISPENSERS CONNECTED TO THE WATER SUPPLY SHALL HAVE A PROTECTED FROM BACKFLOW & CONTAMINATION BY A

3/4"

BACKFLOW PREVENTER CONFORMING TO ASSE 1022 OR AIR GAP

GAS FIXTURE SCHEDULE												
		ptill.	QT Y	MIN PIPE SIZE OFF MAIN BRANCH	NOTES							
MODEL/DESCRIPTION	BRAND MODEL					B†u's						
TANKLESS WH	N/A	N/A	180,000	2	1/2"							
	TOTA	AL GAS DEMAND	360,00	Ø								
	GAS SPECIFICATI	• PIPE SIZING SHALL BE IN ACCORDANCE WITH										
GAS	NATURAL	FBC: FUEL GAS TABLE 402.4(5) • GAS LINE PIPING WILL BE SCH 40 METALLIC PIPE										
INLET PRESSURE	2.0 psi											
PRESSURE DROP		lø psi		• 9'-10" DISTANCE TO FARTHEST APPLIANCE FROM METER								
SPECIFIC GRAVITY		060										

PLUMBING SPECIFICATIONS

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4. WORK IN EXISTING BUILDINGS A. DO NOTUSE POWDER DRIVEN FASTENERS OF ANY TYPE. ALL ITEMS REMOVED AND NOT RE-USED SHALL BE TURNED OVER TO THE OWNER CONTRACTOR SHALL REMOVE ANY UNSATISFACTORY ITEMS FROM THE

PROJECT SITE. SOME EXISTING ITEMS TO REMAIN WITHOUT WORK ARE SHOWN FOR CLARITY OR REFERENCE ONLY. NOTE THAT ADDITIONAL ITEMS WITHOUT WORK MAY ALSO BE

DRAWINGS OF EXISTING SYSTEMS ARE BASED ON EXISTING DOCUMENTS AND FIELD CONDITIONS, SOME OF WHICH MAY BE UNVERIFIED. PRIOR TO SUBMITTING A BID, CONTRACTOR SHALL STUDY THE PLANS AND VISIT THE PROJECT SITE IN ORDER TO BECOME FAMILIAR WITH EXISTING CONDITIONS. ANY DISCREPANCIES IN THE CONTRACT DOCUMENTS WHICH COULD SIGNIFICANTLY IMPACT THE PROJECT BUDGET OR SCHEDULE MUST BE REPORTED TO THE ENGINEER IN WRITING IMMEDIATELY. FAILURE TO DO SO WILL NOT BE SUFFICIENT CAUSE FOR DELAYS OR CHANGES LATER IN THE PROJECT. CHANGE ORDERS RESULTING FROM FAILURE TO PROPERLY INVESTIGATE EXISTING FIELD CONDITIONS WILL NOT BE ACCEPTED. ALL WORK IS NEW UNLESS OTHERWISE NOTED.

MODIFICATIONS TO EXISTING SYSTEMS NECESSARY TO CONNECT TO NEW WORK SHALL BE CONSIDERED TO BE PART OF THE BASIC WORK OF THIS CONTRACT. COORDINATE ALL WORK SCHEDULES WITH THE OWNER TO MINIMIZE DISPUPTIONS TO EXISTING SYSTEMS OUTSIDE THIS SCOPE OF WORK

5. COORDINATION
ALL WORK ON THIS PROJECT SHALL BE COORDINATED WITH THE OWNER AND ALL OTHER TRADES PRIOR TO BEGINNING ANY WORK OR ORDERING ANY MATERIALS. CONTRACTOR SHALL REVIEW PLANS OF ALL DISCIPLINES INVOLVED AND ADVISE THE ARCHITECT IN WRITING OF ANY CONFLICTS, CODE OR SAFETY ISSUES THAT MAY EXIST PRIOR TO ANY FABRICATION OR ORDERING OF EQUIPMENT. RESOLUTION OF SUCH CONFLICTS WHICH ARE NOT REPORTED PRIOR TO CONSTRUCTION SHALL REMAIN THE RESPONSIBILITY OF THE CONTRACTOR AND CHANGE ORDER PROPOSALS FOR SUCH WORK WILL NOT BE ACCEPTED. PROVIDE ROUTING AND OFFSETS NECESSARY TO AVOID CONFLICTS WITH STRUCTURE, FINISHES, AND WORK OF OTHERS. CONTRACTOR SHALL PROVIDE ALL CORE PENETRATIONS AND PATCHING FOR FLOOR PENETRATIONS.

6. PLUMBING GENERAL A. ALL PLUMBING SERVICES TERMINATE 5'-0" FROM THE

- BUILDING EXTERIOR WALLS. NO LEAD OR ASBESTOS CONTAINING MATERIALS OF ANY KIND SHALL BE USED IN THE FABRICATION OF POTABLE WATER SUPPLY SYSTEMS. GALVANIZED STEEL PIPING SHALL NOT BE USED FOR POTABLE WATER SUPPLY
- INSTALL ALL WORK IN COMPLIANCE WITH ADA
- REQUIREMENTS. THE MAXIMUM HOT WATER SUPPLY TEMPERATURE SHALL
- NOT EXCEED 115° F. ALL PIPING SHALL BE CONCEALED IN WALLS, CHASES, CEILINGS, ETC. UNLESS SPECIFICALLY NOTED ON DRAWINGS. ANY PIPING OR ACCESSORIES THAT MUST BE EXPOSED SHALL HAVE A POLISHED CHROME FINISH.
- COORDINATE THE ELECTRICAL CHARACTERISTICS OF ALL ELECTRICAL EQUIPMENT WITH THE ELECTRICAL CONTRACTOR PRIOR TO ORDERING. PIPING SHALL NOT PASS THROUGH DUCTWORK OF ANY

1. SANITARY WASTE & VENT PIPING. A. ALL SANITARY WASTE & VENT PIPING ABOVE AND BELOW

KIND UNLESS APPROVED BY THE ENGINEER

GROUND SHALL BE SCHEDULE 40 PVC. ALL SANITARY WASTE PIPING 2" AND SMALLER SHALL BE SLOPED AT NO LESS THAN 1/4" PER FOOT, ALL SANITARY WASTE 2 ½" AND LARGER SHALL BE SLOPED AT NO

LESS THAN 1/8" PER FOOT. VERIFY LOCATIONS AND INVERT ELEVATIONS OF ANY AND ALL EXISTING WASTE, VENT, AND STORM DRAIN PIPING PRIOR TO BEGINNING ANY WORK

<u>8. DOMESTIC WATER PIPING</u> A. ALL DOMESTIC WATER PIPING ABOVE AND BELOW GROUND SHALL BE CPVC PIPING AND FITTINGS ACCEPTABLE ALTERNATIVES IF APPROVED BY THE AUTHORITY HAVING JURISDICTION PRIOR TO USE.

9. FOOD & BEVERAGE SERVICE RESTRICTIONS
A. ESTABLISMENT IS LIMITED TO BEER & WINE BEVERAGE SERVICE ONLY. NO FOOD IS TO BE SERVED ON SITE. NO GREASE TRAP REQUIRED

PLUMBING LEGEND

SANITARY WASTE PIPING ---- --- --- GREASE WASTE PIPING --- HOT WATER SUPPLY ----- - COLD WATER SUPPLY --- - \vee - - NEW YENT PIPING ---- GAS ---- NEW GAS SUPPLY LINES NEW FLOOR SINK (FS)

NEW FLOOR DRAIN (FD) NEW FLOOR HUB DRAIN (HD) NEW CLEAN OUT

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ALL DIMENSIONS AND JOB CONDITIONS SHALL BE VERIFIED BY THE CONTRACTOR, ANY AND ALL DISCREPANCIES SHALL BE REPORTED TO THE ARCHITECT PRIOR TO COMMENCEMENT OF CONSTRUCTION.

ISSUE DATE REVIEW | 05/21/19 MF Ø5/21/19 MF REY. REY. REY. REY.



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WATER HEATER PLAN, FIXTURE & GAS SCHEDULES