
WALEED SADAQAT RESIDENCE- STORAGE SHED

30 QUEEN STREET, MORRISTON, (PUSLINCH) ONTARIO

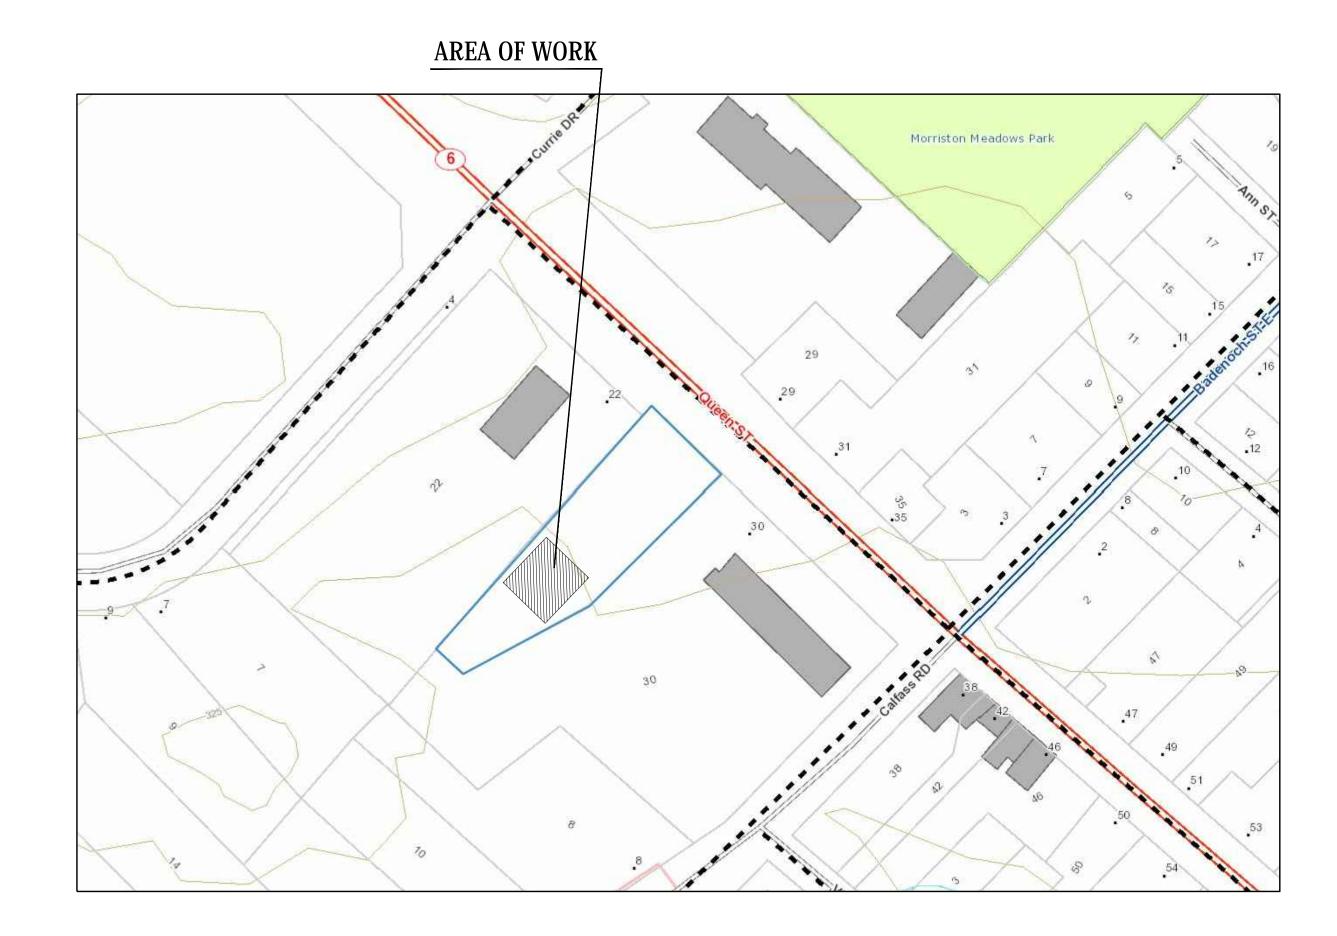



GENERAL REQUIREMENTS

- 01. ALL WORK CALLED FOR ON THESE DRAWINGS SHALL BE IN COMPLIANCE WITH CODES, RULES AND REGULATIONS OF ALL GOVERNMENTAL AGENCIES HAVING JURISDICTION. THIS INCLUDES BUT IS NOT LIMITED TO THE ONTARIO BUILDING CODE, THE ONTARIO ELECTRICAL SAFETY CODE, FIRE PROTECTION CODES AND THE ACCESSIBILITY GUIDELINES.
- 02. THE CONTRACTOR MUST COMPLY WITH ANY AND ALL RULES SET BY EITHER THE BUILDING OWNER AND OR BUILDING'S MANAGEMENT.
- 03. THE CONTRACTOR IS TO REMOVE ALL DEBRIS ASSOCIATED WITH THE DEMOLITION / CONSTRUCTION OF THE PROJECT. THE CONSTRUCTION SITE 03. STEEL SCREWS TO COMPLY WITH ASTM C1002 AND C954. IS TO BE BROOM SWEPT AT THE CONCLUSION OF EACH WORKING DAY.
- 04. THE CONTRACTOR IS TO SUPPLY ALL MATERIAL AND LABOR NECESSARY TO COMPLETE THE WORK DESCRIBED HEREIN.
- 05. THE CONTRACTOR IS RESPONSIBLE FOR SECURING THE CONSTRUCTION SITE AND FOR THE STORAGE OF MATERIALS.
- 06. THE CONTRACTOR WILL SCHEDULE THE USE AND OR SHUT DOWN OF BUILDING SERVICES WITH THE BUILDING OWNER AND OR MANAGEMENT CONTRACTOR SHOULD BE PREPARED TO PERFORM ANY WORK RELATED TO THE SAME DURING NON BUSINESS HOURS.
- 07. THE CONTRACTOR SHALL SCHEDULE AND OBTAIN PERMISSION FROM THE BUILDING OWNER AND OR MANAGEMENT FOR ACCESS TO SPACES OUTSIDE OF THE CONSTRUCTION SITE. THESE SPACES INCLUDE, BUT ARE

 07. STEEL FRAMING SHALL BE INSTALLED IN ACCORDANCE WITH ASTM C754, NOT LIMITED TO, MECHANICAL ROOMS, ROOFS, ELECTRICAL ROOMS, ADJACENT TENANTS, AND FLOORS ABOVE AND BELOW THE CONSTRUCTION. CONTRACTORS SHOULD BE PREPARED TO PERFORM ANY WORK RELATED TO THE SAME DURING NON BUSINESS HOURS.
- 08. THE CONTRACTOR IS RESPONSIBLE FOR PROTECTING ALL COMPLETED WORK AND AREAS WITHIN THE BUILDING USED FOR ACCESS TO THE CONSTRUCTION SITE. THIS INCLUDES, BUT IS NOT LIMITED TO, PUBLIC CORRIDORS, ELEVATORS, LOBBIES, LOADING DOCKS, AND TOILET
- 09. IT IS THE RESPONSIBILITY OF THE CONTRACTOR TO BRING TO THE ATTENTION OF THE ARCHITECT ANY DISCREPANCIES WITH THESE DOCUMENTS AND ACTUAL FIELD CONDITIONS. THE CONTRACTOR MUST BRING THIS TO THE ATTENTION OF THE ARCHITECT DURING THE BIDDING PROCESS (IF APPLICABLE).

FACILITIES. CONTRACTOR IS ALSO TO CLEAN THE SAME AFTER USE.

- 10. WHEN SUBMITTALS ARE CALLED FOR ON THE DOCUMENTS, THEY ARE FIRST TO BE REVIEWED BY THE GENERAL CONTRACTOR. THE SUBMITTAL MUST BE STAMPED INDICATING THE DATE WHEN RECEIVED BY THE GENERAL CONTRACTOR. AFTER THE GENERAL CONTRACTORS' REVIEW, SUBMITTALS CAN THEN BE ISSUED TO THE ARCHITECT AND OR ENGINEER. ALL SUBMITTALS ARE TO BE SUPPLIED TO THE ARCHITECT IN TRIPLICATE. 12. WHERE A PARTITION MEETS A BUILDING CURTAIN WALL MULLION, THE 11. THE CONTRACTOR IS TO WARRANTY ALL WORK, MATERIALS AND
- EQUIPMENT FOR A PERIOD OF ONE YEAR STARTING AT THE DATE OF SUBSTANTIAL COMPLETION.
- 12. THE CONTRACTOR IS RESPONSIBLE FOR FINAL FINE CLEANING AT THE COMPLETION OF THE JOB PRIOR TO OCCUPANCY.
- 13. CONTRACTOR SHALL BE RESPONSIBLE FOR REPLACING DAMAGED SPRAY-ON FIREPROOFING FROM DISTURBED STRUCTURAL STEEL (IF APPLICABLE)

INTERIOR METAL STUD & GYPSUM WALL **BOARD PARTITIONS**

- 01. GYPSUM WALL BOARD IS TO BE PROVIDED IN THE THICKNESS SPECIFIED ON THE PLANS. GYPSUM BOARD SHALL COMPLY WITH ASTM C36.
- 02. GYPSUM WALL BOARD SHALL BE FASTENED TO METAL STUDS VERTICALLY WITH No. 6 SCREWS WITH TAPERED HEADS. SCREWS ARE TO

 03. CROSS TEES ARE TO BE IN 24" AND 48" LENGTHS. 24" LENGTHS ARE TO PENETRATE FRAMING NOT LESS THAN 1/4". MAXIMUM SPACING OF SCREWS SHALL BE 12" FOR $\frac{1}{2}$ AND $\frac{5}{8}$ GYPSUM BOARD.
- 04. JOINT REINFORCING TAPE AND COMPOUND SHALL CONFORM TO ASTM
- C474, C475. ASBESTOS FREE. 05. STEEL STUDS ARE TO BE NON LOAD BEARING SUPPLIED IN THE THICKNESS SPECIFIED ON THE PLANS. THEY ARE TO COMPLY WITH ASTM C645. CONTRACTOR IS TO SUPPLY TOP AND BOTTOM TRACKS AND RUNNERS. 06. HEIGHT AND SPACING LIMITATIONS FOR ONE LAYER OF GYPSUM BOARD
- 25 GAUGE 2 1/2" THICKNESS 16" OC = 10'-9" 25 GAUGE 2 1/2" THICKNESS 24" OC = 9'-6" 25 GAUGE 3 5/8" THICKNESS 16" OC = 14'-0"
- 25 GAUGE 3 5/8" THICKNESS 24" OC = 12'-3"
- AND C1007. 08. WHEN THE PLANS INDICATE THAT A PARTITION IS TO RUN FROM FLOOR FLOOR SLAB TO THE DECK ABOVE. GYPSUM BOARD IS TO BE CUT IN AND AROUND CELLULAR FLOOR DECK, FRAMING AND ANY OTHER
- OBSTRUCTIONS. 09. WHEN THE PLANS INDICATE A FIRE RATED PARTITION, THE PARTITION IS TO BE CONSTRUCTED IN ACCORDANCE WITH UNDER WRITERS LABORATORY'S DESIGN CRITERIA FOR THE RATING AND CONSTRUCTION
- TYPE SPECIFIED. 10. WHEN SPECIFIED ON THE PLANS, SOUND ATTENUATING INSULATION IS TO FILL THE ENTIRE WALL CAVITY. 3 5/8" WALL CAVITIES ARE TO HAVE A STC RATING OF 50. 2 1/2" WALL CAVITIES ARE TO HAVE A STC RATING OF 47. A SILICONE BEAD IS TO BE USED TO SEAL ALL WALL PENETRATIONS AND TO SEAL THE WALL TO THE FLOOR, THE WALL TO THE CEILING AND THE WALL
- 11. ALL GYPSUM BOARD SURFACES ARE TO BE TAPED, SPACKLED AND SANDED UNTIL SMOOTH AND ARE TO BE MADE READY TO RECEIVE THE SPECIFIED WALL FINISH.

TO THE STRUCTURAL DECK ABOVE.

- MULLION CONDITION IS TO MATCH THOSE EXISTING IN THE BUILDING. IF NO MULLION CONDITIONS EXIST THE WALL IS TO BE EXTENDED TO THE MULLION BY NOTCHING OUT THE WALL BOARD OR A BY WAY OF A BREAK METAL CLOSURE PIECE.
- 13. ALL GYPSUM BOARD SURFACES TO BE TAPED, PLASTERED, SANDED AND FINISHED READY TO RECEIVE PAINT / WALL PAPER / FINISHES AS INDICATED ON INTERIOR DESIGN DRAWINGS (IF INCLUDED). FOR ALL FINISH INFORMATION COORDINATE WITH OWNER.
- 14. GYPSUM BOARD SHALL BE WATER & MOLD RESIST (WMR) IN ALL KITCHENS, WASHROOMS OR OTHER APPROPRIATE AREAS.

SUSPENDED CEILING SYSTEM

- 01. THE SUSPENDED CEILING SYSTEM IS TO BE OF THE TYPE, COLOR AND
- MANUFACTURER SPECIFIED ON THE DRAWINGS. 02. MAIN RUNNERS ARE TO HAVE A MAXIMUM LENGTH OF 12'-0" AND A LOAD CARRYING CAPACITY OF NOT LESS THAN 12 LBS../LF. HANGER SPACING IS TO BE 4'-0" OC. HANGER WIRE IS TO BE 12 GAUGE.
- HAVE A LOAD CARRYING CAPACITY OF NOT LESS THAN 35 LBS./LF AND 48" LENGTHS ARE TO HAVE A LOAD CARRYING CAPACITY OF NOT LESS THAN
- 12.5 LBS./LF. 04. EXPOSED TEE SYSTEMS ARE TO MEET ASTM CLASS INTERMEDIATE-DUTY. 05. EXPOSED TEE SYSTEMS ARE TO BE INSTALLED IN ACCORDANCE WITH ALL JURISDICTIONAL AUTHORITIES AND ARE TO MEET LOCAL SEISMIC ZONE
- CRITERIA. 06. ALL PERIMETER CLOSER ANGLES OR CHANNELS MUST PROVIDE A SUPPORT LEDGE OF 7/8 INCH. A TERMINAL END OF A GRID MEMBER OR TILE MUST REST ON THE LEDGE OR MOLDING WITH AT LEAST 3/8" CLEARANCE FROM AN EDGE OR WALL. ALL CEILING PENETRATIONS COLUMNS, SPRINKLERS, ETC. ARE TO BE CONSIDERED PERIMETER
- 07. AT WALL CLOSURE LEDGES, THE CROSS RUNNER AND MAIN RUNNER ENDS SHALL BE PREVENTED FROM SPREADING APART FROM EACH OTHER. PERMANENT ATTACHMENT, POP RIVETS, FOR GRID ALIGNMENT PURPOSES
- SHALL NOT BE PERMITTED. SLAB TO DECK ABOVE, THE ENTIRE PARTITION ASSEMBLY IS TO RUN FROM 08. THE CEILING SYSTEM IS TO BE INSTALLED AT THE ELEVATION SPECIFIED,
 - THE CEILING PLANE IS TO BE LEVEL. 09. IN RENOVATION PROJECTS EXISTING CEILING GRIDS ARE TO BE RETROFIT
 - TO THE ABOVE CRITERIA. 10. DEVICES INSTALLED IN THE CEILING, SUCH AS, DOWN LIGHTS, SPRINKLER

 02. DOORS TO ALL ACCESSIBLE SPACES SHALL HAVE ACCESSIBLE HARDWARE HEADS, DIFFUSERS, ETC. ARE TO BE INSTALLED IN THE CENTER OF TILES.
 - 11. LIGHT FIXTURES ARE TO BE ATTACHED TO GRID WITH EARTHQUAKE CLIPS. 12. CONTRACTOR TO SUBMIT MANUFACTURE'S CUT SHEETS ON CEILING SYSTEM ALONG WITH A TILE AND GRID SAMPLE TO ARCHITECT FOR APPROVAL.
 - GRID: ASTM C635, HEAVY DUTY, STEEL EXPOSED 9/16" T, DOUBLE WEB, ELECTRO-GALVANIZED COMMERCIAL QUALITY, COLD ROLLED STEEL.

ACCESSORIES: STABILIZER BARS, CLIPS, AND SPLICES. GRID FINISH: PRE-PAINTED WHITE SATIN FINISH. SUPPORT SYSTEM: HOT OR COLD ROLLED GALVANIZED STEEL CHANNELS; GALVANIZED HANGER WIRE, SIZE AND TYPE TO SUIT APPLICATION TO

RIGIDLY SECURE ACOUSTIC CEILING SYSTEM INCLUDING INTEGRAL MECHANICAL AND ELECTRICAL COMPONENTS WITH MAXIMUM DEFLECTION EDGE MOULDINGS: METAL CHANNEL WITH EXPOSED FLANGE TO MATCH

HOLD-DOWN CLIPS: MANUFACTURER'S STANDARD RETENTION CLIPS TO SUIT CONDITIONS SPECIFIED.

THE GENERAL CONDITIONS OF THE CONTRACT FOR CONSTRUCTION (O.B.C 2012) ARE A PART OF


DO NOT SCALE THESE DRAWINGS. VERIFY ALL DIMENSIONS AND CONDITIONS IN THE FIELD. ANY DISCREPANCIES IN THESE DRAWINGS SHALL BE BROUGHT TO THE ATTENTION OF THE ARCHITECT

ALL WORK SHALL CONFORM TO THE 2012 EDITION OF THE ONTARIO BUILDING CODE, AND ALL

- ALL PROPOSED SUBSTITUTIONS SHALL BE APPROVED BY THE ARCHITECT, IN WRITING, PRIOR TO
- BUILDING PERMIT (IF APPLICABLE). THIS INCLUDES, BUT IS NOT LIMITED TO ELECTRICAL,
- UNLESS OTHERWISE NOTED. SEE SCOPE OF WORK FOR EXCEPTIONS
- GRAPHIC AND WRITTEN INFORMATION ON DRAWINGS SHALL BE COORDINATED WITH ALL TRADES
- ALL MATERIALS STAGED TO BE USED FOR CONSTRUCTION SHALL BE PROTECTED FROM EXCESSIVE MOISTURE. IF THEY ARE EXPOSED TO MOISTURE THEY SHOULD BE ADEQUATELY DRIED BEFORE
- ALL PAINTS, ADHESIVES, COATINGS AND SEALANTS USED INSIDE THE BUILDING SHALL HAVE A LOW
- CONSTRUCTION PROJECT MANAGER TO COORDINATE ALL UTILITY CONNECTIONS WITH RESPECTIVE

PROJECT CONTACTS:	MAINTAIN INTEGRITY OF ALL EXISTING FIRE SEPARATIONS (TYPICAL).
OWNER MEHMOOD BUTT PHONE :(705) 977-1786	ALL CONSTRUCTION TO MEET ONTARIO BUILDING CODE REQUIREMENTS.
EMAIL :LAKEFIELDESSO@GMAIL.COM	ALL THE EXITS AND ACCESS TO EXITS SHALL BE CLEARLY VISIBLE AND ACCESSIBLE AT ALL TIMES.
ARCHITECT MEHBOOB BANGASH ARCHITECTS INC. 8140 HORNBY ROAD, HALTON HILLS, ON LOP 1E0 PHONE :(416) 444.3162 Email :MEHBOOB@MBARCH.CA	
MECH. / ELEC. ENGINEER	
THE NB PARTNERSHIP 12 BRADWORTHY COURT, TORONTO, ON	ALL THE EXITS AND ACCESS TO EXITS SHALL BE CLEARLY VISIBLE AND ACCESSIBLE AT ALL TIMES.

ONTARIO BUILDING CODE DATA MATRIX ONTARIO BUILDING CODE DATA MATRIX PARTS 3 & 9 **OBC** Reference] Part 11 □ Part 3 X Part 9 PROJECT DESCRIPTION: ☐ Addition CONSTRUCTION AN ACCESSORY 1.1.2. [A] **BUILDING TO A HOUSE** Alteration 9.10.1.3 Change of use MAJOR OCCUPANCY : GROUP 'C' 3.1.2.1.(1) 2.2 OCCUPANCY OF SUITE COVERED UNDER THIS PERMIT : C (RESIDENTIAL) 1.4.1.2. [A] BUILDING AREA (m²): EXISTING 0 NEW 140 TOTAL 140 1.1.3.2. AREA OF SUITE COVERED UNDER THIS PERMIT APPLICATION (m²): 140 NUMBER OF STOREYS ABOVE GRADE 1 BELOW GRADE 0 3.2.1.1. & 1.1.3.2. 9.10.4. HEIGHT OF BUILDING (m) ABOVE GRADE 5 NUMBER OF STREETS/ACCESS ROUTES 1 3.2.5.4 TO 3.2.5.6 BUILDING CLASSIFICATION RESIDENTIAL 3.2.2.28 9.10.8.2. 3.2.2.28 STANDPIPE SYSTEM REQUIRED 9.10.18. FIRE ALARM SYSTEM REQUIRED ☐ Yes 🗓 No ☐ Existing 3.2.4. WATER SERVICE/SUPPLY IS ADEQUATE HIGH BUILDING ☐ Yes 🕱 No PERMITTED CONSTRUCTION ☐ Combustible ☐ Non-combustible ☒ both 9.10.6. 9.10.4.1 MEZZANINE AREA WITHIN SUITE (m2) N/A 6 OCCUPANT LOAD BASED ON __ m2/person TOTAL OCCUPANT LOAD = 2BARRIER-FREE DESIGN ☐ Yes x No (Not required) HAZARDOUS SUBSTANCES ☐ Yes 3.3.1.2 & 3.3.1.19 3.2.2.25 & 3.2.1.4 9.10.8. REQUIRED FIRE RESISTANCE RATING 9.10.14. 20 | SPATIAL SEPARATION - CONSTRUCTION OF EXTERIOR WALLS

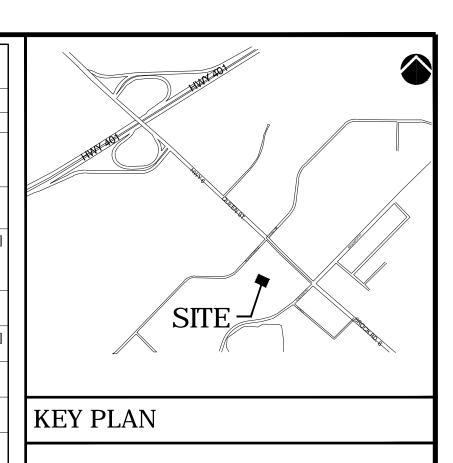

ISSUED FOR PERMIT

No.	DATE	DESCRIPTION
0	20/FEB/2018	ISSUED FOR PERMIT
	ALL DDE	VIOUS COPIES TO BE MARKED VOID

CONTRACTOR MUST CHECK AND VERIFY ALL DIMENSIONS ON THE JOB AND REPORT ANY DISCREPANCIES TO THE ARCHITECT BEFORE PROCEEDING WITH THE WORK. DO NOT SCALE THE DRAWING.

THIS DRAWING CONTAINS COPYRIGHT MATERIALS BELONGING TO THE THIS DRAWING WAS DEVELOPED FOR A SPECIFIC PURPOSE; USE FOR

ANY OTHER PURPOSE IS NOT PERMITTED. THIS DRAWING SHALL NOT BE REPRODUCED IN WHOLE OR IN PART WITHOUT THE WRITTEN APPROVAL OF THE ARCHITECT. THIS DRAWING MUST BE READ IN THE CONTEXT OF ALL OTHER DRAWINGS WHICH CONSTITUTE THE DOCUMENT.

DRAWING TITLE:

TITLE SHEET, OBC MATRIX, SITE PLAN AND NOTES


PROJECT TITLE:

STORAGE SHED 30 QUEEN STREET, MORRISTON, ON, CANADA

MEHBOOB BANGASH ARCHITECTS

8140 HORNBY ROAD, HALTON HILLS,ONTARIO CANADA LOP1E0 www.mbarch.ca

TEL: 416-444-3162 FAX: 866-571-1317 info@mbarch.ca

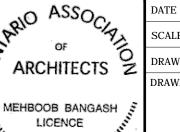

AS NOTED

PAINT GYPSUM BOARD SURFACES

01. CONTRACTOR IS TO SUPPLY PAINT IN THE COLOUR, TYPE, FINISH AND MANUFACTURER SPECIFIED ON THE DRAWINGS OR BY THE OWNER DIRECTLY. ALL PAINT AND MATERIAL MUST BE DELIVERED TO THE JOB SITE IN THE MANUFACTURER'S ORIGINAL CONTAINERS.

CONTACT: ZAIGHAM NAQUI PHONE : (416) 836.2784 EMAIL : ZNAQUI@TNBP.CA

- 02. PAINT IS TO BE APPLIED AS PER MANUFACTURER'S SPECIFICATIONS.
- 03. ALL SURFACES RECEIVING PAINT ARE TO BE PREPARED AS REQUIRED TO RECEIVE THE SPECIFIED FINISH. 04. EXISTING TO REMAIN SURFACES SCHEDULED FOR PAINTING ARE TO BE
- PREPARED AND MADE READY FOR PAINTING AS IF THEY WERE NEW SURFACES. THIS INCLUDES, BUT IS NOT LIMITED TO REMOVING BLISTERED, PEELING AND SCALING PAINT, CLEANING THE SURFACE, AND PATCHING ALL HOLES AND CRACKS.
- 05. SURFACES ARE TO RECEIVE ONE PRIMER COAT SOON AFTER SURFACE PREPARATION HAS BEEN COMPLETED.
- 06. SURFACES ARE TO RECEIVE TWO FINISH COATS OF PAINT.
- 07. THE CONTRACTOR IS TO SUBMIT PAINT COLOUR SAMPLE TO ARCHITECT FOR APPROVAL.
- 08. PERFORM ALL PAINTING OPERATIONS IN ACCORDANCE WITH
- CAN/CGSB-85.100 EXCEPT WHERE SPECIFIED OTHERWISE.
- 09. APPLY ALL PAINT MATERIALS IN ACCORDANCE WITH PAINT MANUFACTURERS WRITTEN APPLICATION INSTRUCTIONS.


ACCESSIBILITY NOTES:

- 01. EMERGENCY WARNING SYSTEMS SHALL INCLUDE BOTH AUDIBLE AND VISUAL ALARMS. THE VISUAL ALARMS SHALL BE LOCATED THROUGHOUT, INCLUDING RESTROOMS, AND PLACED 80" ABOVE THE FLOOR OR 6" BELOW CEILING, WHICHEVER IS LOWER WHERE APPLICABLE.
- (i.e. LEVER-OPERATED, PUSH-TYPE, U-SHAPED) MOUNTED NO HIGHER THAN 48" ABOVE THE FINISHED FLOOR.
- 03. FLOOR SURFACES SHALL BE STABLE, FIRM, AND SLIP-RESISTANT. CHANGES IN LEVEL BETWEEN 0.25" AND 0.5" SHALL BE BEVELED WITH A SLOPE NO GREATER THAN 1:2. CHANGES IN LEVEL GREATER THAN 0.5" REQUIRE RAMPS. CARPET PILE THICKNESS SHALL BE 0.5" MAX. GRATINGS IN FLOOR SHALL HAVE SPACES NO GREATER THAN 0.5" WIDE IN ONE DIRECTION. DOORWAY THRESHOLDS SHALL NOT EXCEED 0.5" IN HEIGHT. 04. HOT WATER AND DRAIN PIPES UNDER ACCESSIBLE LAVATORIES AND
- SINKS SHALL BE INSULATED OR OTHERWISE CONFIGURED TO PROTECT AGAINST CONTACT. THERE SHALL BE NO SHARP OR ABRASIVE SURFACES UNDER LAVATORY OR SINK

ABBREVIATIONS:

H.M.P = HOLLOW METAL PAINTEDEXIST. = EXISTING (TO REMAIN)TYP. = TYPICALRAD. = RADIUS

A.F.F. = ABOVE FINISHED FLOORG.C. = GENERAL CONTRACTORN.T.S. = NOT TO SCALE

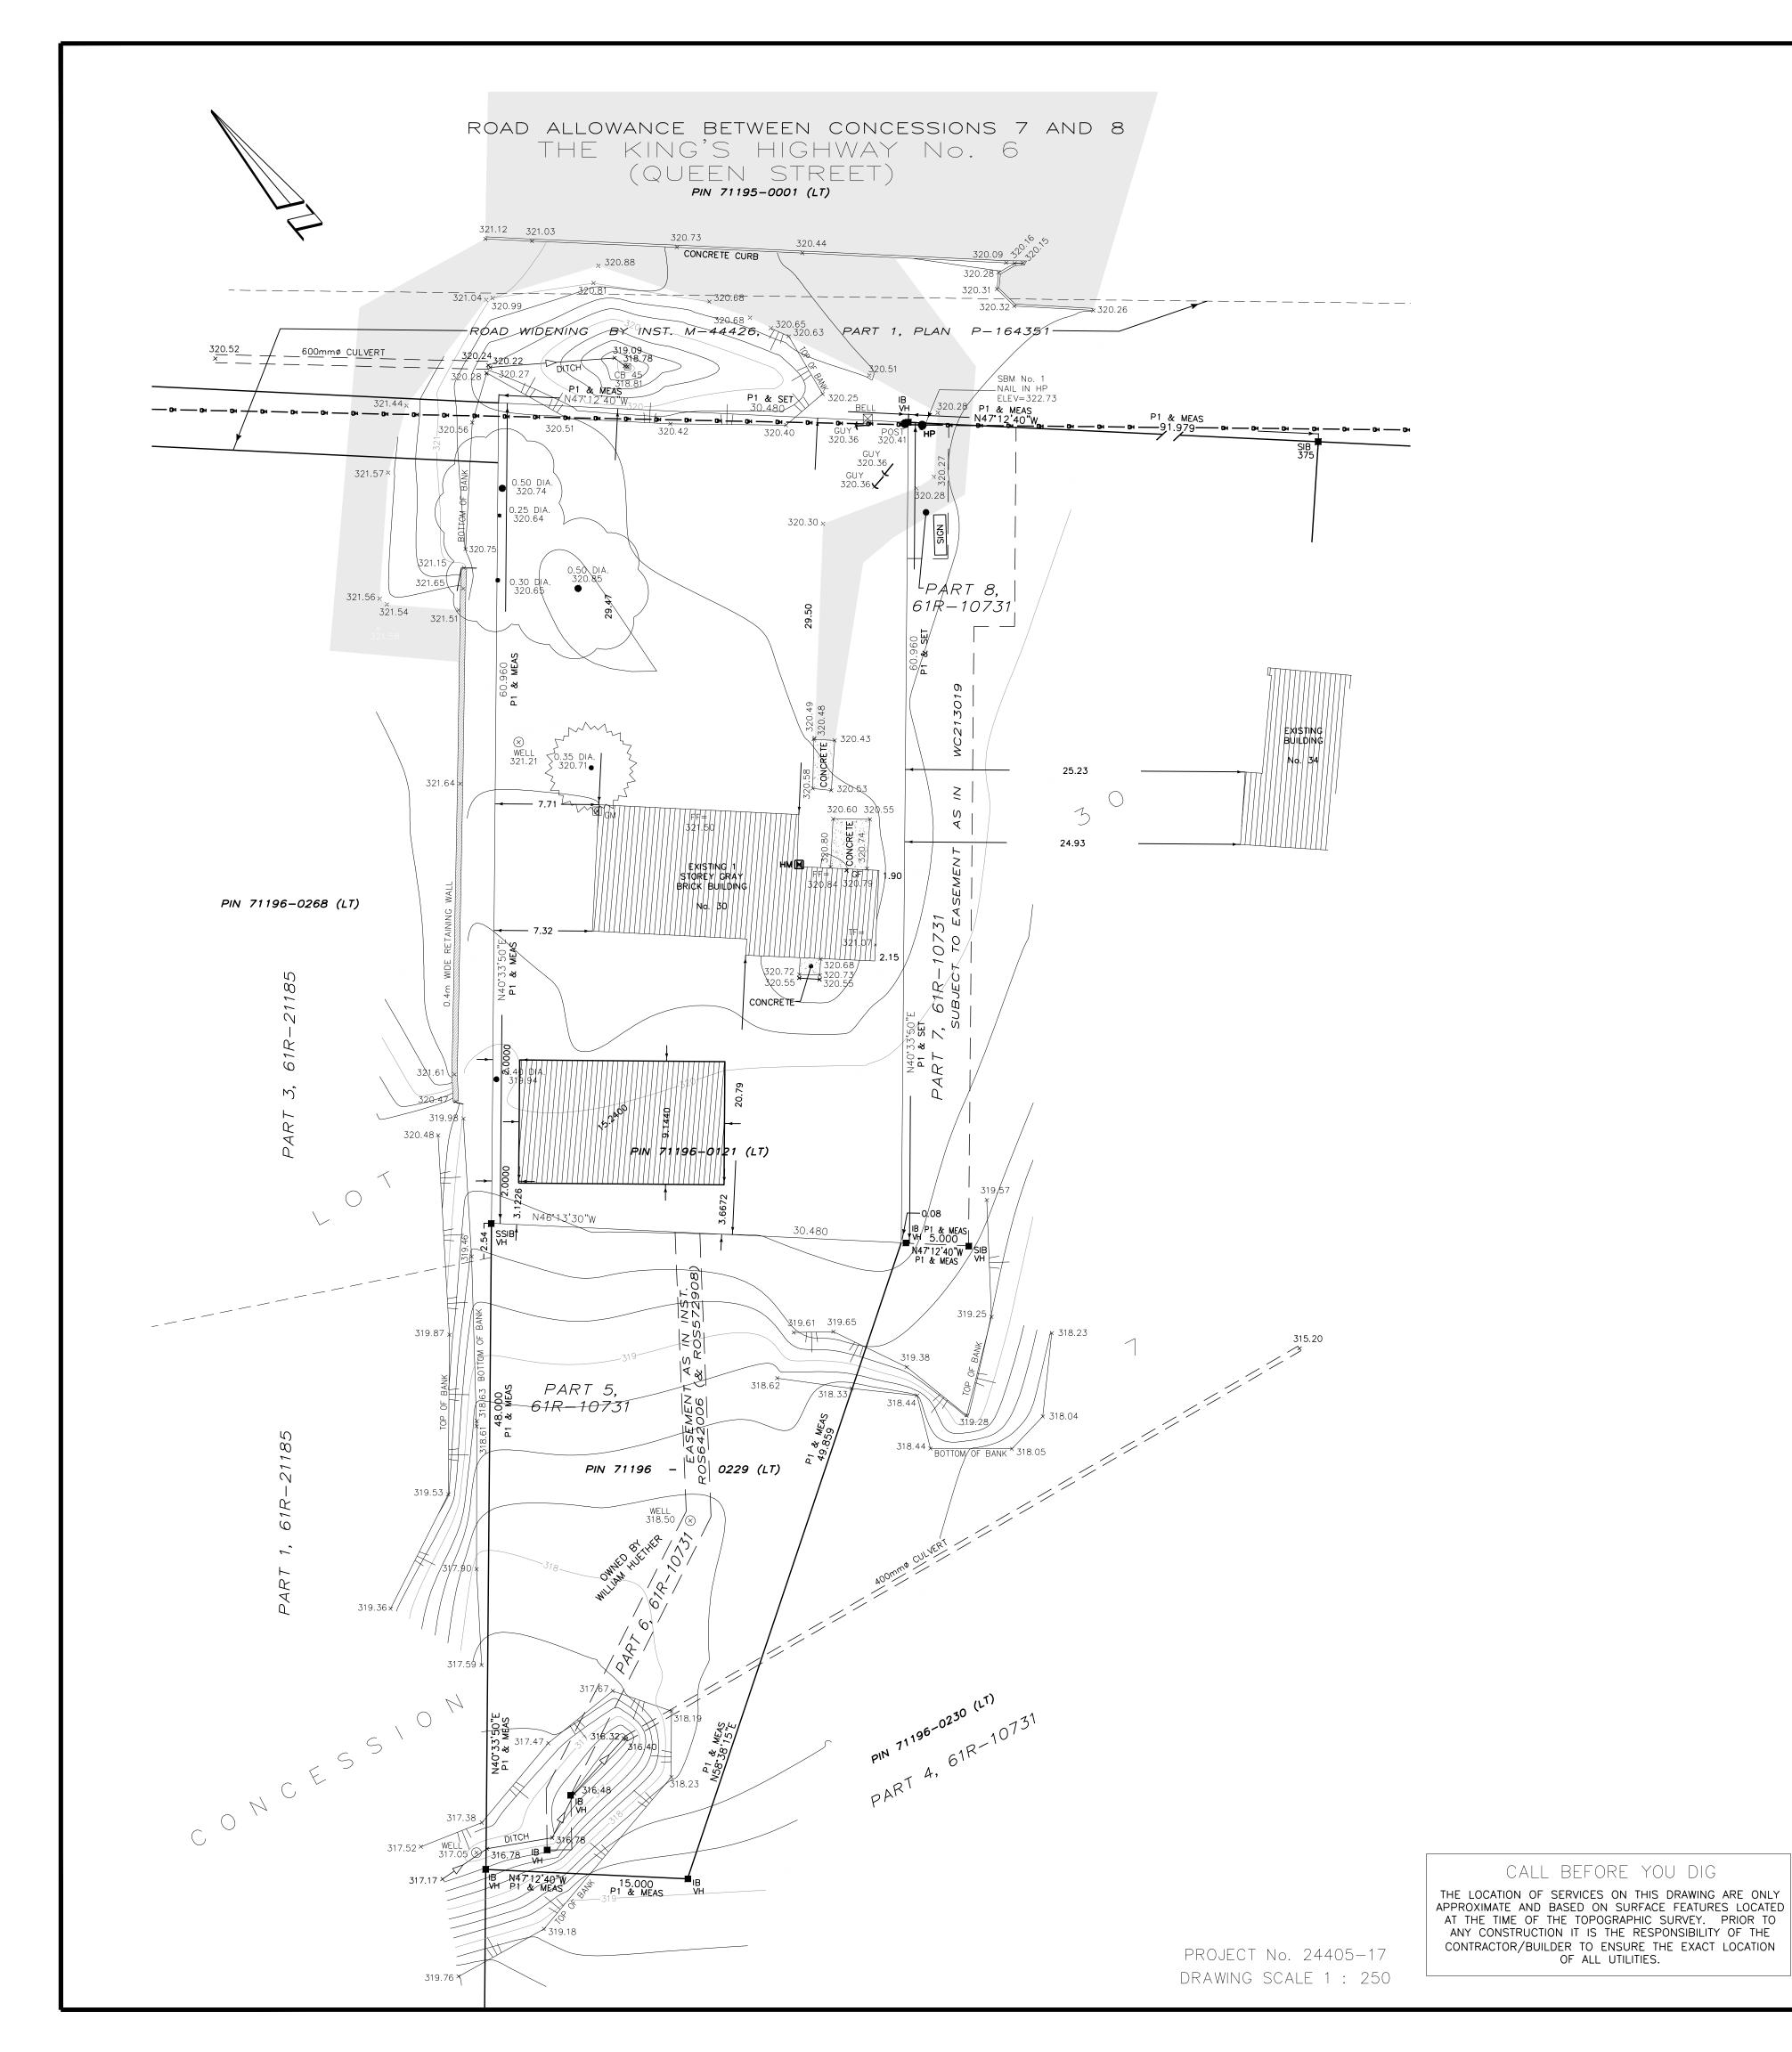

PROPERTY DESCRIPTION:

- PIN 71196-0121 (LT)
 PART OF LOT 30, CONCESSION 7, AS IN ROS642006
- TOWNSHIP OF PUSLINCH

TOP OF BANK

• TOGETHER WITH AN EASEMENT OVER PART 6, 61R-10731 AS IN INSTRUMENT ROS642006 (FIRSTLY & SECONDLY) FOR MAINTENANCE AND REPAIR OF WATER PIPE LINE AND TO DRAW WATER FROM WELL • TOGETHER WITH AN EASEMENT OVER PART 7, 61R-10731, AS IN INSTRUMENT WC213019 FOR INGRESS AND EGRESS

—□— DENOTES SURVEY MONUMENT SET ─■ DENOTES SURVEY MONUMENT FOUND DENOTES .025 x .025 x 1.20 STANDARD IRON BAR SSIB DENOTES .025 x .025 x 0.60 SHORT STANDARD IRON BAR IB DENOTES .015 x .015 x 0.60 IRON BAR 375 DENOTES BLACK, SHOEMAKER et. al., O.L.S.'s

VH DENOTES VAN HARTEN SURVEYING INC., O.L.S.'s P1 DENOTES DEPOSITED PLAN 61R-10731 BY (VH) ASPHALT GRAVEL EXISTING ELEVATION GUY WIRE CUY FENCE POST • CATCHBASIN E CB HYDRO POLE • HP BELL PEDESTAL 🔀 BELL HYDRO METER HHM TV PEDESTAL 🖾 CATV GAS METER GM CONIFEROUS TREE DECIDUOUS TREE OVERHEAD HYDRO DITCH/SWALE CENTRELINE OF ROAD

BEARING AND COORDINATE NOTE:

- BEARINGS ARE GRID BEARINGS AND ARE DERIVED FROM GPS OBSERVATIONS AND ARE REFERRED TO THE UTM PROJECTION, ZONE 17, NAD 83 (CSRS-2010) ADJUSTMENT.
- 2. DISTANCES SHOWN ON THIS PLAN ARE ADJUSTED GROUND DISTANCES AND CAN BE CONVERTED TO GRID DISTANCES BY MULTIPLYING BY AN AVERAGED COMBINED SCALE FACTOR OF 0.999617
- COORDINATES ON THIS PLAN ARE UTM, ZONE 17, NAD83 (CSRS-2010) ADJUSTMENT AND ARE BASED ON GPS OBSERVATIONS FROM A NETWORK OF PERMANENT GPS REFERENCE STATIONS. BEARING COMPARI
- FOR THE PURPOSES OF BEARING COMPARISONS, PREVIOUS SURVEYS HAVE BEEN ROTATED TO UTM BEARINGS BY THE ANGLES SHOWN BELOW. PLAN ROTATION FOR NORTHEAST BEARINGS

SURVEY INFORMATION:

BENCHMARK REFERENCE: ELEVATIONS ARE BASED ON GPS OBSERVATIONS TO PERMANENT REFERENCE STATIONS AND HAVE BEEN CORRECTED TO ORTHOMETRIC ELEVATIONS WITH GEOID MODEL HTv2.0, AS SUPPLIED BY NATURAL

RESOURCES CANADA. NAIL IN HYDRO POLE HAVING AN ELEVATION OF 322.73 METRES.

SURVEYOR'S CERTIFICATE

I CERTIFY THAT: 1. THE TOPOGRAPHIC SURVEY WAS COMPLETED ON THE 12h DAY OF JANUARY, 2017.

DATE: APRIL 19, 2018

JEFFREY E. BUISMAN ONTARIO LAND SURVEYOR

CAUTION: - THIS IS NOT A PLAN OF SURVEY AND SHALL NOT BE USED FOR TRANSACTION OR MORTGAGE PURPOSES.

- THIS SKETCH IS PROTECTED BY COPYRIGHT. METRIC: DISTANCES SHOWN ON THIS PLAN ARE IN METRES AND CAN BE CONVERTED TO FEET BY DIVIDING BY 0.3048.


TOPOGRAPHIC SURVEY PART OF LOT 30, CONCESSION 7 TOWNSHIP OF PUSLINCH COUNTY OF WELLINGTON



info@vanharten.com www.vanharten.com

REQUIRED	PROPOSI
00m ²	2944m ²
5%	4.7%
5m	5m
	00m ²

- PIN 71196-0121 (LT)
 PART OF LOT 30, CONCESSION 7, AS IN ROS642006
- TOWNSHIP OF PUSLINCH
- TOGETHER WITH AN EASEMENT OVER PART 6, 61R-10731 AS IN INSTRUMENT ROS642006 (FIRSTLY & SECONDLY) FOR MAINTENANCE AND REPAIR OF WATER PIPE LINE AND TO DRAW WATER FROM WELL • TOGETHER WITH AN EASEMENT OVER PART 7, 61R-10731, AS IN INSTRUMENT WC213019 FOR INGRESS AND EGRESS
- PIN 71196-0229 (LT)
 PART OF LOT 30, CONCESSION 7, BEING PARTS 5 & 6, 61R-10731
- TOWNSHIP OF PUSLINCH
- TOGETHER WITH AND SUBJECT TO AN EASEMENT AS IN INSTRUMENT ROS572908 TOGETHER WITH AN EASEMENT OVER PART 7, 61R-10731, AS IN INSTRUMENT WC213019 FOR INGRESS AND EGRESS

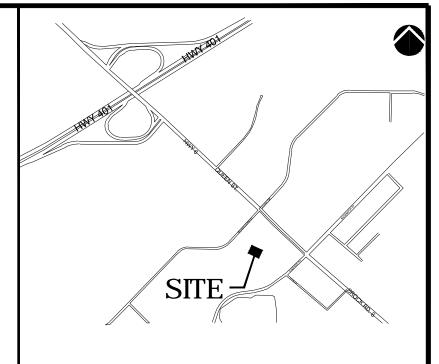

KEY PLAN

ISSUED FOR PERMIT

No.	DATE	DESCRIPTION
0	20/FEB/2018	ISSUED FOR PERMIT

ALL PREVIOUS COPIES TO BE MARKED VOID

CONTRACTOR MUST CHECK AND VERIFY ALL DIMENSIONS ON THE JOB AND REPORT ANY DISCREPANCIES TO THE ARCHITECT BEFORE PROCEEDING WITH THE WORK. DO NOT SCALE THE DRAWING.

THIS DRAWING CONTAINS COPYRIGHT MATERIALS BELONGING TO THE

THIS DRAWING WAS DEVELOPED FOR A SPECIFIC PURPOSE; USE FOR ANY OTHER PURPOSE IS NOT PERMITTED. THIS DRAWING SHALL NOT BE REPRODUCED IN WHOLE OR IN PART WITHOUT THE WRITTEN APPROVAL OF THE ARCHITECT.

THIS DRAWING MUST BE READ IN THE CONTEXT OF ALL OTHER

DRAWING TITLE:

TITLE SHEET, OBC MATRIX, SITE PLAN AND NOTES

DRAWINGS WHICH CONSTITUTE THE DOCUMENT.

PROJECT TITLE:


STORAGE SHED 30 QUEEN STREET, MORRISTON, ON, CANADA

MEHBOOB BANGASH ARCHITECTS


8140 HORNBY ROAD, HALTON HILLS,ONTARIO CANADA LOP1E0 www.mbarch.ca





TEL: 416-444-3162 FAX: 866-571-1317 info@mbarch.ca

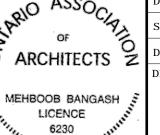

AS NOTED

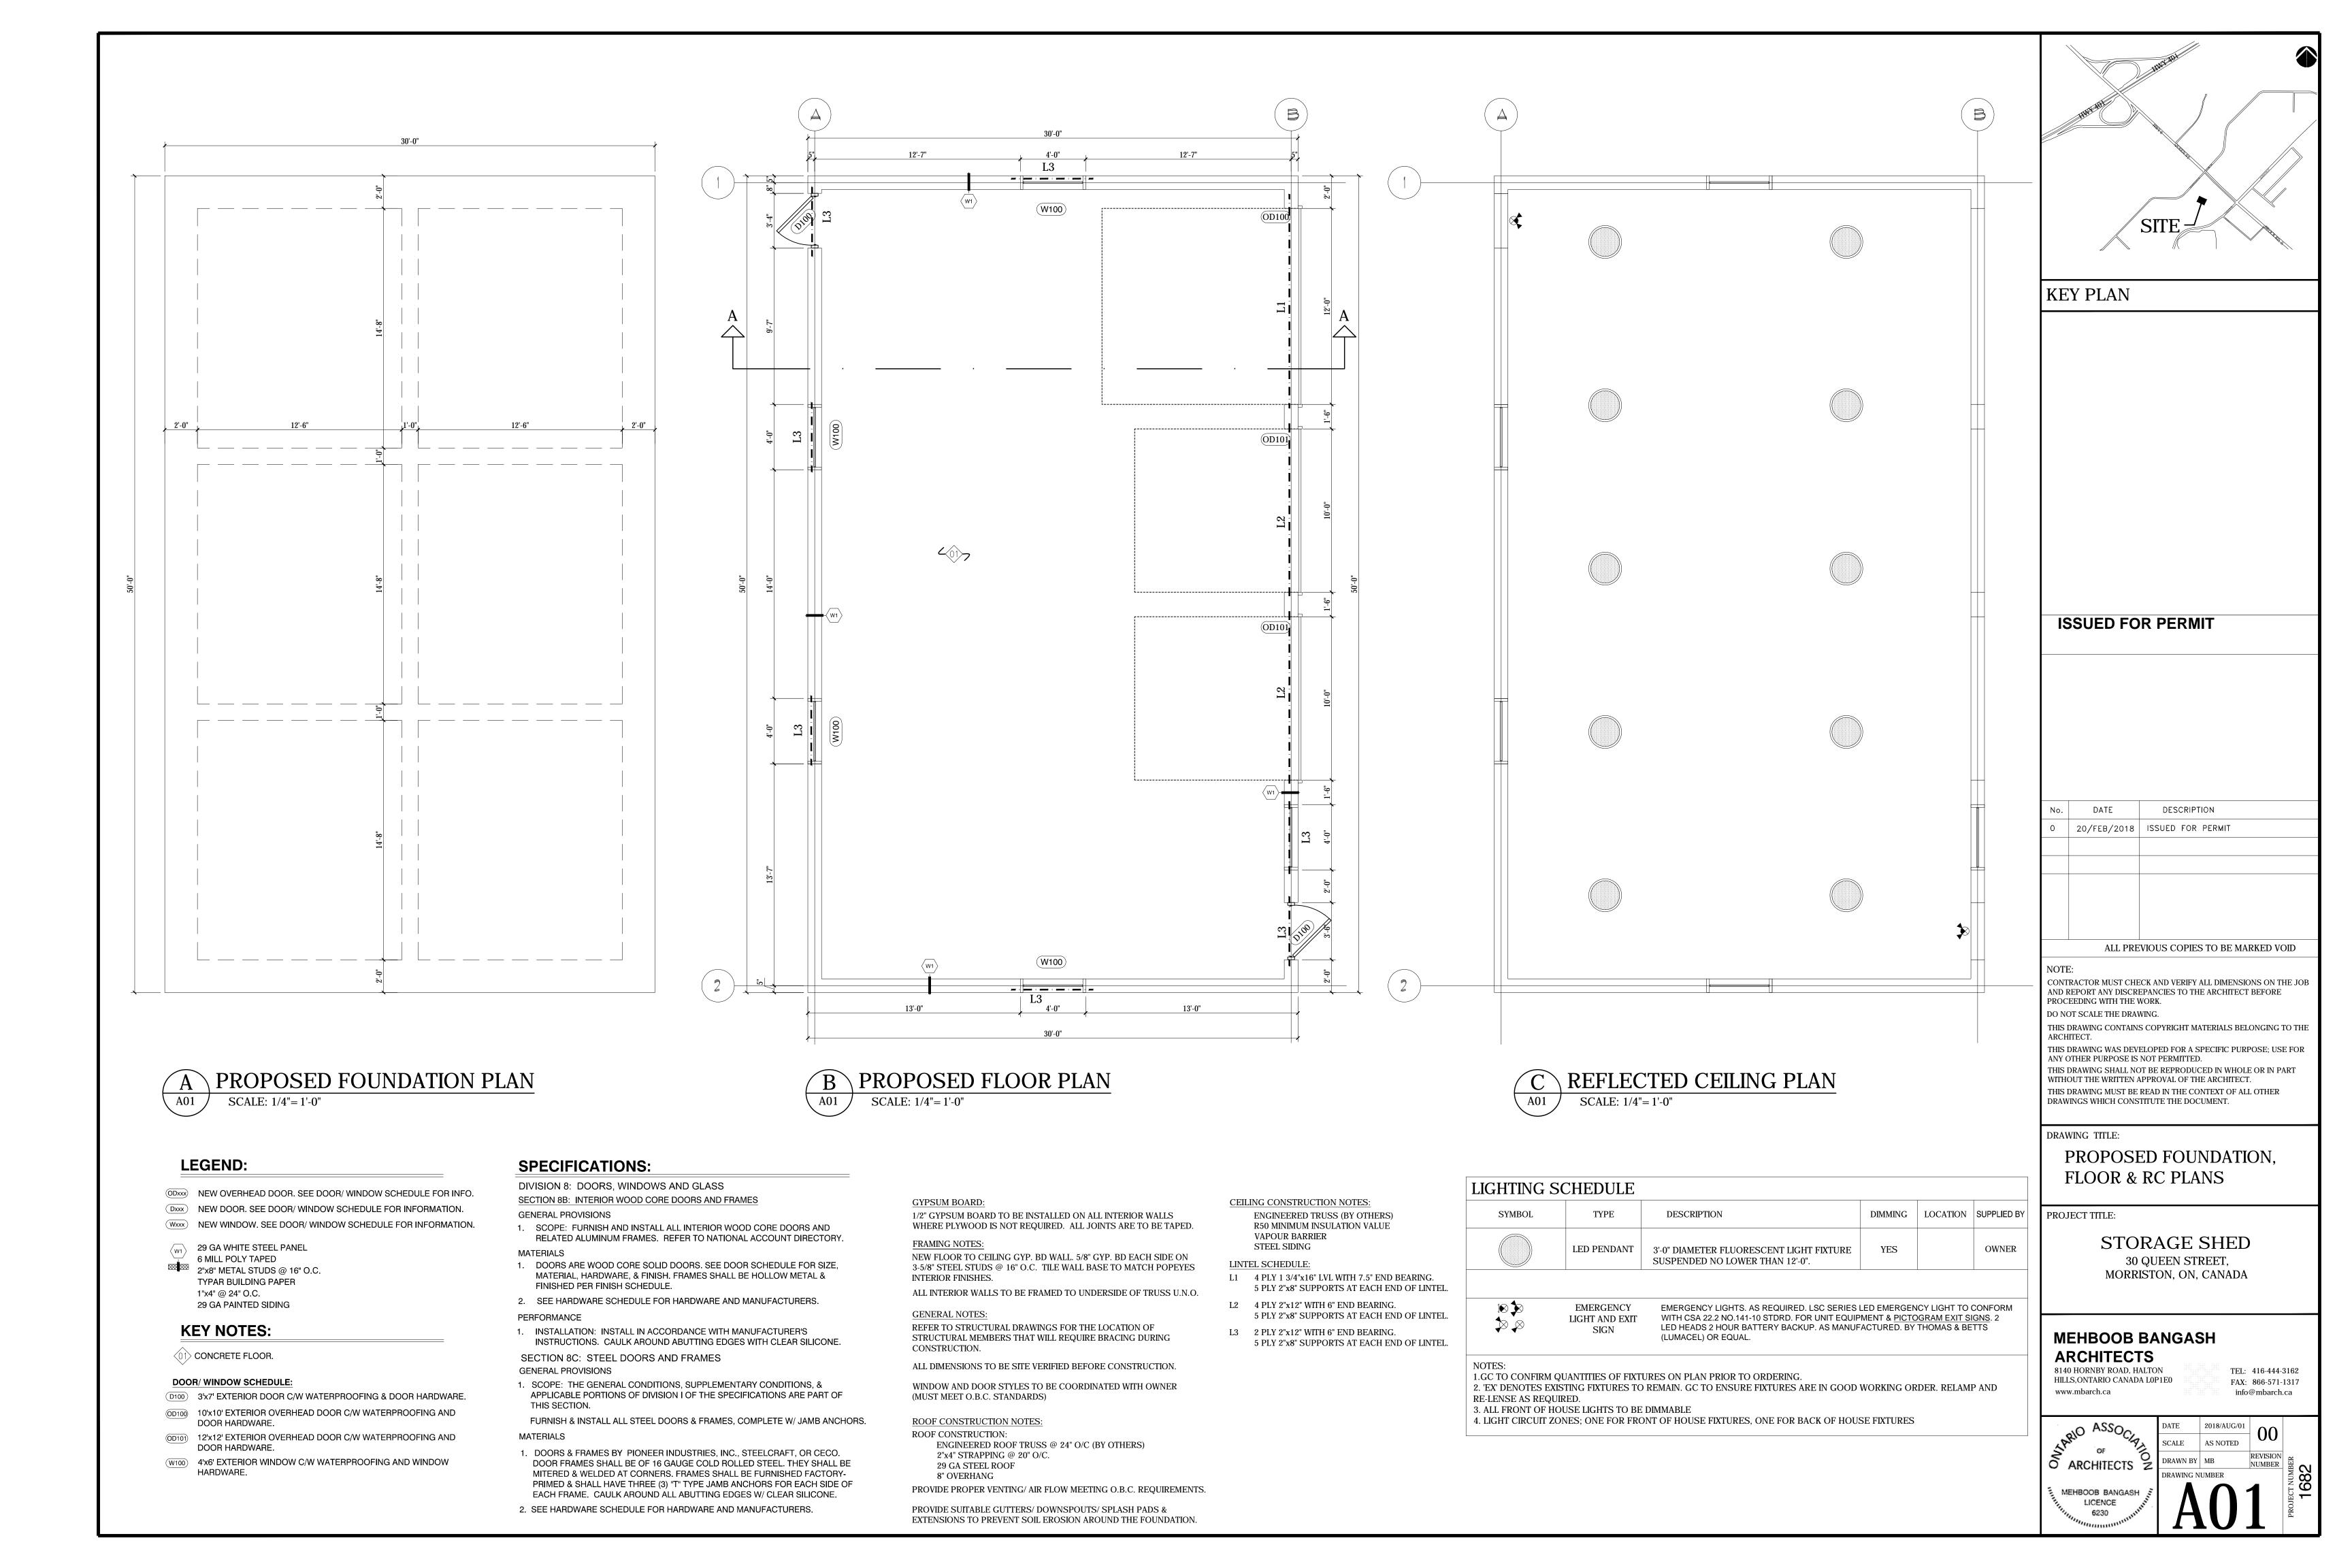

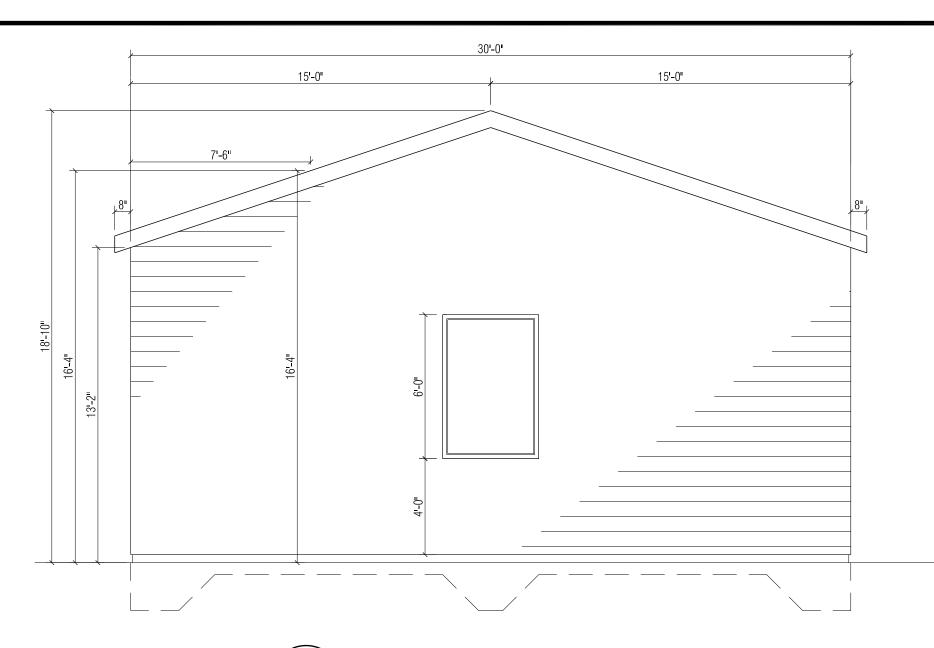

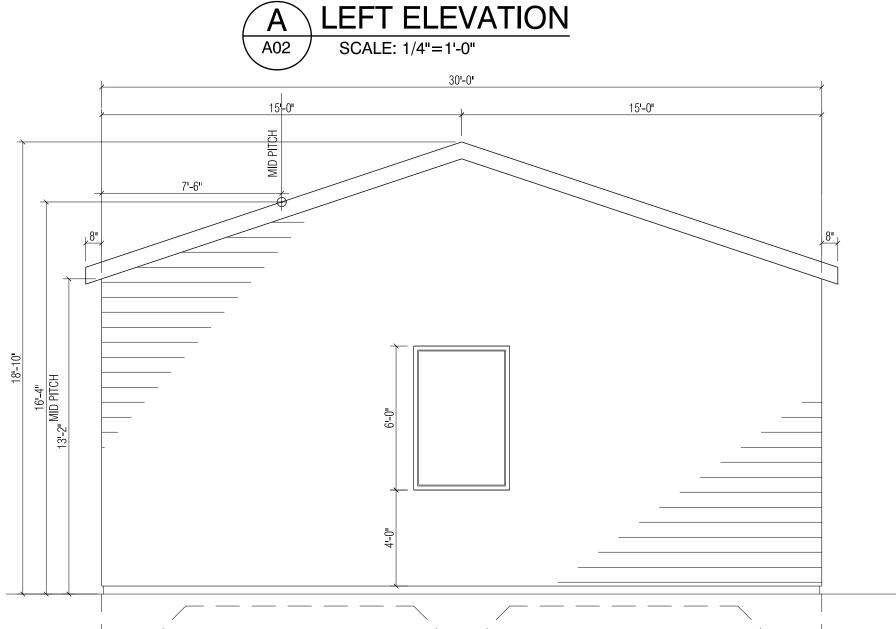



GENERAL CONSTRUCTION NOTES:

NOTE: A. CO-ORDINATE ALL SECTIONS OF WORK, PAY ALL FEES AND OBTAIN ALL PERMITS AS

B. ANY WORK REQUIRED BY THE DRAWINGS OR REASONABLY NECESSARY TO COMPLETE THE WORK BUT NOT INCLUDED IN ANY SPECIFIC SECTION OF THE DRAWINGS OR NOTES ARE HEREBY INCLUDED.

C. ALL WORK COMPLETED BY THE CONTRACTOR SHALL BE IN ACCORDANCE WITH THE DRAWINGS. ALTERNATIVES CAN BE PROPOSED BY THE CONTRACTOR FOR TENANT / DESIGNER APPROVAL PROVIDED THE APPROVED PROJECT SCHEDULE IS NOT DELAYED AS A RESULT OF SUBSTITUTIONS. CONTRACTOR TO CHECK AND PRE-ORDER MATERIALS REQUIRING LONGER DELIVERIES. ANY DELAYS CAUSED BY NOT ORDERING MATERIALS IN A TIMELY MANNER WILL BE AT THE SOLE COST TO THE CONTRACTOR.


D. ALL WORK SHALL BE PERFORMED IN ACCORDANCE WITH LATEST APPLICABLE BUILDING CODES AND FIRE REGULATIONS AND ANY LOCAL BUILDING REQUIREMENTS.

E. CONTRACTOR TO VERIFY AND CONFIRM ALL DIMENSIONS ON SITE AND REPORT ANY DISCREPANCIES TO THE DESIGNER BEFORE PROCEEDING WITH WORK.


F. THIS DRAWING TO BE READ IN CONJUNCTION WITH ALL OTHER DRAWINGS, SCHEDULES, SPECIFICATIONS AND DETAILS. REFER ALSO TO ENGINEERING DRAWINGS AND SPECIFICATIONS WHERE APPLICABLE.

G. FOR DOOR INFORMATION REFER TO DOOR SCHEDULE.


H. CONTRACTOR TO PROVIDE FIRE EXTINGUISHERS AS REQUIRED AS PER LOCAL FIRE/BUILDING CODE REGULATIONS. EXACT LOCATIONS TO BE DETERMINED ON SITE IN RESPECT TO FIXTURE PLACEMENT

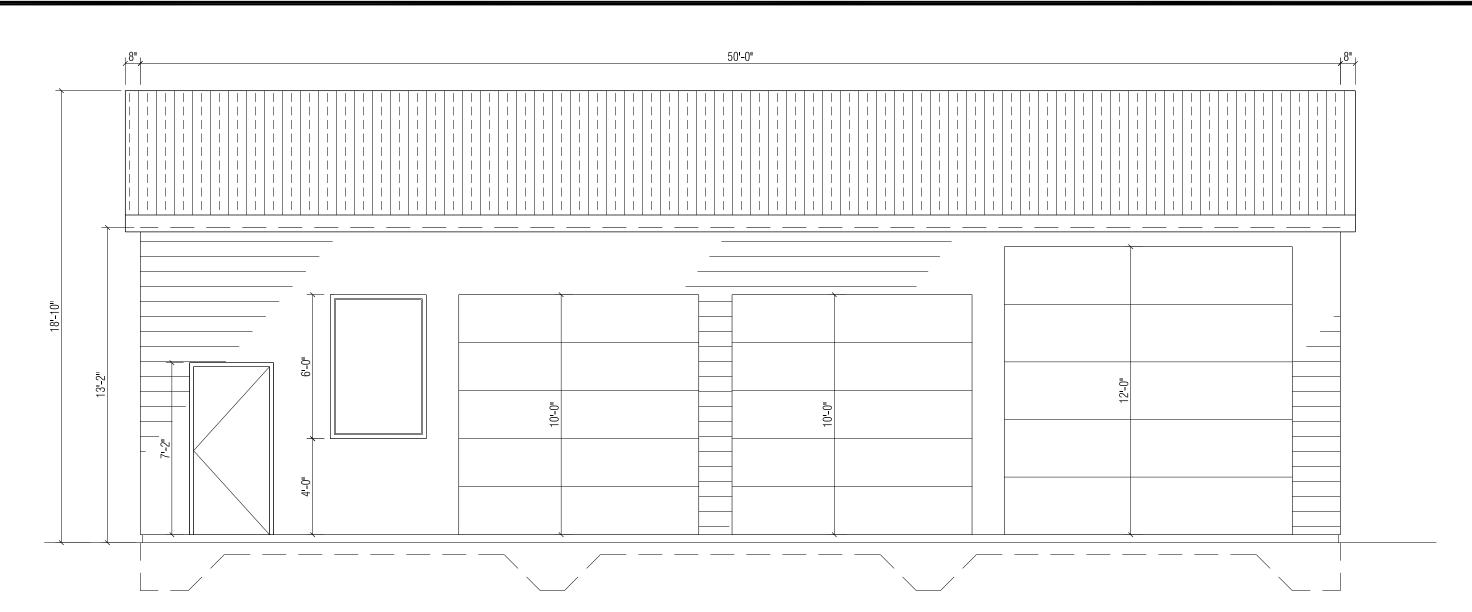


B FRONT ELEVATION SCALE: 1/4"=1'-0"

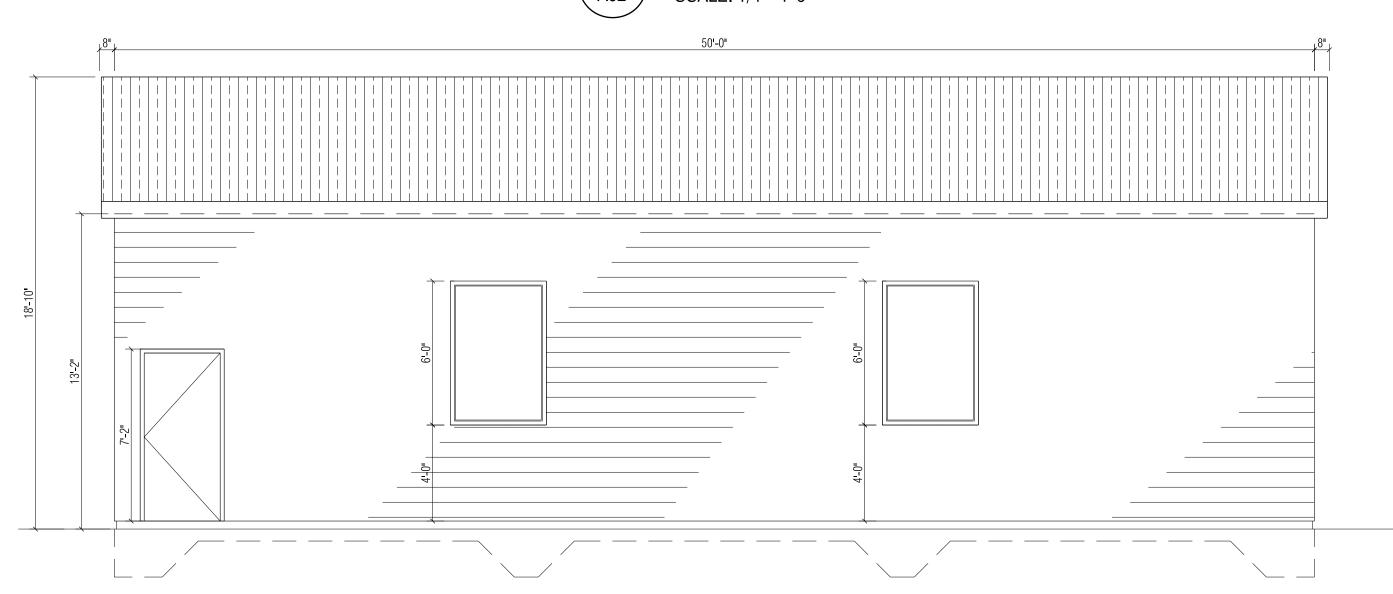

D BACK ELEVATION SCALE: 1/4"=1'-0"

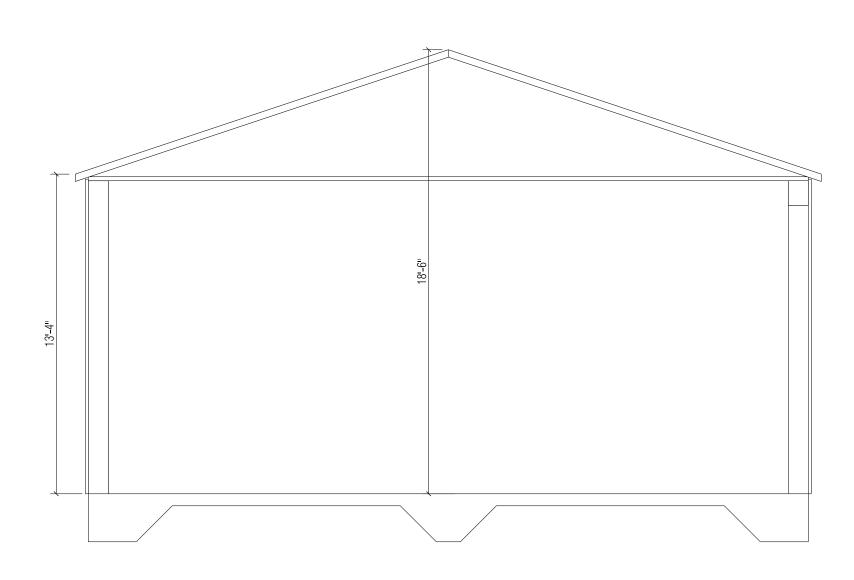



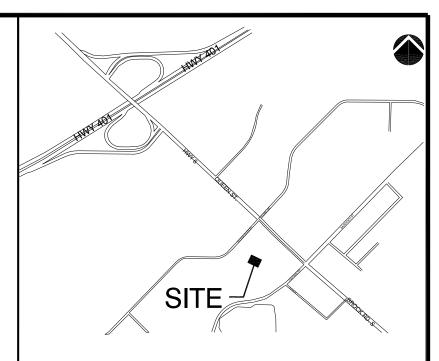

KEY PLAN

ISSUED FOR PERMIT

No.	DATE	DESCRIPTION
0	20/FEB/2018	ISSUED FOR PERMIT
	ALL PRE	VIOUS COPIES TO BE MARKED VOID

CONTRACTOR MUST CHECK AND VERIFY ALL DIMENSIONS ON THE JOB AND REPORT ANY DISCREPANCIES TO THE ARCHITECT BEFORE PROCEEDING WITH THE WORK. DO NOT SCALE THE DRAWING.

THIS DRAWING CONTAINS COPYRIGHT MATERIALS BELONGING TO THE ARCHITECT.

THIS DRAWING WAS DEVELOPED FOR A SPECIFIC PURPOSE; USE FOR ANY OTHER PURPOSE IS NOT PERMITTED. THIS DRAWING SHALL NOT BE REPRODUCED IN WHOLE OR IN PART WITHOUT THE WRITTEN APPROVAL OF THE ARCHITECT. THIS DRAWING MUST BE READ IN THE CONTEXT OF ALL OTHER DRAWINGS WHICH CONSTITUTE THE DOCUMENT.

DRAWING TITLE:

SECTION AND ELEVATIONS

PROJECT TITLE:

STORAGE SHED

30 QUEEN STREET, MORRISTON, ON, CANADA

MEHBOOB BANGASH ARCHITECTS

8140 HORNBY ROAD, HALTON HILLS,ONTARIO CANADA LOP1E0 www.mbarch.ca

MEHBOOB BANGASH LICENCE

TEL: 416-444-3162 FAX: 866-571-1317 info@mbarch.ca

2018/AUG/01 AS NOTED

