FREEMAN - DRIVEWAY

BUDGET SALES, INC

CONTACTS

OWNER/DEVELOPER

JIM FREEMAN, JR
BUDGET SALES, INC.
MARIETTA, GA, 30062
jf@atlequ.com

CIVIL

JAY FLOYD


RAGAN SMITH ASSOCIATES

1410 COWART STREET

CHATTANOOGA, TN 37408 (423)

490-9400

jfloyd@ragansmith.com

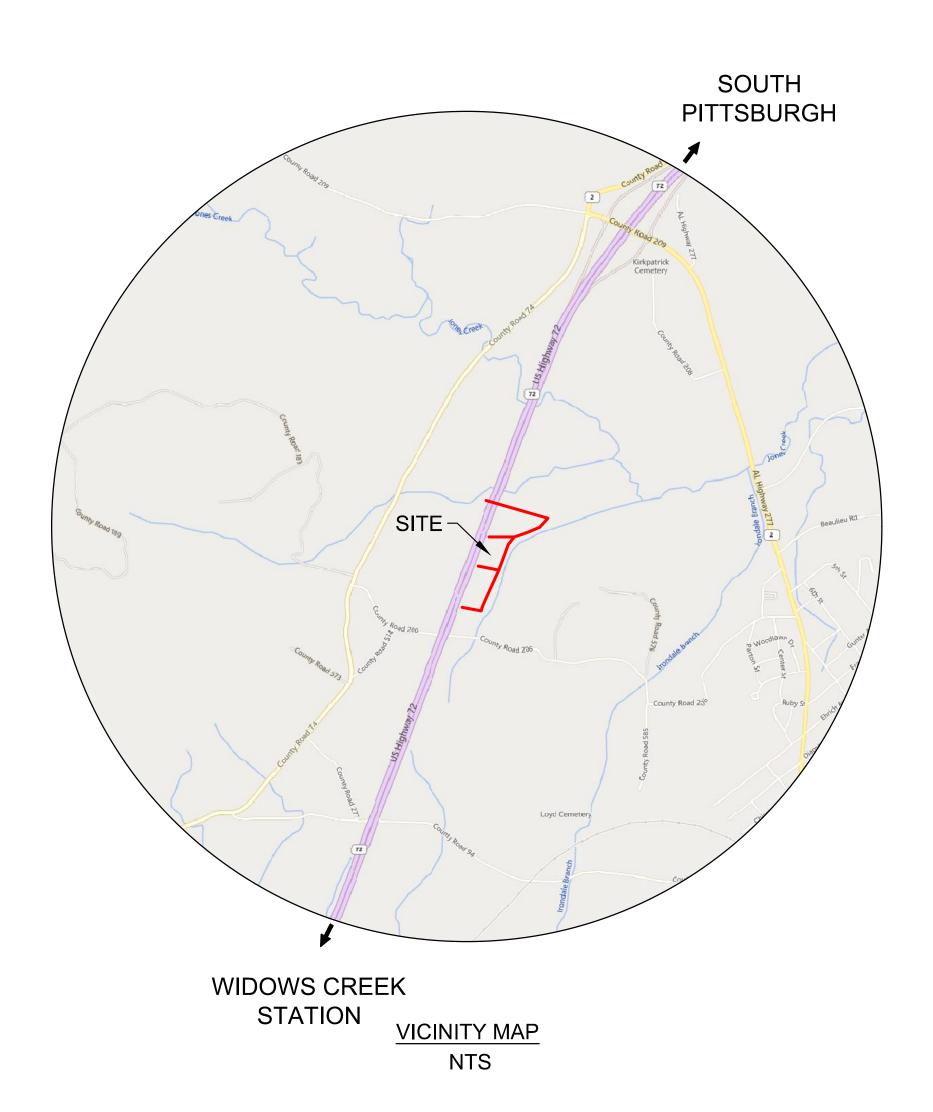

JACKSON COUNTY, AL



Nashville - Murfreesboro - Chattanooga ragansmith.com

SHEET NUMBER

C0.0

C0.1

C1.0

C2.1

C3.1

C3.2

C5.0

SHEET NAME

EXISTING CONDITIONS

EROSION CONTROL PLAN

TRAFFIC CONTROL PLAN

SIGHT DISTANCE PLAN

COVER

LAYOUT

DETAILS

RIVEWA

UDGET SALES, I

REEEMAN - DRIVE

 Scale:
 NTS

 Date:
 09-07-2022

 Approved By:
 JEF

 Revisions:
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Drawing Title:

COVER SHEET

Drawing No.

C0.0



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MAN - DRIVEWA

Scale: 1"=50' Date: 09-07-2022 Approved By: JEF

risions:


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Drawing Title:

EXISTING CONDITION

Drawing No.

C0.1

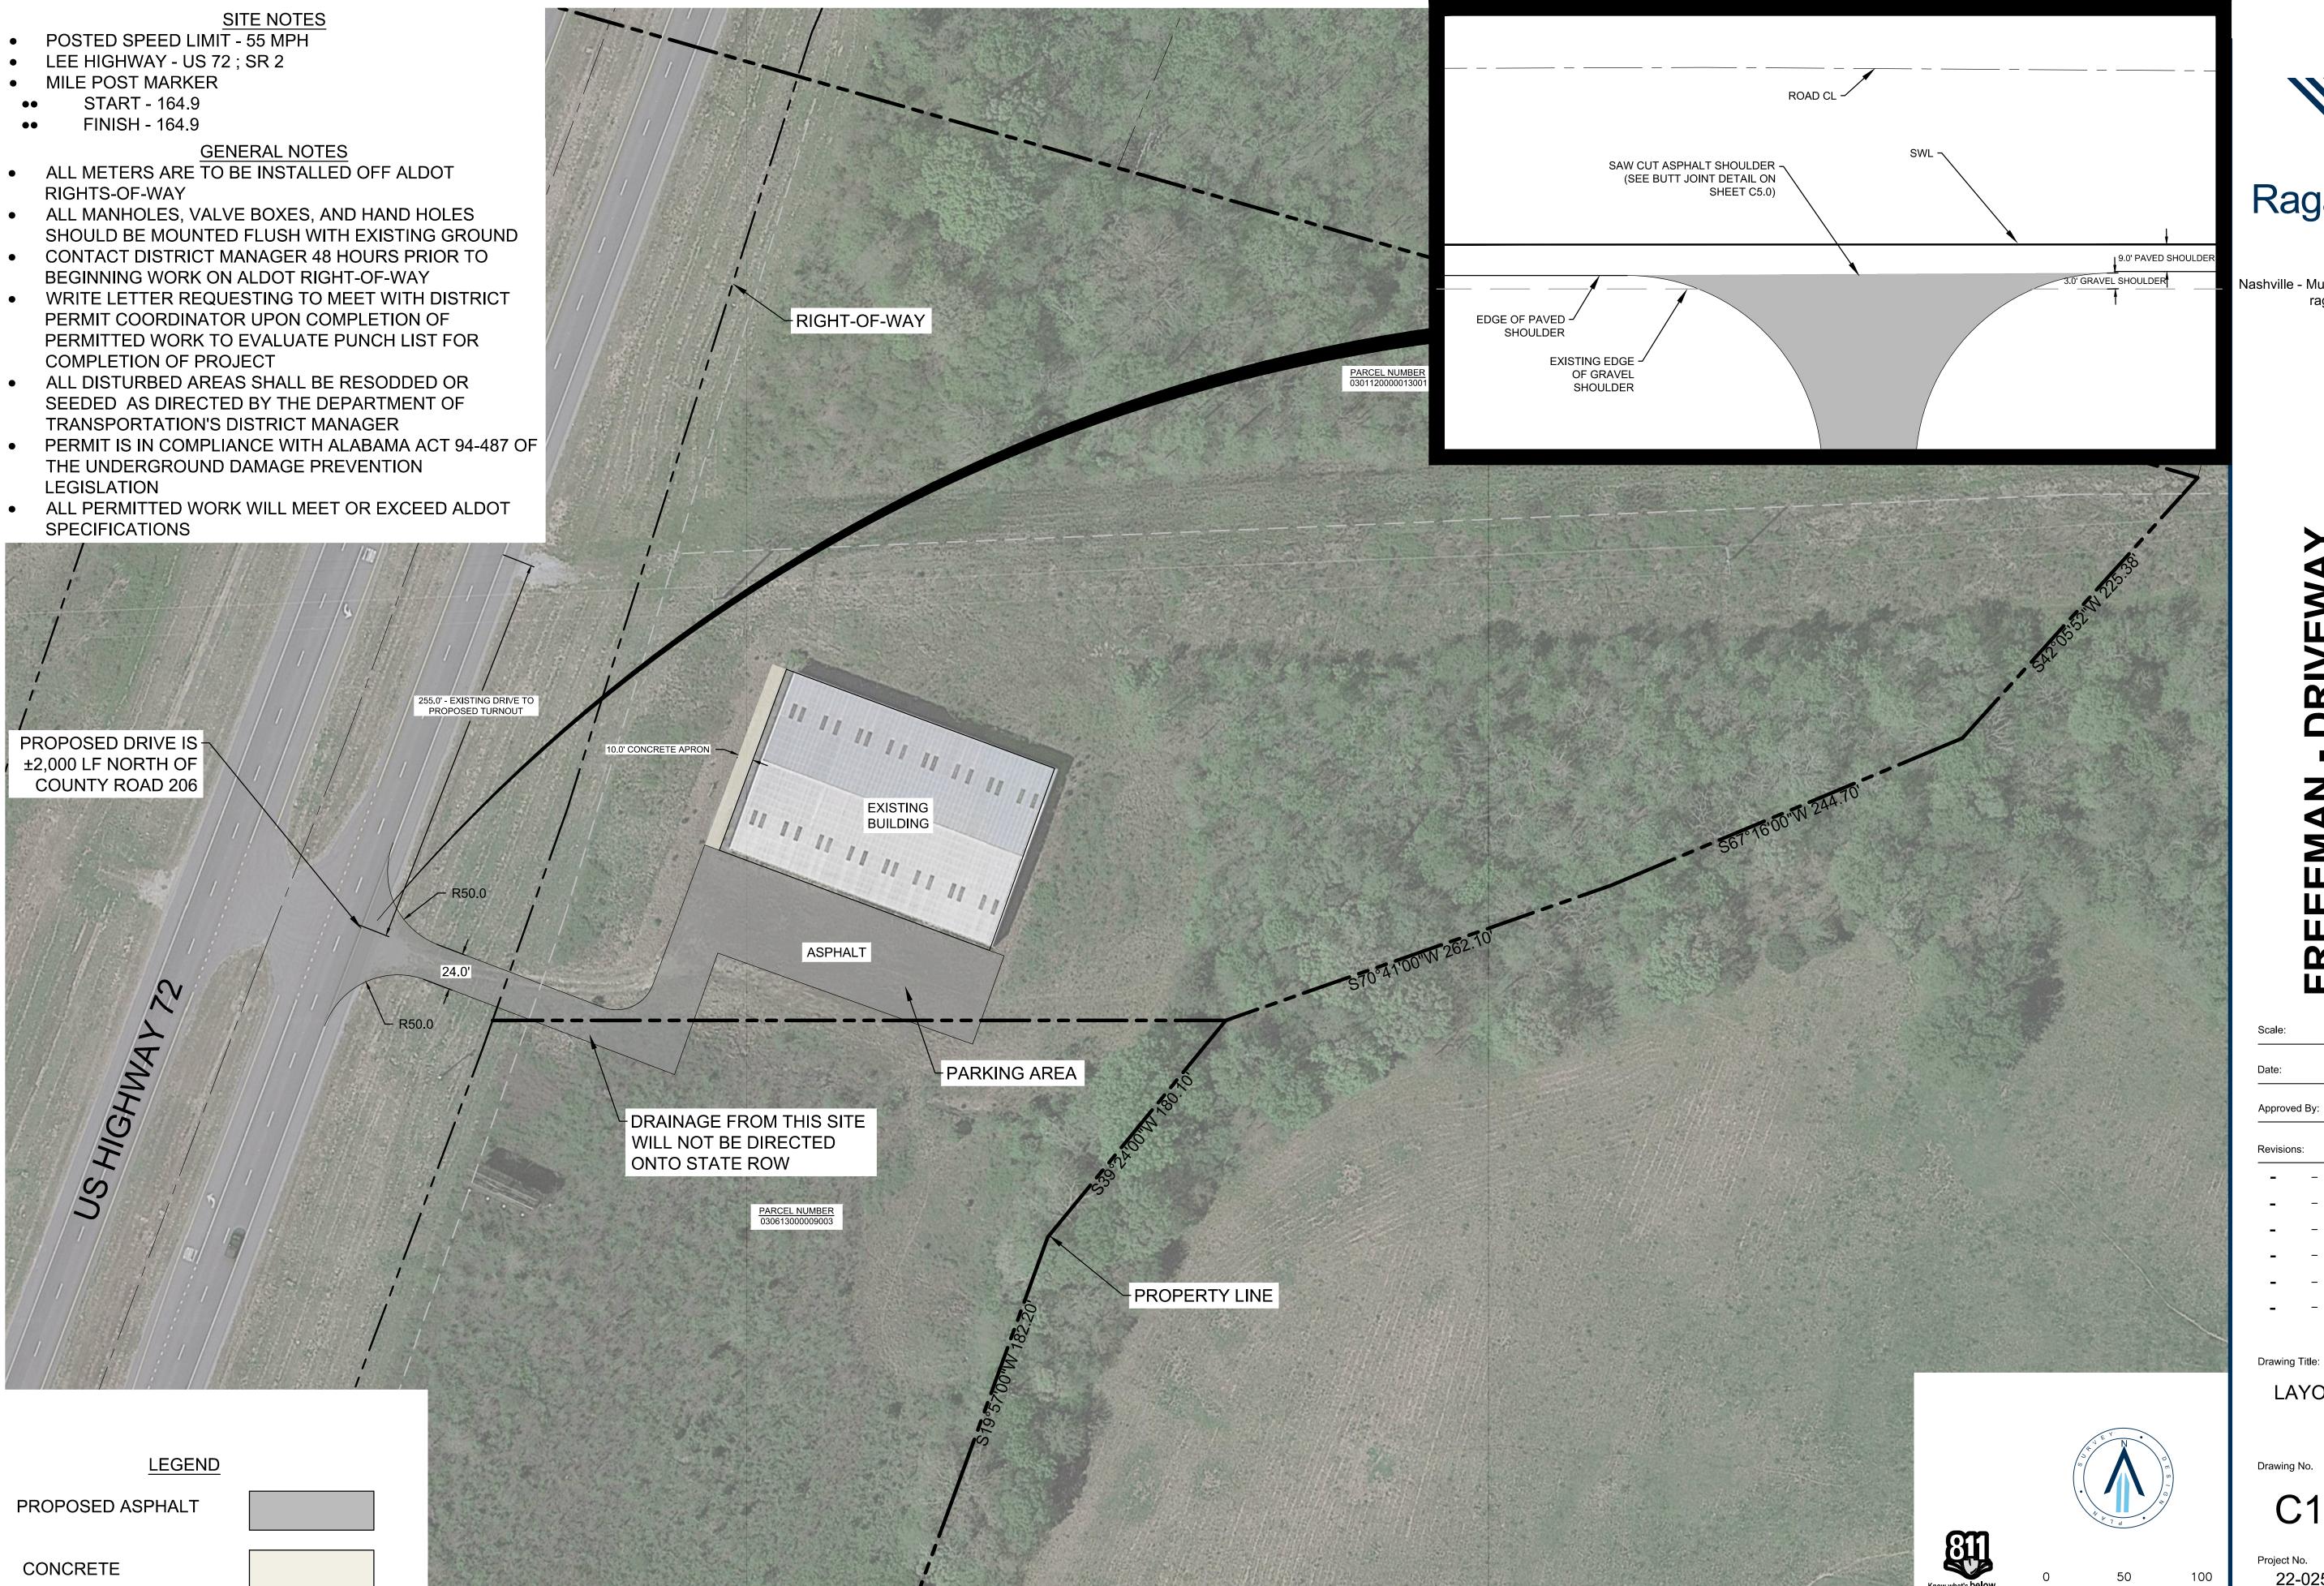

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1"=50' 09-07-2022 Approved By:

LAYOUT

Drawing No.

PROPOSED IMPERVIOUS AREA (SITE) = .97 AC.

PROPOSED IMPERVIOUS AREA (ROW) = 0.08 AC.

EXISTING IMPERVIOUS AREA (OFFSITE NON-ROW) = 0.00 AC.

PROPOSED IMPERVIOUS AREA (OFFSITE NON-ROW) = 0.00 AC.

EROSION CONTROL NOTES

FILTER FABRIC SHALL BE A MINIMUM OF 32" IN WIDTH


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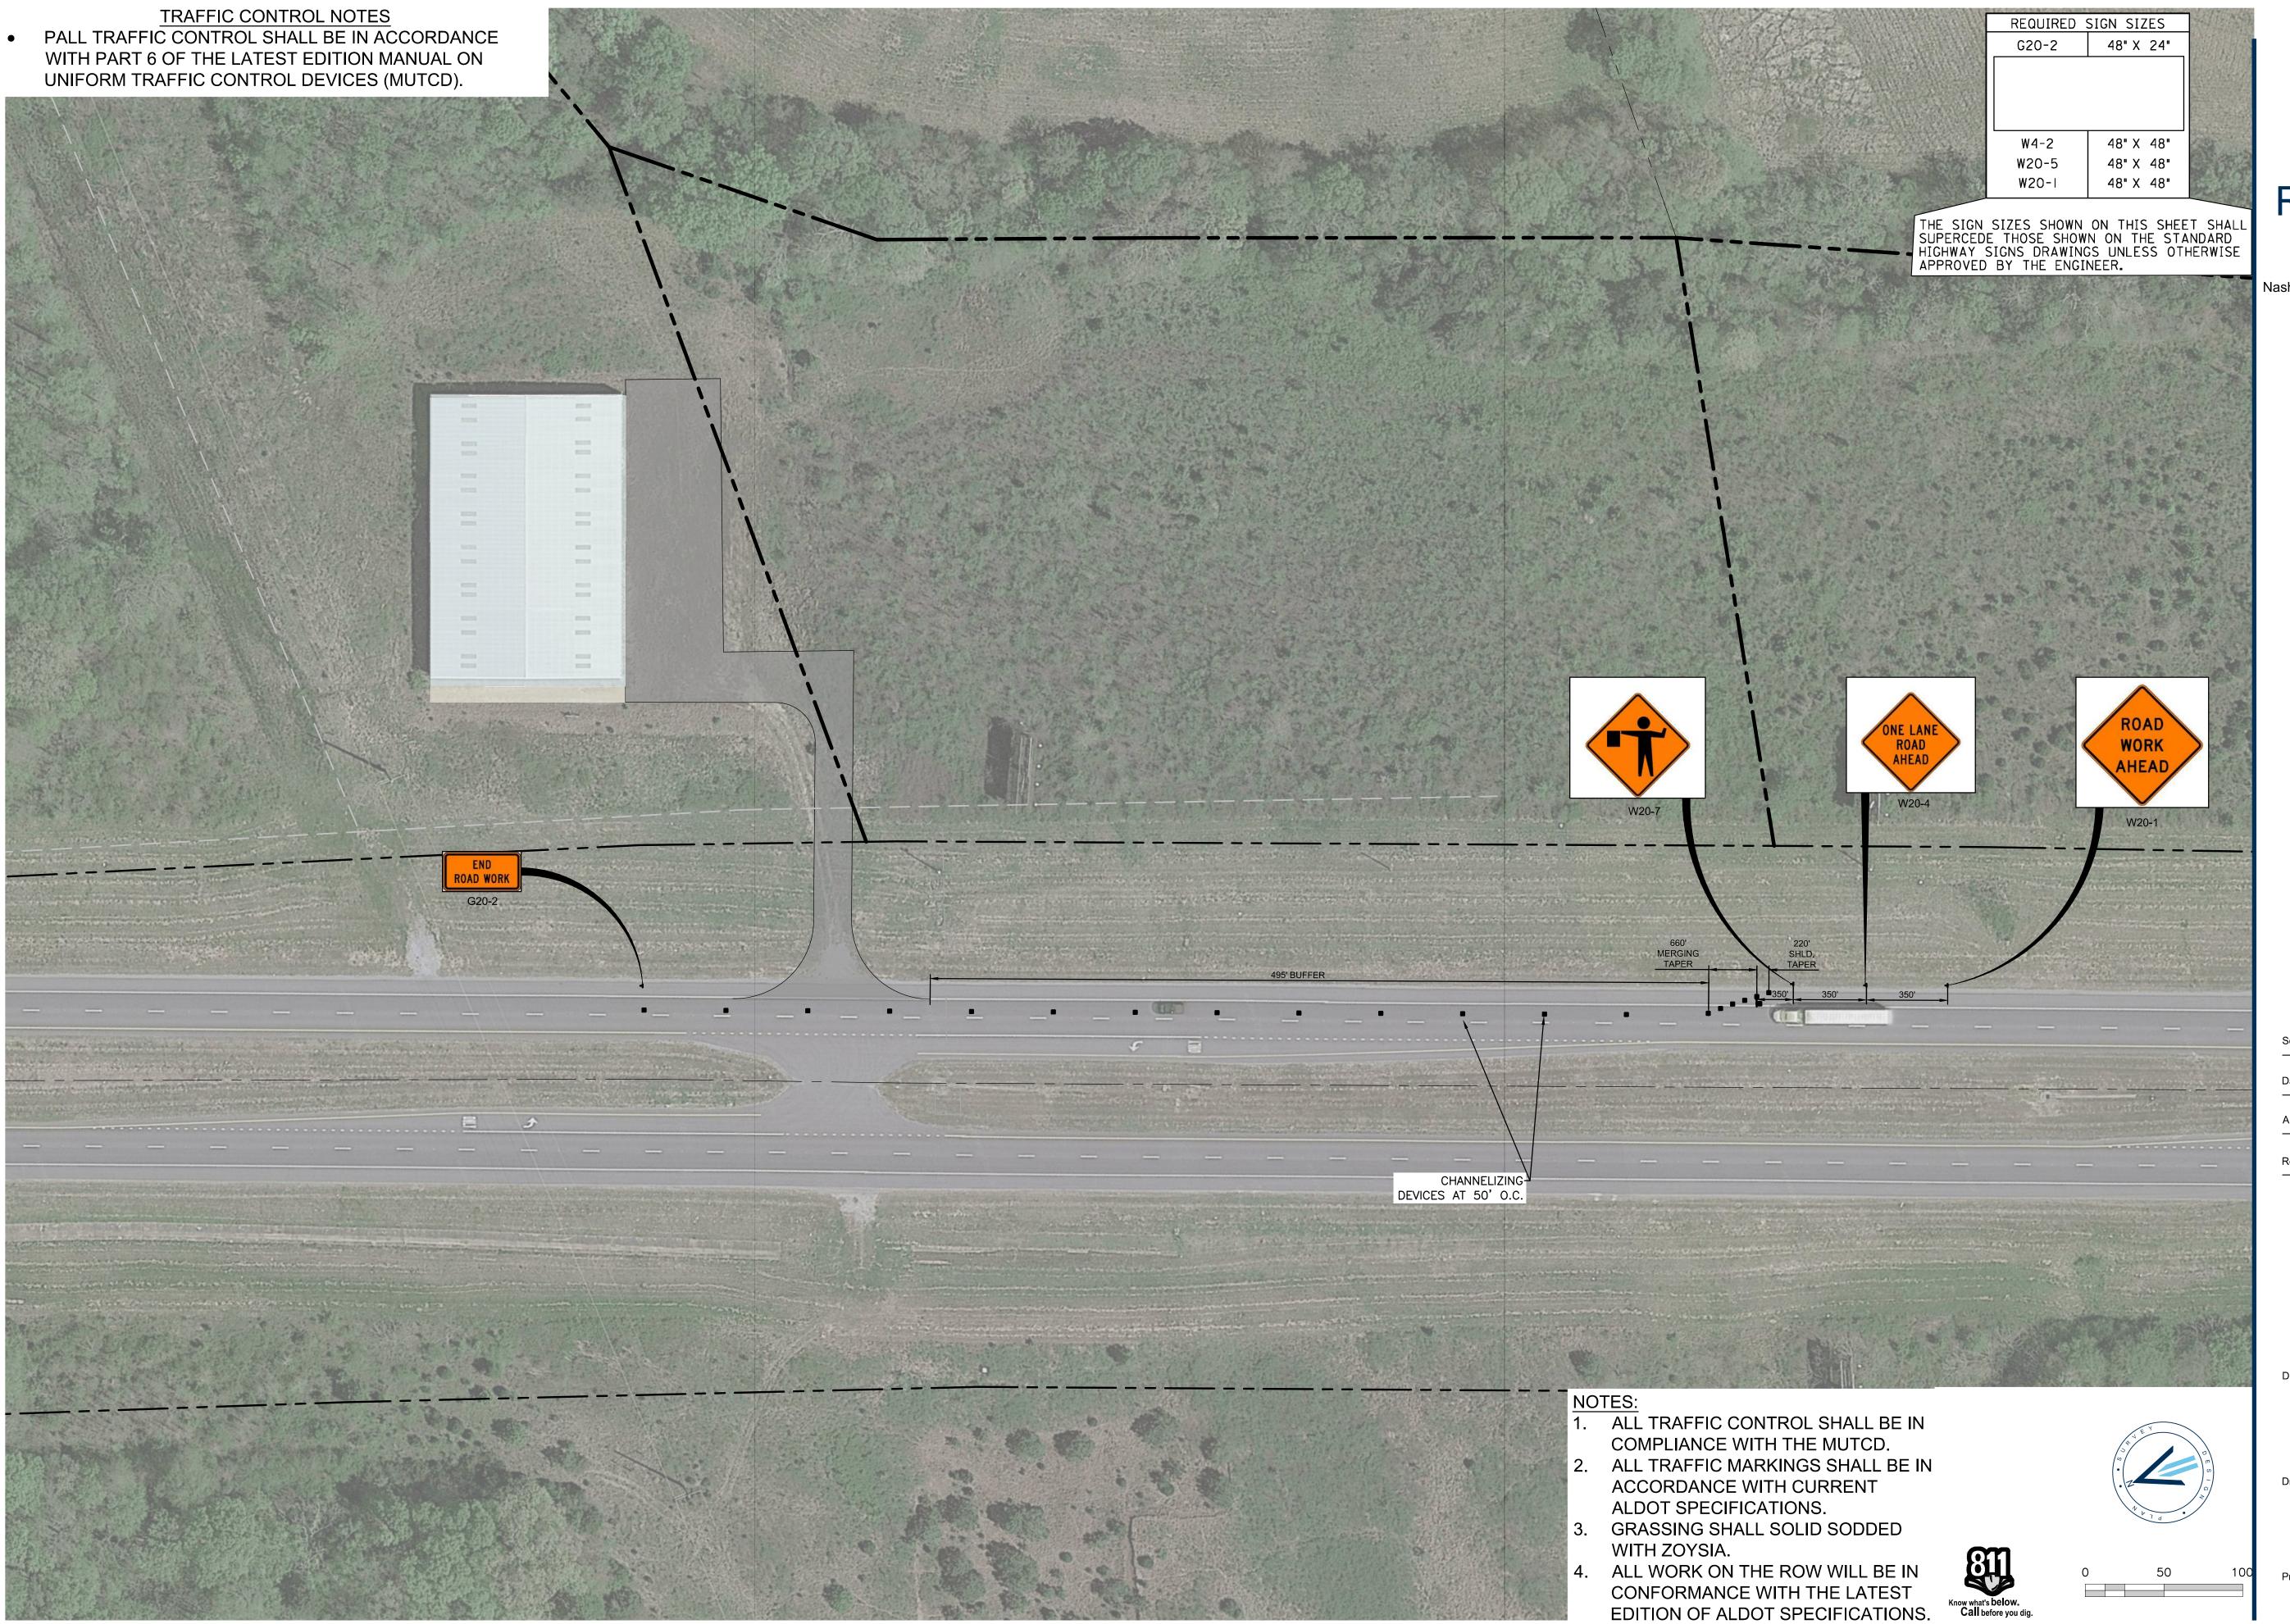
09-07-2022 Approved By:

Drawing Title:

EROSION CONTROL PLAN

Drawing No.



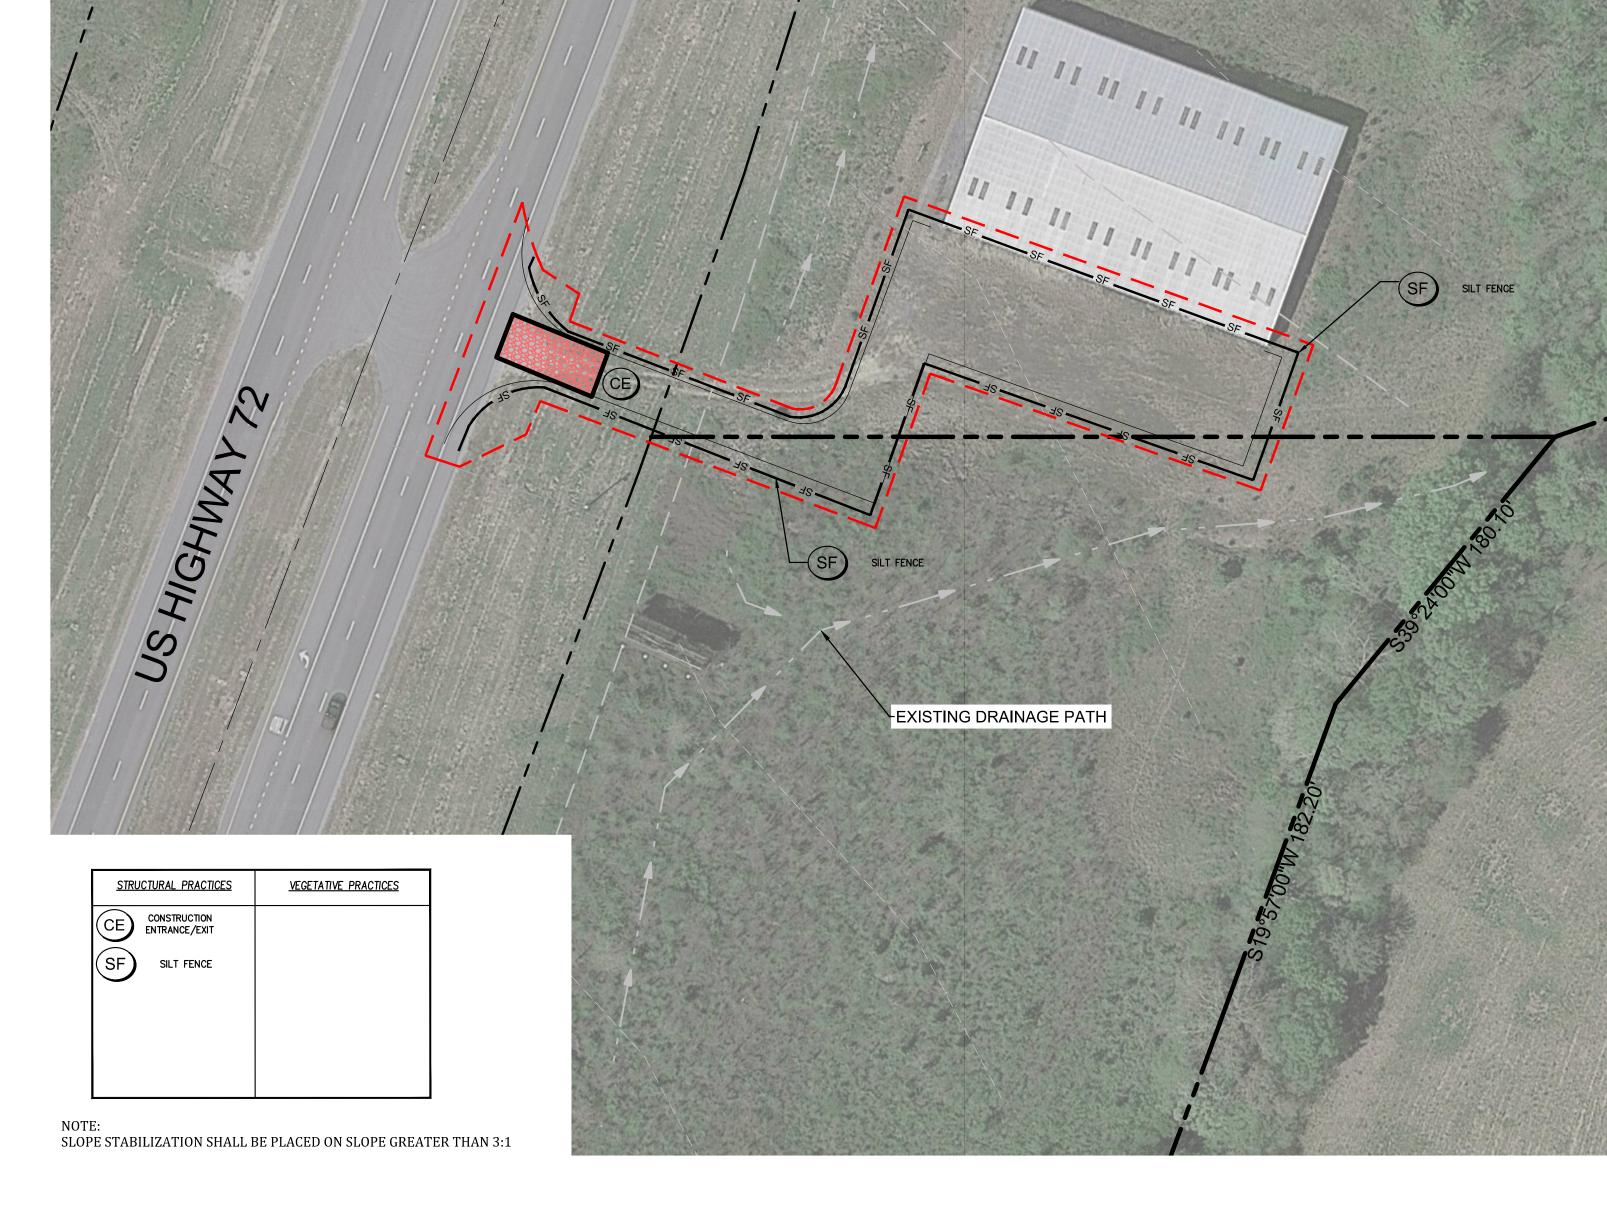

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EMAN - DRIVEWAY

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09-07

Date: 09-07-2022

Approved By: JEF

Revisions:

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Drawing Title:

TRAFFIC CONTROL PLAN

Drawing No.

C3.1



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EEEMAN - DRIVEWA

Scale: 1"=300'

Date: 09-07-2022

Approved By: JEF

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Drawing Title:

SIGHT DISTAN

SIGHT DISTANCE PLAN

Drawing No.

C3.2

TYPICAL PAVEMENT SECTION INSIDE ALDOT ROW

Geotextile fabric Source: Smith Cattle Guard Company * According to ASTM D4632/D4632M : When geotextile elongation ≥ 50%, use 4 ft. post spacing SILT FENCE SF DEWATERING HOLES SHALL BE 1"-1.5"IN DIAMETER AND SPACED 2"-3" APART TO ALLOW FOR DEWATERING IN NO MORE THAN 48 HOURS. Precast, reinforced concrete 3. FASTEN DEWATERING DEVICE TO THE 2X4 SIDE BRACE. Wash Rack Details 4. STAPLE GEOTEXTILE FABRIC TO DEWATERING DEVICE AND CUT CROSS SLITS IN THE FILTER FABRIC AT THE HOLE LOCATIONS TO ALLOW WATER TO FLOW THROUGH.

5. USE 8 0Z. NON-WOVEN GEOTEXTILE FOR UNDERLAYMENT AND 4 OZ. NON-WOVEN GEOTEXTILE FOR SILT FENCE.

Ditch to carry wash water to sediment basin or trap

CONSTRUCTION EXIT CE

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NTS 09-07-2022 Approved By:

Drawing Title:

DETAILS

Drawing No.

