GENERAL NOTES:

1. CODE COMPLIANCE: All work is to be performed in accordance with all governing Codes, Ordinances and Regulations. The designs herein are based on the 2019 C.B.C., 2019 S.F.B.C., 2019 S.F.M.C., 2019 S.F.E.C, 2019 S.F.P.C., 2019 S.F.F.C., 2019 C. Energy C.

2. JOB COORDINATION & SAFETY: Contractor shall be responsible for the development, coordination and execution of construction methods and procedures. The Contractor shall also be responsible for initiating, maintaining and supervising all safety precautions and programs in connection with his work.

3. JOB CLEANLINESS: Contractor shall on a daily basis leave the construction site "broom clean" at the end of the work day. At substantia completion, the Contractor shall turn to the Owner a spotlessly clean house, including clean mirrors, glass, light bulbs, walls, floors, cabinetry inside and out, bathroom fixtures, tiles and appliances.

4. CONSTRUCTION QUALITY: No guarantee for quality of construction is implied or intended by the architectural documents, and the Contractor shall assume full responsibility for any or all construction deficiencies.

5. CONTRACT DOCUMENT REVIEW: Contractor shall review all Contract Documents. If fifteen days elapse from the time the Contractor receives the plans and signs to perform the work, and the Owners have not been notified of any errors, omissions or objections the Owners will consider the documents approved by the Contractor for the performance of his/her work.

6. DISCREPANCIES: In case of any discrepancy notify the Owners before proceeding. Contractor shall be responsible for correction of work at his/her own expense for work installed in conflict with the Contract Documents.

7. DIMENSIONS: All dimensions shown on plans are to face of stud, unless otherwise noted. All dimensions shown on interior elevations are finish dimensions. No dimensions shall be taken by measuring from the drawings. Details take precedence over general sections or plans. Written dimensions take precedence over scale. All dimensions shall be verified in the field for coordination with existing and new

8. SUBSTITUTIONS: The Contractor will be held to furnish under his Proposal all work described herein. All materials and articles of any kind necessary for this work are subject to the approval of the Owners.

9. MANUFACTURED ITEMS: Transport, handle, store, protect and install manufactured items in strict accordance with manufacturer's recommendations. Should conflict exist between construction documents and manufacturer's instructions, consult with Designer.

10. ASBESTOS: Asbestos removal is not intended to be covered by this contract. If Asbestos is suspected, a testing agency must be hired to verify, and special procedures must be used for removal and disposal. Friable asbestos is the dangerous type and was used extensively for pipe insulation, fireproofing and certain building materials up to 1970.

11. CUTTING AND PATCHING: Cut and fit components as required; patch disturbed areas to match adjacent materials and finishes.

12. ATTIC VENTILATION: Ventilating area shall not be less than 1/150th of the net area of the space ventilated. If at least 50% of required ventilation is provided in the upper portion of the space, then ventilating area may be 1/300th of the attic space per section 2019 CBC 1203.2.

13. BLOCKING: Provide solid blocking as necessary for all wall mounted shelves, fixtures and fittings. See interior elevations, where

14.WATER TIGHTNESS: Contractor shall verify that all work on the exterior of the project is watertight. All joints and surfaces exposed to the elements shall be tested for water tightness prior to substantial completion.

15.WATERPROOF MEMBRANE: Install a waterproof membrane under the Master Shower floor @ the Master Bath. Wrap the membrane up a minimum of 8" on all surrounding surfaces.

16. GLAZING: Tempered glazing is required as per 2019CBC. Glazing to be tempered includes but is not limited to: glazing that is less than 18" above finish floor; within 24" radius of doors; Glass door and panels of shower and bathtub enclosures and adjacent glazed openings within 60" above a standing surface and drain inlet shall be fully tempered, laminated safety glass as per UBC 2406.3 & .4; skylights; etc...

17. DRYWALL: All drywall to be 5/8" thick. Install metal corner beads at all outside corners. Fasten drywall to framing with drywall screws. All drywall is to be sanded three times to produce a smooth finish for all walls and ceilings. All drywall shall be finished so that it is smooth, with no bumps or craters. All joints to be taped and sanded so that there is no distinguishable transition. Contractor shall deliver all new or repaired walls perfectly even. The owners' and designer's criteria will be the sole measure for approval of the finished work.

18. HANDRAILS AND GUARDRAILS: All handrails at stairs are 34" above tread nosing. All guardrails are 42" minimum to finish floor, U.O.N. See interior elevations or details, as applicable, for guardrail design.

19. SHOWER AND TUB W/ SHOWER: Provide ceramic tile or stone finish at all shower and tub w/ shower areas to a minimum height of 72" above the drain inlet AS PER 2019 CBC 1210.2.2; over a moisture resistant underlayment (typical). Verify with interior elevations, if applicable. All showers & shower/tub combinations to have pressure balance mixing valves as per UPC section 410.7

20. PLUMBING: All work is design/build by the Plumbing contractor and is to meet required codes and Title 24 requirements. Low flow plumbing fixtures & fittings will be used in all bathrooms, etc... Toilets to have a max. allowable flush of 1.28 gal. When there are fixtures @ three levels, cast iron or other approved non-plastic materials for drain, waste, & vents is to be used.

21. TITLE 24 RESIDENTIAL LIGHTING REQUIREMENTS

- A) All residential lighting to be high efficacy as per Table 150.0-A
- **B**) At least one fixture in bathrooms, garages laundry room and utility rooms must be controlled by a vacancy sensor.
- C) Lighting in kitchens, bathrooms, garages, laundry room and utility rooms shall be high efficacy or either controlled by a dimmer switch or
- **D)** Recessed lights in insulated ceilings must be ic and at(air tight) rated. recessed lights within 5'-0" of a common prop. line to have 1hr rated
- E) Exterior building mounted lighting must be high efficacy and must include manual on/off switchand one of the following: photocontrol & motion sensor - photocontrol & automatic time switch control - astronomical time switch control or energy management control system. F) Common areas of low-rise residential buildings with four or more units must be high efficacy or controlled by a title 24 compliant

210.12 (A).

- **G**) Under cabinet lighting (including kitchen) must be switched seperatly from other lighting systems. H) All nonlocking-type 125 volt, 15- and 20-ampere receptacle outlets shall be listed tamper-resistant receptacles, as per Electrical Code
- I) All 120-volt, single phase, 15- and 20-ampere outlets or devices installed in dwelling unit kitchens, family rooms, dining rooms, living rooms, bedrooms, closets, hallways, laundry or similar rooms or areas shall be arc-fault circuit-interrupter protected as per Electrical Code
- **21.** TITLE 24 RESIDENTIAL LIGHTING REQUIREMENTS A) All residential lighting to be high efficacy as per Table 150.0-A
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- **G**) Under cabinet lighting (including kitchen) must be switched seperatly from other lighting systems.
- H) All nonlocking-type 125 volt, 15- and 20-ampere receptacle outlets shall be listed tamper-resistant receptacles, as per Electrical Code
- I) All 120-volt, single phase, 15- and 20-ampere outlets or devices installed in dwelling unit kitchens, family rooms, dining rooms, living rooms, bedrooms, closets, hallways, laundry or similar rooms or areas shall be arc-fault circuit-interrupter protected as per Electrical Code 210.12 (A).

ARCHITECTURAL SHEETS:

- A1.0 PROJECT INFO. LEGENDS, GENERAL NOTES &
- A1.1 SITE PLAN, AB-017, DA CHECKLIST
- A2.0 EXIST. /DEMO 1ST FLR, PROP. 1ST FLR. TRAVEL DISTANCE DIAGRAM
- **A2.1** EXIST. 2ND FLR, PROP. BUILDING SECTION, ARCH. DETAIL
- **A3.0** EXIST. & PROP. NORTH (FRONT) ELEVATION DOOR SCHEDULE, WINDOW SCHEDULE, ENTRY DOOR CLEARANCES, STOREFRONT DETAILS
- **A4.0** ADA RESTROOM ELEVATIONS @ TENANT SPACE "B" ADA REQUIREMENTS, ADA W.C.
- WALL AND DOOR SIGNAGE, RCP PLAN **A4.1** ADA RESTROOM ELEVATIONS @ TENANT SPACE "A", ADA REQUIREMENTS

TOTAL NO. OF SHEETS: 7

DRAWING SYMBOL LEGEND

PROJECT AREA

Partition/wall to be demolished Fittings/fixtures to be removed

New Partition/wall

Existing Partition/wall

Detail Number [typical]

- Sheet Number [typical]

Interior Elevation/multiple elevations Elevation Number [typical] Sheet Number [typical] Indicates walls elevated

> Elevation Elevation Number [typical] Sheet Number [typical] Building Section

> > - Section Number [typical]

Sheet Number [typical]

Door Number Keynote Note number [typical] Dimension Line ·· — · — Center Line

PROJECT AREA

FLOORS

1ST FLOOR

2ND FLOOR

Revision: Clouded area indicates revised area Revision symbol/see title block

Elevation Level

Window Type

Wall Section Section Number [typical]

GROSS

EXISTING

AREA

2386 sq.ft.

1559 sq.ft.

3945 sq.ft

EXISTING

GARAGE

AREA

642 sq.ft

0 sq.ft.

EXISTING

TENANT

SPACE # 3119

2398 sq.ft.

0 sq.ft.

PROJECT DESCRIPTION:

THE SCOPE OF WORK IS LIMITED TO CORE & SHELL IMPROVEMENTS TO CREAT TWO SEPARATE TENANT SPACES, EACH WITH A UNISEX RESTROOM; NEW SECOND STORE FRONT ENTRY AREA AT THE FORMER GARAGE DOOR OPENING. REMOVE PORTION OF EXISTING REAR ONE-STORY AREA FOR OPEN SPACE. BOTH TENANT SPACES WILL REMAIN VACANT AND ALL TENANT IMPROVEMENTS WILL BE UNDER SEPARATE TENANT IMPROVEMENT PERMIT.

RES. & 1 COMMERCIAL

PROPOSED OPEN

SPACE / REDUCTION OF

324 sq.ff

0 sq.ft.

PROJECT DATA

ZONING:

STORIES:

UNITS:

HEIGHT LIMIT

PROPOSED

TENANT

SPACE "A"

645 sq.ft

0 sq.ft

645 sq.f

EXISTING: PROPOSED: [NO CHANGE] NCT 45-X 45-X EXISTING OCCUPANCY: R-3 / B R-3 / B TYPE V-B W/O SPRINKLER TYPE V-B W/O SPRINKLER CONSTRUCTION:

1 RES. & 1 COMMERCIAL

ADDED

AREA

ONDITIONED

645 sq.ft

645 sq.ft

0 sq.ft

NON SPRINKLERED

GROSS

PROPOSED

AREA

2062 sq.f

1559 sq.f

3621 sq.f

SPRINKLERS: NON SPRINKLERED

PROPOSED

TENANT

SPACE "B"

1310 sq.ft

0 sq.ft.

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94110 HELL STREET 24TH FRANCISCO 3117-3119


SHEET TITLE PROJECT INFO, LEGENDS, GENERAL NOTES

PROJECT AREA

SCALE: N/A

JOB NO. 21.06



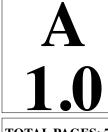

ratified by the Access Appeals Commission (see UHR form for details)

~ 7 ~

7. Fill out Request for an Unreasonable Hardship form for each item checked and attach to plan. All UHR must be

3135-3138 24TH STREET (4 STORIES ADJACENT REAR YARD RESIDENCES) I ÞÁRKING +METER (E) UTILITIES 7 PROPERTY LINE 100.00' (1 STORY BELOW) (E) ROOF DECK ROOF 1 STORY AREA/ // TO BE // REMOVED - (1 STORY BELOW) 3117-3119 **PROJECT 24TH STREET** S **ROOF DECK** (2 STORIES) H /13'-0'' (E) SEWER VENT PÁRKING METER PROPERTY LINE 100.00' (E) SIDEWALK **3111 24TH STREET** (E) LIGHT-(3 STORIES **ADJACENT** RESIDENCE) REAR YARD **EXISTING SITE PLAN** 3135-3138 24TH STREET (4 STORIES REAR YARD **ADJACENT** RESIDENCES) PÁRKING +METER PROPERTY LINE 100.00' LT.WELL (1 STORY BELOW) (N) 8' FENCE (E) ROOF DECK (TÝP) (OPEŃ) REAR YARD ROOF - (1 STORY BELOW) 3117-3119 PROJECT SITE **24TH STREET ROOF DECK** (2 STORIES) /13'-0" (E) SEWER PARKING PROPERTY LINE 100.00' (E) SIDEWALK **3111 24TH STREET** (3 STORIES REAR YARD **ADJACENT** RESIDENCE) PROPOSED SITE PLAN SUBJECT PROPERTY - SUBJECT PROPERTY (1) LOOKING SOUTH AT ROOF 2 LOOKING SOUTH (FRONT FACADE) **SITE PHOTOS**

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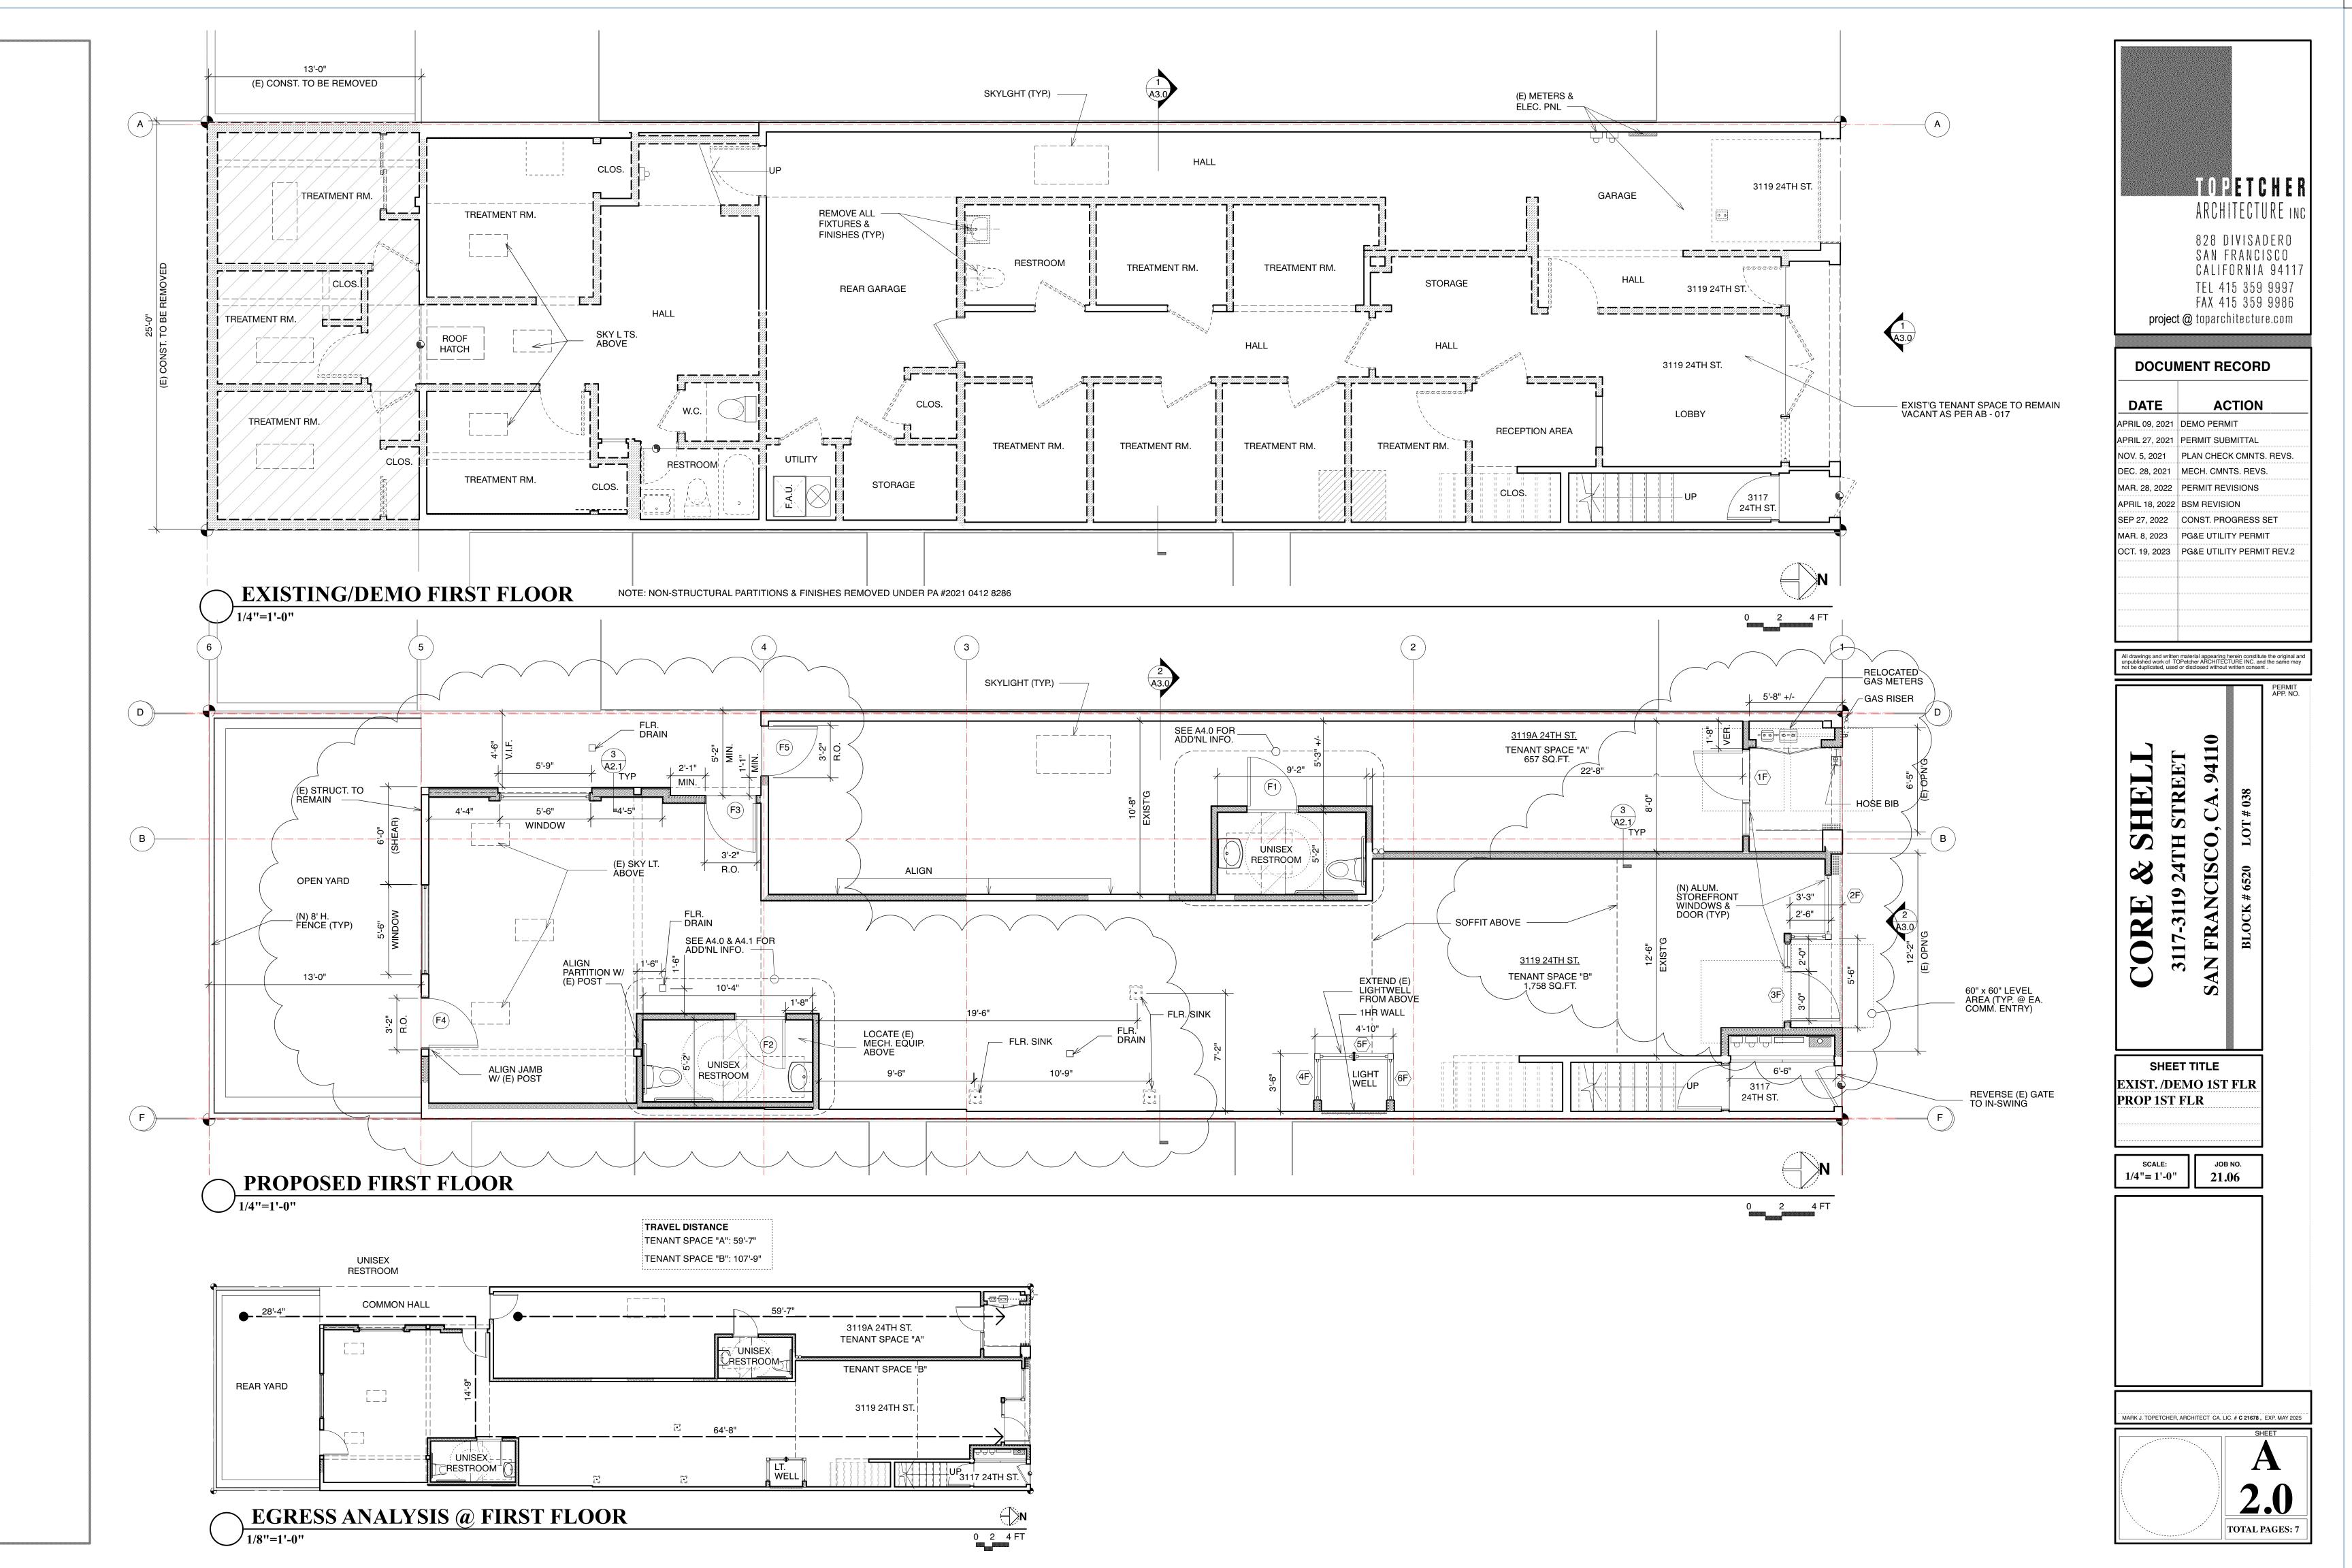
SHEET TITLE SITE PLAN **AB-017** DA-CHECKLIST


AS NOTED


21.06

TOTAL PAGES: 7

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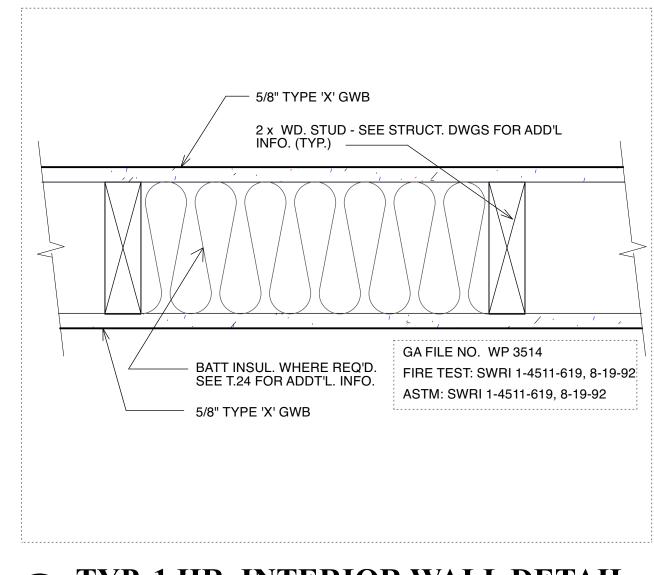




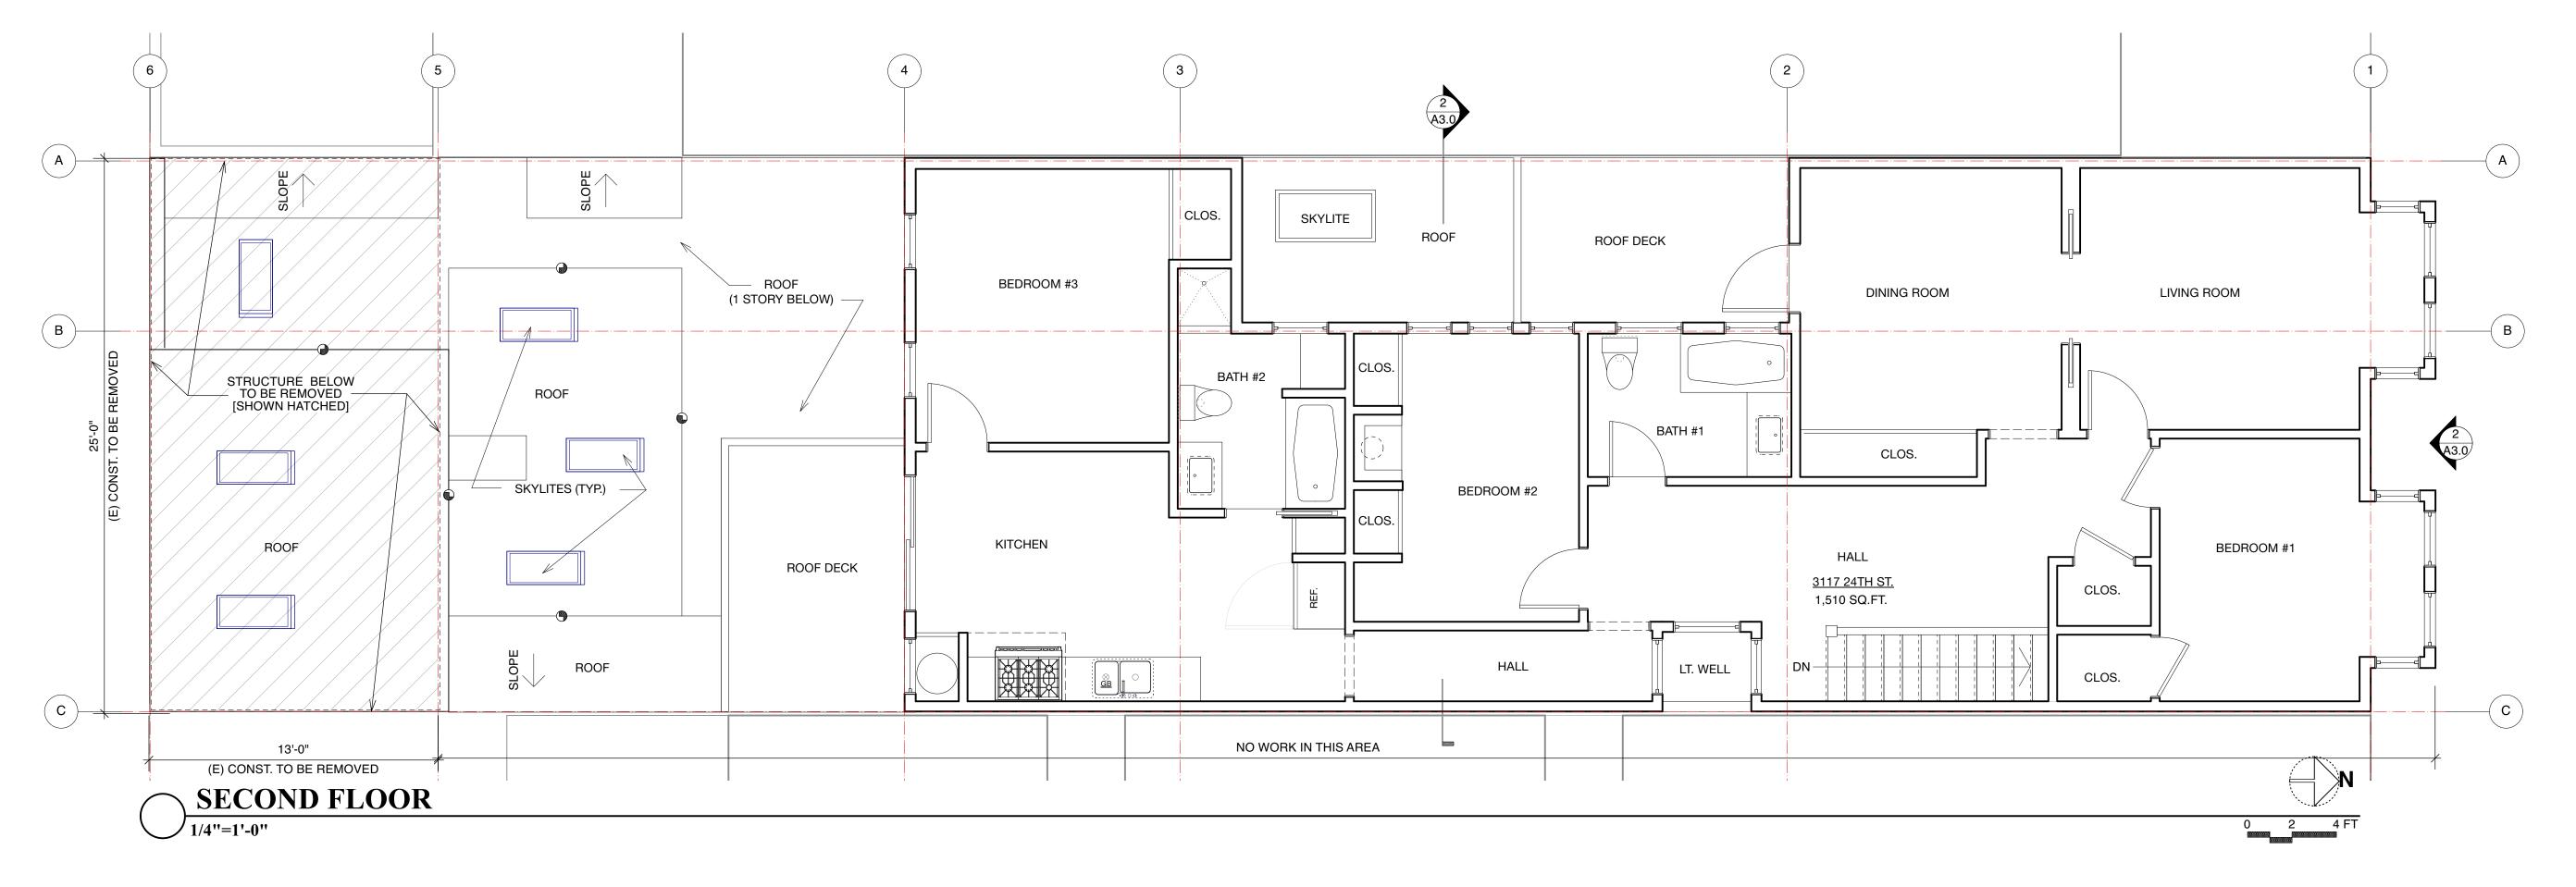

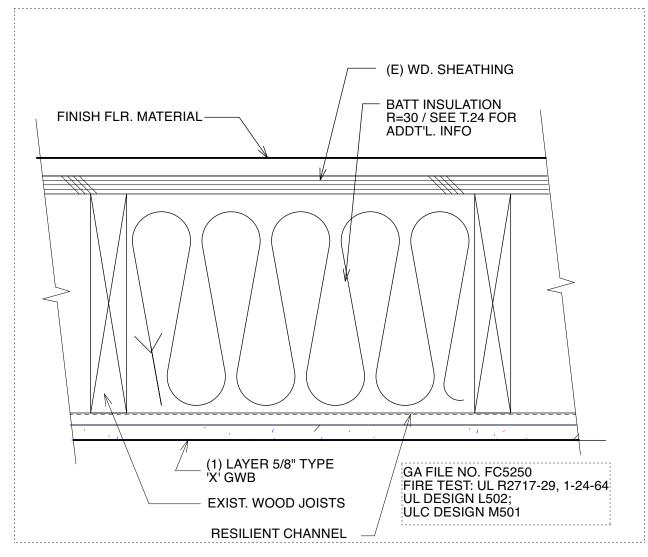
TYP. 1 HR. INTERIOR CL'G. DETAIL

Scale: 3" = 1'-0"



TYP. 1 HR. INTERIOR WALL DETAIL

Scale: 3" = 1'-0"

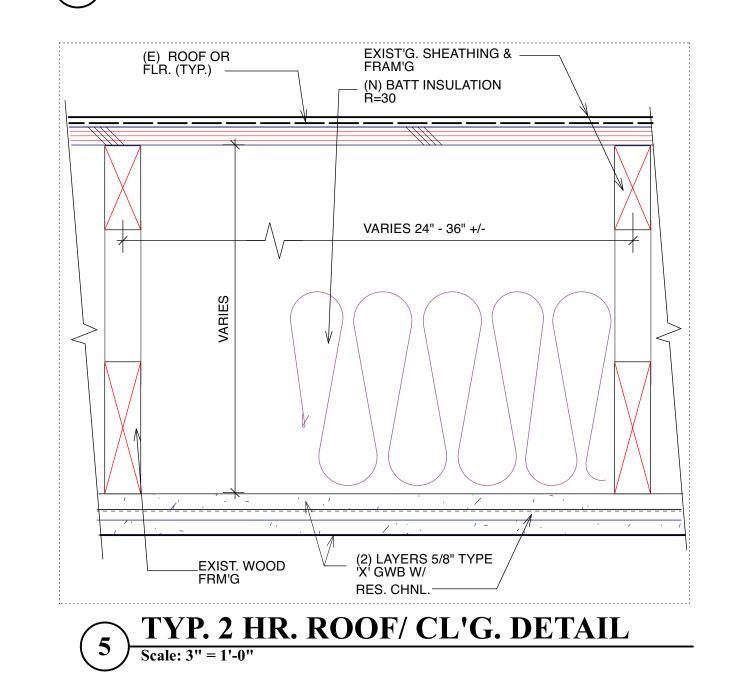

BEDRM #2

NO WORK \$\frac{5}{4}\$

TYP

\$\frac{5}{42}\$


TENANT SPACE "A"

TENANT SPACE "B" \$\frac{5}{4}\$

TENANT SPACE "B" \$\fra


PROPOSED BUILDING SECTION

1/4" = 1'-0"

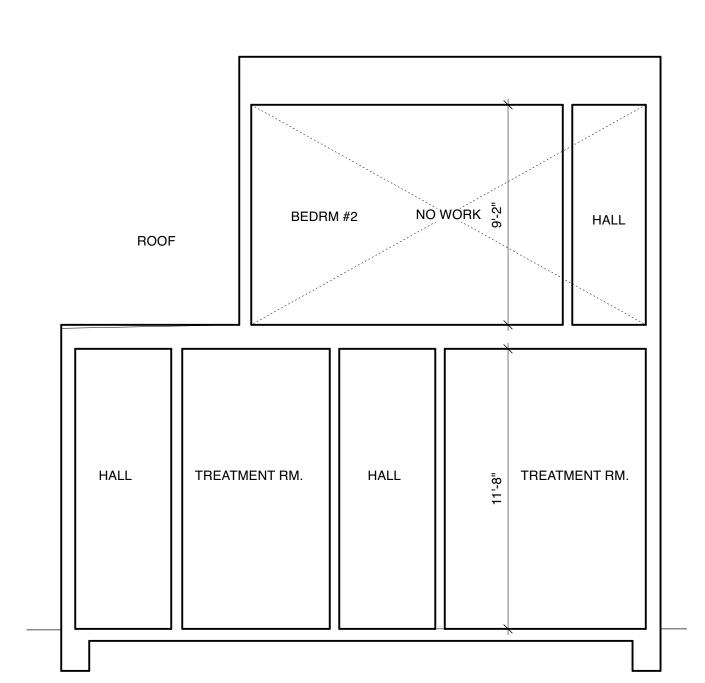

1 EXISTING BUILDING SECTION

1/4" = 1'-0"

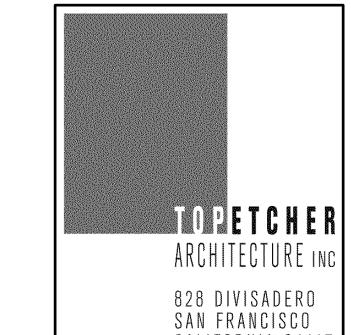

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CORE & SHELL
3117-3119 24TH STREET
SAN FRANCISCO, CA. 94110
BLOCK # 6520 LOT # 038


SHEET TITLE
EXIST. /2ND FLR
BUILDING SECTION
ARCH. DETAILS


SCALE: JOB N

AS NOTED 21.06

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A 2.1 TOTAL PAGES: 7



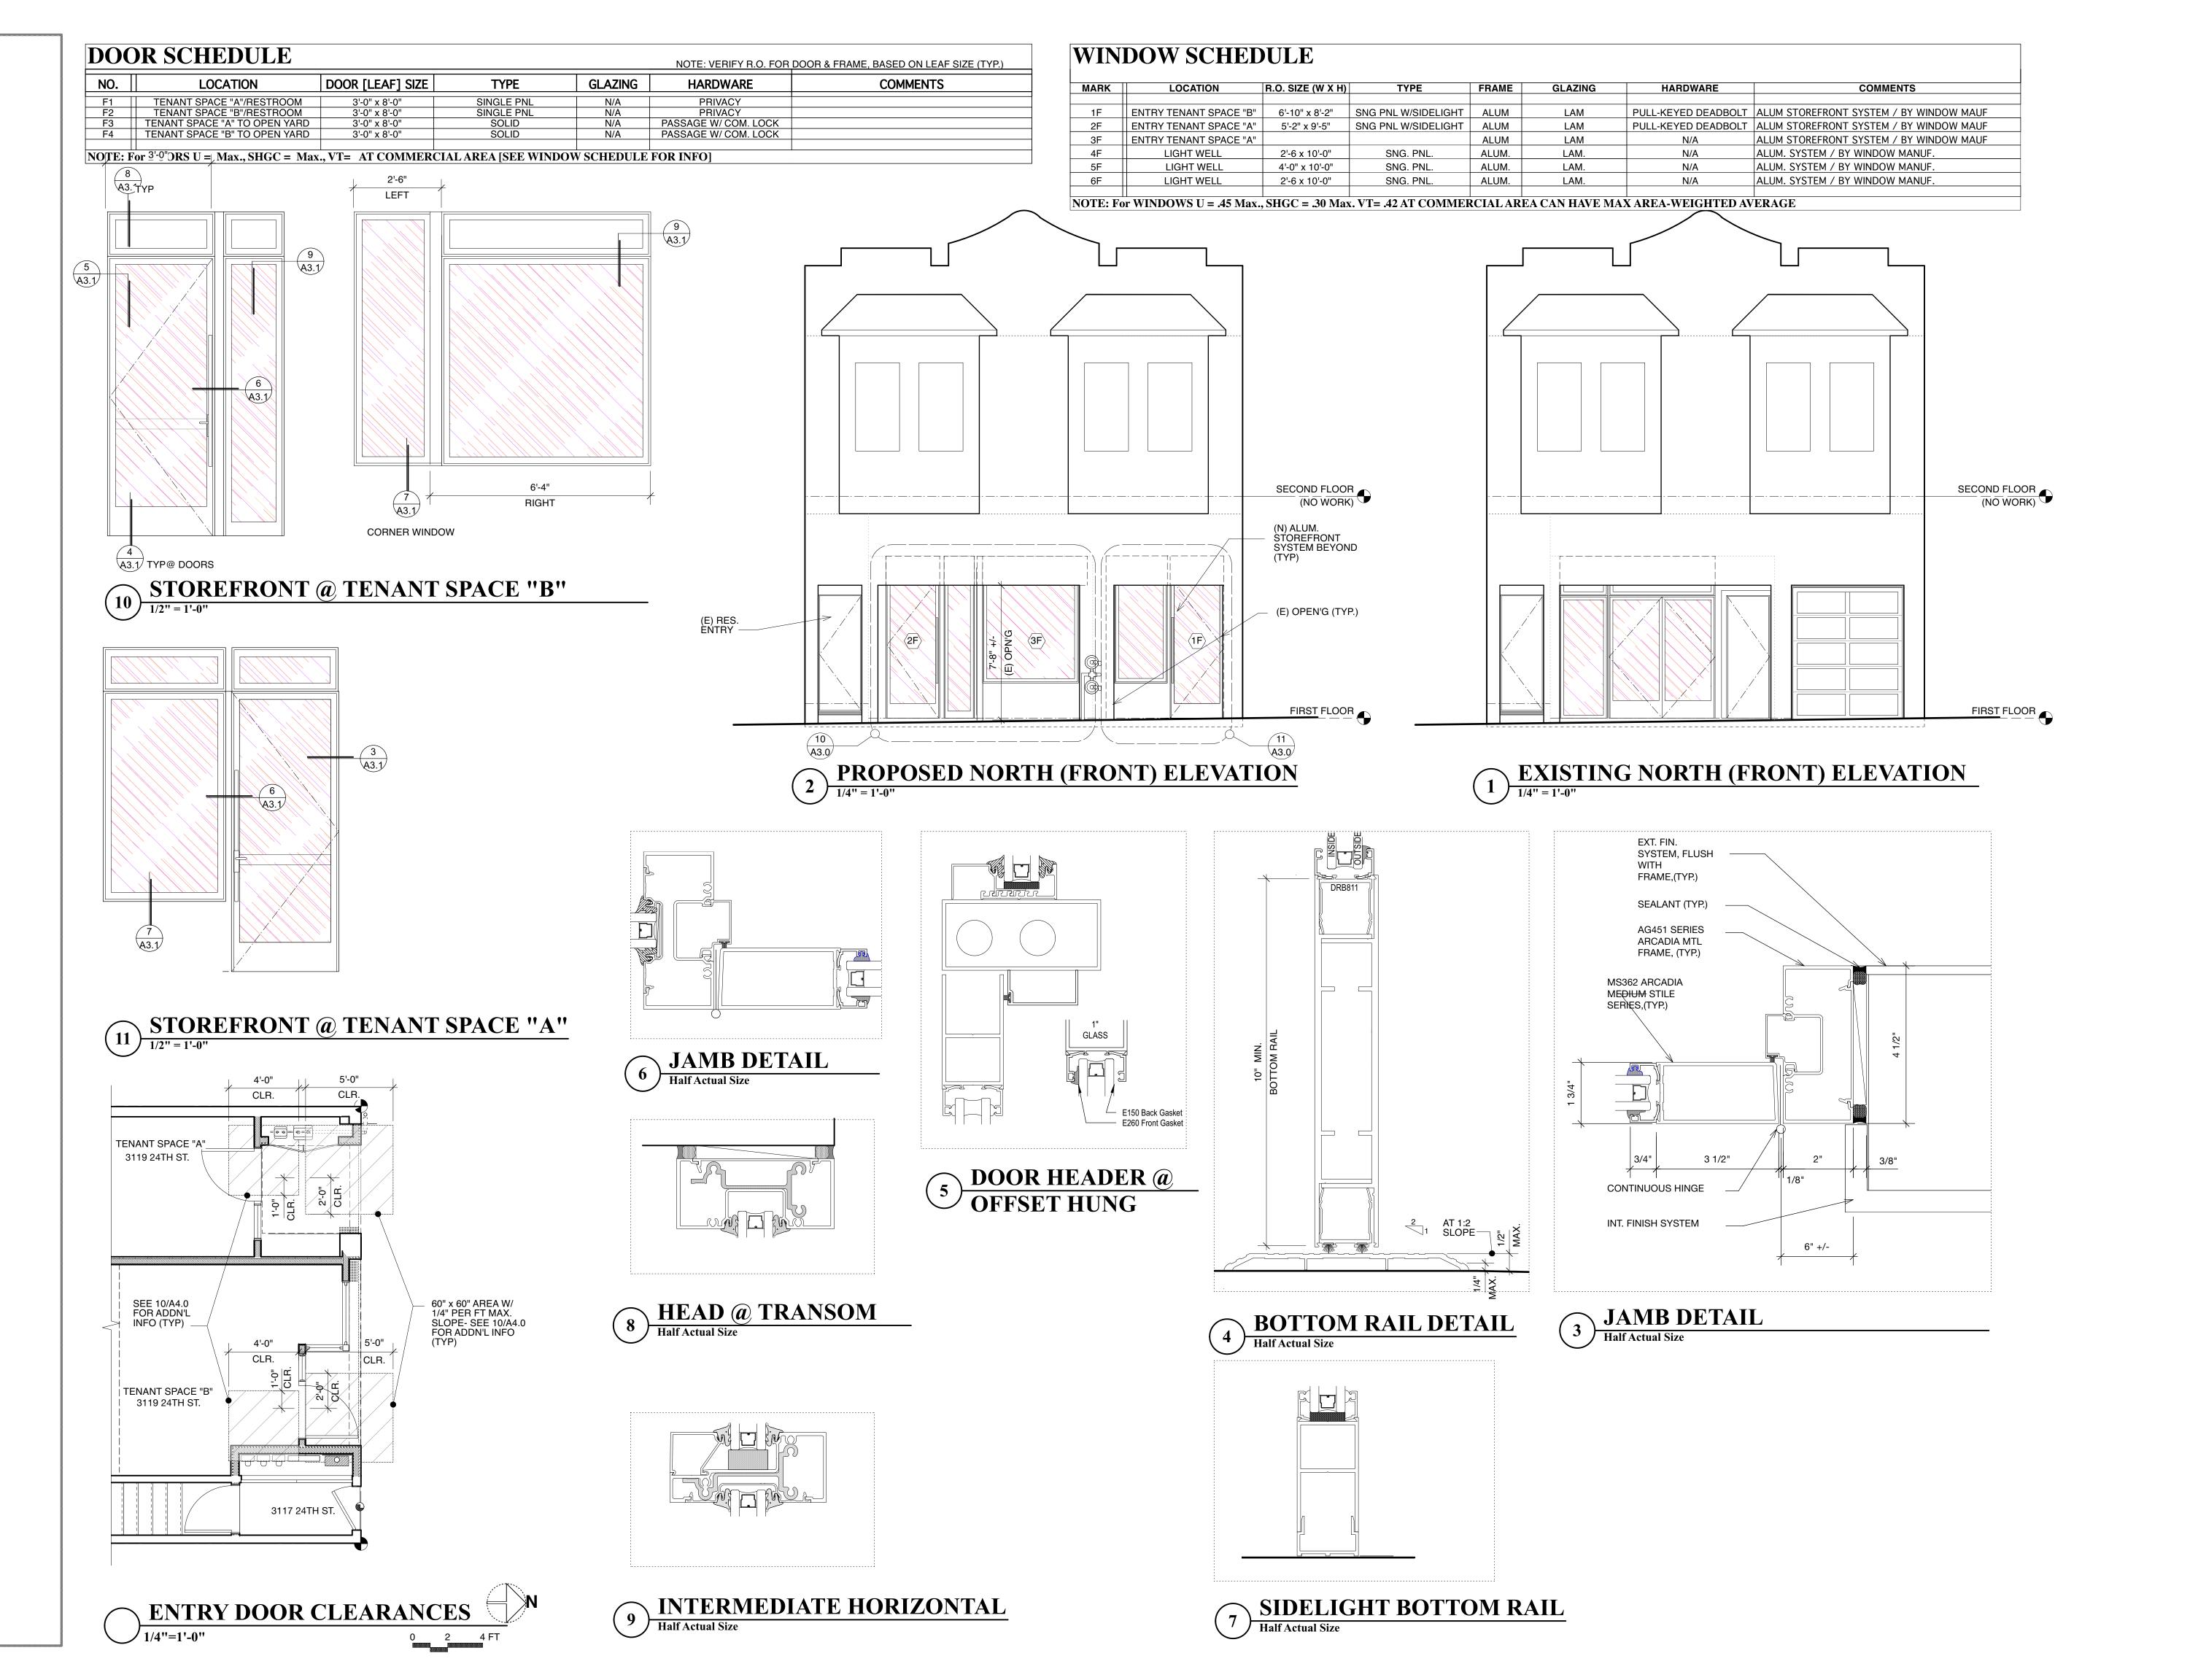
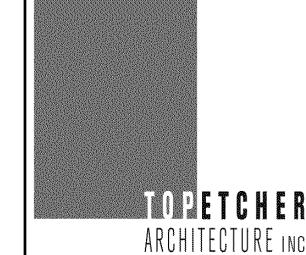
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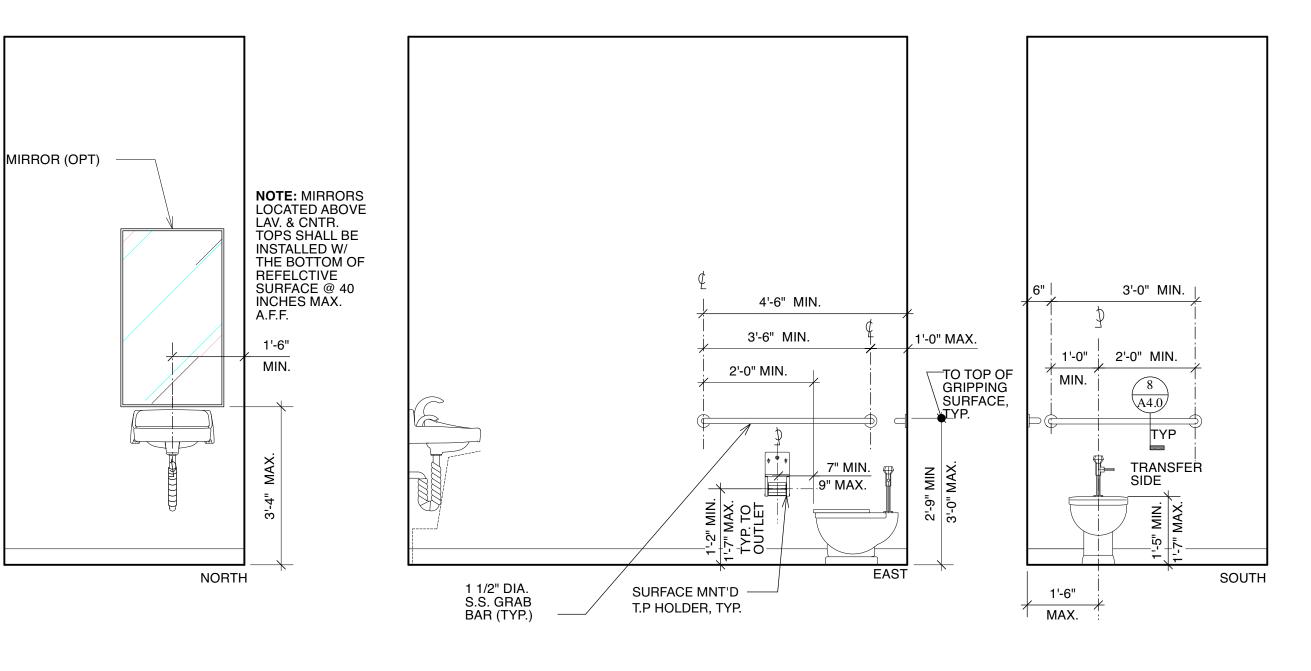
STREET


3117-3119 24ТН § **FRANCISCO**

SHEET TITLE EXTERIOR ELEVATION DOOR SCHEDULE WINDOW SCHEDULE DETAILS

AS NOTED

21.06



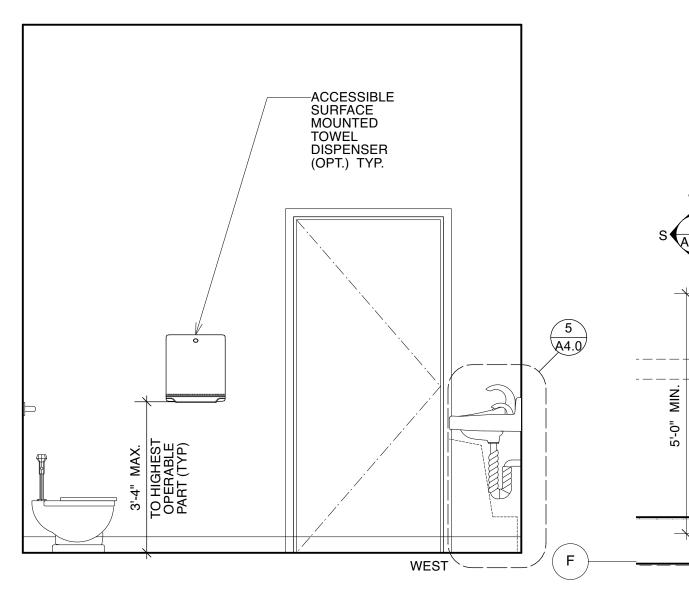

HATCH DENOTES — DOOR CLEARANCES NEEDED AT EA DOOR, SEE 5/A4.1 FOR ADD'NL INFO TACTILE SIGN **BATHROOM** DOOR - CLR **FLR SPACE** CENTERED ON TACTILE CHARACTERS 2'-8" CLR. PASS 1'-10" TYP. SEE 11/A4.0 (TYP.) SEE DTL 11/A4.0 MIN. OPERABLE PARTS SHALL BE 5 POUNDS MAX. 5'-0" MIN. CLR. TURNING RADIUS 4'-0" MIN. CLR. ⊒FLR. MNT'Ò TOÍLET*⊈* 30" x 48" CLR. SPACE ———

TENANT "B" UNISEX PLAN DETAIL

1/2"=1'-0" / DIM. SHOWN ON THIS PLAN ARE FIN. DIM.

. ALL TOWELS, WASTE BINS DRYERS, SANITARY NAPKINS & SOAP DIŚPENSERS OPERABLE PARTS TO BE 3'-4" MAX. HEIGHT ABOVE FLOOR PER ADA.

OPERABLE PARTS SHALL BE OPERABLE WITH ONE HAND AND SHALL NOT REQ. TIGHT GRASPING, PINCHING, OR TWISTING ÓF WRIST. THE FORCE RQ'D. TO ACTIVATE

• FLUSH CONTROLS TO BE HAND OPERATED OR AUTOMATIC. HAND OPERATED FLUSH CONTROLS TO BE 44 INCHES AF.F. MAX. & TO BE LOCATED ON THE OPEN SIDE OF WATER CLOSET, TYP.

• 56 INCH CLEARANCE NEEDED FOR WALL MOUNTED TOILETS AND 59 INCHES CLEARANCE NEEDED FOR FLOOR MOUNTED TOILETS

DOCUMENT RECORD

DATE **ACTION** APRIL 09, 2021 | DEMO PERMIT APRIL 27, 2021 PERMIT SUBMITTAL NOV. 5, 2021 PLAN CHECK CMNTS. REVS. DEC. 28, 2021 MECH. CMNTS. REVS. MAR. 28, 2022 | PERMIT REVISIONS APRIL 18, 2022 BSM REVISION SEP 27, 2022 | CONST. PROGRESS SET MAR. 8, 2023 | PG&E UTILITY PERMIT OCT. 19, 2023 | PG&E UTILITY PERMIT REV.2

TOPETCHER

ARCHITECTURE INC

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94110

STREET 24TH 00 CIS 3117-3119 FR

SHEET TITLE INT. ELEVATIONS @ ΓENANT SPACE "Β'

SCALE: **AS NOTED**

RCP PLAN

ADA DETAILS

JOB NO. 21.06

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TOTAL PAGES: 7

UNISEX BATHROOM ELEVATION (TENANT "B")

1/2"=1'-0" - TENANT "B" SIM.

LOCATION FOR OTHER HARDWARE ITEMS: KICK, HOP AND ARMOR PLATES, UNLESS OTHERWISE SPECIFIED, SHALL EXTEND TO WITHIN 1/4" FROM THE BOTTOM OF THE DOOR AND THEIR HORIZONTAL LENGTH TO BE AS FOLLOWS: PARTIAL PLAN VIEW SINGLE DOORS - NOMINAL DOOR WIDTH LESS 2" **ALTERNATE CONDITION** (PUSH SIDE) AND NOMINAL DOOR WIDTH LESS 1"

WHERE SWITCHES OCCUR AT

THE END OF THE DOOR

LOCATE SWITCHES ETC.

WITHIN 1'-6" OF END OF

DOOR. FOR ADDITIONAL NOTES, SEE BELOW.

EMERGENCY INDICATOR LIGHT (WHERE OCCURS)

TACTILE RESTROOM SIGN

TOP ROW OF ELECTRICAL

SWITCHES, DIMMERS, PROJ.

PLACE WITHIN 1'-6" OF DOOR

PROVIDE ADDITIONAL ROWS

DUPLEX WALL OUTLET. ALIGN WITH SWITCH IF OUTLET IS

TYPICAL ELECTRICAL

WITHIN 2'-0" OF DOOR

AS REQUIRED. LIGHT SWITCHES

ON TOP ACCESSORY SWITCHES

SCREEN CONTROLS, ETC.

TACTILE ROOM AND/OR EXIT

THERMOSTAT (WHERE OCCURS)

FLASHING STROBE

SIGN (SEE 9/A4.0)

BELOW

ADA DOOR SIGNAGE & HARDWARE

ADA DOOR SIGNAGE

1/2" = 1'-0"

SWINGS (SEE PLAN).

FOR DOORS 7'-0" HIGH OR SHORTER LOCATE BOTTOM AND TOP HINGE AS SHOWN - LOCATE MIDDLE HINGE EQUIDISTANT BETWEEN TOP AND **BOTTOM HINGES**


WIDTH LESS 1" (BOTH SIDES)

(PULL SIDE) DOORS OF PAIRS - NOMINAL DOOR

DOOR HINGE (TYP) EQ. ÆQ. - COAT HOOK - HT. OF PUSH PLATE - ROLLER CATCH LATCH, DEADBOLT WHERE PUSHPLATE OCCURS -HT. OF PUSH/PULL BAR, U.O.N. - HT. OF ACCESSIBLE LATCH/LOCKSET OR PANIC BAR -FINISH FLOOR LOCATE SILENCERS OPP. HINGE LOCATIONS & 6" EA.


SIDE OF CENTER OF

ADA DOOR SIGNAGE & HARDWARE

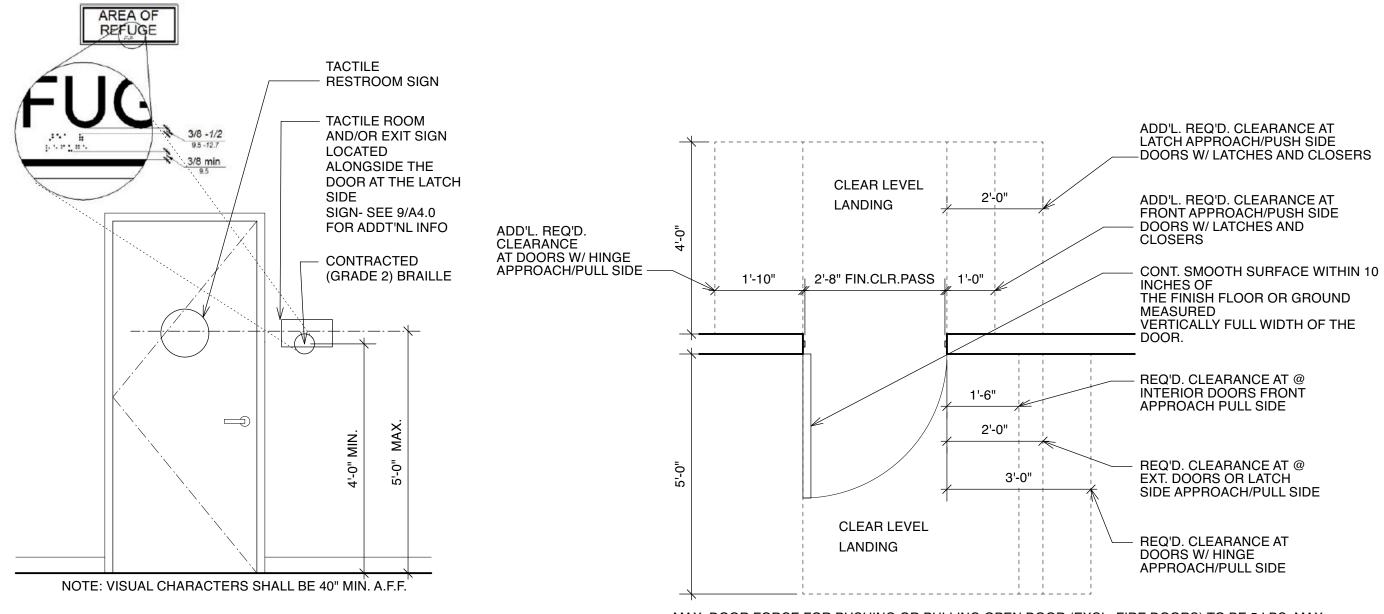


MAX. DOOR FORCE FOR PUSHING OR PULLING OPEN DOOR (EXCL. FIRE DOORS) TO BE 5 LBS. MAX. MINIMUM DOOR FORCE FOR PUSHING OR PULLING OPEN FIRE DOORS TO BE THE MINIMUM OPENING FORCE ALLOWABLE BY THE LOCAL CODE OFFICIAL, AND SHALL NOT TO EXCEED 15 LBS.

TYP. ACCESIBLE DOOR CLEARANCES

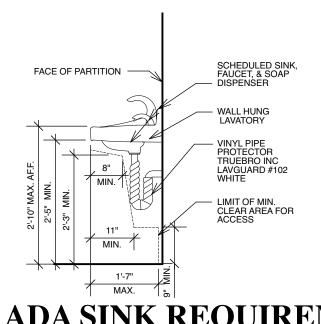




SIGNS:

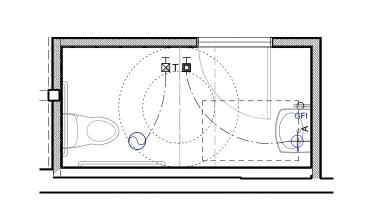


TENANT "B" RCP PLAN

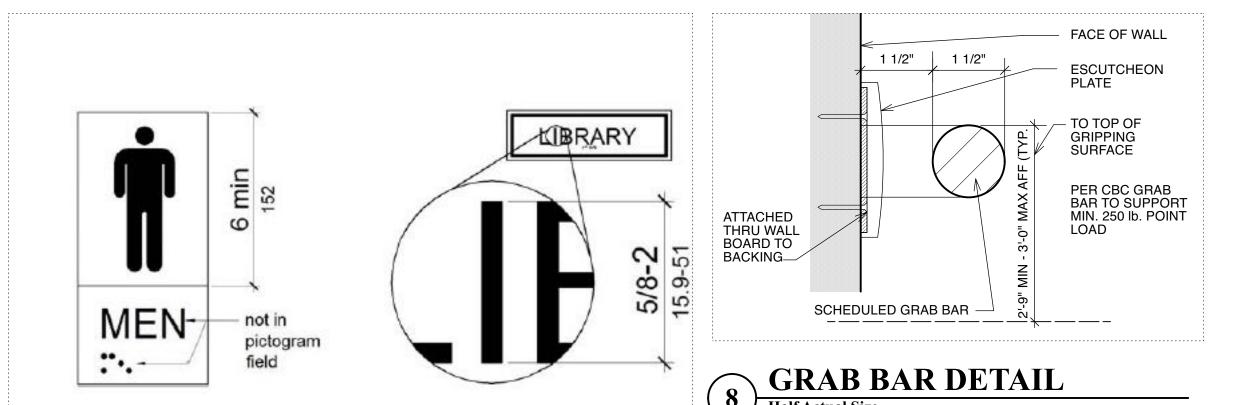


distance between corresponding dots distance between dots . CHARACTERS SHALL BE SANS SERIF AND 1/32" MIN. RAISED ABOVE THEIR BACKGROUND. in adjacent cells in the same cell CHARACTERS SHALL BE UPPERCASE, SHALL NOT BE ITALIC, single braille OBLIQUE, SCRIPT OR HIGHLY DECORATIVE. . CHARACTERS SHALL BE SELECTED FROM FONTS WHERE THE WIDTH OF THE UPPERCASE "O" IS 60% MIN. AND 110% MAX. OF distance between dots THE HEIGHT OF THE UPPERCASE LETTER "I". in the same cell STROKE THICKNESS OF THE UPPERCASE LETTER "I" SHALL BE blank cell space 15% MAX. OF THE HEIGHT OF CHARACTER. between words CHARACTER SPACING SHALL BE MEASURED BETWEEN THE TWO CLOSEST POINTS OF ADJ. RAISED CHARACTERS WITHIN A MESSAGE, EXCLUDING WORD SPACES. raised dot distance between corresponding dots from one cell directly below SPACING BETWEEN THE BASELINE OF SEPERATE LINES OF RAISED CHARACTER WITHIN A MESSAGE SHALL BE 135% MIN. & 170% MAX. OF THE RAISED CHARACTER HEIGHT.

MEASUREMENT RANGE	MINIMUM IN INCHES MAXIMUM IN INCHES
Dot base diameter	0.059 (1.5 mm) to 0.063 (1.6 mm)
Distance between two dots in the same cell ¹	0.100 (2.5 mm)
Distance between corresponding dots in adjacent cells ¹	0.300 (7.6 mm)
Dot height	0.025 (0.6 mm) to 0.037 (0.9 mm)
stance between corresponding dots from one cell directly below ¹	0.395 (10 mm) to 0.400 (10.2 mm)

9 ADA W.C. WALL SIGNAGE
N.T.S.

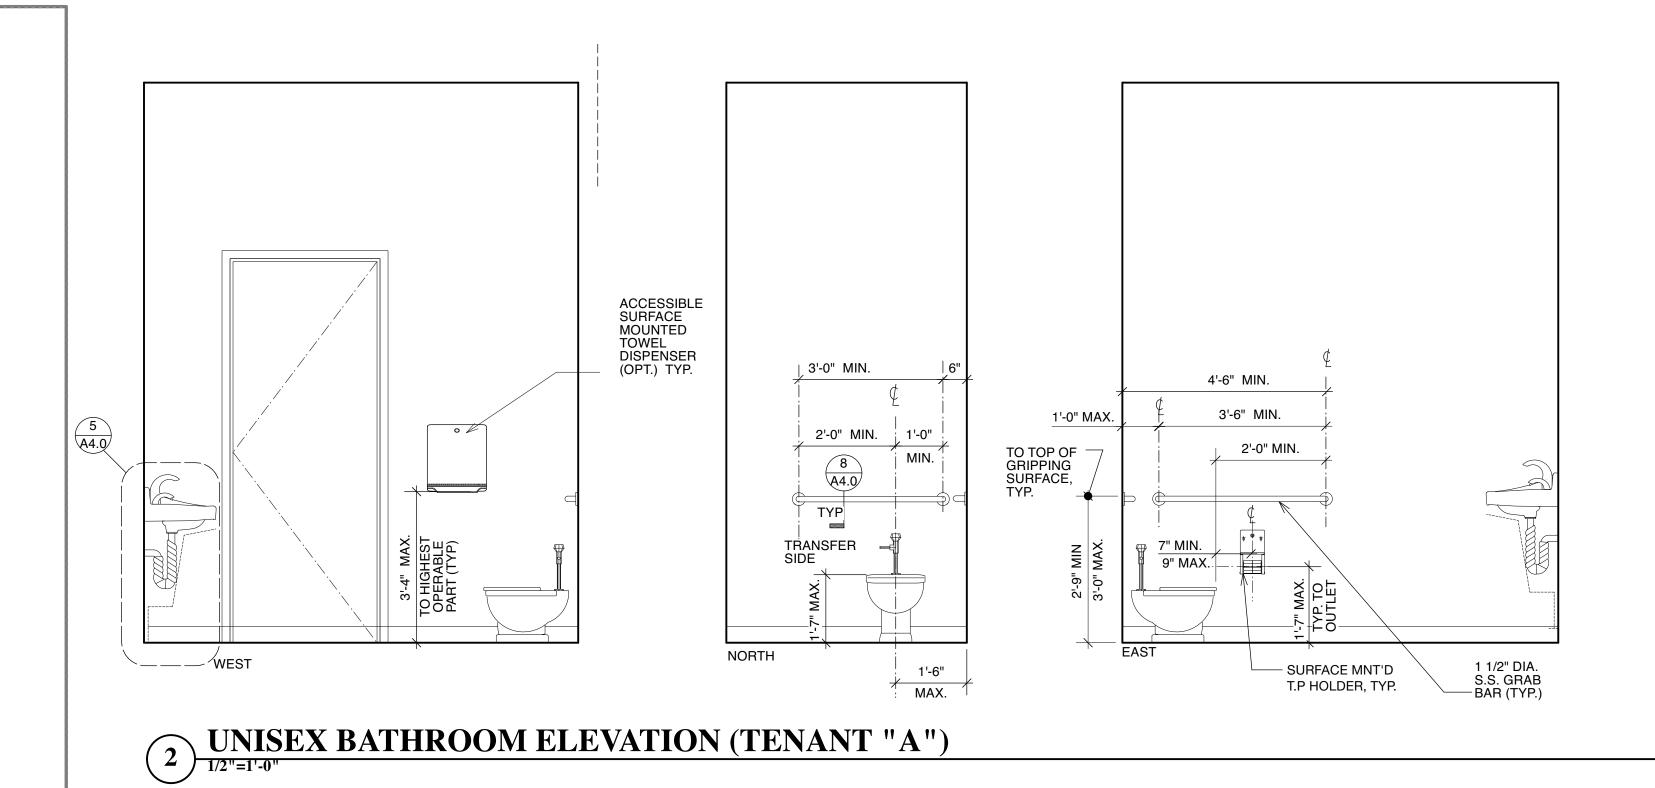

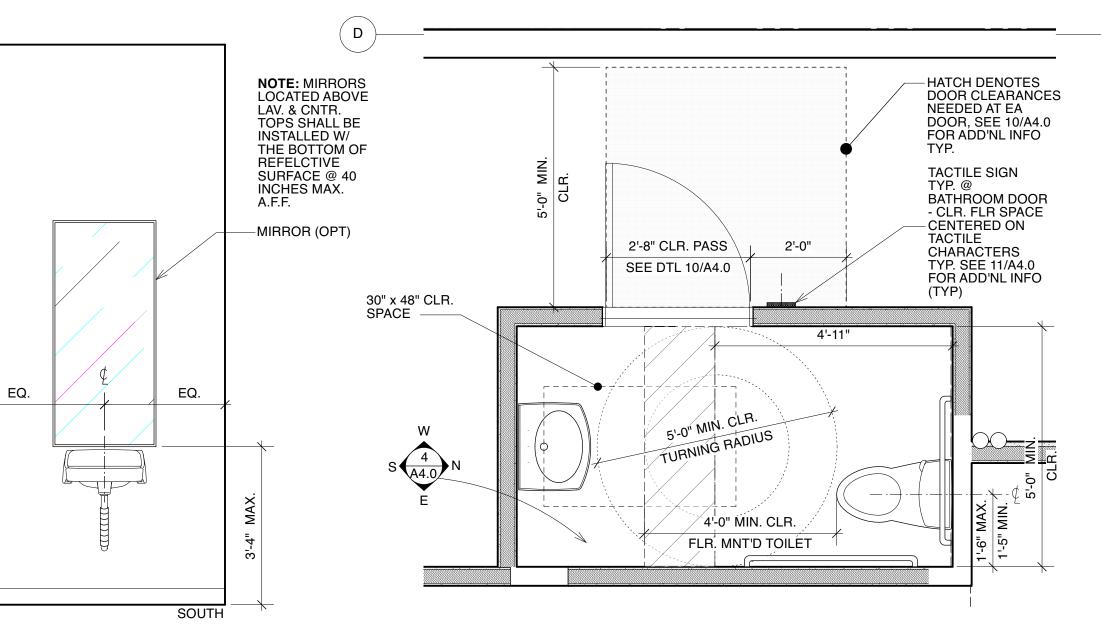

.• ALL TOWELS, WASTE BINS, DRYERS, SANITARY NAPKINS & SOAP DISPENSERS OPERABLE PARTS TO BE 3'-4" MAX. HEIGHT ABOVE FLOOR PER ADA. • OPERABLE PARTS SHALL BE OPERABLE WITH ONE HAND AND SHALL NOT REQ. TIGHT


(D)

GRASPING, PINCHING, OR TWISTING OF WRIST. THE FORCE RQ'D. TO ACTIVATE OPERABLE PARTS SHALL BE 5 POUNDS MAX.

• FLUSH CONTROLS TO BE HAND OPERATED OR AUTOMATIC. HAND OPERATED FLUSH CONTROLS TO BE 44 INCHES AF.F. MAX. & TO BE LOCATED ON THE OPEN SIDE OF WATER CLOSET, TYP.

• 56 INCH CLEARANCE NEEDED FOR WALL MOUNTED TOILETS AND 59 INCHES CLEARANCE NEEDED FOR FLOOR MOUNTED TOILETS

TENANT "A" UNISEX PLAN DETAIL 1/2"=1'-0" / DIM. SHOWN ON THIS PLAN ARE FIN. DIM. - TENAN'T "B" SIM.

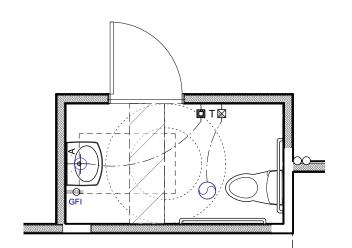

TENANT "A" RCP PLAN

1/4" = 1'-0"

DOCUMENT RECORD DATE **ACTION** APRIL 09, 2021 DEMO PERMIT APRIL 27, 2021 PERMIT SUBMITTAL NOV. 5, 2021 PLAN CHECK CMNTS. REVS. DEC. 28, 2021 MECH. CMNTS. REVS. MAR. 28, 2022 PERMIT REVISIONS APRIL 18, 2022 BSM REVISION SEP 27, 2022 | CONST. PROGRESS SET MAR. 8, 2023 PG&E UTILITY PERMIT OCT. 19, 2023 PG&E UTILITY PERMIT REV.2

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SHEET TITLE INT. ELEVATIONS @ TENANT SPACE "A" RCP PLAN

AS NOTED

21.06

MARK J. TOPETCHER, ARCHITECT CA. LIC. # C 21678, EXP. MAY 2025

