

			tory Chart Recommendations, Tree Sp	acies Diam	eter at Dec	aget T	Jeight	Key N
В Н), С	onditi	on Rating	, and Tree Category.					
Tree No.	Rec P	ommend. M R	Tree Species	DBH (cm)	Cond.	1	ategory 2 3	
#1	P		Japanese Lilac Syringa reticulata	6	F		3	
#2	P		Japanese Lilac	3.5	F		3	
#3	P		Syringa reticulata Japanese Lilac	3	F		3	
#4	P		Syringa reticulata Japanese Lilac	3.5	F		3	
			Syringa reticulata					
#5	P		Flowering-Crab Malus baccata	11	F		3	
#6	P		Japanese Lilac Syringa reticulata	3	F		3	
#7		R	Japanese Lilac	4	D		3	
#8	P		Syringa reticulata Japanese Lilac	6	G		3	
#9	P		Syringa reticulata Japanese Lilac	8	F		3	
#10	P		Syringa reticulata White Mulberry	19	G		3	
	r		Morus alba				3	
#11		R	Horse-Chestnut Aesculus hippocastanum	56	F	1		
#12	P		Norway Maple Acer platanoides	32	F		3	
#13		R	White Mulberry	27	F		3	
#14		R	Morus alba Black Maple	32	F		3	
#15		R	Acer nigrum Horse-Chestnut	27	F	1		
			Aesculus hippocastanum					
#16		R	Norway Maple Acer platanoides	26	F	1		
#17		R	Norway Maple Acer platanoides	46	F	1		
#18		R	Cherry tree	39	F	1		
#19		R	Prunus serrulata Catalpa	44	F	1		
#20		R	Catalpa speciosa Blue Spruce	16	G			
			Picea pungens					
#21		R	Blue Spruce Picea pungens	32	F	1		
#22		R	Black Maple Acer nigrum	14	P			
#23		R	White Birch	26	F	1		
#24		R	Betula papyrifera White Birch	24	F	1		
#25		R	Betula papyrifera Green Ash	36	P		3	
			Fraxinus pennsylvanica					
#26		R	Green Ash Fraxinus pennsylvanica	36-38	P		3	
#27		R	Norway Maple	48	F		3	
#28		R		26	F		3	
#29		R	Acer platanoides Silver Maple	25	F	1		
			Acer saccharinum					
#30		R	Acer negundo	35	F	1		
#31		R	Norway Maple Acer platanoides	18	G			
#32		R	Norway Maple	62	F	1		
#33		R	Acer platanoides Norway Maple	48	F	1		
#34		R	Acer platanoides Black Walnut	42	F	1		
			Juglans nigra					
#35		R	Black Walnut Juglans nigra	43	F	1		
#36		R	Pear tree Pyrus calleryana	21	F	1		
#36b		R	Blue Spruce	35	F	1		
#37		R	Picea pungens Pear tree	14-15	F			
#38		R	Pyrus calleryana	58	F	1		
			Acer saccharinum			1		
#39		R	White Mulberry Morus alba	5-6	G			
#40		R	Blue Spruce	41	G		3	
	1		Picea pungens			1		

16 P

18 F

34-36 F

1-3 G



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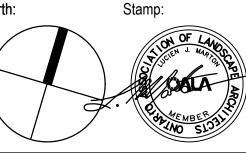
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Municipality

Newmarket

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Proposed Residential Development 1015 Davis Drive & 22 Hamilton Drive

Newmarket, Ontario

1:200 Date: **April 2018 D.R.** Checked By: **L.M.**

Drawing Title: Tree Survey &


Preservation Plan

Sheet No. 18139 L1-01

Legend **Material Schedule** Prop. Sodded V V V V V V V **UNIT PAVER TYPE 1** Area Typ. *** * * * *** Permeable, Pedestrian Tree Protection Prop. Concrete "UMBRIANO" by UNILOCK Zone (TPZ) Paving Typ. Size: 3 Unit Random Bundle Colour: Summer Wheat Prop. Unit Pattern: Random 1 STOREY BRICK BUILDING NO. 28 Property Line Paving Typ. (refer to **UNIT PAVER TYPE 2** ARMOURSTONE Tree Protection Material List) Permeable, Pedestrian DETAIL TYP. Fencing SNOW —— STORAGE **RETAINING WALL** "UMBRIANO" by UNILOCK (BY OTHERS) Prop. 1.8m HT Wood 200 x 600 x 70mm Size: TRANSFORMER -Privacy Fence Typ. -BIKE RINGS √W/(BY OTHERS) Colour: Midnight Sky DETAIL TYP. Reference Key Pattern: Running Bond Prop. 1.8m HT Wood Privacy Screen Typ. **UNIT PAVER TYPE 3** Plant Material Permeable, Vehicular Reference Key "UMBRIANO" by UNILOCK 180 x 360 x 80mm Size: AREA Proposed Colour: French Grey PROPOSED Coniferous Tree 4 BENCH SEATING -03 ON CONC. PAD Pattern: Running Bond Proposed Deciduous Tree UNIT PAVER TYPE 4 £42 PROPOSED PERMEABLE 7 UNIT PAVING TYPE 1 Proposed Armourstone Type: Permeable, Vehicular "REALA" by UNILOCK PROP. LIGHT 100 x 250 x 70mm Size: BOLLARD (4) Colour: OLD OAK RETAINING WALL -Pattern: Harringbone PROPOSED BY TIO TYP. WITH OTHERS BALCONÝ ABOVE 1.5m CONCRETE WALKWAY VEHICULAR PAVER BANDING BETWEEN **PRECAST** PAVING SLABS DETAIL TYP. DRIVEWAYS TYP. PATTERN: DOUBLE WIDE SOLDIER COURSE 1800mm HT WOOD PRIVACY SCREEN BETWEEN UNITS DETAIL TYP. **PEDESTRIAN** CLEARANCE AROUND BUILDING PATIO TYP. 1800mm HT WOOD PRIVACY FENCE BLOCK D DETAIL TYP. FENCE TO END IN LINE WITH RETAINING 10 M STOP SIGN NTABLE CURB AS-SETBACK TYP. GARBAGE ENCLOSURE **RETAINING WALL**— ON CONCRETE PAD (BY OTHERS) TRANSFORMER -STOP (BY OTHERS) SIGN TYP. 1.5m CONCRETE WALKWAY UNIT PAVING SIGN TYP. LIGHT STANDARD TYP. (REFER TO LIGHTING PLAN PREPARED BY RTG) UNIT PAVING PEDESTRIAN CURB PLANTER CLEARANCE TYP. ACROSS 10 M STOP SIGN SETBACK TYP. ON FOR VEHICLE AND PERSON FRIAN 1.5m CONCRETE WALKWAY → 1.5m CONCRETE WALKWAY 1.5m CONCRETE WALKWAY 1800mm HT WOOD PRIVACY FENCE DETAIL TYP. FENCE TO END IN LINE WITH BUILDING 92 ON BOTH ENDS FIRE ROUTE SIGN TYP. VEHICULAR PAVER BANDING BETWEEN DRIVEWAYS TYP. PATTERN: DOUBLE WIDE 1 STOREY BRICK BUILDING NO. 1005 SOLDIER COURSE CONCRETE STAIRS DETAIL. TYP FOR ALL STAIRS IN R.O.W. D-0 CONCRETE STAIRS DETAIL. TYP FOR ALL STAIRS IN R.O.W.

▶ / 1.5m CONCRETE WALKWAY

1.5m CONCRETE WALKWAY

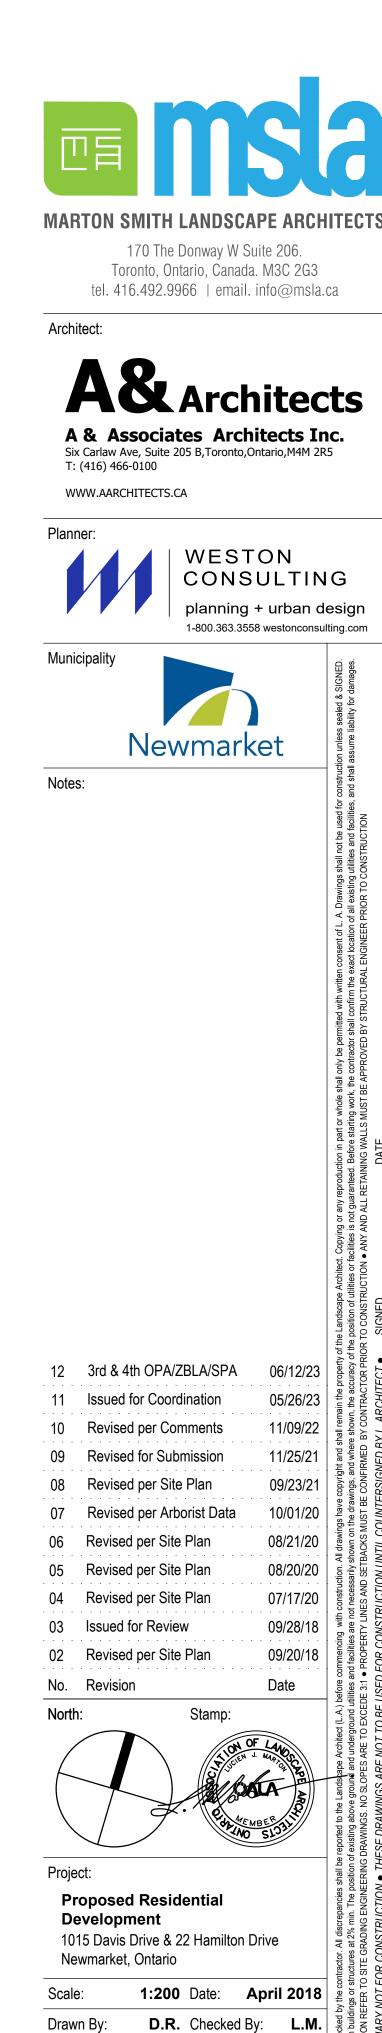

PROPOSED WASTE

RECEPTACLE

PROPOSED CIP

PROPOSED 1.2M HT CUSTOM COR EN METAL

PROPOSED MASONRY PIERS

PROPOSED CIP CONC. SEATWALL

PICNIC TABLE

CURB PLANTER DETAIL TYP.

PERMEABLE

PROPOSED

1.5m CONCRETE WALKWAY

MASONRY SIGNAGE WALL

PERMEABLE
PRECAST UNIT
PAVING TYPE 4
1D-02

-REMOVE EXISTING CURB

CUTTER AS PER TOWN

Drawing Title:

Project No.

Landscape Plan

L2-01

STANDARDS

CUT AND REPLACE WITH CONCRETE CURB AND

SEATING ON CONC. PAD

METAL PERGOLA

WITH LIGHTING 18 ON CONC. PAD LD-03

WITH WALL


LIGHTS

PROPOSED

ART PIECE SCREEN

CLUSTER SEATING

KEY QN:	QNTY BOTANICAL NAME	COMMON NAME	HT/CAL SPR	SPREAD ROOT	REMARKS	KEY	ZINØ	BOTANICAL NAME	COMMON NAME	HT/CAL SPF	SPREAD ROOT	REMARKS
DECIDUOUS TREES	REES					CONIFE	CONIFEROUS SHRUBS	IBS				
AGI	1 Acer ginnala	Amur Maple	90 mm	B.&B.	Tree Form	HMT	136	Taxus media 'Hicksii'	Hick's Yew	80 cm	c.G.	Full Form
ASC	4 Acer saccharum	Sugar Maple	80 mm	B.&B.	Full Form	TOE	30	Thuja occidentalis 'Smarago'	Emerald Cedar	100 cm	B.&B.	Full Form
AXA	3 Acer x freemanii 'Armstrong'	Armstrong Freeman Maple	80 mm	B.&B.	Full Form	PERENNIALS	IIALS					
CAO	4 Carya ovata	Shagbark Hickory	70 mm	B.&B.	Full Form	ACA	72	Anemone canadensis	Canada Anemone		2 Gal.	Full Form
CEH	2 Celtis occidentalis	Hackberry	70 mm	B.&B.	Full Form	ANO	15	Allium cernum	Nodding Onion		2 Gal.	Full Form
GDI	3 Gymnocladus dioicus	Kentucky Coffee Tree	70 mm	B.&B.	Full Form	AQC	88	Aquilegia canadensis	Wild Columbine		2 Gal.	Full Form
QRB	4 Quercus rubra	Red Oak	80 mm	B.&B.	Full Form	Too	32	Coreopsis lanceolata	Lanceleaf Coreopsis		2 Gal.	Full Form
CONIFEROUS TREES	TREES					ECK	24	Echinacea purpurea 'Kim's Knee High'	Dwarf Purple Cone Flower		2 Gal.	Full Form
PGL	6 Picea glauca	White Spruce	200 cm	B.&B.	Full Form	EMG	18	Eupatorium maculatum 'Gateway'	Joe Pye Weed	L L	moave 2 Gal.	Full Form
TOW	3 Thuja occidentalis	Native White Cedar	100 cm	B.&B.	Native	EPP	38	Echinacea pallida	Pale Purple Coneflower		2 Gal.	Native
TISTEM SI	MULTISTEM SPECIMEN SHRUBS					FVR	0	Fragaria vesca	Woodland Strawberry	, v)	shade 2 Gal.	Native
ACB	8 Amelancier canadensis 'Ballerina'	1, Ballerina Serviceberry	200 cm	B.&B.	Multistem Clump	GER	85	Geranium 'Rozanne'	Hardy Cranesbill Geranium		2 Gal.	Full Form
CAL 1	13 Cornus alternifolia	Pagoda Dogwood	150 cm	B.&B.	Multistem Clump	HSD	64	Hemerocallis 'Stella D'oro'	Stella D'oro (Yellow) Daylilies		2 Gal.	Full Form
HAV	1 Hamemelis virginiana	Common Witch-hazel	80 cm	C.G.	Full Form	HSE	104	Hosta sieboldiana elegans (Blue)	Elegans Large Blue Leaf Hosta	<i>(</i>)	shade 2 Gal.	Large Leaf
PAA	3 Prunus americana	American Plum	200 cm	B.&B.	Multistem Clump	LPS	70	Lupinus perennis	Sundial Lupine		2 Gal.	Native
VLN	5 Viburnum lentago	Nannyberry	150 cm	B.&B.	Multistem Clump	PLS	24	Perovskia atriplicifolia 'Little Spire'	Little Spire Russian Sage		2 Gal.	Full Form
VAMENTAL	ORNAMENTAL GRASSES					RUD	64	Rudbeckia fulgida ' Goldstrum'	Dward Black Eyed Susan		2 Gal.	Full Form
AGN	21 Andropegen gerardii	Big Bluestem		5 Gal.	Full Form	DECIDO	DECIDUOUS SHRUBS	\$1				
PAV 15	155 Panicum virgatum	Switch Grass		2 Gal.	Full Form — Native	CNK	29	Cornus sericea 'Kelseyi'	Kelsey Red Osier Dogwood	60 cm	c.G.	Full Form
9 SOS	68 Schizachyrium scoparium	Little Bluestem		2 Gal.	Full Form — Native	CNS	28	Cornus stolonifera	Red Osier Dogwood	80 cm	C.G.	Full Form
SPH 4	42 Sporobolus heterolepsis	Pairie Dropseed		2 Gal.	Full Form — Native	HPB	31	Hydrangea paniculata 'Bombshell'	Dwarf Bombshell Hydrangea	60 cm	5 gal.	Full Form
L QUANT	ALL QUANTITIES IN THE LIST OF PLANT MATERIALS ARE TO	RIALS ARE TO BE CHECKED BY THE L	ANDSCAPE CONTR	ACTOR. ANY	BE CHECKED BY THE LANDSCAPE CONTRACTOR. ANY DISCREPANCIES ARE TO BE REPORTED	RIR	11	Rubus idaes	Red Raspberry	80 cm	c.G.	Full Form
) THE LA	NDSCAPE ARCHITECT. THE QUANTI	TIES INDICATED ON THE DRAWINGS SUF	PERCEDE THE TOT	AL QUANTITIE	S	SMP	20	Syringa meyeri 'Palibin'	Purple Dwarf Korean Lilac	60 cm	C.G.	Full Form

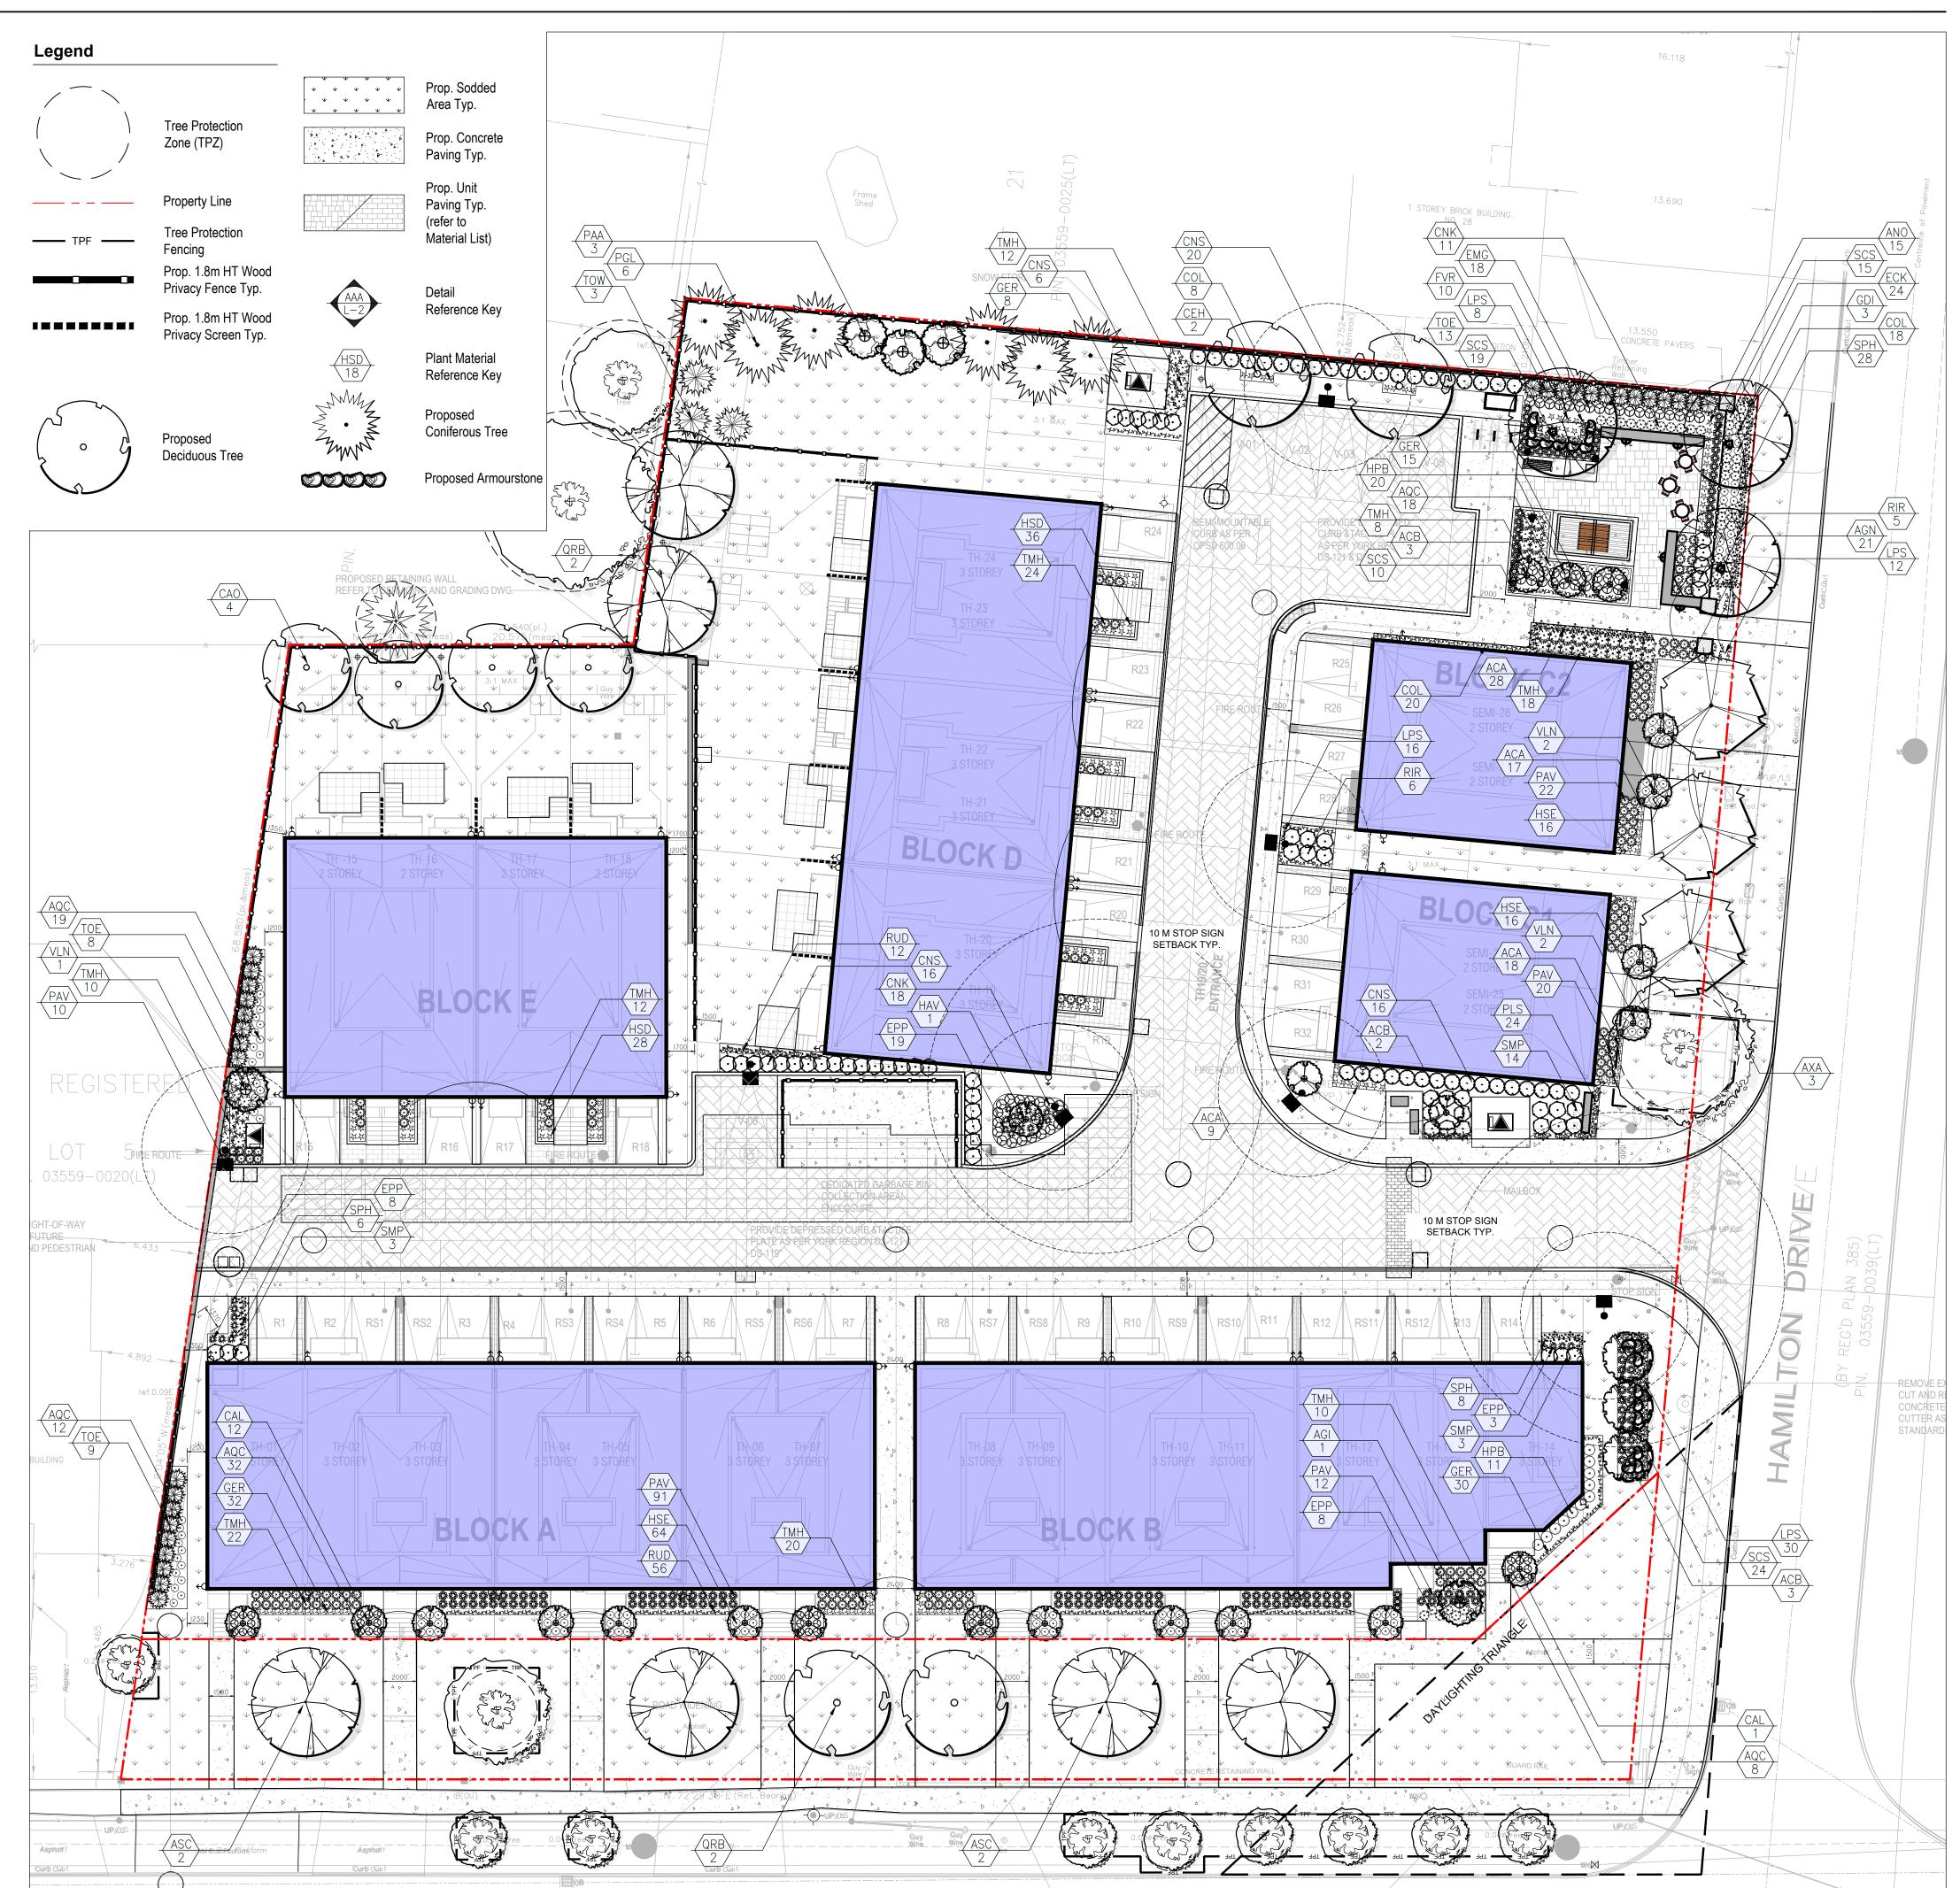



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Planner:

WESTON CONSULTING planning + urban design 1-800.363.3558 westonconsulting.com

Municipality Newmarket

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Proposed Residential

1015 Davis Drive & 22 Hamilton Drive Newmarket, Ontario

1:200 Date: **April 2018**


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Planting Plan

Project No.

L3-01


Legend Tree Protection Zone (TPZ) Property Line Prop. Soil

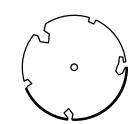

Proposed Deciduous Tree

SOIL VOLUME GUIDELINES

- All deciduous trees planted on their own have access to a minimum of 30 cubic meters of soil volume to grow in.
- All deciduous trees planted in groups of two or more trees have access to a minimum of 15 cubic meters of soil volume to grow in per tree.
- All soil volume areas are 1m in depth, as per the maximum depth allowable in soil calculations per municipal guidelines.

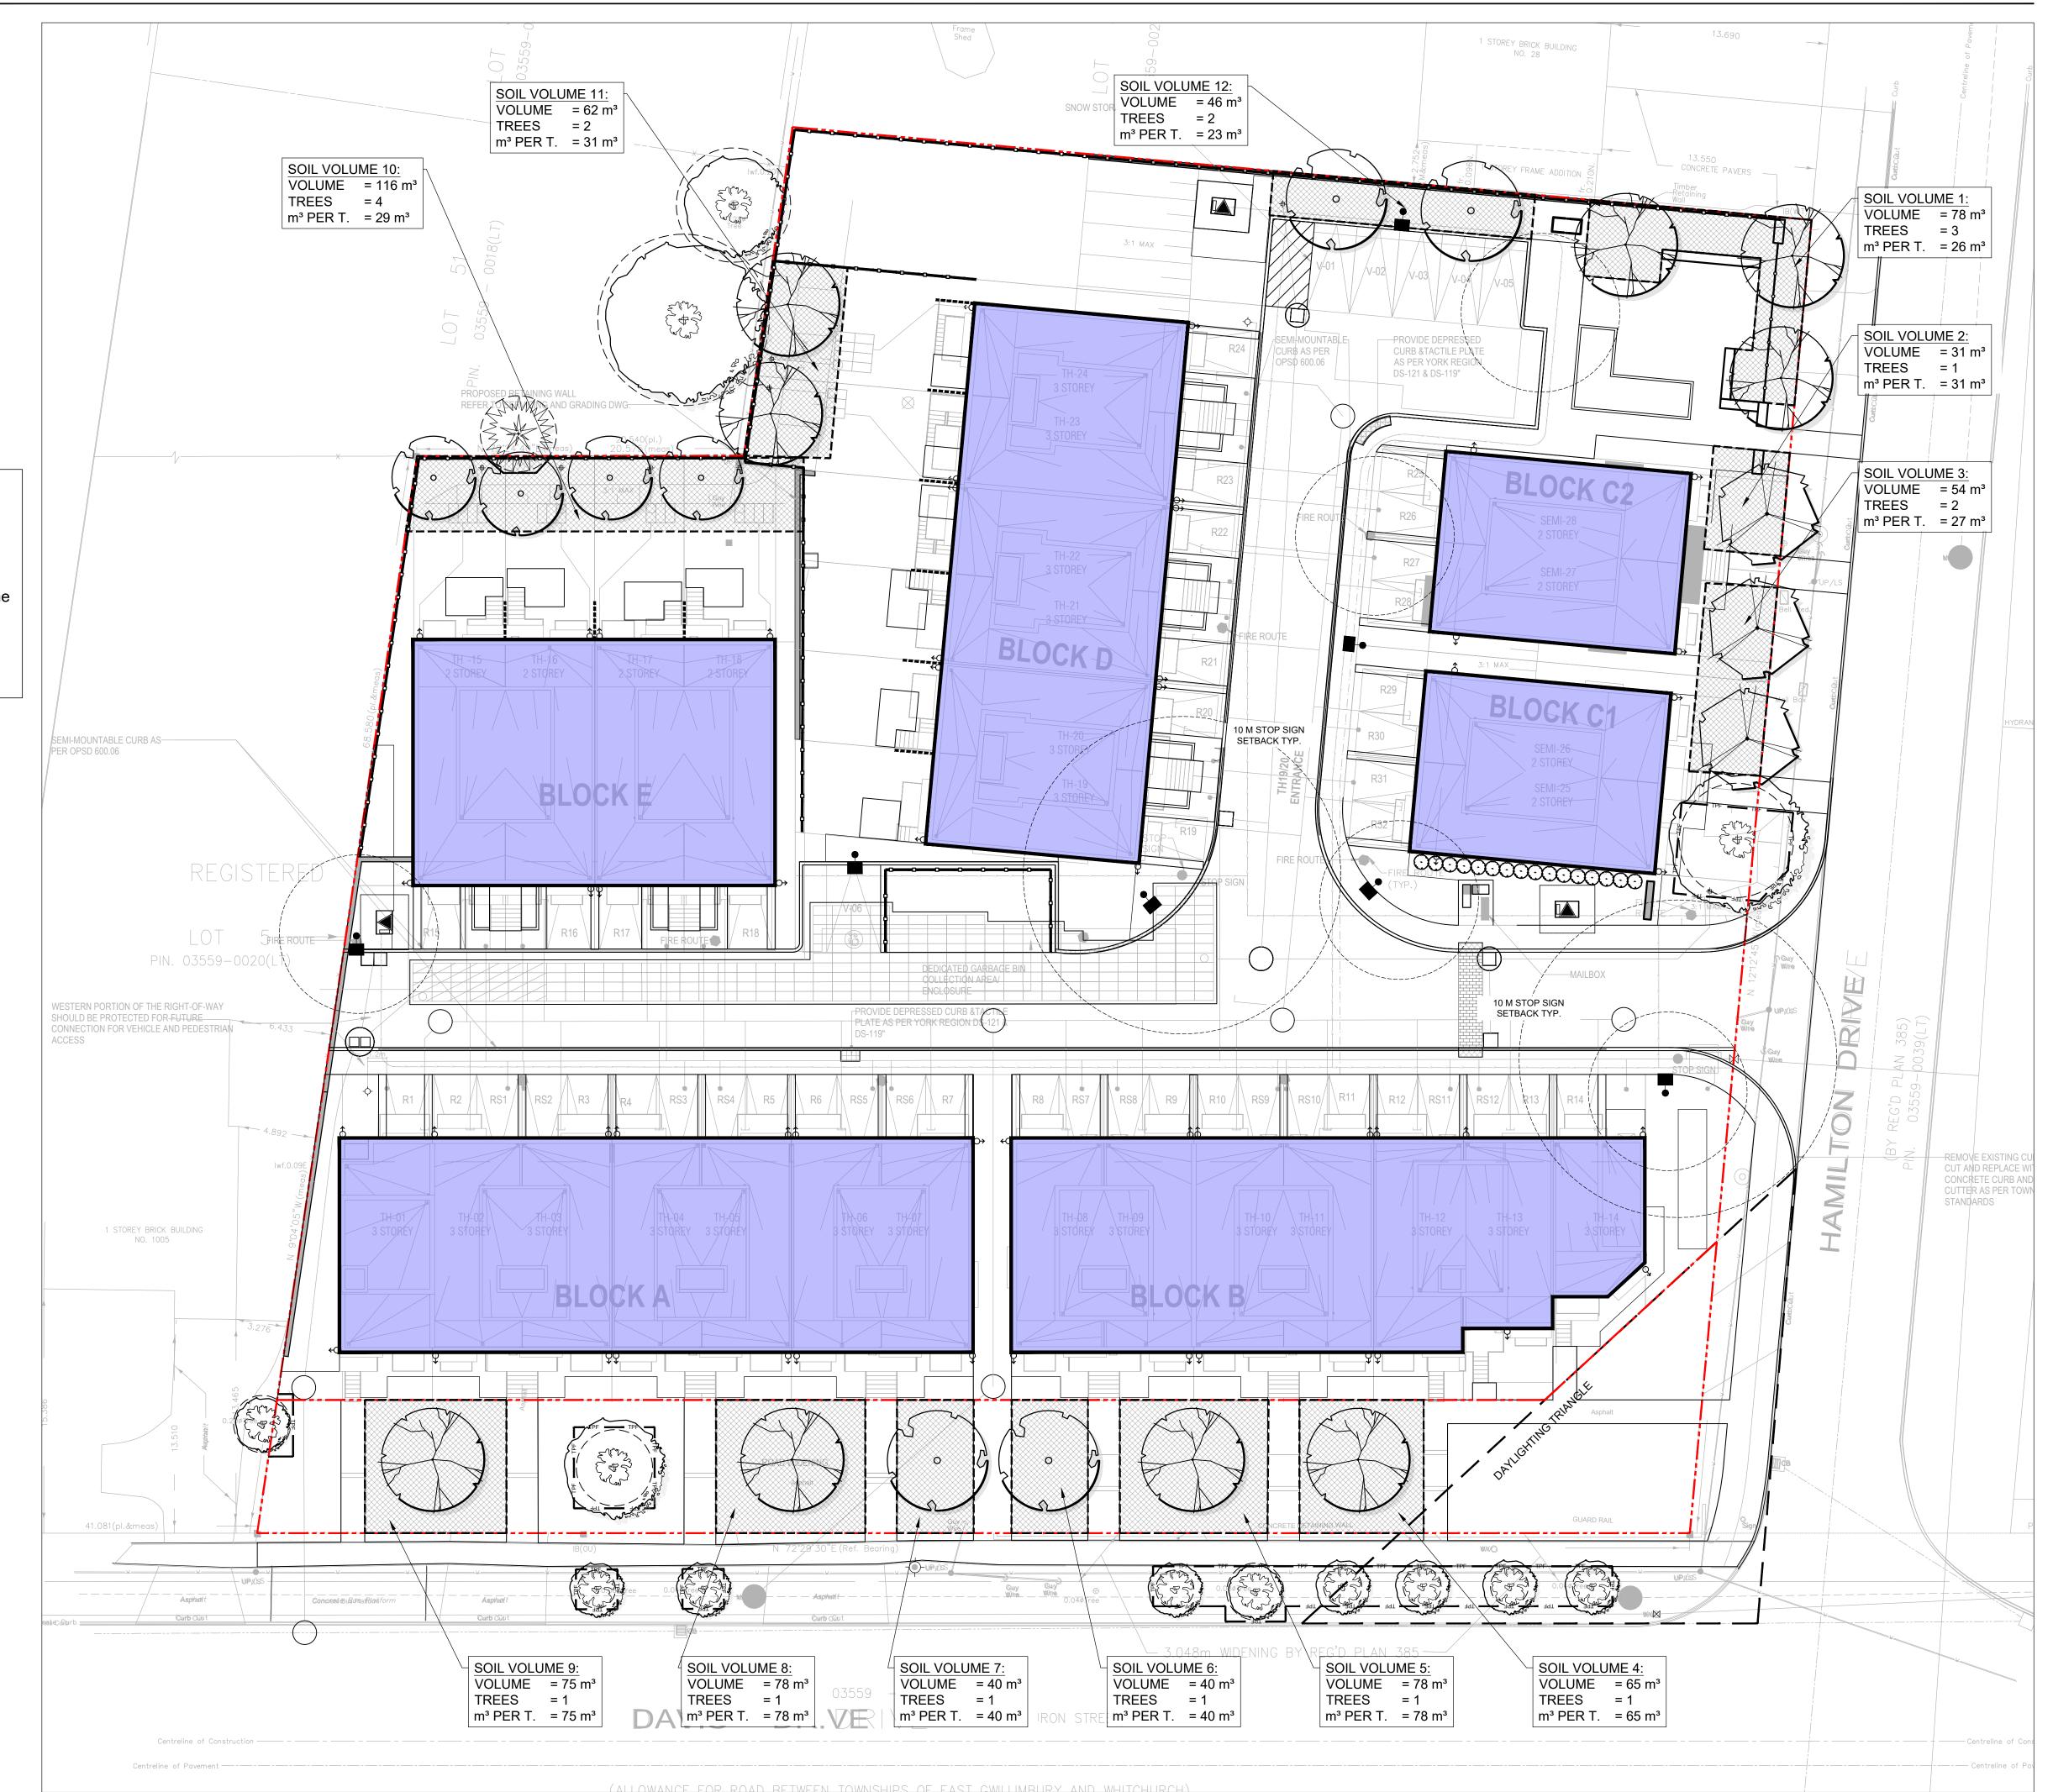



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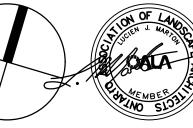
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Municipality

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Proposed Residential Development 1015 Davis Drive & 22 Hamilton Drive Newmarket, Ontario

1:200 Date: **April 2018**

D.R. Checked By: **L.M.** Drawn By: Drawing Title:

Soil Volume Plan

Project No. L4-01 CONTRACTOR MUST CONTACT ALL UTILITY COMPANIES FOR STAKE OUTS PRIOR TO ANY EXCAVATION OR PLANTING.

ROUGH GRADE AND FILL AREAS TO ESTABLISH SUBGRADE AS REQUIRED. PROVIDE DRAINAGE PATTERN AS INDICATED ON DRAWINGS. ROUND SMOOTHLY ALL TOPS AND TOES OF SLOPES. COMPACT ALL AREAS TO 95% STANDARD PROCTOR DENSITY UNLESS SPECIFIED OTHERWISE. EXISTING TREES TO REMAIN ON SITE ARE TO BE PROTECTED AS DETAILED.

FINE GRADING

FINE GRADE ALL AREAS TO FINISHED GRADES AS SHOWN ON LAYOUT OR GRADING PLAN OR ARCHITECT'S SITE PLAN. PROVIDE UNIFORM SLOPES AWAY FROM THE BUILDING, UNLESS SPECIFIED OTHERWISE. SLOPES MAY NOT EXCEED 33 1/3% (3:1).

SPREADING OF TOPSOIL

SCARIFY THE SUBSOIL PRIOR TO THE SPREADING THE TOPSOIL. REMOVE ALL DEBRIS AND LEAVE A FINE-TEXTURED EVEN SURFACE. ALL TOPSOIL TO BE IMPORTED UNLESS. PREVIOUSLY APPROVED BY LANDSCAPE ARCHITECT, OBTAIN APPROVAL FOR THE QUALITY OF ANY IMPORTED TOPSOIL BEFORE DELIVERY TO THE SITE. TOPSOIL IS TO BE COMPACTED TO CREATE A FIRM AND EVEN SURFACE.

USE NO. 1 GRADE TURFGRASS NURSERY SOD WHICH CONFORMS WITH THE SPECIFICATIONS OF THE NURSERY SOD GROWERS ASSOCIATION OF ONTARIO, ALLI AWN AREAS SHALL RECEIVE A MINIMUM OF 150MM (6") OF COMPACTED TOPSOIL, AND SHALL BE SODDED WITH #1 KENTUCKY BLUEGRASS - FESCUE. NO SOD SLOPES ARE TO EXCEED 3:1. SLOPE IN EXCESS OF 4:1 TO BE PEGGED.

MINERAL FERTILIZER

APPLY THE FOLLOWING MINERAL FERTILIZER UNLESS SOILS TESTS SHOW OTHER REQUIREMENTS:

1. SODDED AREAS - 11% NITROGEN, 8% PHOSPHORUS AND 4% POTASH (11-8-4) AT THE RATE OF 4.5 KG OVER M2 (10 LBS OVER 1000 SQ.

2. PLANTING BEDS - 7% NITROGEN, 7% PHOSPHORUS AND 7% POTASH (7-7-7) AT THE RATE OF 40 GRAMS (4 OZ.) FOR EVERY BUSHEL OF

PREPARATION OF PLANTING BEDS

ALL PLANT BEDS TO BE CONTINUOUS. EXCAVATE ALL PLANTING BEDS TO THE DEPTH AS INDICATED ON THE DRAWINGS AND DETAILS, MIN 450mm(18"). BACKFILL ALL PLANTING BEDS WITH A SOIL MIXTURE CONSISTING OF SIX (6) PARTS OF SAND LOAM, ONE (1) PART OF FINELY PULVERIZED PEAT MOSS. TWO (2) PARTS OF WELL-ROTTED MANURE AND THE MINERAL FERTILIZER AS SPECIFIED ABOVE. ALSO ADD .58 KILOS BONEMEAL/CUBIC METER OF PLANTING SOIL (1 LB./CUBIC YARD). PREPARE THE PLANTING BEDS FOR PLANTING BEFORE THE DELIVERY OF THE PLANT MATERIAL TO THE JOB SITE.

NOTE: IF THE EXISTING SOIL CONDITIONS ARE CLAY OR WET IN NATURE, CONTACT THE LANDSCAPE ARCHITECT FOR INSTRUCTIONS OF A SUITABLE SOIL MIXTURE. FAILURE TO DO THIS MAY RESULT IN DELAY OF APPROVAL AND ACCEPTANCE.

ALL PLANT MATERIAL SHALL CONFORM TO THE STANDARDS OF THE CANADIAN NURSERY TRADES ASSOCIATION FOR SIZE AND

OF PLANTING OPERATIONS. ALL PLANT MATERIAL TO BE CLAY GROWN STOCK UNLESS OTHERWISE NOTED.

ALL SHRUB AND TREE MATERIAL SHALL BE CONTAINER GROWN, POTTED, S/B OR B/B, UNLESS OTHERWISE NOTED. BARE ROOT PLANTING SHALL BE ACCEPTABLE FOR CERTAIN SPECIES DURING EARLY SPRING OR LATE FALL PLANTING SEASON. CONTRACTOR SHALL MAKE REQUESTS FOR ROOT CONDITION SUBSTITUTION IN WRITING TO THE LANDSCAPE ARCHITECT PRIOR TO COMMENCEMENT

LANDSCAPE SPECIFICATIONS



ALL TREES. SHRUBS AND GROUNDCOVERS SHALL BE PLANTED AS DETAILED & AS SHOWN ON THE PLANTING PLAN. ALL BEDS TO RECEIVE A COVER OF CLEAN MULCH TO A DEPTH OF 75mm(3"). FOR GUYING AND STAKING TREES, REFER TO PLANTING DETAILS. WRAP ALL DECIDUOUS TREES UNDER EXPERIENCED SUPERVISION ONLY TO THE SPECIFICATIONS OF THE ONTARIO LANDSCAPE

PLANT MATERIAL SIZES AND CONDITIONS ARE TO BE AS INDICATED ON THE LANDSCAPE DRAWING.

THE INDIVIDUAL PLANT GROUPING TOTAL AS ILLUSTRATED ON THE PLANTING PLAN SUPERSEDES THE ESTIMATED QUANTITY ON THE MASTER PLANT LIST. CONTRACTOR MUST REPORT ANY DISCREPANCIES TO THE LANDSCAPE ARCHITECT IN WRITING BEFORE COMMENCING ANY WORK. CONTRACTOR WILL ASSUME FULL RESPONSIBILITY IF LANDSCAPE ARCHITECT IS NOT NOTIFIED. OF

* MULCH - SHREDDED PINE MULCH BY "GRO BARK" OR APPROVED EQUAL. LANDSCAPE ARCHITECT TO APPROVE MULCH BEFORE INSTALLATION.

GENERAL MAINTENANCE

DISCREPANCIES.

PROPER MAINTENANCE PROCEDURES ARE TO BE FULLY ADMINISTERED FOR ALL NEWLY CONSTRUCTED LANDSCAPE WORK, IN ACCORDANCE WITH LANDSCAPE ONTARIO SPECIFICATIONS (SECTION 1E - MAINTENANCE WORK). THIS SHALL APPLY ONLY DURING THE CONSTRUCTION PERIOD, UNLESS OTHERWISE SPECIFIED. CONTRACTOR IS RESPONSIBLE FOR MAINTENANCE OF SOD AND PLANTING UNTIL FINAL ACCEPTANCE BY LANDSCAPE ARCHITECT.

RODENT PROTECTION

THE CONTRACTOR SHALL BE RESPONSIBLE FOR THE PROTECTION OF ALL TREES AND SHRUBS FOR WINTER PROTECTION AND FROM RODENT INJURY FOR THE DURATION OF GUARANTY PERIOD. PROTECTIVE GUARDS SHALL BE EMPLOYED AROUND ALL DECIDUOUS TREES GUARDS TO BE 150MM DIA PVC PIPE OR AS MUNICIPAL GUIDELINES. GUARDS SHALL BE INSTALLED PRIOR TO THE APPLICATION OF THE MULCH AND SHOULD BE PLACED A MINIMUM OF 50MM (2") OUT FROM THE TREE TRUNK ON ALL SIDES.

ALL SHRUBS AND CONIFEROUS TREES SHALL HAVE AN APPLICATION OF "SKOOT" OR APPROVED EQUIVALENT RODENT FORMULA, TO BE APPLIED AT THE END OF OCTOBER. FOLLOW MANUFACTURER'S DIRECTIONS FOR APPLICATION.


USE ABOVE SPECIFICATIONS IN CONJUNCTION WITH THE GENERAL LANDSCAPE SPECIFICATIONS OF THE ONTARIO LANDSCAPE CONTRACTORS ASSOCIATION, THE NURSERY SOD GROWERS ASSOCIATION OF ONTARIO AND WITH THE GUIDE SPECIFICATIONS FOR NURSERY STOCK OF THE CANADIAN NURSERY TRADES ASSOCIATION. USE ONLY PLANT MATERIAL TRUE TO NAME, SIZE AND GRADE AS SPECIFIED ON PLANTING PLAN; PROVIDE SUFFICIENT LABELS OR MARKINGS TO INDICATE CLEARLY THE VARIETY, SIZE AND GRADE OF EACH SPECIMEN OR BUNDLE.


OBTAIN APPROVAL FOR SUBSTITUTIONS AS TO VARIETY, SIZE OR GRADE FROM THE LANDSCAPE ARCHITECT. USE ONLY NURSERY STOCK GROWN UNDER PROPER HORTICULTURAL PRACTICES, VIABLE, FREE FROM PEST AND DISEASE AND UNDAMAGED. CHECK LOCATIONS AND OBTAIN STAKEOUTS OF ALL UTILITY LINES BEFORE EXCAVATION. OBTAIN ALL NECESSARY PERMITS BEFORE COMMENCEMENT OF CONSTRUCTION. REPORT IN WRITING ANY DISCREPANCIES IN THE DRAWINGS, SPECIFICATIONS AND CONTRACT DOCUMENTS TO THE LANDSCAPE ARCHITECT BEFORE THE END OF THE BIDDING PROCESS AND COMMENCEMENT OF CONSTRUCTION. THESE SPECIFICATIONS MAY BE SUPERCEDED BY ADDITIONAL SPECIFICATIONS SET OUT IN THE TENDER DOCUMENTS. CONTRACTOR TO REVIEW ALL DOCUMENTS.

GUARANTEE PERIOD

PROVIDE TWO FULL YEAR GUARANTEE ON ALL LANDSCAPE WORK FROM DATE OF FINAL ACCEPTANCE BY LANDSCAPE ARCHITECT. GUARANTEE PERIOD MAY BE EXTENDED DEPENDING ON MUNICIPAL STANDARDS. CONTRACTOR TO VERIFY WITH OWNER AND LANDSCAPE ARCHITECT.

PLANT MATERIAL INSTALLATION

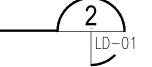

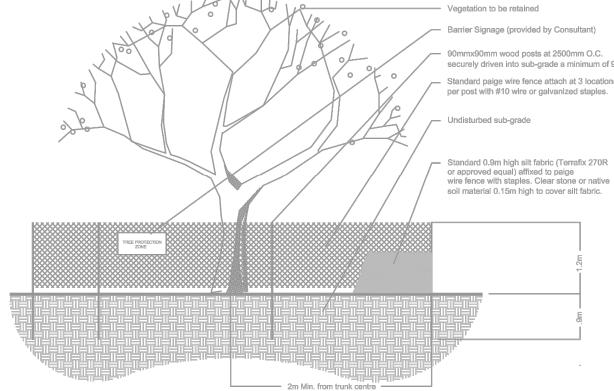

TOWN OF NEWMARKET TREE PROTECTION

- 1. All retained trees as shown shall be identified on site in such a way so that all workers shall know that the vegetation is to be retained. Identification of retained vegetation on site shall be by a Tree Protection Barrier as detailed here.
- 2. The tree's roots, trunk, crown and tree protection zone must be adequately protected. The Tree Protection Barrier must be at least 1.2m (4') in height, 2m (6') around the circumference of the trunk or, to the tree dripline (whichever is greater) and installed in all locations where trees are to be retained. The fencing or barrier material shall be a bright, contrasting colour and be durable. Fence posts shall be metal T-posts, comparable or heavier. Fencing will be maintained in an upright position throughout the duration of the project.
- 3. All Tree Protection Barriers shall be signed indicating that the area is a tree retention area and that there is no access. Signage shall be placed in a highly visible location on the fence. Signs to be provided by the consultant. Signs to be no smaller then 12"x18".

securely driven into sub-grade a minimum of 900mm Standard paige wire fence attach at 3 locations or approved equal) affixed to paige wire fence with staples. Clear stone or native soil material 0.15m high to cover silt fabric.

TREE PROTECTION FENCE NOTES

1. Fence to be installed before start of construction.

Fence to be located as shown on plan.

- 3. Attachment of fence to trees to be preserved is not permitted
- 4. Fencing to be monitored regularly for damage and ensure functioning as designed.
- No excavation, stock piling of materials or other construction related activity shall occur within the Tree Protection Barrier.
- 6. Install onto tree protection fence at intervals of 100 meters, tree protection zone signs as per details.
- 7. Standard 0.9 high silt fabric affixed to palge wire fence with staples. Clear stone or native soil mix material 0.15m high to cover silt fabric.
- 8. Barrier signage.
- TREE PROTECTION ZONE (TPZ) No grade change, contaminants, storage of equipment materials, etc. is allowed within TPZ. Tree protection fence is not to be removed without written authorization from project consultant/Town of Newmarket.

5. Trees and other vegetation within the the Tree Protection Barrier shall be adequately maintained throughout the construction process. They shall be watered sufficiently, particularly if the root system has been disturbed during construction.

4. No excavation, stock-piling of materials or other construction related activity shall occur within the

Tree Protection Barrier.


- 6. Root and branch pruning shall only be completed with approval from and in accordance with The Town of Newmarket and the Consultant.
- 7. If any damage occurs to the protected vegetation (regardless of how) the Contractor is required to notify the permit holder within two working days.



GUIDELINES

TREE PRESERVATION FENCING DETAIL

SCALE: N.T.S. NEWMARKET STANDARD DETAIL

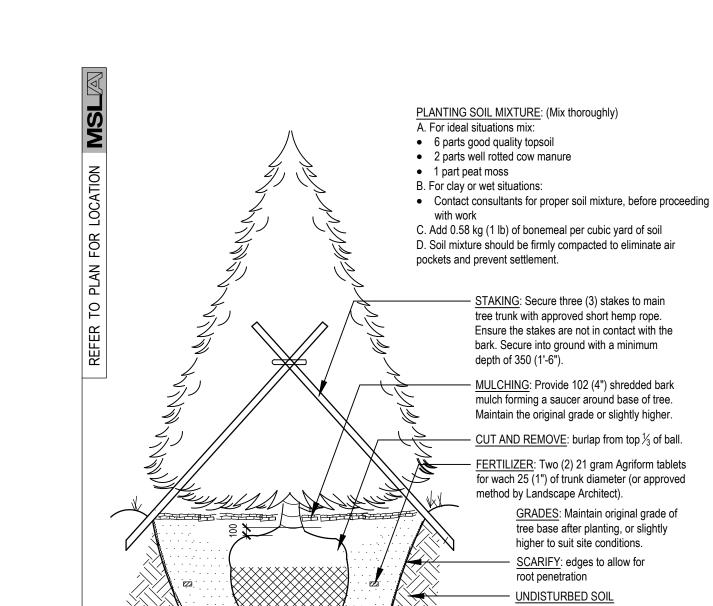

STANDARD CONIFEROUS TREE DETAIL

NOTE: All tree stakes, ties, wraps and guards are

to be removed one year after installation by the


ALL GIVEN DIMENSIONS ARE IN METRIC

WIRE BASKETS OR STRING ON ROOT

BALL - CUT AND TOP REMOVE 3/3

SCALE: N.T.S. DATE:

landscape contractor.

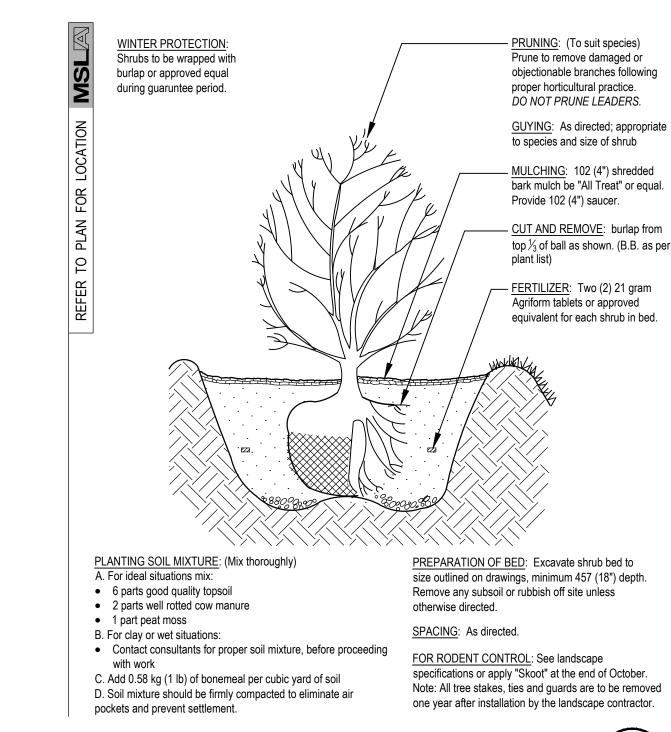

STANDARD SHRUB PLANTING DETAIL

SCALE: N.T.S. DATE:

12 3rd & 4th OPA/ZBLA/SPA 05/26/23 11 Issued for Coordination 11/09/22 Revised per Comments 11/25/21 Revised for Submission Revised per Site Plan 09/23/21 Revised per Arborist Data Revised per Site Plan 08/20/20 Revised per Site Plan 07/17/20 04 Revised per Site Plan 09/28/18 03 Issued for Review 09/20/18 Revised per Site Plan No. Revision Date North:

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Architect:

Planner:

Municipality

Notes:

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Project:

Drawing Title:

Proposed Residential Development

1015 Davis Drive & 22 Hamilton Drive Newmarket, Ontario

Scale: As Shown Date: April 2018 Drawn By: **D.R.** Checked By: **L.M.**

Landscape **Details**

Project No.

LD-01

 This Tree Planting detail shall be used for Prune dead and broken branches to maintain either coniferous or deciduous. Basket natural form of tree and Burlap trees (unless multi stem Stake beyond edge of root ball This Tree Planting detail shall be used in species is specified Use rubber straps at end of all guy wires to detials as outlined in the Town of protect the tree at point of contact Newmarket Tree Planting Guidelines. Tree pit to be double the size of the root ball Stakes are to be removed after 1 year. Contractor to Coordinat Root ball resting on undisturbed soil Stakes should be hammered down into solid footing (at least 400mm into sub-soil base) If tree is in a wire basket, cut strapping, cut basket and pull burlap back from top 1/3 of rootball Remove all burlap wrap from tree trunk Top of root ball at existing grade or slightly higher in poorly drained soils (50mm max. above grade) Backfill firmly tamped to prevent settling and leaning Il gauge guy wire-Do not allow air pockets to form when back filling Black rubber strap. Remove all burlap — Wire does not go around tree Shredded mulch, preferably cedar (100mm depth), wrap from tree trunk not contacting base of trunk - 60 - 100mm caliper tree Use two 50x50mm — Taper mulch to base Base of tree 25mm above grade Sod disturbed area Slope Top Soil from Root Ball to edge of hole to form well -Tree pit to be double the size of the root ball - Cut strapping, cut basket and pull burlap back from top 1/3 of rootball

Town of Newmarket

STREET_TREE:_TREE_DETAIL


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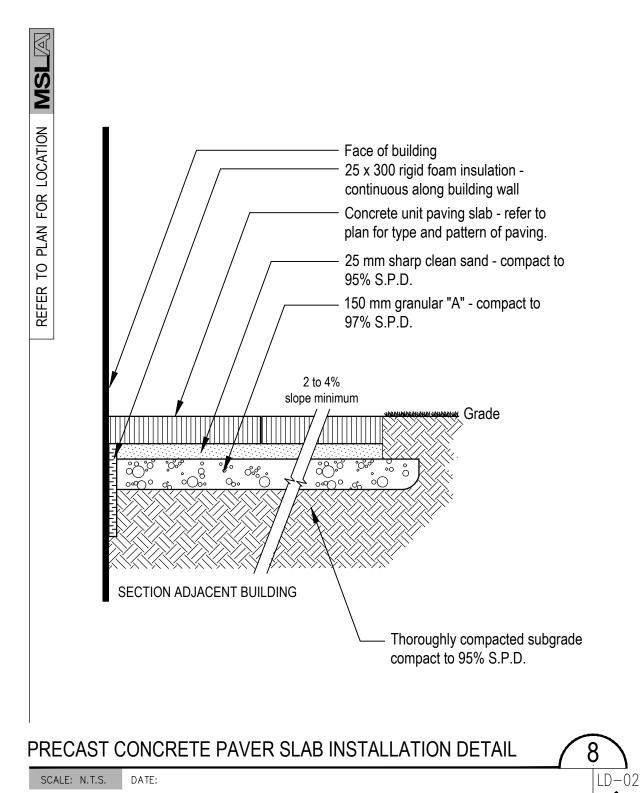
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STREET TREE PLANTING DETAIL


SCALE: N.T.S. NEWMARKET STANDARD DETAIL






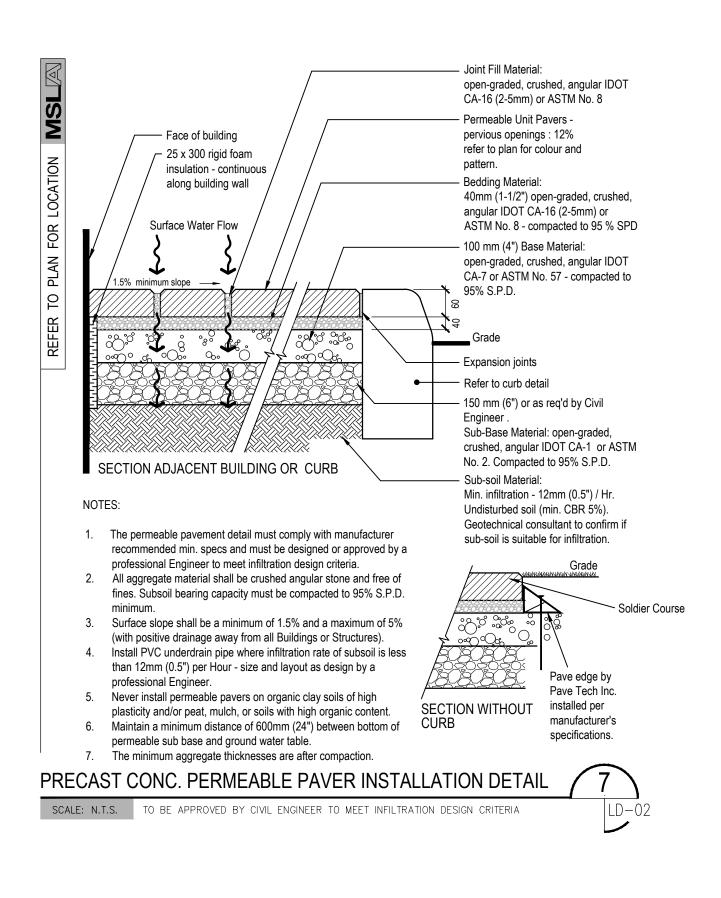


SCALE: N.T.S. 1/4" (6mm) GAP BETWEEN BOARDS

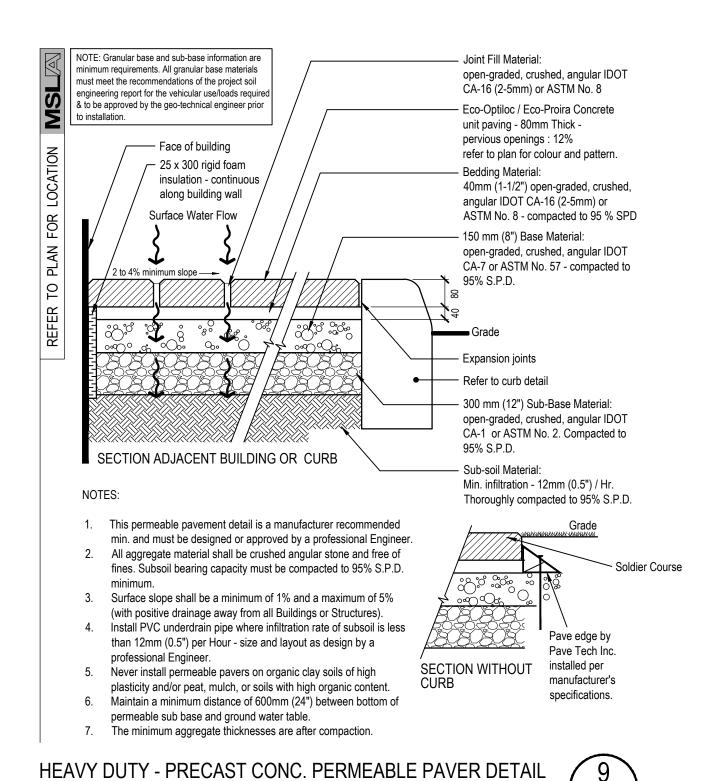

SCALE: N.T.S. TO BE APPROVED BY CIVIL ENGINEER TO MEET INFILTRATION DESIGN CRITERIA

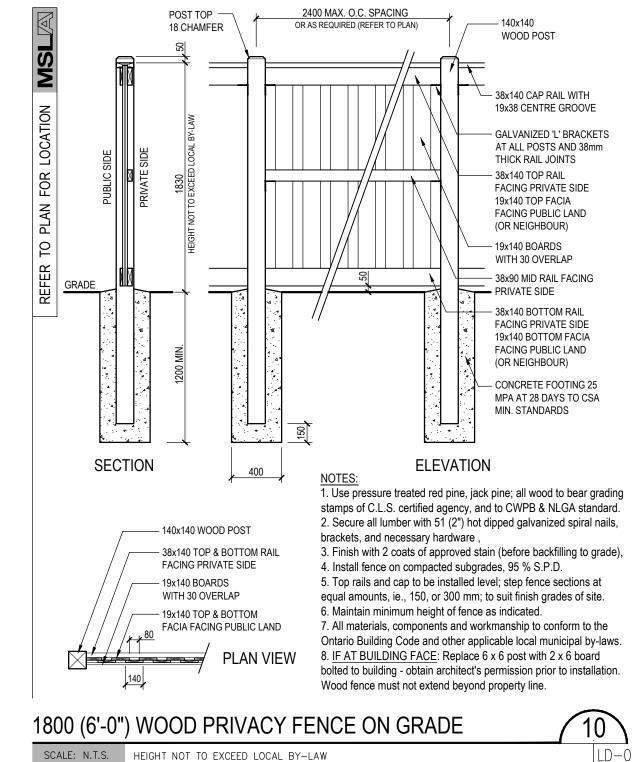

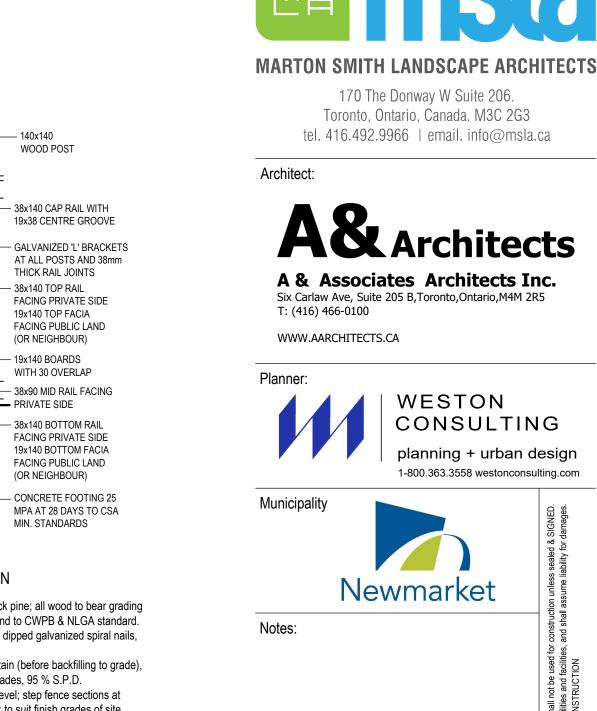

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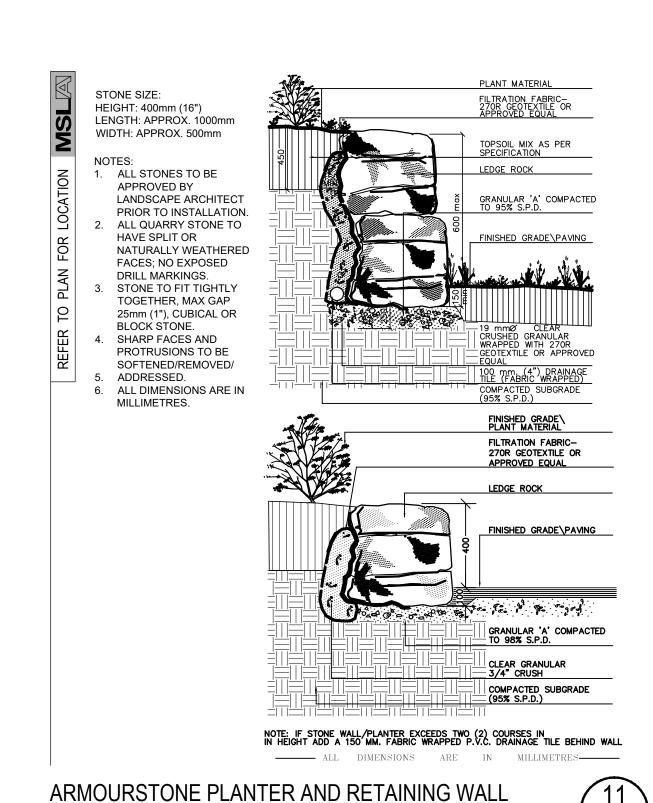
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11/09/22


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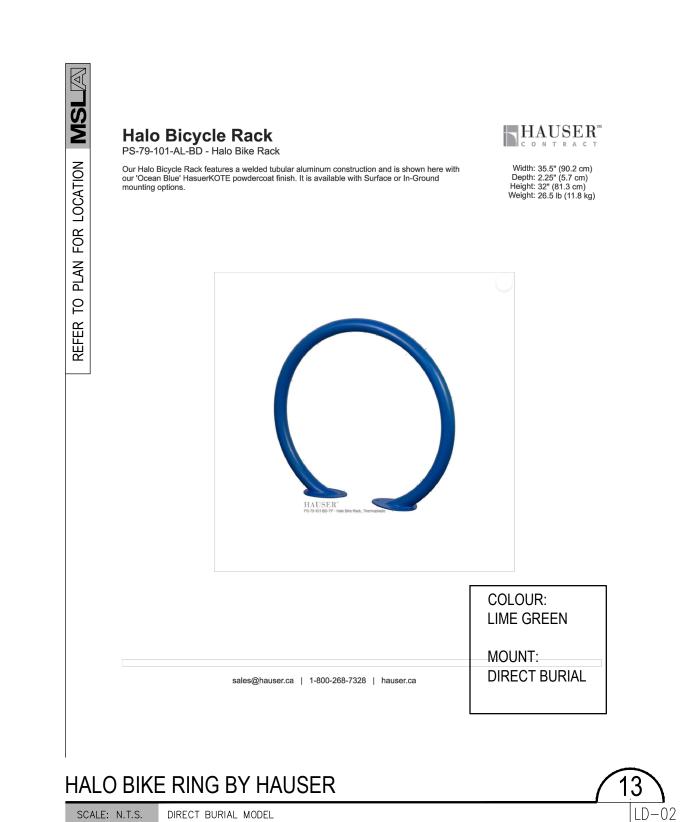
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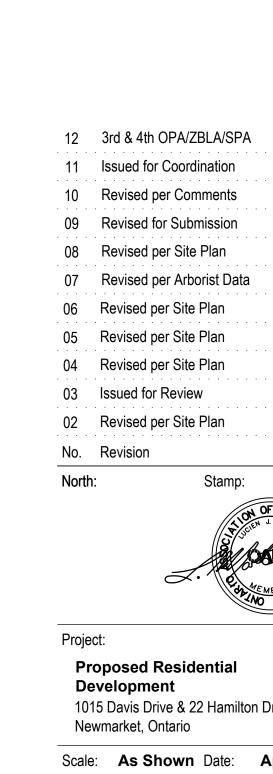
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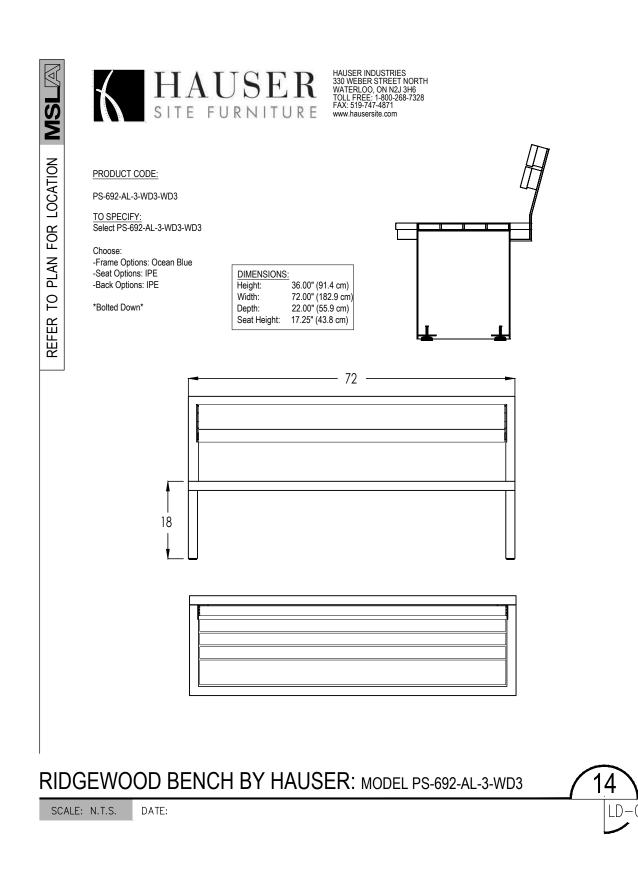
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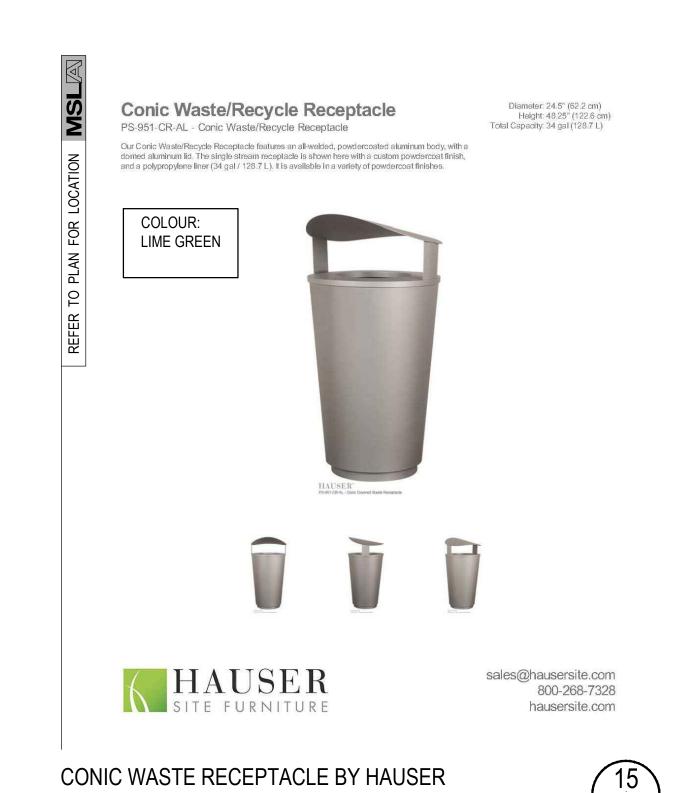







09/28/18 Date 1015 Davis Drive & 22 Hamilton Drive Scale: As Shown Date: April 2018 **D.R.** Checked By: **L.M.** Drawn By: Drawing Title: Landscape **Details** Project No. **LD-02**




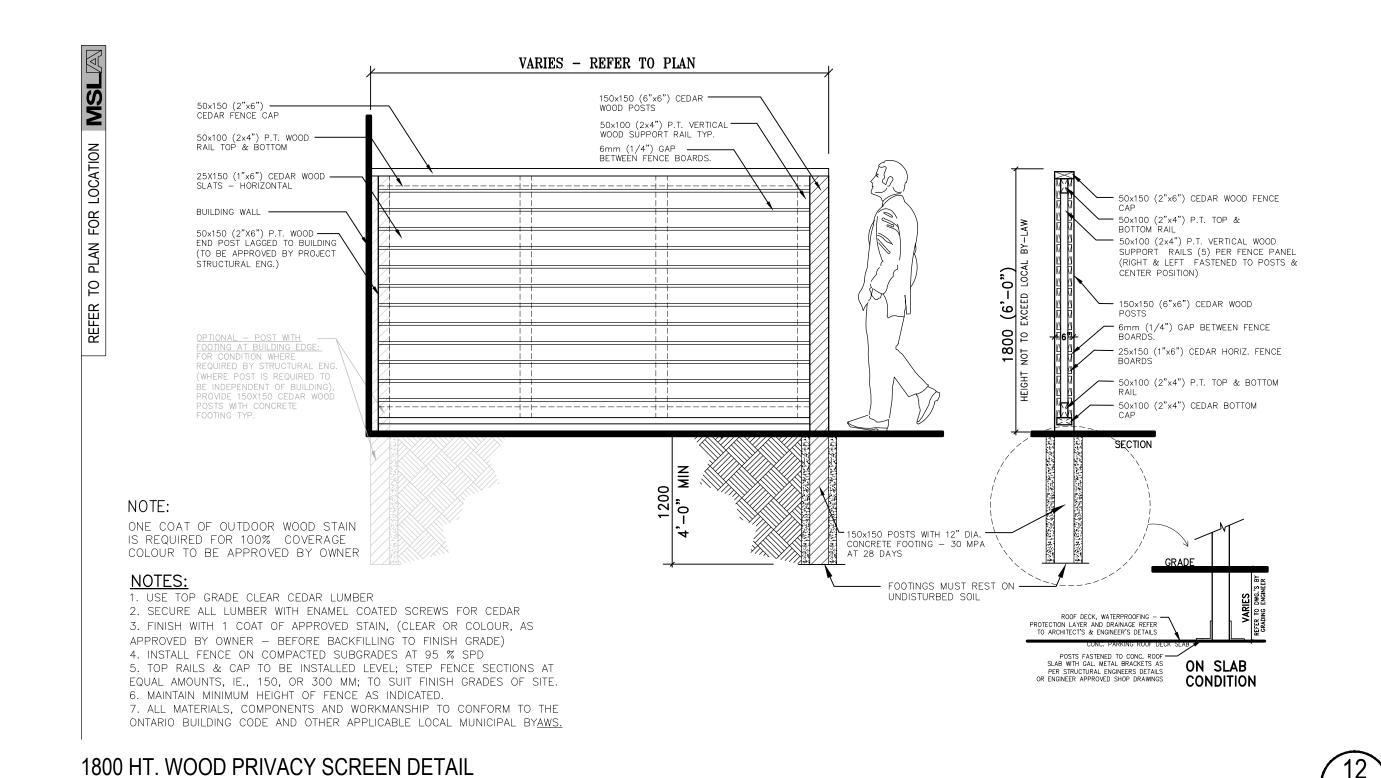





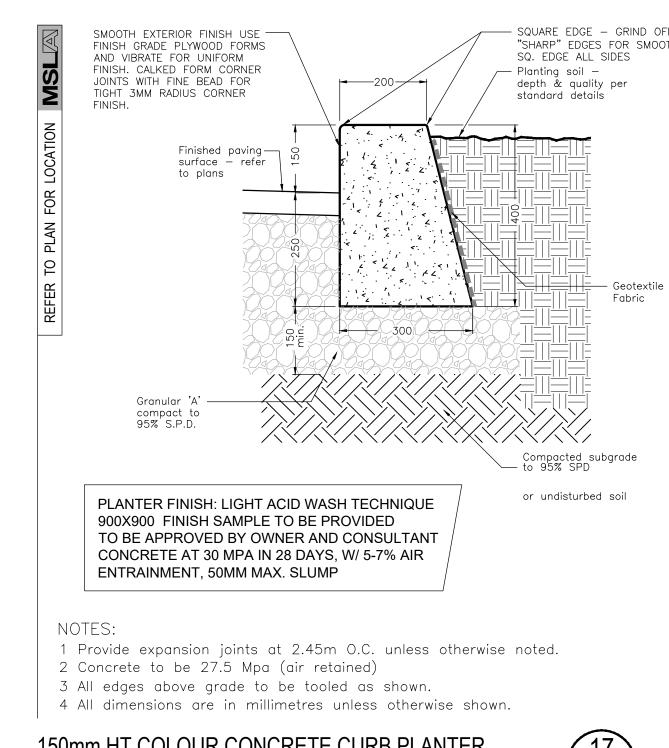



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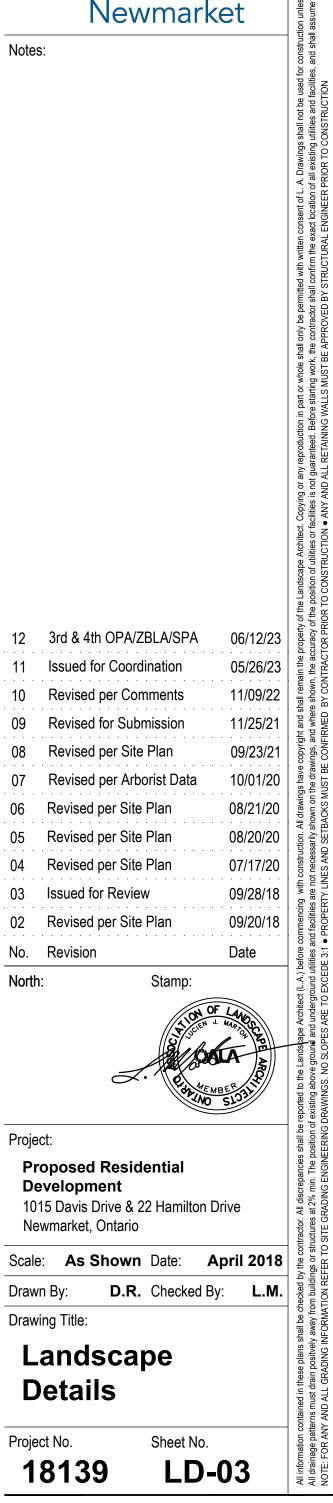


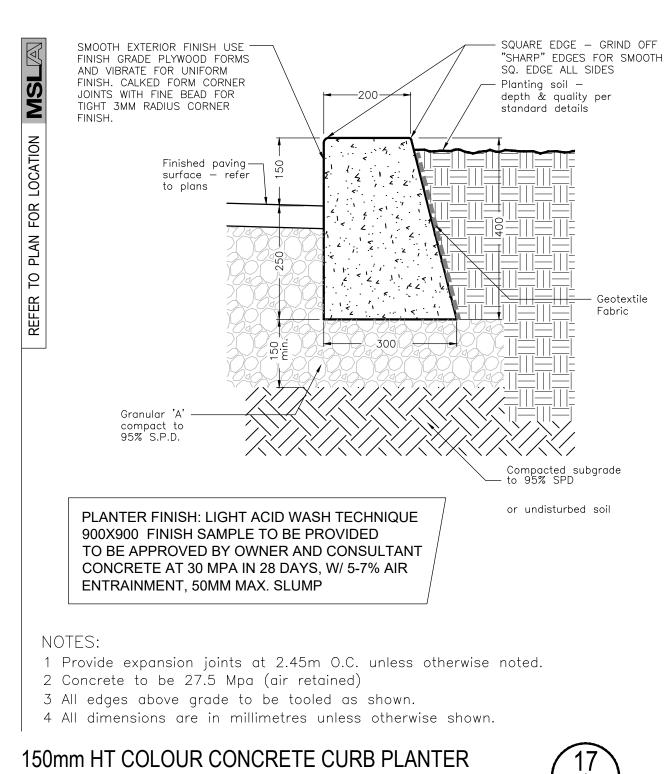

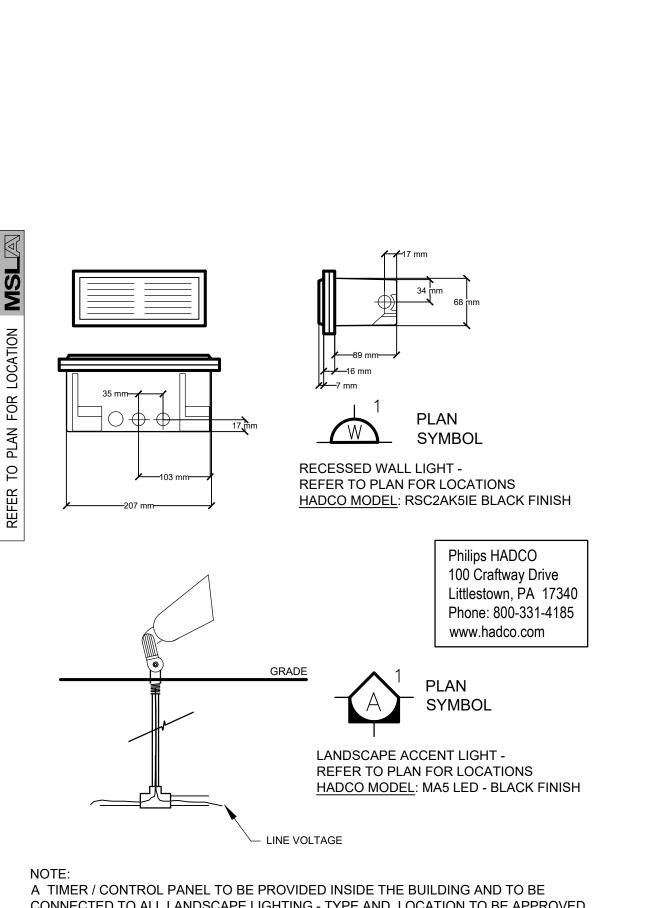

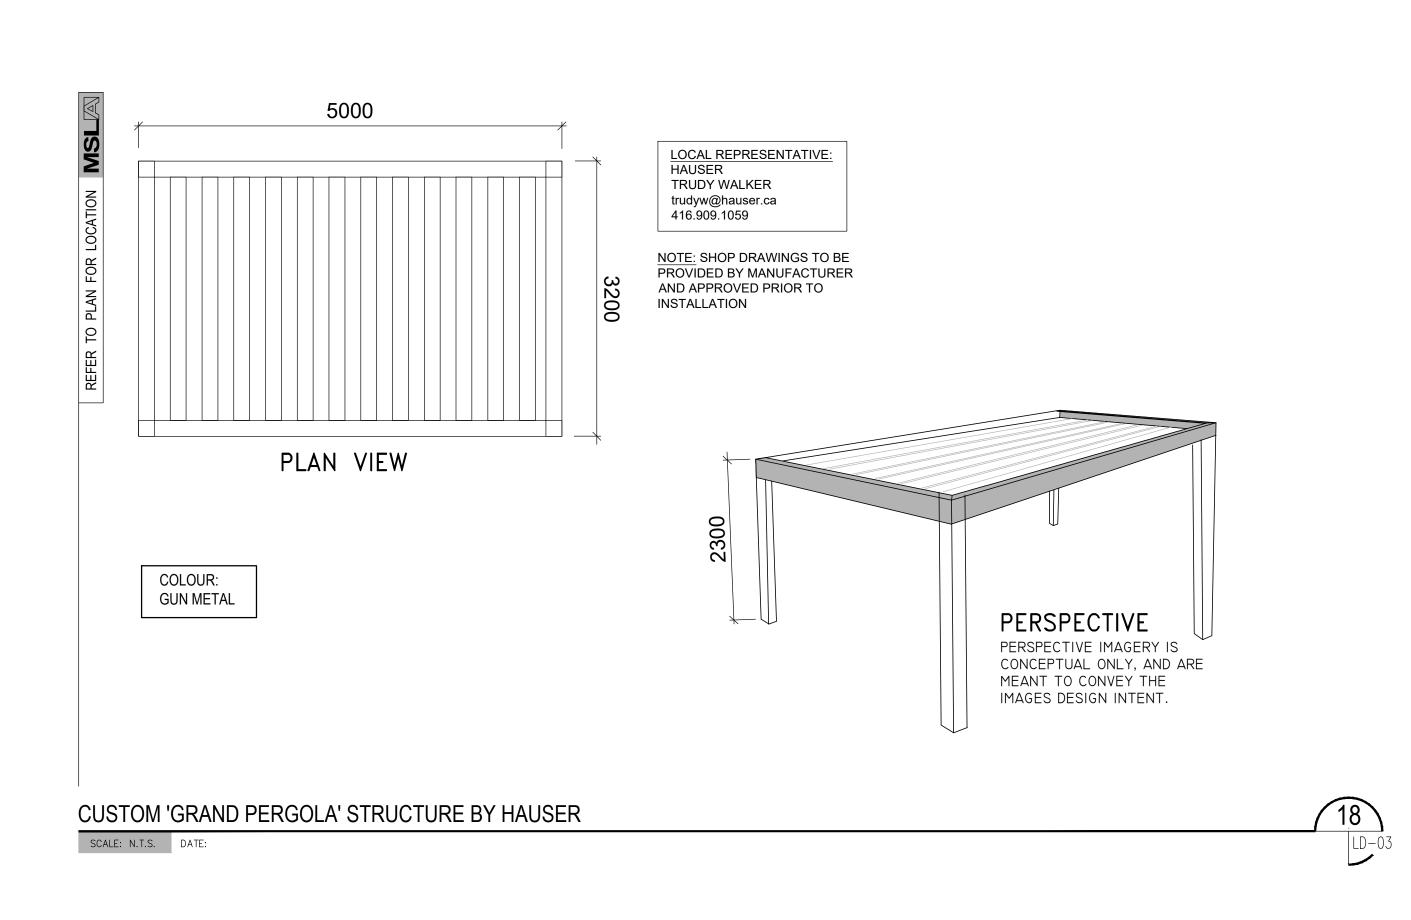

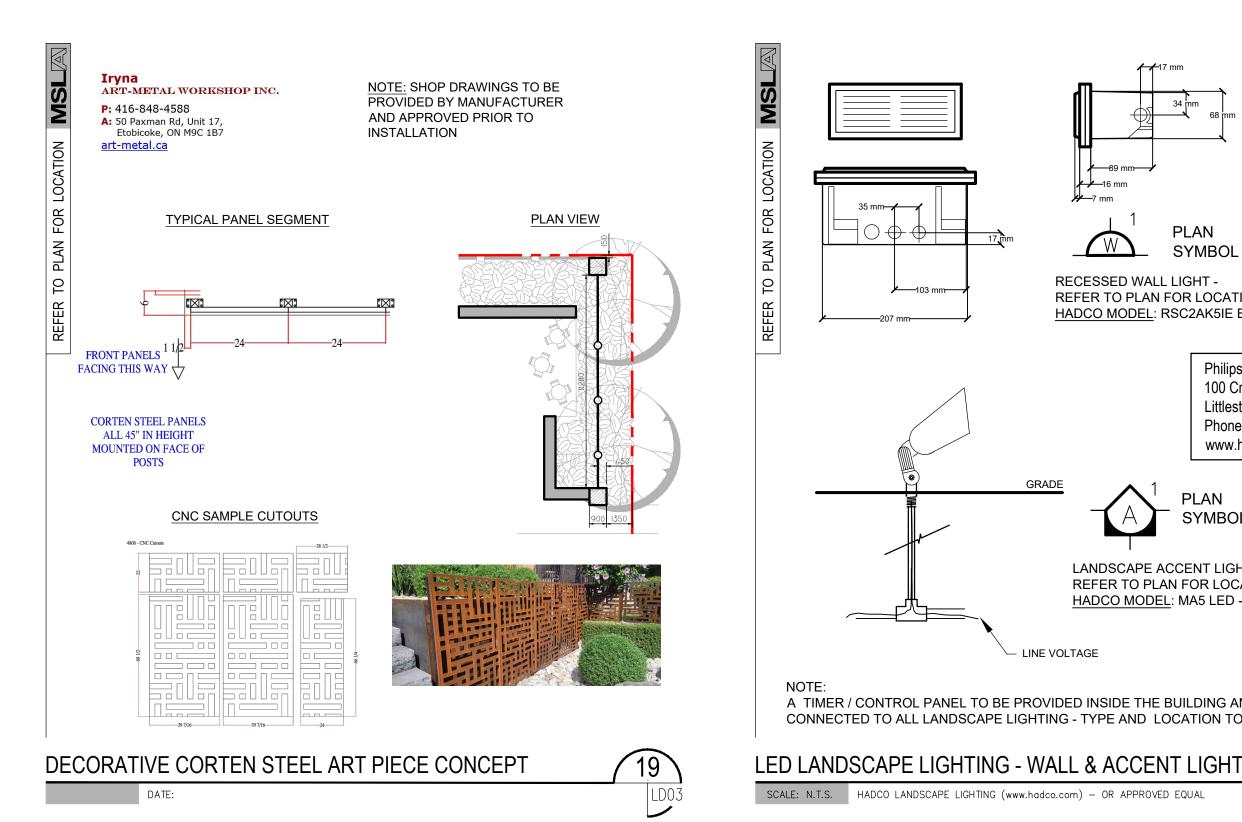SCALE: N.T.S. HADCO LANDSCAPE LIGHTING (www.hadco.com) - OR APPROVED EQUAL

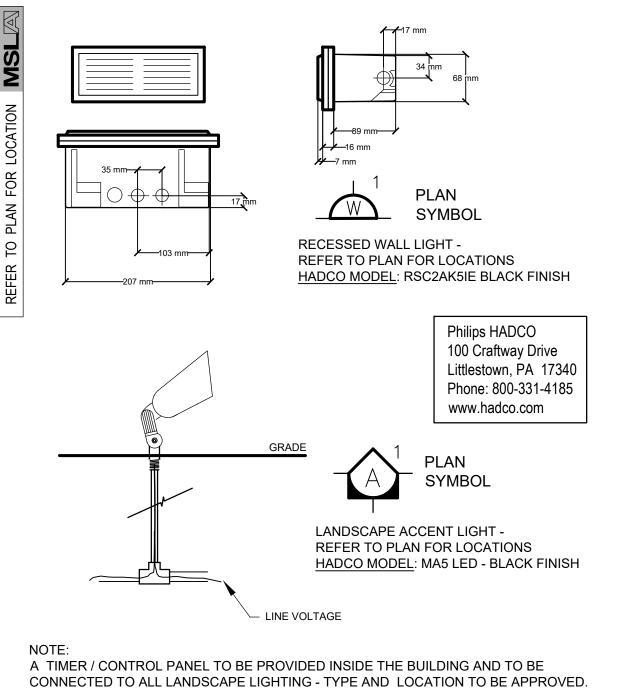

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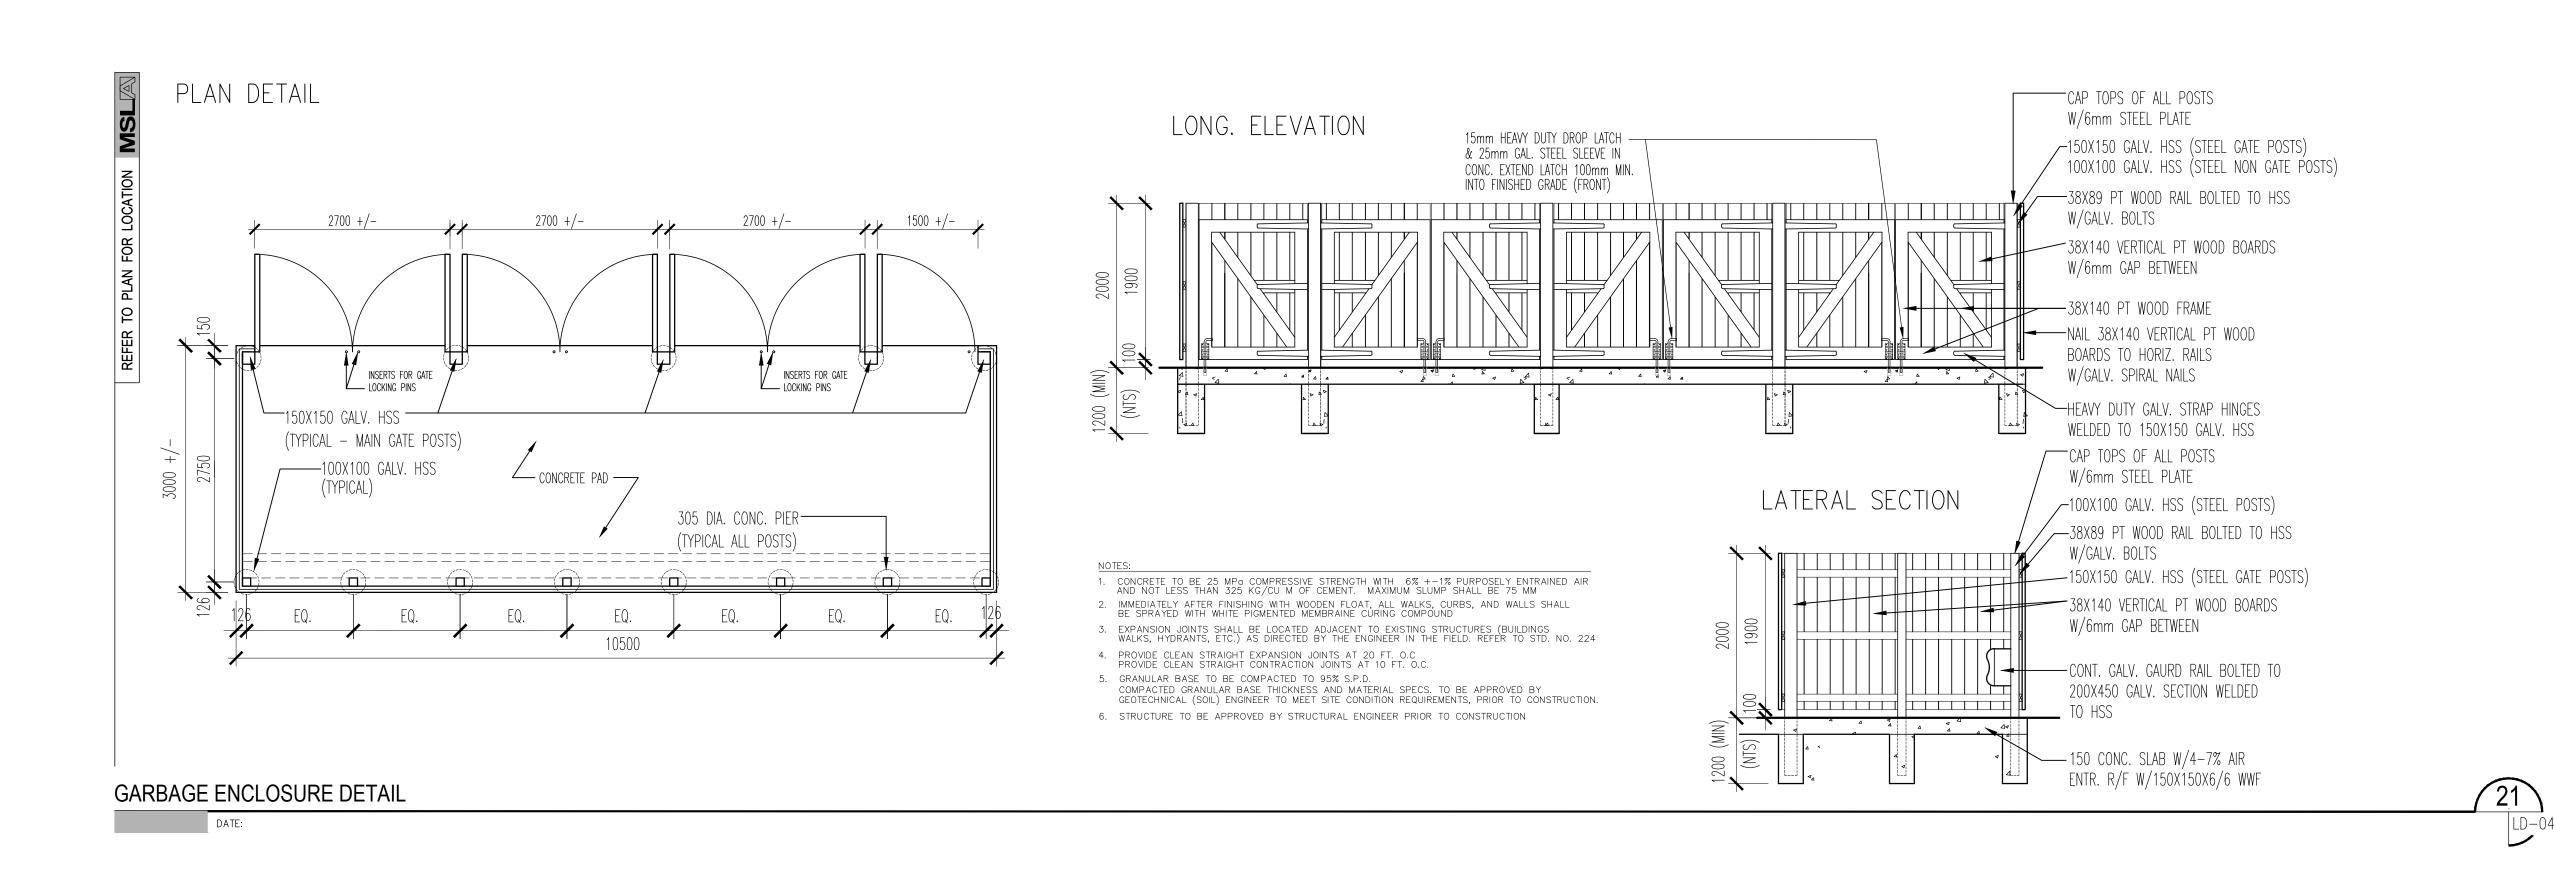
Architect:


Planner:

Municipality

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Architect:

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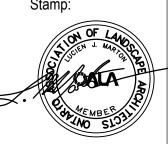
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12 3rd & 4th OPA/ZBLA/SPA 05/26/23 11 Issued for Coordination 11/09/22 10 Revised per Comments 11/25/21 09 Revised for Submission 09/23/21 08 Revised per Site Plan 07 Revised per Arborist Data 06 Revised per Site Plan Revised per Site Plan 08/20/20 07/17/20 04 Revised per Site Plan 09/28/18 03 Issued for Review 09/20/18 02 Revised per Site Plan No. Revision Date

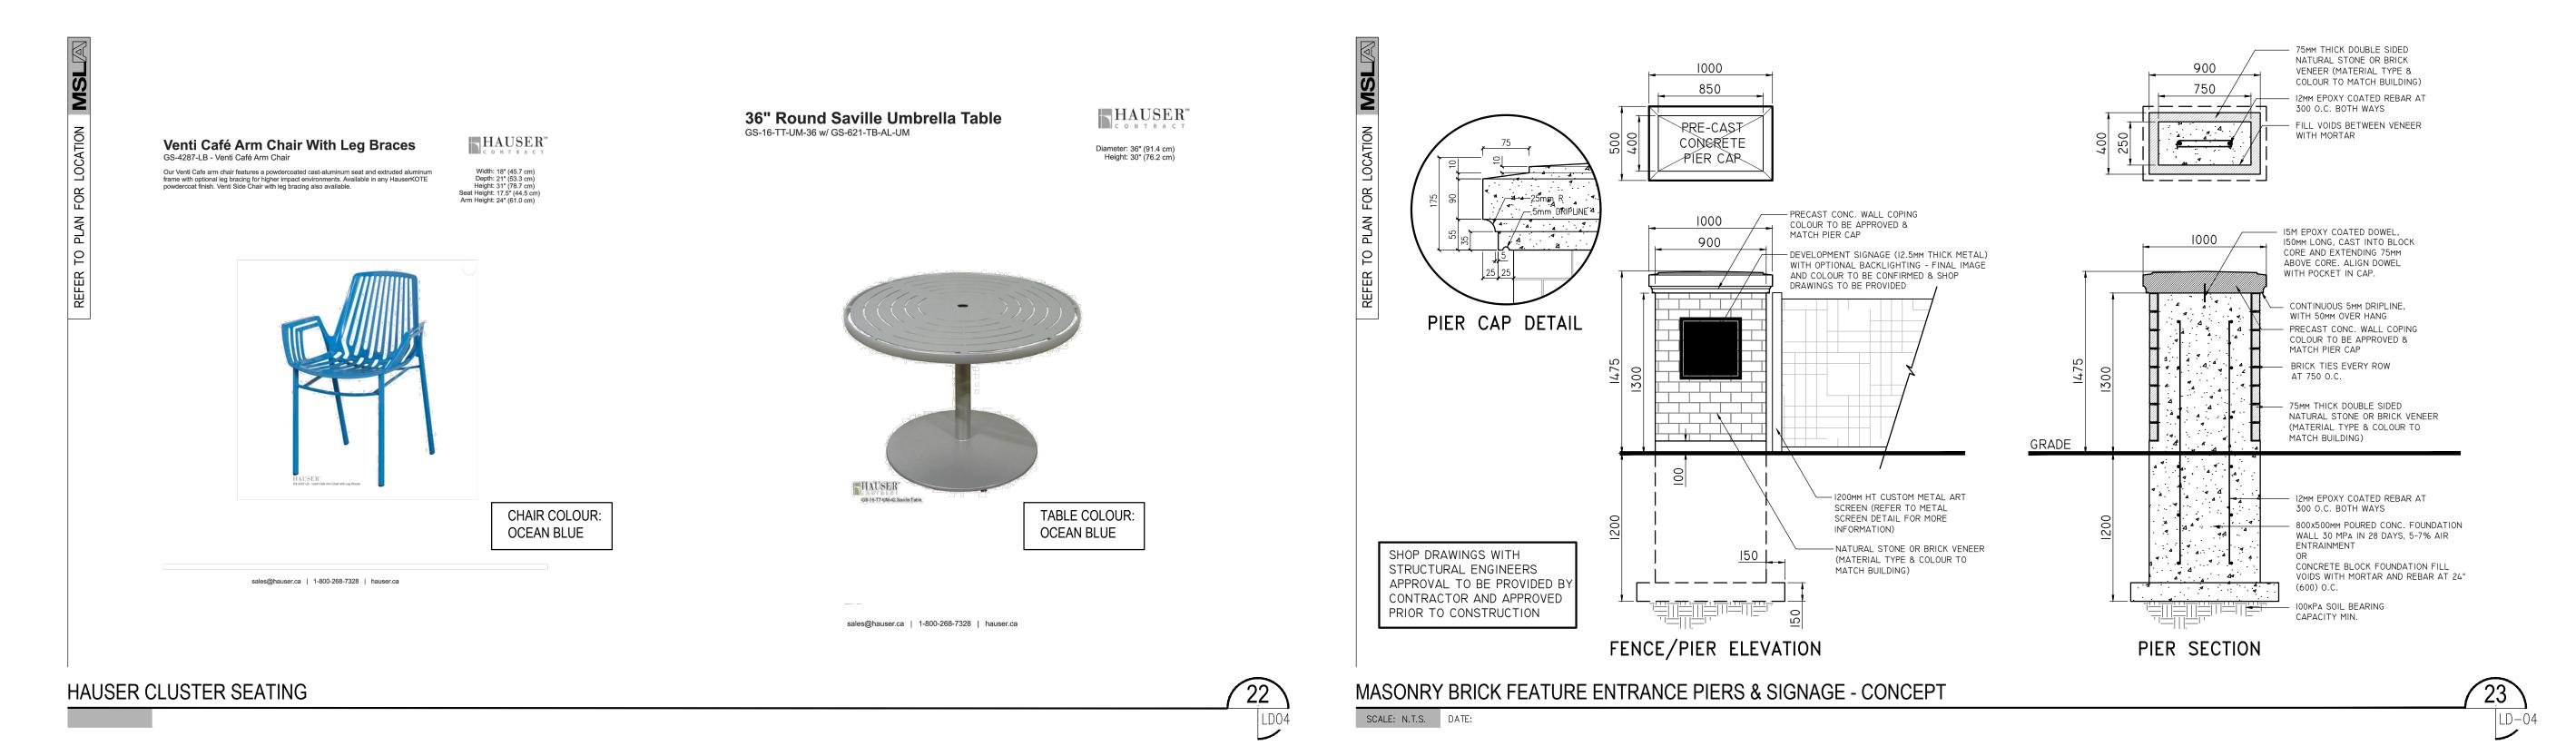

Project:

North:

Proposed Residential
Development

1015 Davis Drive & 22 Hamilton Drive Newmarket, Ontario

Scale: As Shown Date: April 2018


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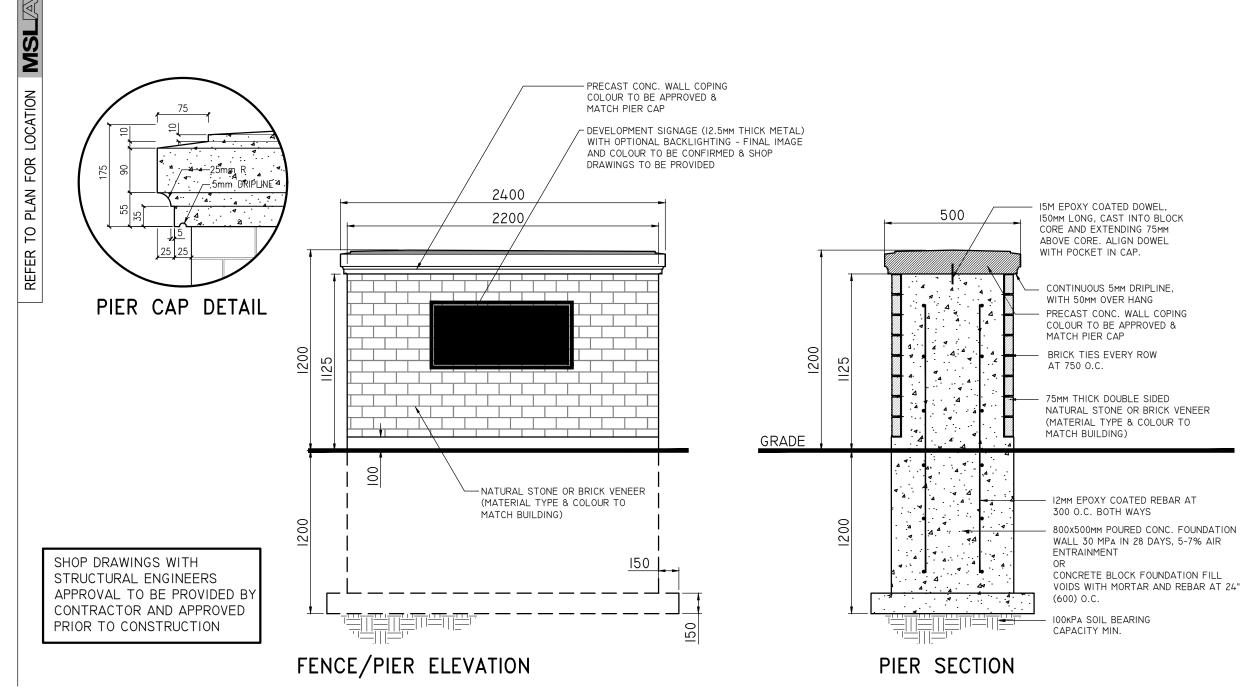
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Landscape Details

Project No. Sheet No.


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MASONRY BRICK FEATURE ENTRANCE PIERS & SIGNAGE - CONCEPT

SCALE: N.T.S. DATE:

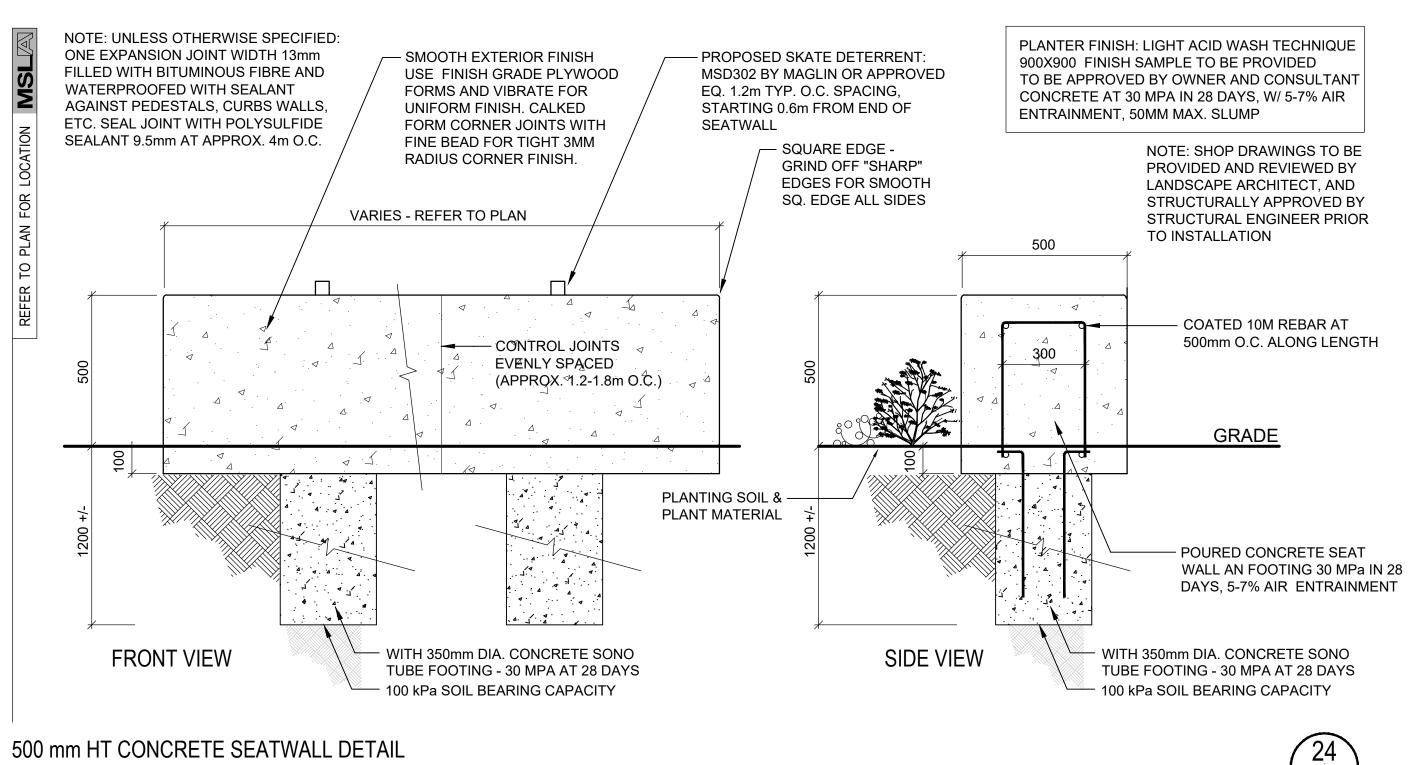

SCALE: N.T.S. DATE:

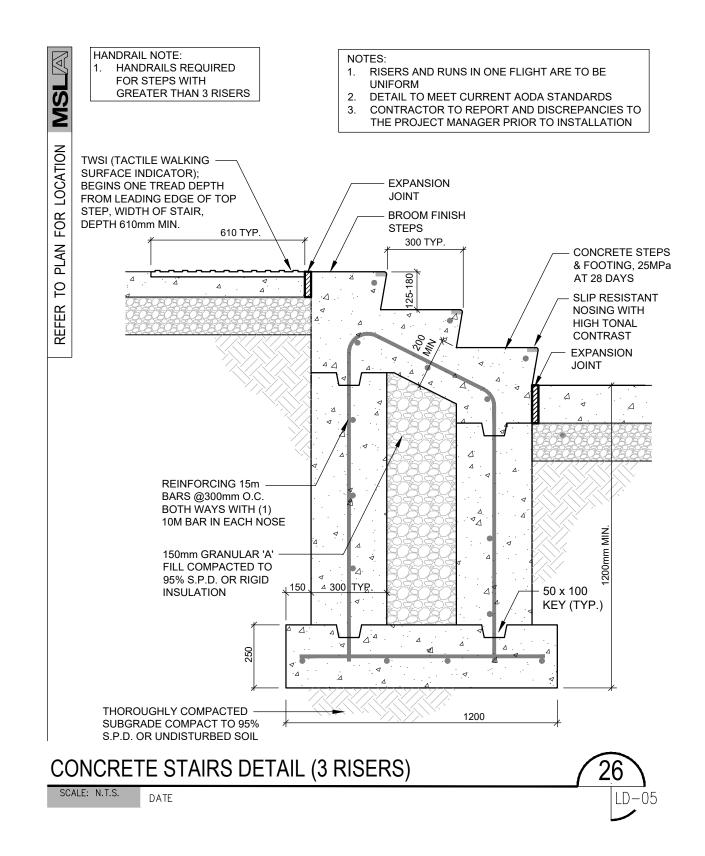

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No.	Revision	Date
02	Revised per Site Plan	09/20/18
03	Issued for Review	09/28/18
04	Revised per Site Plan	07/17/20
05	Revised per Site Plan	08/20/20
06	Revised per Site Plan	08/21/20
07	Revised per Arborist Data	10/01/20
08	Revised per Site Plan	09/23/21
09	Revised for Submission	11/25/21
10	Revised per Comments	11/09/22
11	Issued for Coordination	05/26/23
12	3rd & 4th OPA/ZBLA/SPA	06/12/23

Project:

Proposed Residential
Development
1015 Davis Drive & 22 Hamilton Drive

Newmarket, Ontario

Scale: As Shown Date: April 2018

Drawn By: D.R. Checked By: L.M.

Drawing Title:

Landscape

Landscape Details

Project No. Sheet No.

Sheet No.