California Eye Specialists

New Medical Building (30,382 sf)

25258 REDLANDS BLVD. LOMA LINDA, CA 92354

PROJECT CONSULTANTS

Alexander Varga 224 North Fair Oaks Ave. Pasadena, CA 91103 p.626.696.1434 mbl. 626.644.8617 email: av@alexandervarga.com

Structural Engineer

CM Peck 25 S. El Molino Ave. Pasadena, CA 91101 Office: 626.683.0708

Landscape Architect hourian associates, inc. 107 avenida miramar, suite d san clemente, california 92672

p.949.489.5623 efax 877.271.3122

Electrical Engineer Salas Obrien 8825 RESEARCH DRIVE **IRVINE**, CA 92618 TEL: (949) 753-1553

Civil Engineer **Encompass** Associates, inc. 5699 Cousins Place Rancho Cucamonga, CA 91737 p.909.684.0093 askeers@encompasscivil.com

Mechanical / Plumbing Engineer **Pocock Design** 14451 Chambers Road Suite 210 Tustin. Ca. 92780 Ph. (949) 417-3903

GENERAL NOTES

UTILITIES

1-855-470-3572

1-855-237-5355

<u>WATER, SEWER, & TRASH</u> CITY OF LOMA LINDA (909) 799-2845

TELEPHONE & CABLE TV

FRONTIER COMMUNICATIONS (FORMERLY VERIZON CA)

(FORMERLY TIME WARNER CABLE)

ELECTRICITY SOUTHERN CALIFORNIA EDISON

GAS SOUTHERN CALIFORNIA GAS COMPANY 1-800-427-2200

SEWER LATERALS ARE NOT SHOWN ON CITY MAP. SEWER LATERALS SHALL BE LOCATED AS NECESSARY DURING THE BUILDING PERMIT PROCESS.

PUBLIC WORKS

PUBLIC WORKS NOTE:

GRADING AND DRAINAGE OF SITE SHALL COMPLY WITH ALL CITY AND STATE REQUIREMENTS FOR WATER INFILTRATION, RETENTION, AND SUCH SYSTEMS SHALL BE DESIGNED BY A REGISTERED CIVIL ENGINEER DURING THE BUILDING PERMIT PROCESS.

PROJECT STATISTICS

LEGAL DESCRIPTION

PARCEL MAP 18208 PARCEL 1 UNIT 11A AND 11B BOOK 228 PAGE 3 AND INT COMMON AREA AS DESC IN CONDO PLAN #2008-0241183

APN: 0292-631-17-0000 AND 0292-631-18-0000

PROJECT DESCRIPTION

TWO STORY, 30,382 SF, NEW MIXED-USE FACILITY, MEDICAL OFFICE BUILDING AS OWNER USER DEVELOPMENT INCLUDING AN "EYE SURGERY CENTER" WITH SOME MEDICAL OFFICE AND RETAIL LEASE SPACE AS PART OF THE PROJECT.

THIS IS AN INFILL SITE ON 2 PARCELS TOTALING 2.04 ACRES. NEW SITE DEVELOPMENT WITH PARKING AND LANDSCAPING AND PUBLIC SEATING SPACES ALONG REDLANDS BLVD. AND RICHARDSON STREET.

CUP APPLICATION NUMBER: P19-071 TPM APPLICATION NUMBER: P19-000-122 SIGN PROGRAM NUMBER: P19-134

VICINITY MAP

No Scale REDLANDS BLVD. COURT ST. No Scale

MATERIALS

POZ, LLC

1900 W. GARVEY AVE., UNIT 335 WEST COVINA . CA 91790 626-305-9100

PROJECT ADDRESS

25258 REDLANDS BLVD LOMA LINDA. CA 92354

CURRENT APNS: 0281-162-33 & 0281-162-34

GROSS BUILDING AREA: 30,382SF NET BUILDING AREA: 30,084 SF

OCCUPANCY: B (MEDICAL OFFICE / RETAIL USE) I-2.1 (ASC / EYE SURGERY CENTER)

CONSTRUCTION TYPE: VA FULLY SPRINKLERED

CUP APPLICATION NUMBER: P19-071

GENERAL PLAN LAND USE: COMMERCIAL

EAST VALLEY CORRIDOR SPECIFIC PLAN

- (Shall Comply with CBC 907.2.6.2 & CBC 407.2.1)
- 4. KEYLESS ENTRY / BUILDING ALARM
- 5. EXTERIOR SIGNAGE

- 6. SITE FENCING AND GATES

LOT COVERAGE, LANDSCAPE PERCENTAGE AND PARKING INFORMATION

LOT AREA: 2.04 AC = 88,862 SF LOT COVERAGE OF BUILDING AND CANOPIES: 20,525 = 23%

F.A.R OF GROSS BUILDING AREA: 30.382 / 88.862 = 34%

24,245 SF LANDSCAPE / 88,862 SF LOT = 27.3% 3309 SF PERVIOUS PAVERS, 2588 SF CONC. WALKS & BENCHES, 18348 SF PLANTING AREA

USEABLE BUILDING AREA LESS MECHANICAL SPACE 30,382 SF - 298 SF (MECH) = 30,084 SF

PROVIDED: 125 SPACES TOTAL ACCESSIBLE SPACES PROVIDED AND INCLUDED IN TOTAL = 6 SPACES

SHEET INDEX

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CG.2 CalGreen Mandatory Measures Sheet 2 of 3

CG.3 CalGreen Mandatory Measures Sheet 3 of 3 A0.1 Site and Building Accessibility Details 1

A0.2 Site and Building Accessibility Details 2

A0.3 Site and Building Accessibility Details 3 A0.4 Site and Building Accessibility Details 4

A0.5 Site and Building Accessibility Details 5

A0.6 Site and Building Accessibility Details 6 A0.7 Parking Area Lighting Photometric Plan

A0.8 Site Details

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A1.1 Second Floor Plan

A1.2 Roof Plan

A1.3 First Floor Reflected Ceiling Plan

A1.4 Second Floor Reflected Ceiling Plan A2.0 Exterior Elevations (Sheet 1 of 2)

A2.1 Exterior Elevations (Sheet 2 of 2)

A3.0 Building Sections (Sheet 1 of 5)

A3.1 Building Sections (Sheet 2 of 5)

A3.2 Building Sections (Sheet 3 of 5)

A3.3 Building Sections (Sheet 4 of 5) \ /1\

A3.4 Building Sections (Sheet 5 of 5)

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A6.0 Window and Door Schedule A6.1 Window and Exterior Door Graphic Schedule

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S-1.3 Roof Details

S-1.4 Typical Framing Details S-1.5 Typical Metals Studs Details 1

S-1.6 Typical Metals Studs Details 2

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S-2.2 Second Floor Plan

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S-3.3 Roof Framing Details

S-3.4 Details

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M-2.2 Mechanical Second Floor Plan

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M-4.2 Mechanical Details 2

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M-5.1 Mechanical Controls

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E0.1.2 Electrical Symbol List

E0.2.1 Electrical Specifications

E0.2.2 Electrical Specifications E0.2.3 Electrical Specifications

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E0.7 Exterior Title 24 Calculations **E0.8** Title 24 Power Distribution Forms

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E0.20 Panel Schedules E1.0 Electrical Site Plan

E2.0 First Floor Electrical Plan

E2.1 2nd Floor Electrical Plan **E2.2** Roof Electrical Plan

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C-6 Erosion Control Details

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L-1.1 Reports and Calculations L-1.2 Planting Details

L-1.3 Planting Specifications L2.0 Irrigation Plan

L2.1 Irrigation Details

L2.2 Irrigation Details **L2.3 Irrigation Specifications**

VARGA ASSOCIATES

ARCHITECTS / CONSULTANTS

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Ca. Lic. 29853

hourian associates, inc.

Structural Engineer CM Peck

Pocock Design

Civil Engineer **Encompass Associates, Inc.**

Mechanical/Plumbing Engineer

Mechanical/Plumbing Engineer Salas Obrien

Project

Cal Eye Loma Linda

25258 Redlands Blvd. Loma Linda, CA 92354

Owner

POZ, LLC 1900 W. Garvey Ave. **Unit 335** West Covina, CA 91790

p. 626.305.9100

PROJECT TEAM ISSUE DATES DESCRIPTION NO. 05-01-20 Construction Docs

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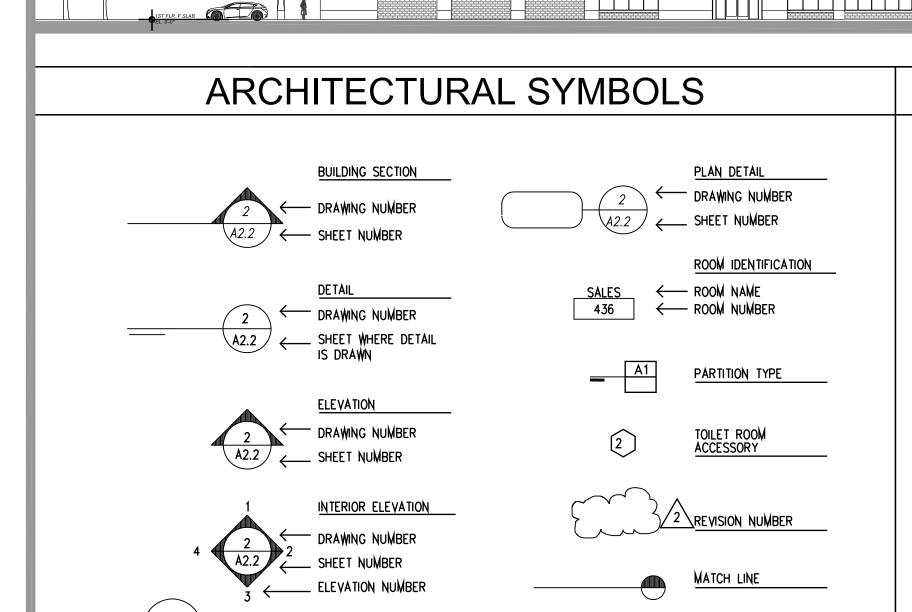
SHEET TITLE

SHEET NO.

JOB NO. CE-2019-1

Cover

STATUS: CONSTRUCTION DOCS



DOOR SYMBOL

WINDOW SYMBOL

EL. 370.00'

THIS PROJECT SHALL CONFORM TO THE

CALIFORNIA BUILDING CODE (CBC)

CALIFORNIA FIRE CODE

CALIFORNIA ELECTRICAL

CALIFORNIA PLUMBING CODE

CALIFORNIA MECHANICAL CODE

NFPA 13 FIRE SPRINKLER STANDARD

NFPA 99 AND 101 FOR MEDICAL OFFICES.

NFPA 72 FIRE ALARM MONITORING

CALIFORNIA TITLE 24

and CBC 407.2.1.*

FOLLOWING REFERENCED BUILDING CODES:

LOMA LINDA MUNICIPLE CODE (LLMC); LLCCP

*Fire Alarm System Shall Comply with CBC 907.2.6.2

ELEVATION LEVEL

PROPERTY LINE

SPOT ELEVATION

2019 EDITION

2019 EDITION

2019 EDITION

2019 EDITION

2019 EDITION

2019 EDITION

REGULATORY REQUIREMENTS / NOTES

CENTERLINE

METAL STUD FRAMING, THROUGH MEMBER WOOD FRAMING. THROUGH MEMBER BLOCKING/SHIM CONCRETE EXISTING CONCRETE EARTH GYPSUM BOARD INSULATION

OWNER

RIGID INSULATION

LOMA LINDA SPECIFIC LCPL NOTE:

TO ISSUING GRADING PERMITS."

CUP APPLICATION NUMBER: P19-071

"THIS PROJECT WILL COMPLY WITH THE LOMA LINDA

CONNECTED COMMUNITY PROGRAM (LCPL) AND BE EQUIPPED

WITH THE CITY'S NEW FIBER-OPTICS INTERFACE AND COPPER

SHALL BE PROVIDED WITH THE PRECISE GRADING PLANS AND

REVIEWED AND APPROVED BY THE CITY OF LOMA LINDA PRIOR

CABLING. PLANS FOR THE LOCATION OF THE INFRASTRUCTURE

1. FIRE SPRINKLER SYSTEM

2. FIRE ALARM / LIFE SAFETY SYSTEM

DEFERRED SUBMITTALS

3. NURSE CALL SYSTEM

LANDSCAPE PERCENTAGE OF ENTIRE LOT (INCLUDES WALKWAYS AND PERVIOUS PAVERS)

PARKING REQUIRED: 4 PER 1,000 FOR MEDICAL AND RETAIL 30,084 GROSS USEABLE AREA / 250 = 120.4 SPACES

TPM APPLICATION NUMBER: P19-000-122 SIGN PROGRAM NUMBER: P19-134

SFRM SPRAYED FIRE RATING MATERIALS

(MONOKOTE MK-6 BY GCP INDUSTRIES)

BXUV - Fire Resistance Ratings - ANSI/UL 263 Certified for United States

BXUV7 - Fire Resistance Ratings - CAN/ULC-S101 Certified for

See General Information for Fire-resistance Ratings - ANSI/UL 263 Certified for United States
Design Criteria and Allowable Variances

See General Information for Fire Resistance Ratings - CAN/ULC-S101 Certified for Canada Design Criteria and Allowable Variances


Design No. X854

July 12, 2019

Ratings — 1, 1-1/2, 2, 3 and 4 h.

* Indicates such products shall bear the UL or cUL Certification Mark for jurisdictions employing the UL or cUL Certification (such as Canada), respectively.

(MONOKOTE MK-6 APPLIED TO STEEL COLUMNS)

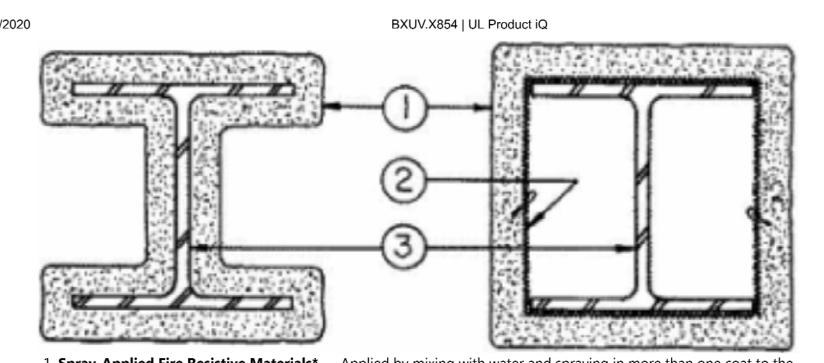

1. **Spray-Applied Fire Resistive Materials*** — Applied by mixing with water and spraying in more than one coat to the thicknesses shown below, to steel surfaces which are clean and free of dirt, loose scale, and oil. Min avg and min ind density of 15/14 pcf respectively. Min avg and min ind density of 22/19 pcf respectively for Types Z-106, Z-106/G, Z-106/HY. Min avg and min ind density of 40/36 pcf respectively for Types Z-146, Z-146PC and Z-146T cementitious mixture. Min avg and min ind density of 50/45 pcf respectively for Types Z-156, Z-156T and Z-156PC. For method of density determination, see Design Information Section, Sprayed Material.

The thickness of Spray-Applied Fire Resistive Materials to be applied to all surfaces of the column (Item 1) required for rating periods of 1

BXUV - Fire Resistance Ratings - ANSI/UL 263 Certified for United States

BXUV7 - Fire Resistance Ratings - CAN/ULC-S101 Certified for Canada

See General Information for Fire-resistance Ratings - ANSI/UL 263 Certified for United States Design Criteria and Allowable Variances

See General Information for Fire Resistance Ratings - CAN/ULC-S101 Certified for Canada Design Criteria and Allowable Variances

Design No. D782


October 04, 2019

Restrained Assembly Ratings — 1, 1-1/2, 2, 3 & 4 Hr
Unrestrained Assembly Ratings — 1, 1-1/2, 2, 3 & 4 Hr

Unrestrained Beam Assembly Ratings — 1-1/2, 2, 3 & 4 Hr

This design was evaluated using a load design method other than the Limit States Design Method (e.g., Working Stress Design Method). For jurisdictions employing the Limit States Design Method, such as Canada, a load restriction factor shall be used — See Guide BXUV or BXUV7

(MONOKOTE MK-6 APPLIED TO STEEL BEAMS AND DECK)

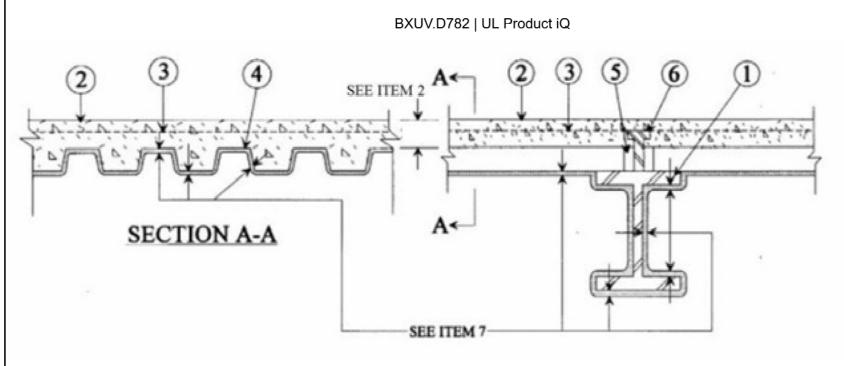

APPLY PER MANUFACTURER'S SPECIFICATIONS. ALL REQUIRED INSPECTIONS OF INSTALLED PRODUCT SHALL BE PERFORMED BY A LABORATORY LICENSED IN CA TO PERFORM SUCH INSPECTIONS.

2019 CBC CODE ANALYSIS

THIS PROJECT SHALL CONFORM TO THE FOLLOWING REFERENCED BUILDING CODES:

CALIFORNIA BUILDING CODE (CBC) 2019 EDITION CALIFORNIA FIRE CODE 2019 EDITION LOMA LINDA MUNICIPLE CODE (LLMC); LLCCP **CALIFORNIA TITLE 24** 2019 EDITION CALIFORNIA PLUMBING CODE 2019 EDITION CALIFORNIA MECHANICAL CODE 2019 EDITION 2019 EDITION CALIFORNIA ELECTRICAL NFPA 13 FIRE SPRINKLER STANDARD NFPA 72 FIRE ALARM MONITORING *Fire Alarm System Shall Comply with CBC 907.2.6.2 and CBC 407.2.1.*

USE AND OCCUPANCY

PROPOSED USE AND OCCUPANCY CLASSIFICATION

GROUND FLOOR: I-2. / Ambulatory Surgery Center

NFPA 99 AND 101 FOR MEDICAL OFFICES.

2nd FLOOR: B / Medical Office / Business Office

REQUIRED OCCUPANCY SEPARATION

2 HOURS BETWEEN GROUP I-2.1 AND GROUP B

METHOD OF SEPARATION

2 HOUR RATED MASONRY WALLS AND RATED GLASS ASSEMBLIES ON GROUND FLOOR BETWEEN I-2.1 AND COMMON HALLS AND STAIRS

FLOOR / CEILING SEPARATION BETWEEN GROUND FLOOR I-2.1 AND 2ND FLOOR GROUP B SHALL BE PROVIDED BY 6 IN. NORMAL WEIGHT CONCRETE AND 3 IN. FLUTED STEEL DECK WITH SFRM APPLIED TO STEEL BEAMS AND UNDERSIDE OF STEEL DECK (MONOKOTE MK-6 BY GCP INDUSTRIES)

CONSTRUCTION TYPE

V-A (PROTECTED) WITH AUTOMATIC FIRE SPRINKLER SYSTEM THROUGHOUT

ALLOWABLE BUILDING HEIGHT

70 FT.

54,000 SF

(GROSS) 15,000 SF

TABLE 504.3 FOR VA SPRINKLERED

ALLOWABLE STORIES

TABLE 506.2 FOR VA SPRINKLERED -GROUP B- 2 STORIES

TABLE 506.2 FOR VA SPRINKLERED -GROUP I-2.1 -SINGLE

ALLOWABLE BUILDING AREA

TABLE 506.2

VA SPRINKLERED I-2.1 ON GROUND FLOOR 28,500 SF
**ACTUAL ON GROUND FLOOR (GROSS) 15,000 SF

TABLE 506.2


VA SPRINKLERED B ON 2ND FLOOR
**ACTUAL ON 2ND FLOOR


OCCUPANT LOAD

TABLE 1004.5

GROUND FLOOR : INSTITUTIONAL OUTPATIENT $\frac{1}{100}$ SF ACTUAL = 15,000 SF / 100 SF / PERSON = 150 PERSONS

2ND FLOOR: B OFFICE STANDARD LOAD $\frac{1}{150}$ SF ACTUAL = 15,000 SF / 150 SF / PERSON = 100 PERSONS

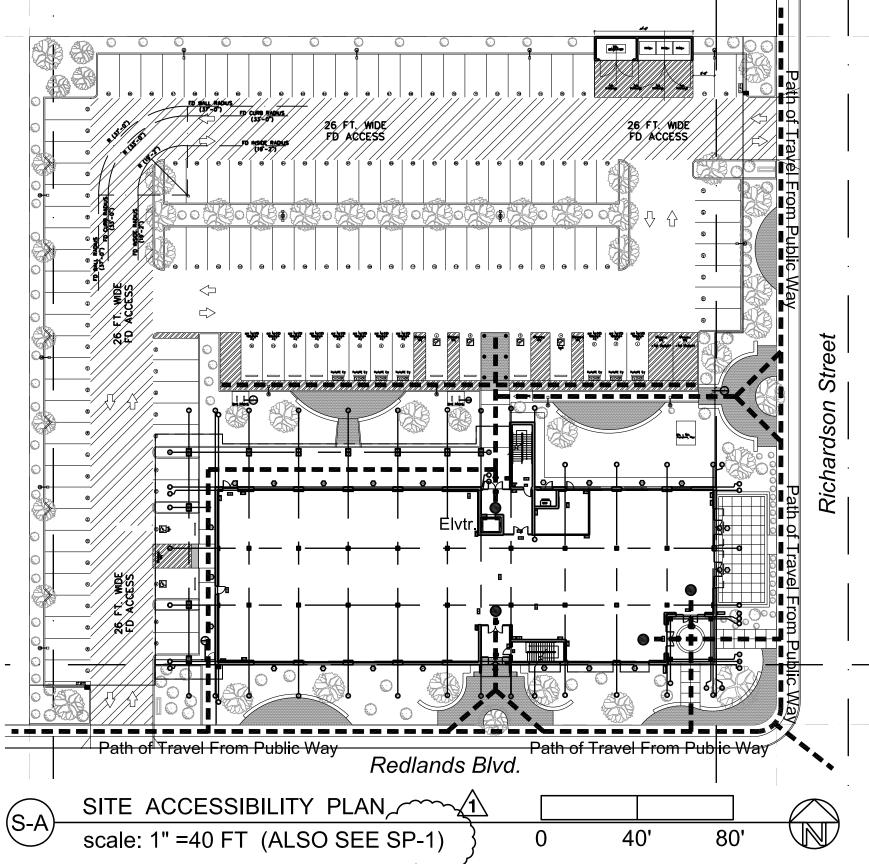

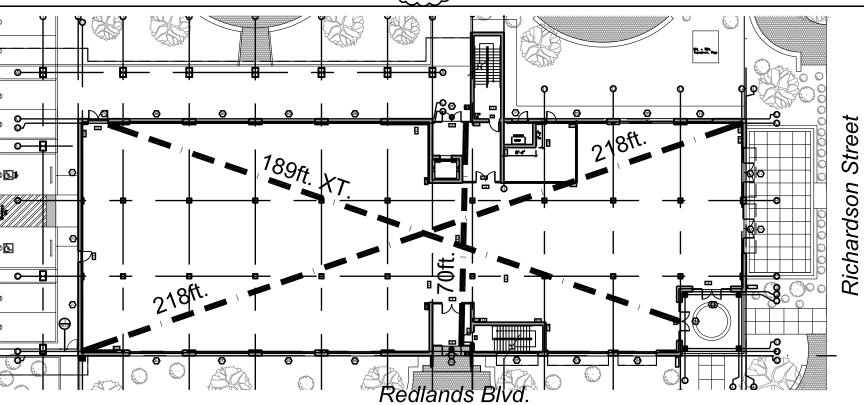


Diagonal Interior Dimension = 218 ft. $\frac{1}{3}$ Diagonal Distance = 72.66 ft. Required | Exit Separation Provided = 189 ft. | Exit Separation Complies

FIRST FLOOR EXITING PLAN

scale: 1" = 30 FT

0
30'
60'

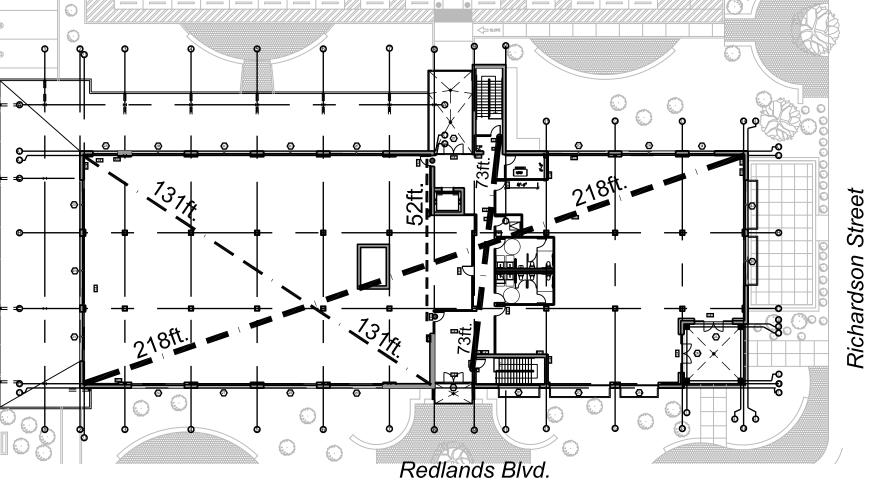

Overall Diagonal Interior Dimension = 218 ft.

\[\frac{1}{3} \]

Diagonal Distance = 72.66 ft. Required | Exit Stair Separation Provided = 73 ft. | Stair Separation Complies |

Diagonal Interior Dimension of Larger Office = 131 ft. | \frac{1}{3} \]

Diagonal Distance = 43.66 ft. Required | Exit Door Separation Provided = 52 ft. | Exit Door Separation Complies |

2ND FLOOR EXITING PLAN

scale: 1" = 30 FT

0

30'
60'

VARGA ASSOCIATES

ARCHITECTS / CONSULTANTS

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Landscape Architect

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Structural Engineer
CM Peck

Civil Engineer
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Mechanical/Plumbing Engineer

Pocock Design

Mechanical/Plumbing Engineer
Salas Obrien

Project

Cal Eye Loma Linda

25258 Redlands Blvd. Loma Linda, CA 92354

<u>Owner</u>

POZ, LLC 1900 W. Garvey Ave. Unit 335 West Covina , CA 91790 p. 626.305.9100

PROJECT TEAM AV
ISSUE DATES

DATE DESCRIPTION NO.
05-01-20 Construction Docs
07-21-20 PC Submittal
09-12-20 PC Corrections 1

DRAWN BY: AV

DATE: 04-01-20

SCALE: as shown


JOB NO. (
SHEET TITLE

Code Analysis
Access &
Exiting

STATUS: CONSTRUCTION DOCS

SHEET NO.

A-0.0

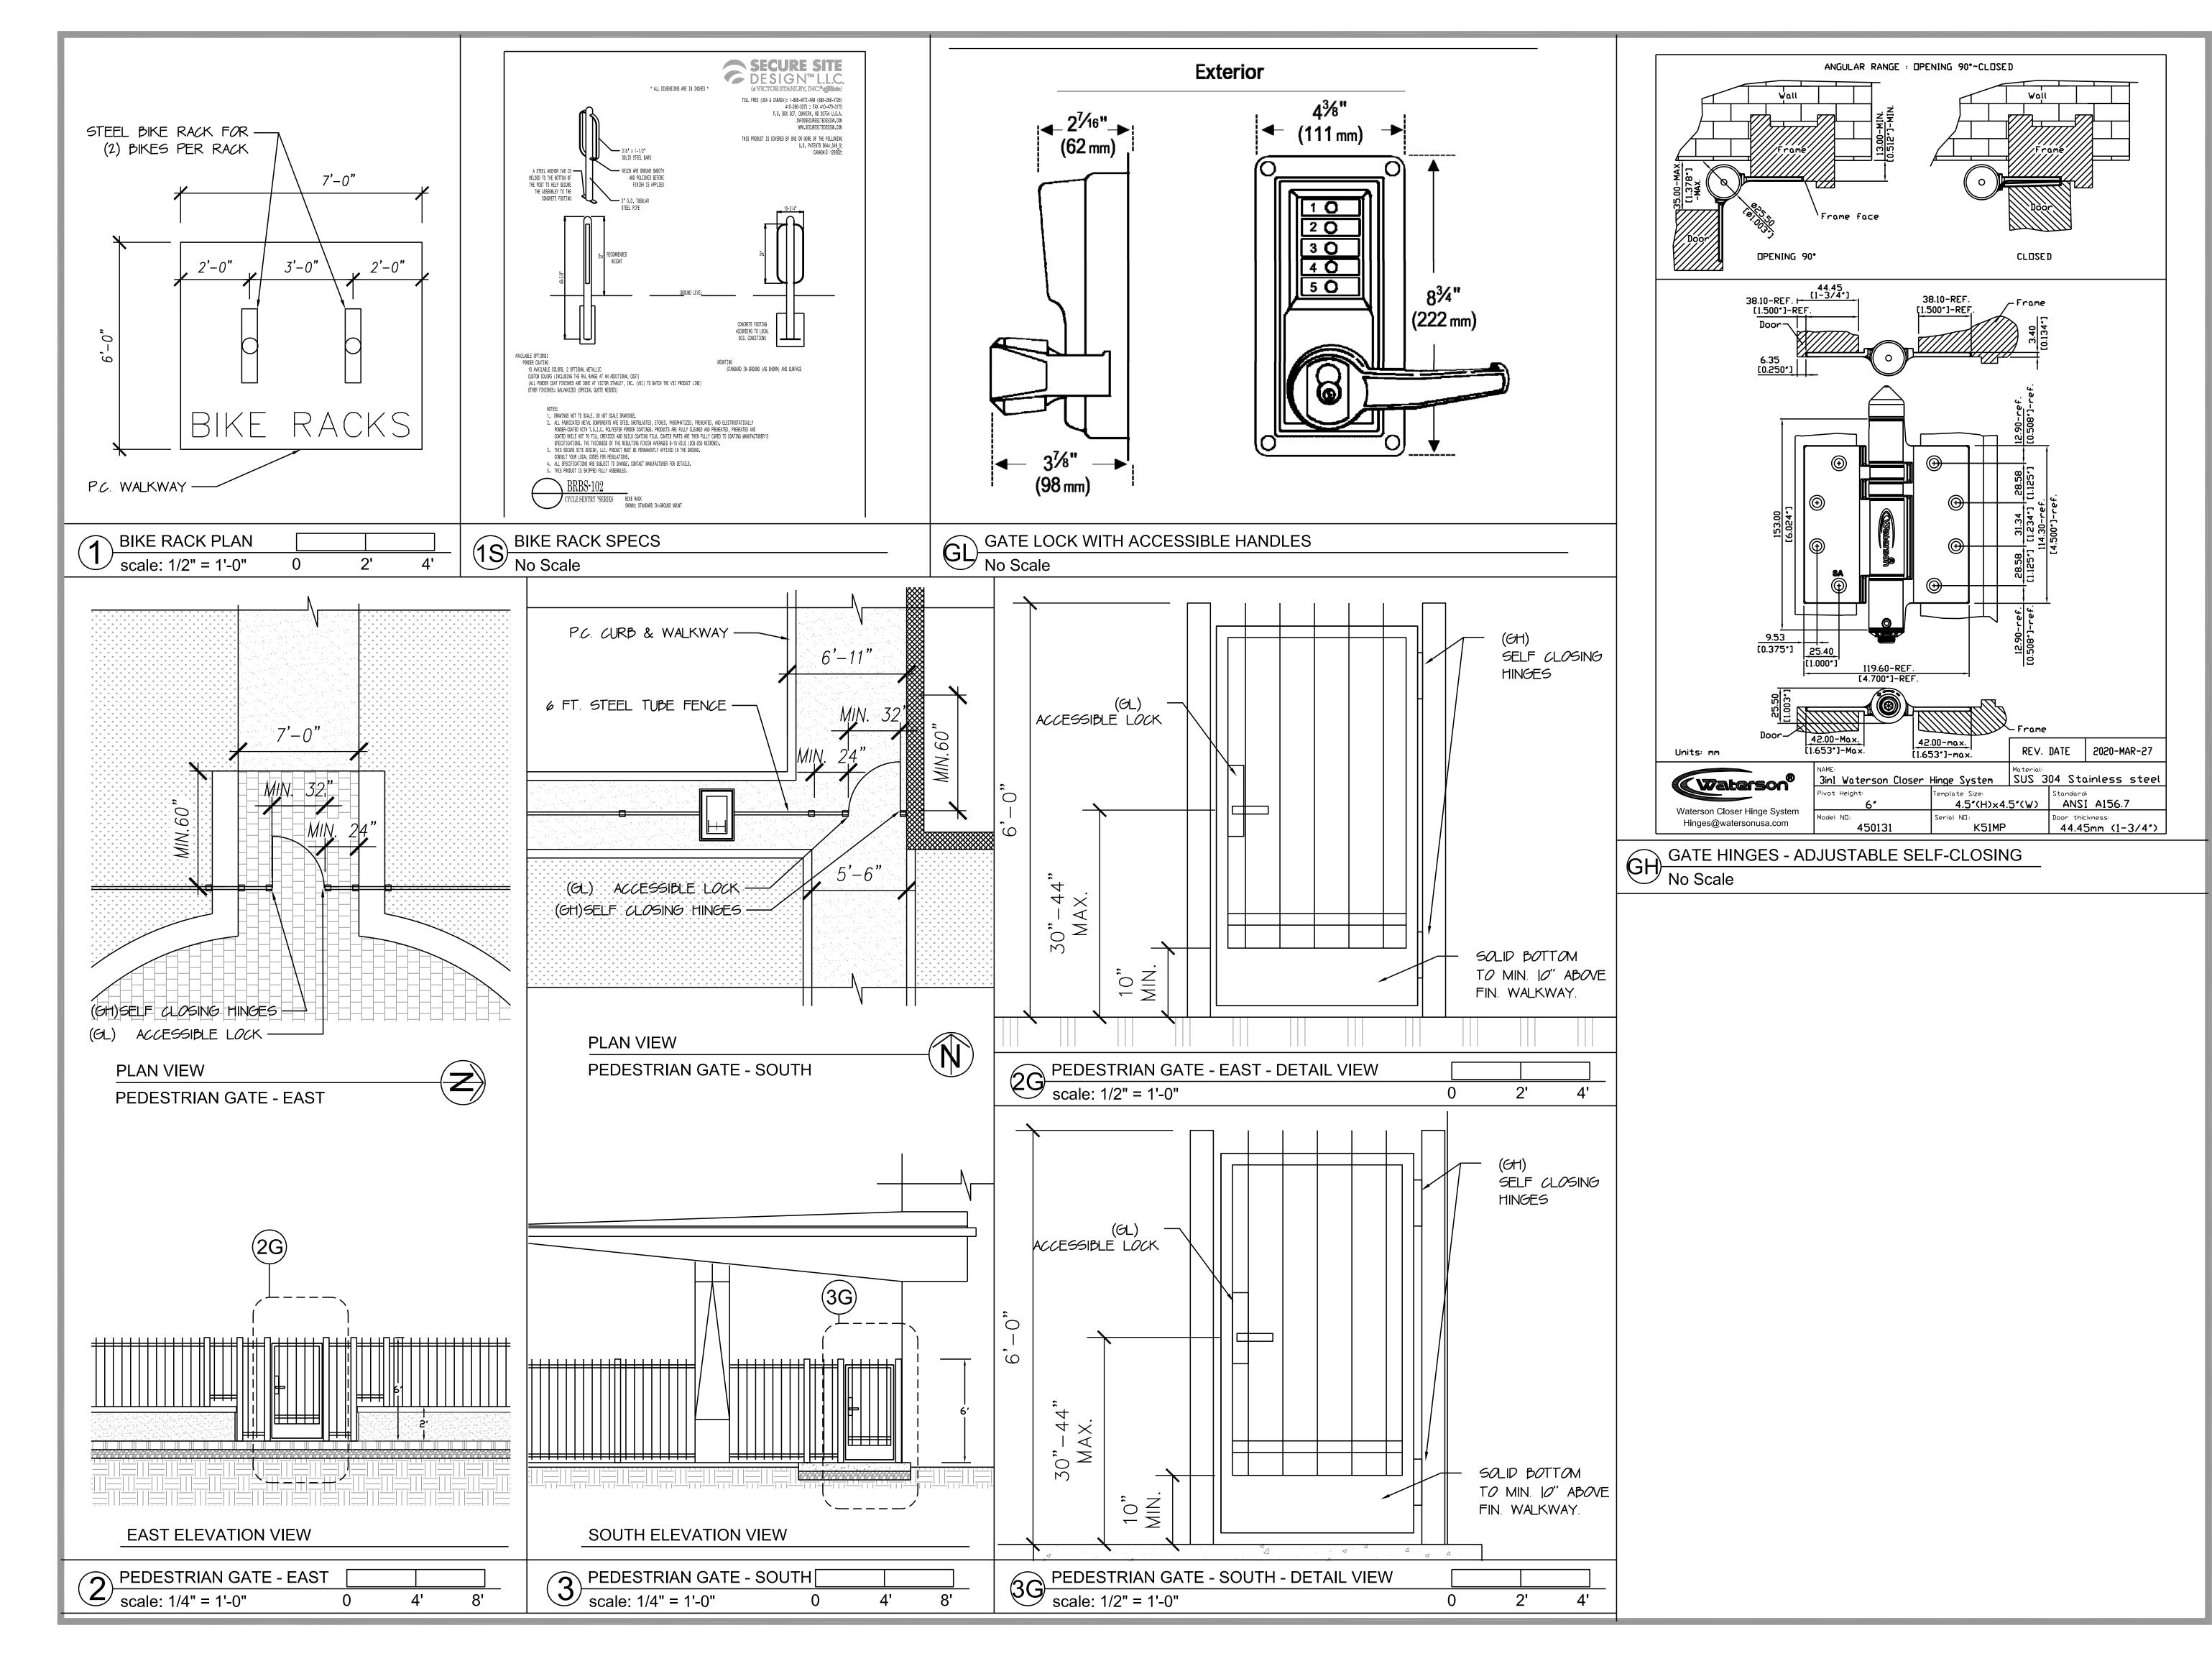

ARCHITECTS / CONSULTANTS

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Civil Engineer

Mechanical/Plumbing Engineer

Encompass Associates, Inc.

Mechanical/Plumbing Engineer
Salas Obrien

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SEAL

DRAWN BY: AV

SCALE: as shown

DATE: 04-01-20

B NO.


SHEET TITLE

SHEET NO.

Site Details

STATUS: CONSTRUCTION DOCS

A0.8

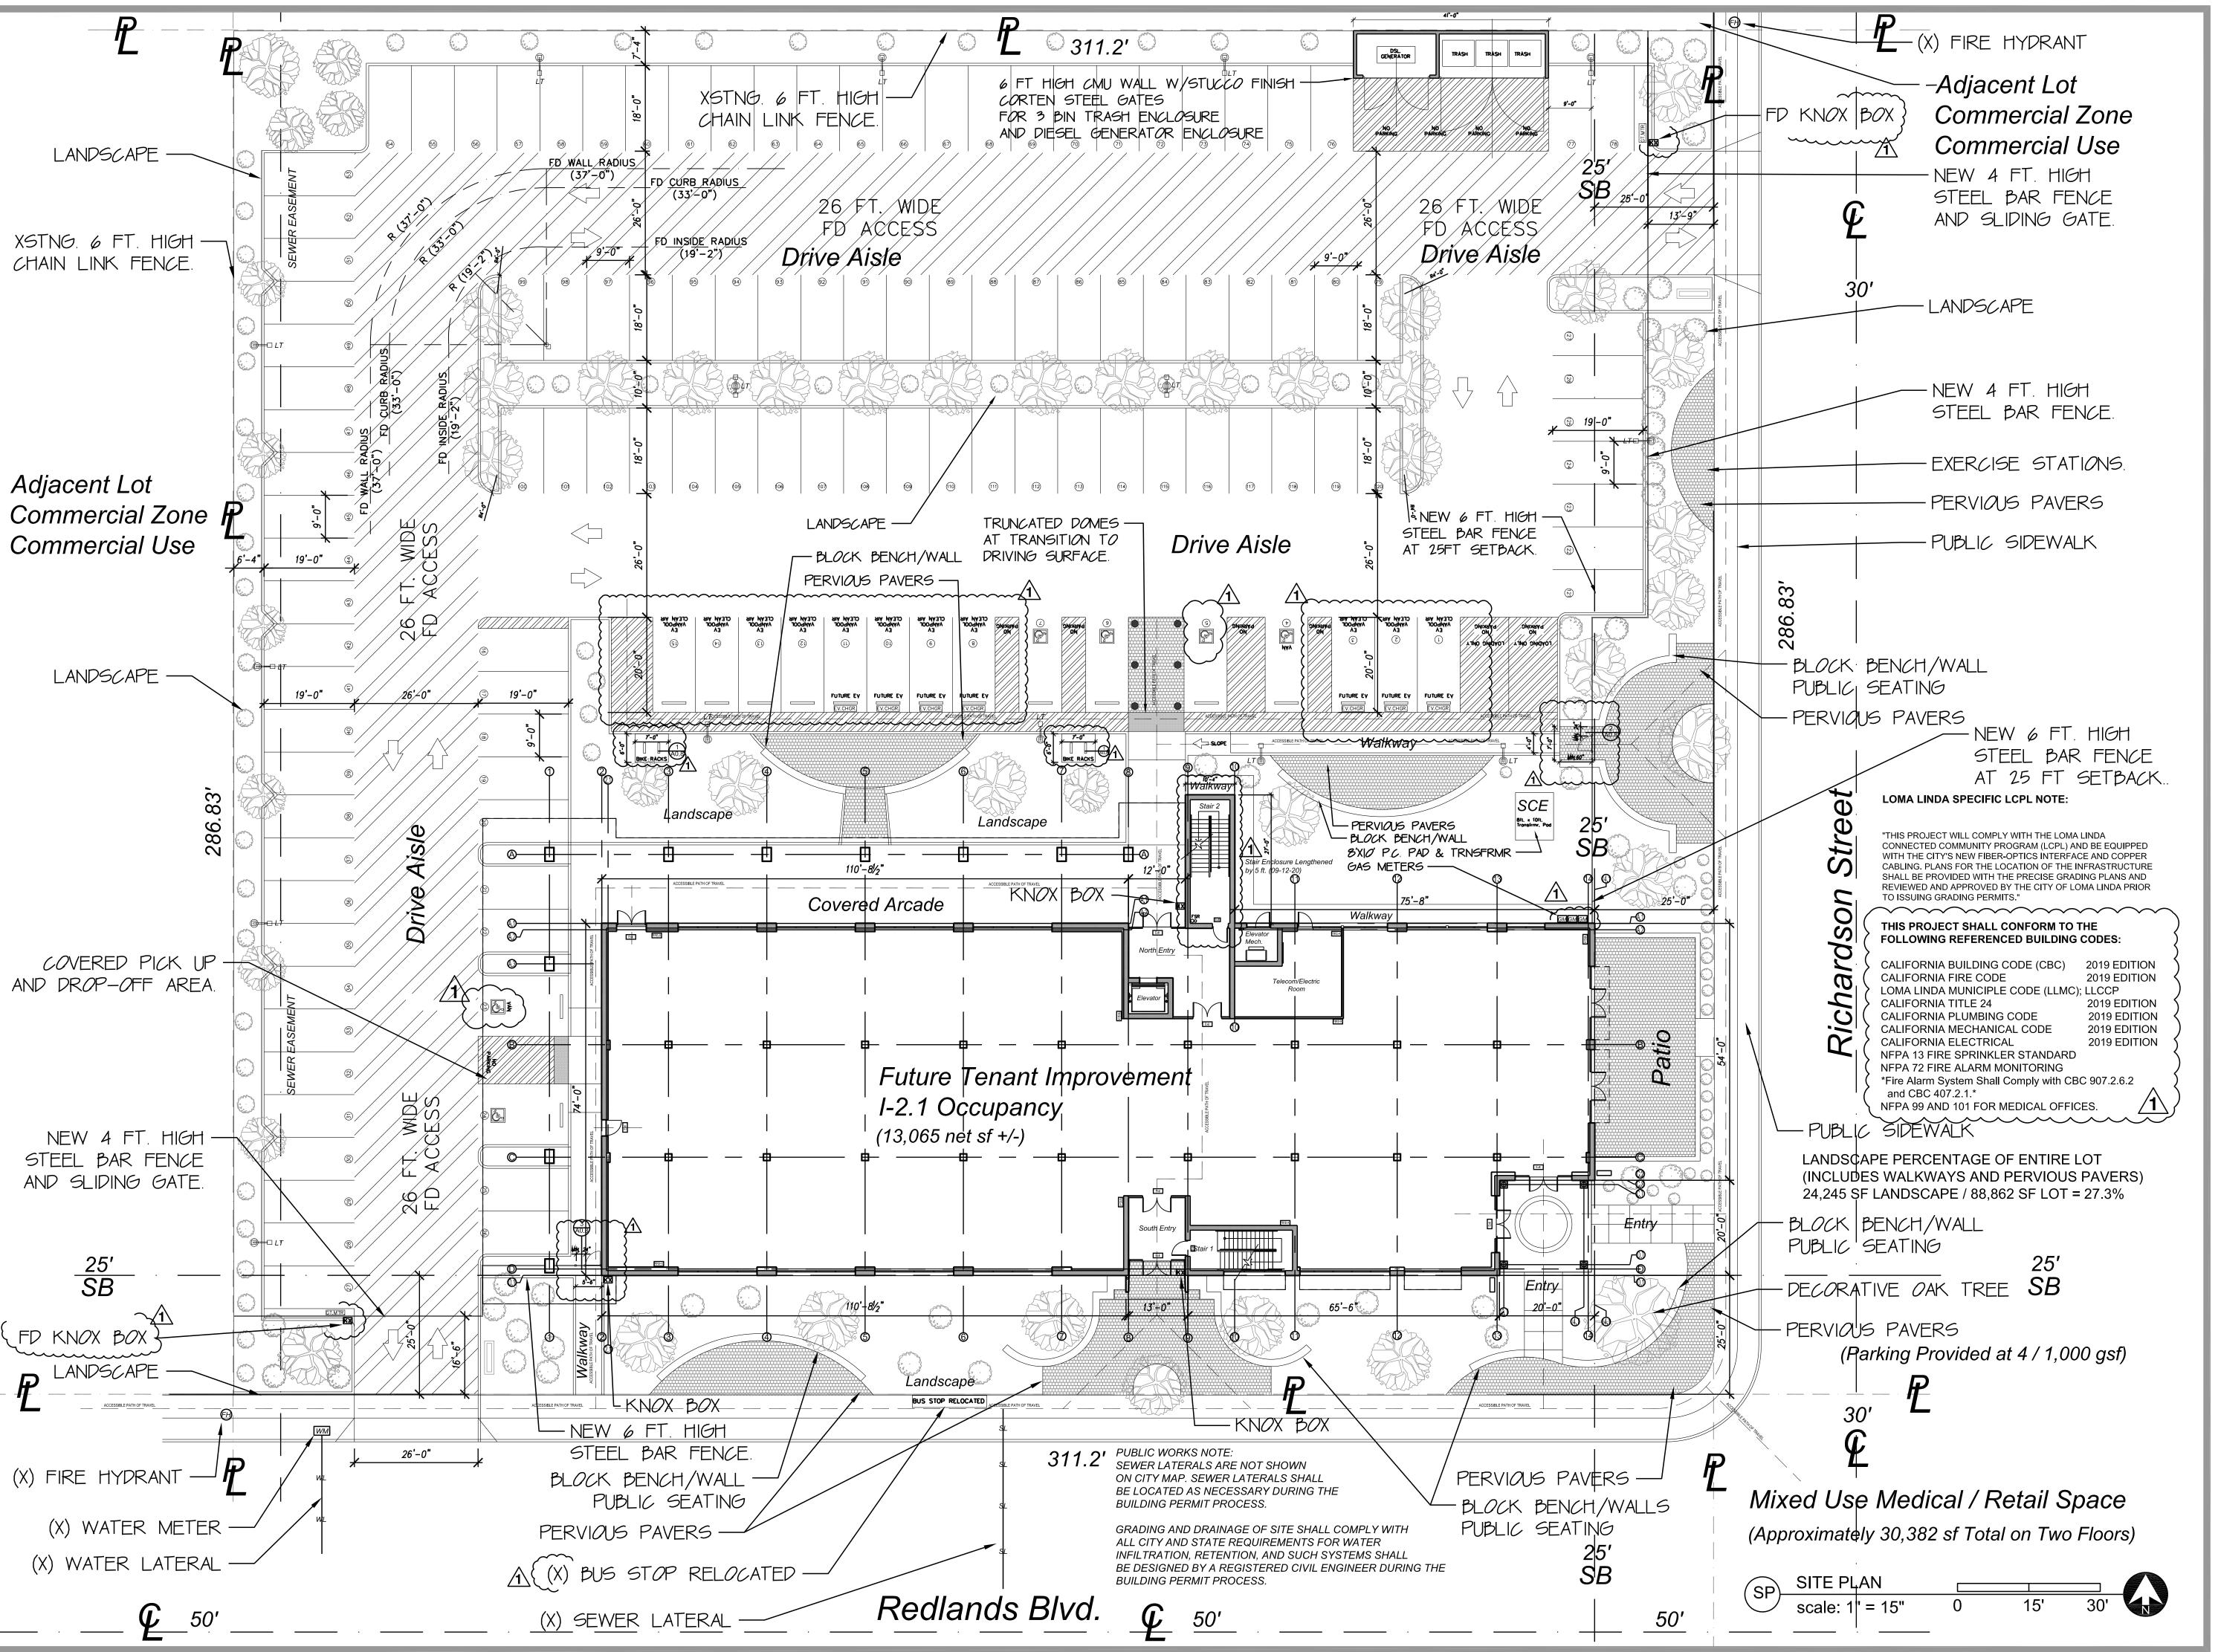

ARCHITECTS / CONSULTANTS

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Mechanical/Plumbing Engineer

<u>Project</u>

Salas Obrien

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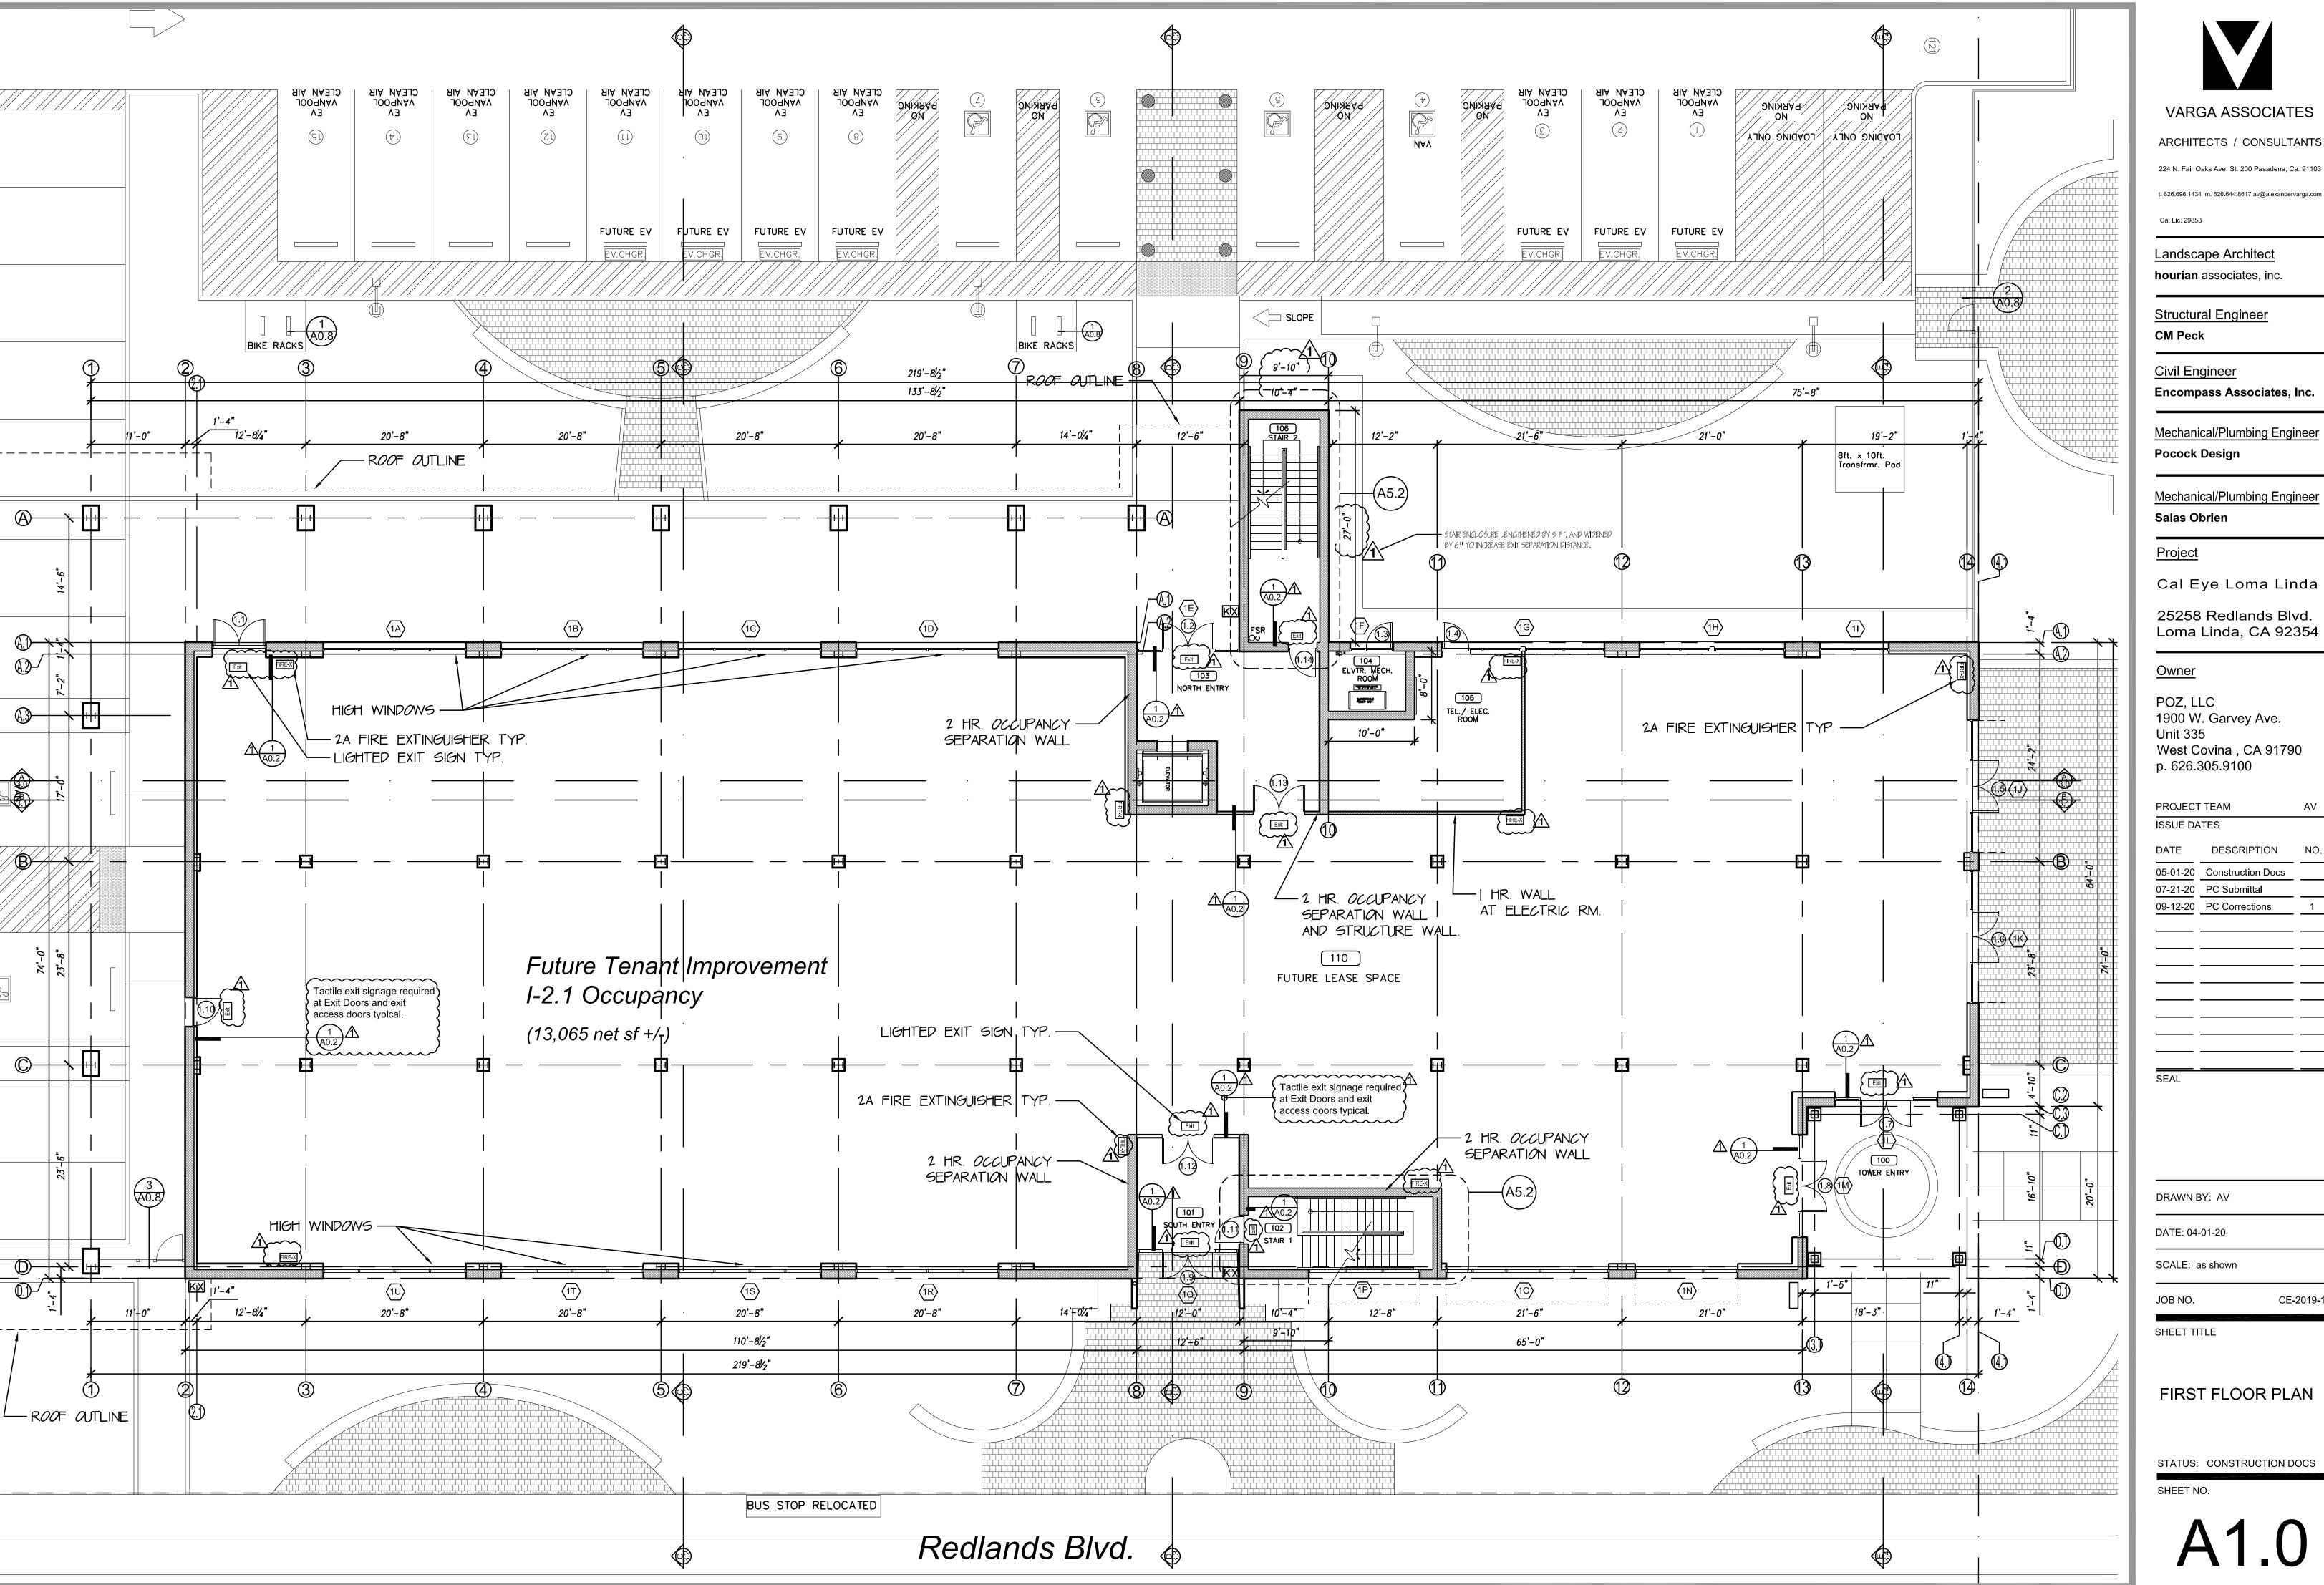
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DATE: 04-01-20

SITE PLAN

STATUS: CONSTRUCTION DOCS
SHEET NO.

SP-1



ARCHITECTS / CONSULTANTS

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Landscape Architect hourian associates, inc.

Structural Engineer

CM Peck

Civil Engineer Encompass Associates, Inc.

Mechanical/Plumbing Engineer **Pocock Design**

Mechanical/Plumbing Engineer Salas Obrien

<u>Project</u>

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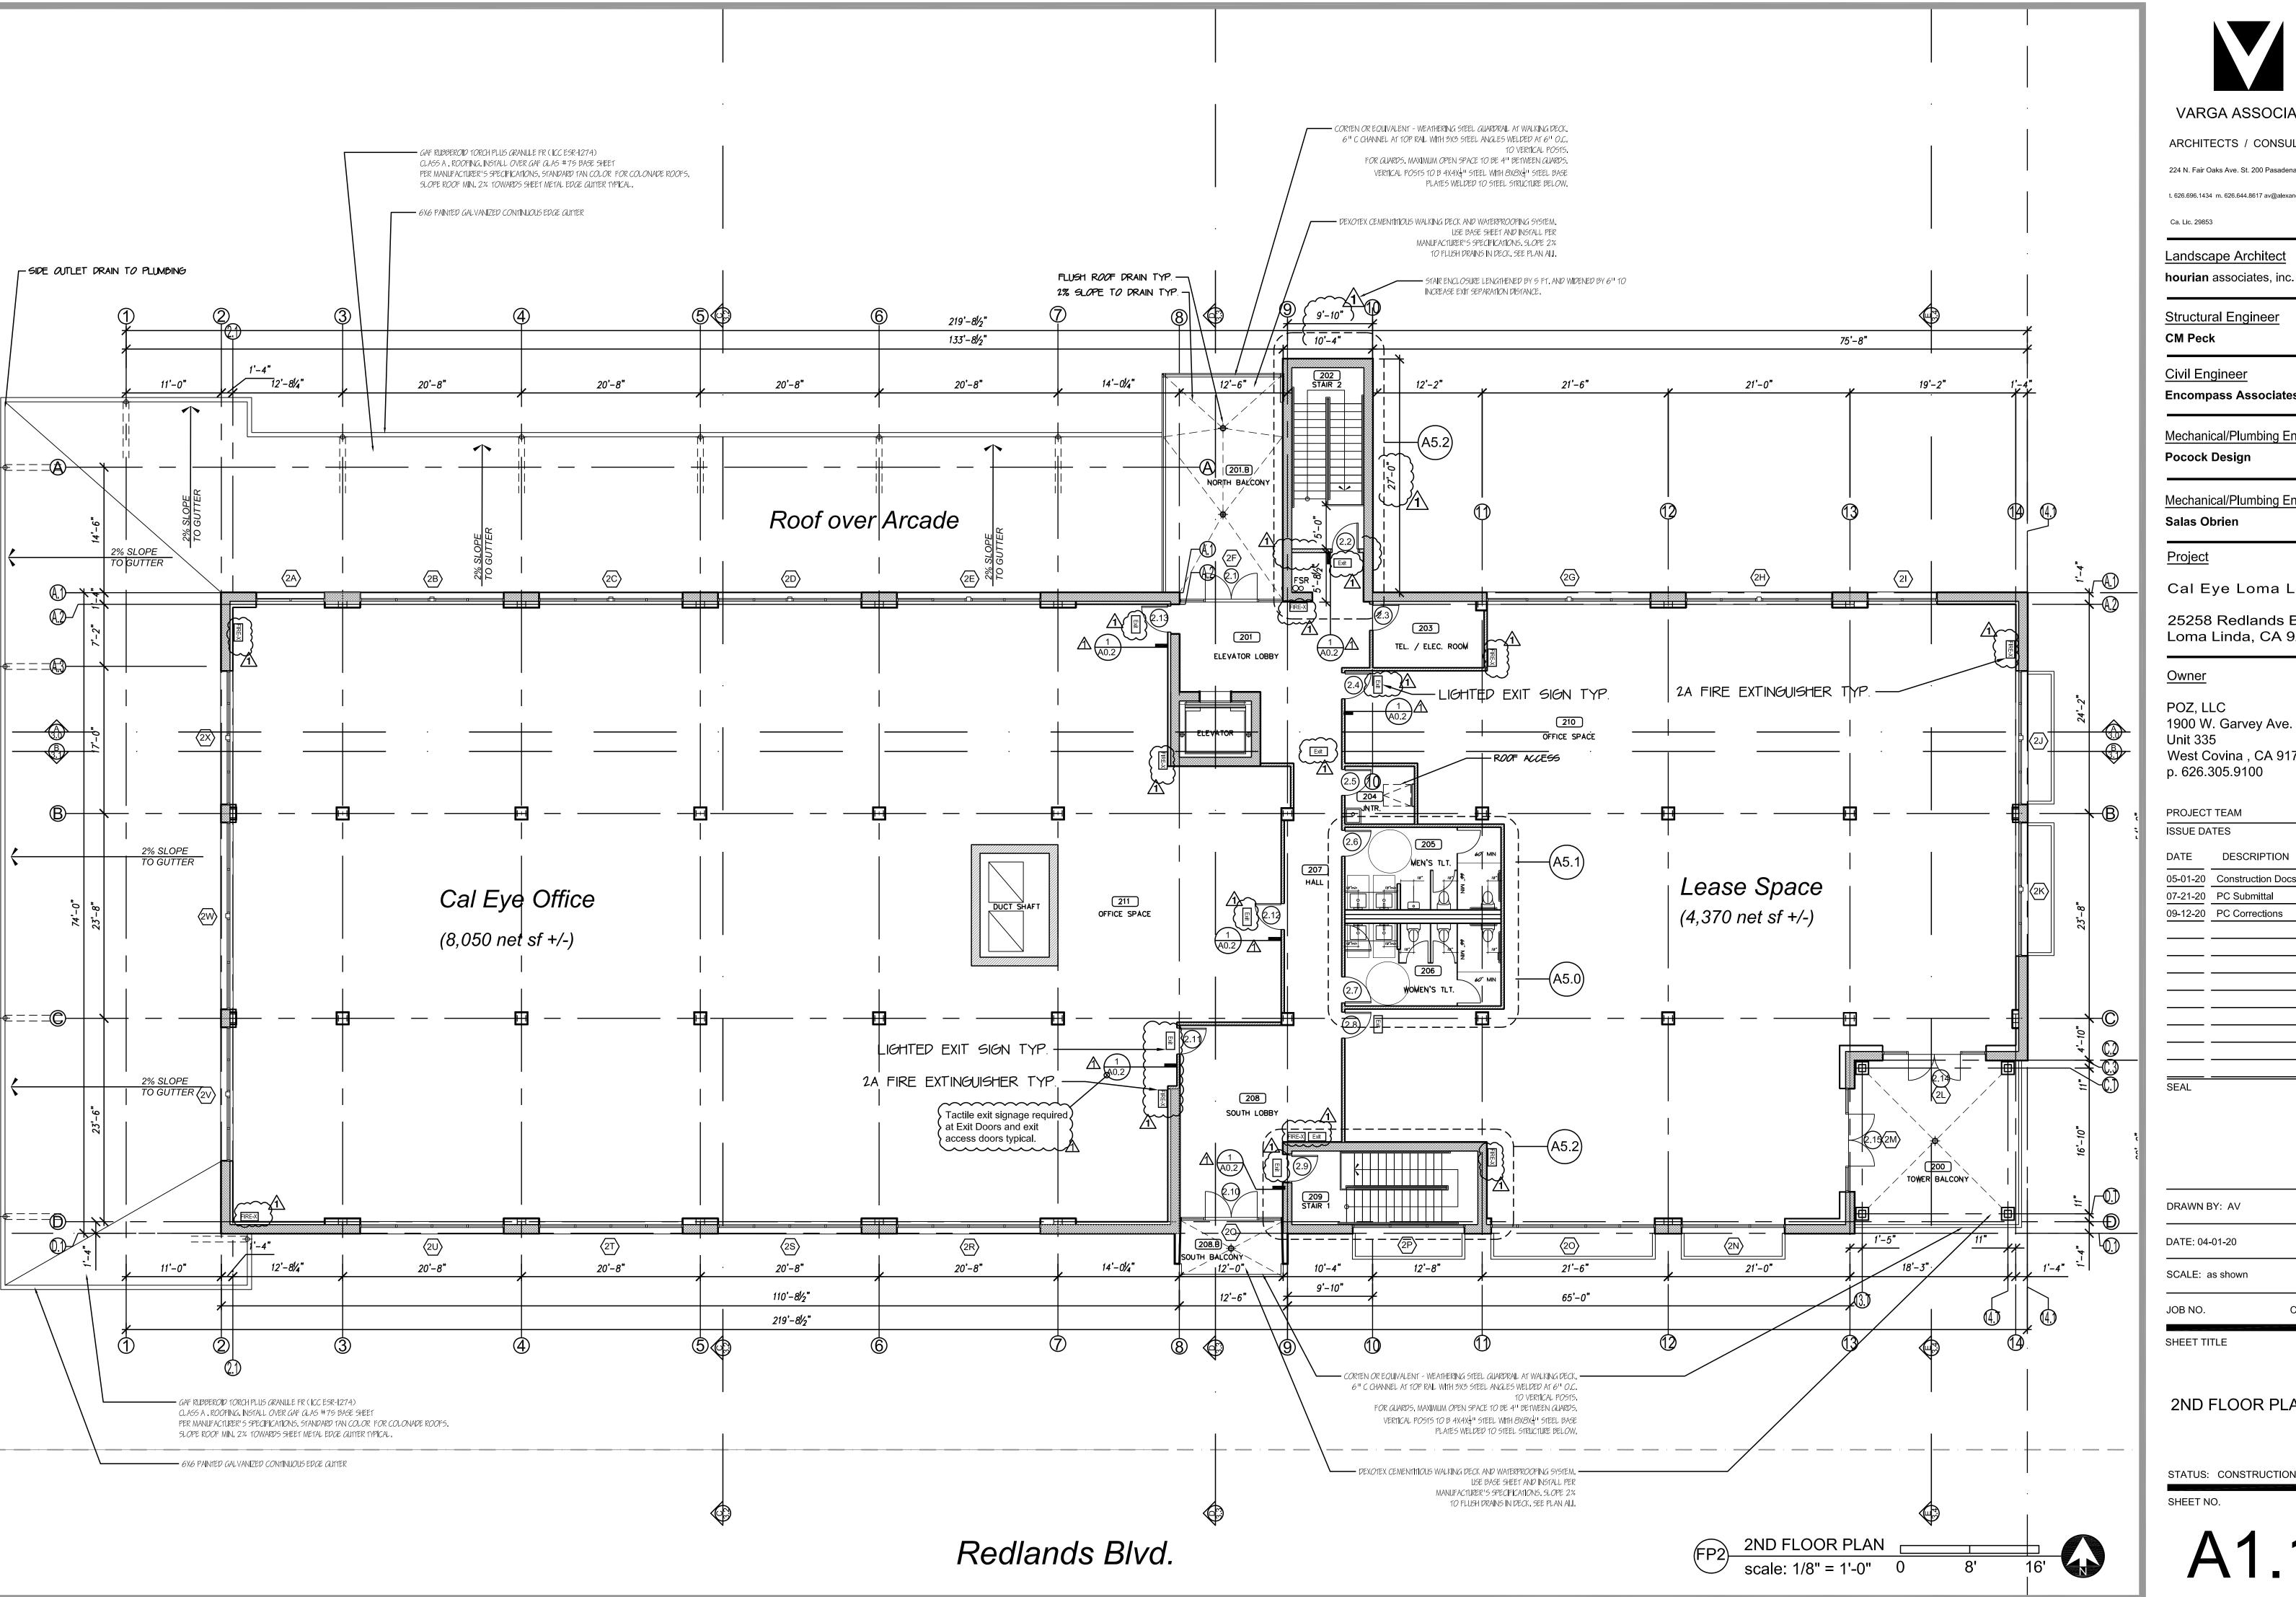
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SHEET TITLE

FIRST FLOOR PLAN

STATUS: CONSTRUCTION DOCS

SHEET NO.





ARCHITECTS / CONSULTANTS

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Mechanical/Plumbing Engineer

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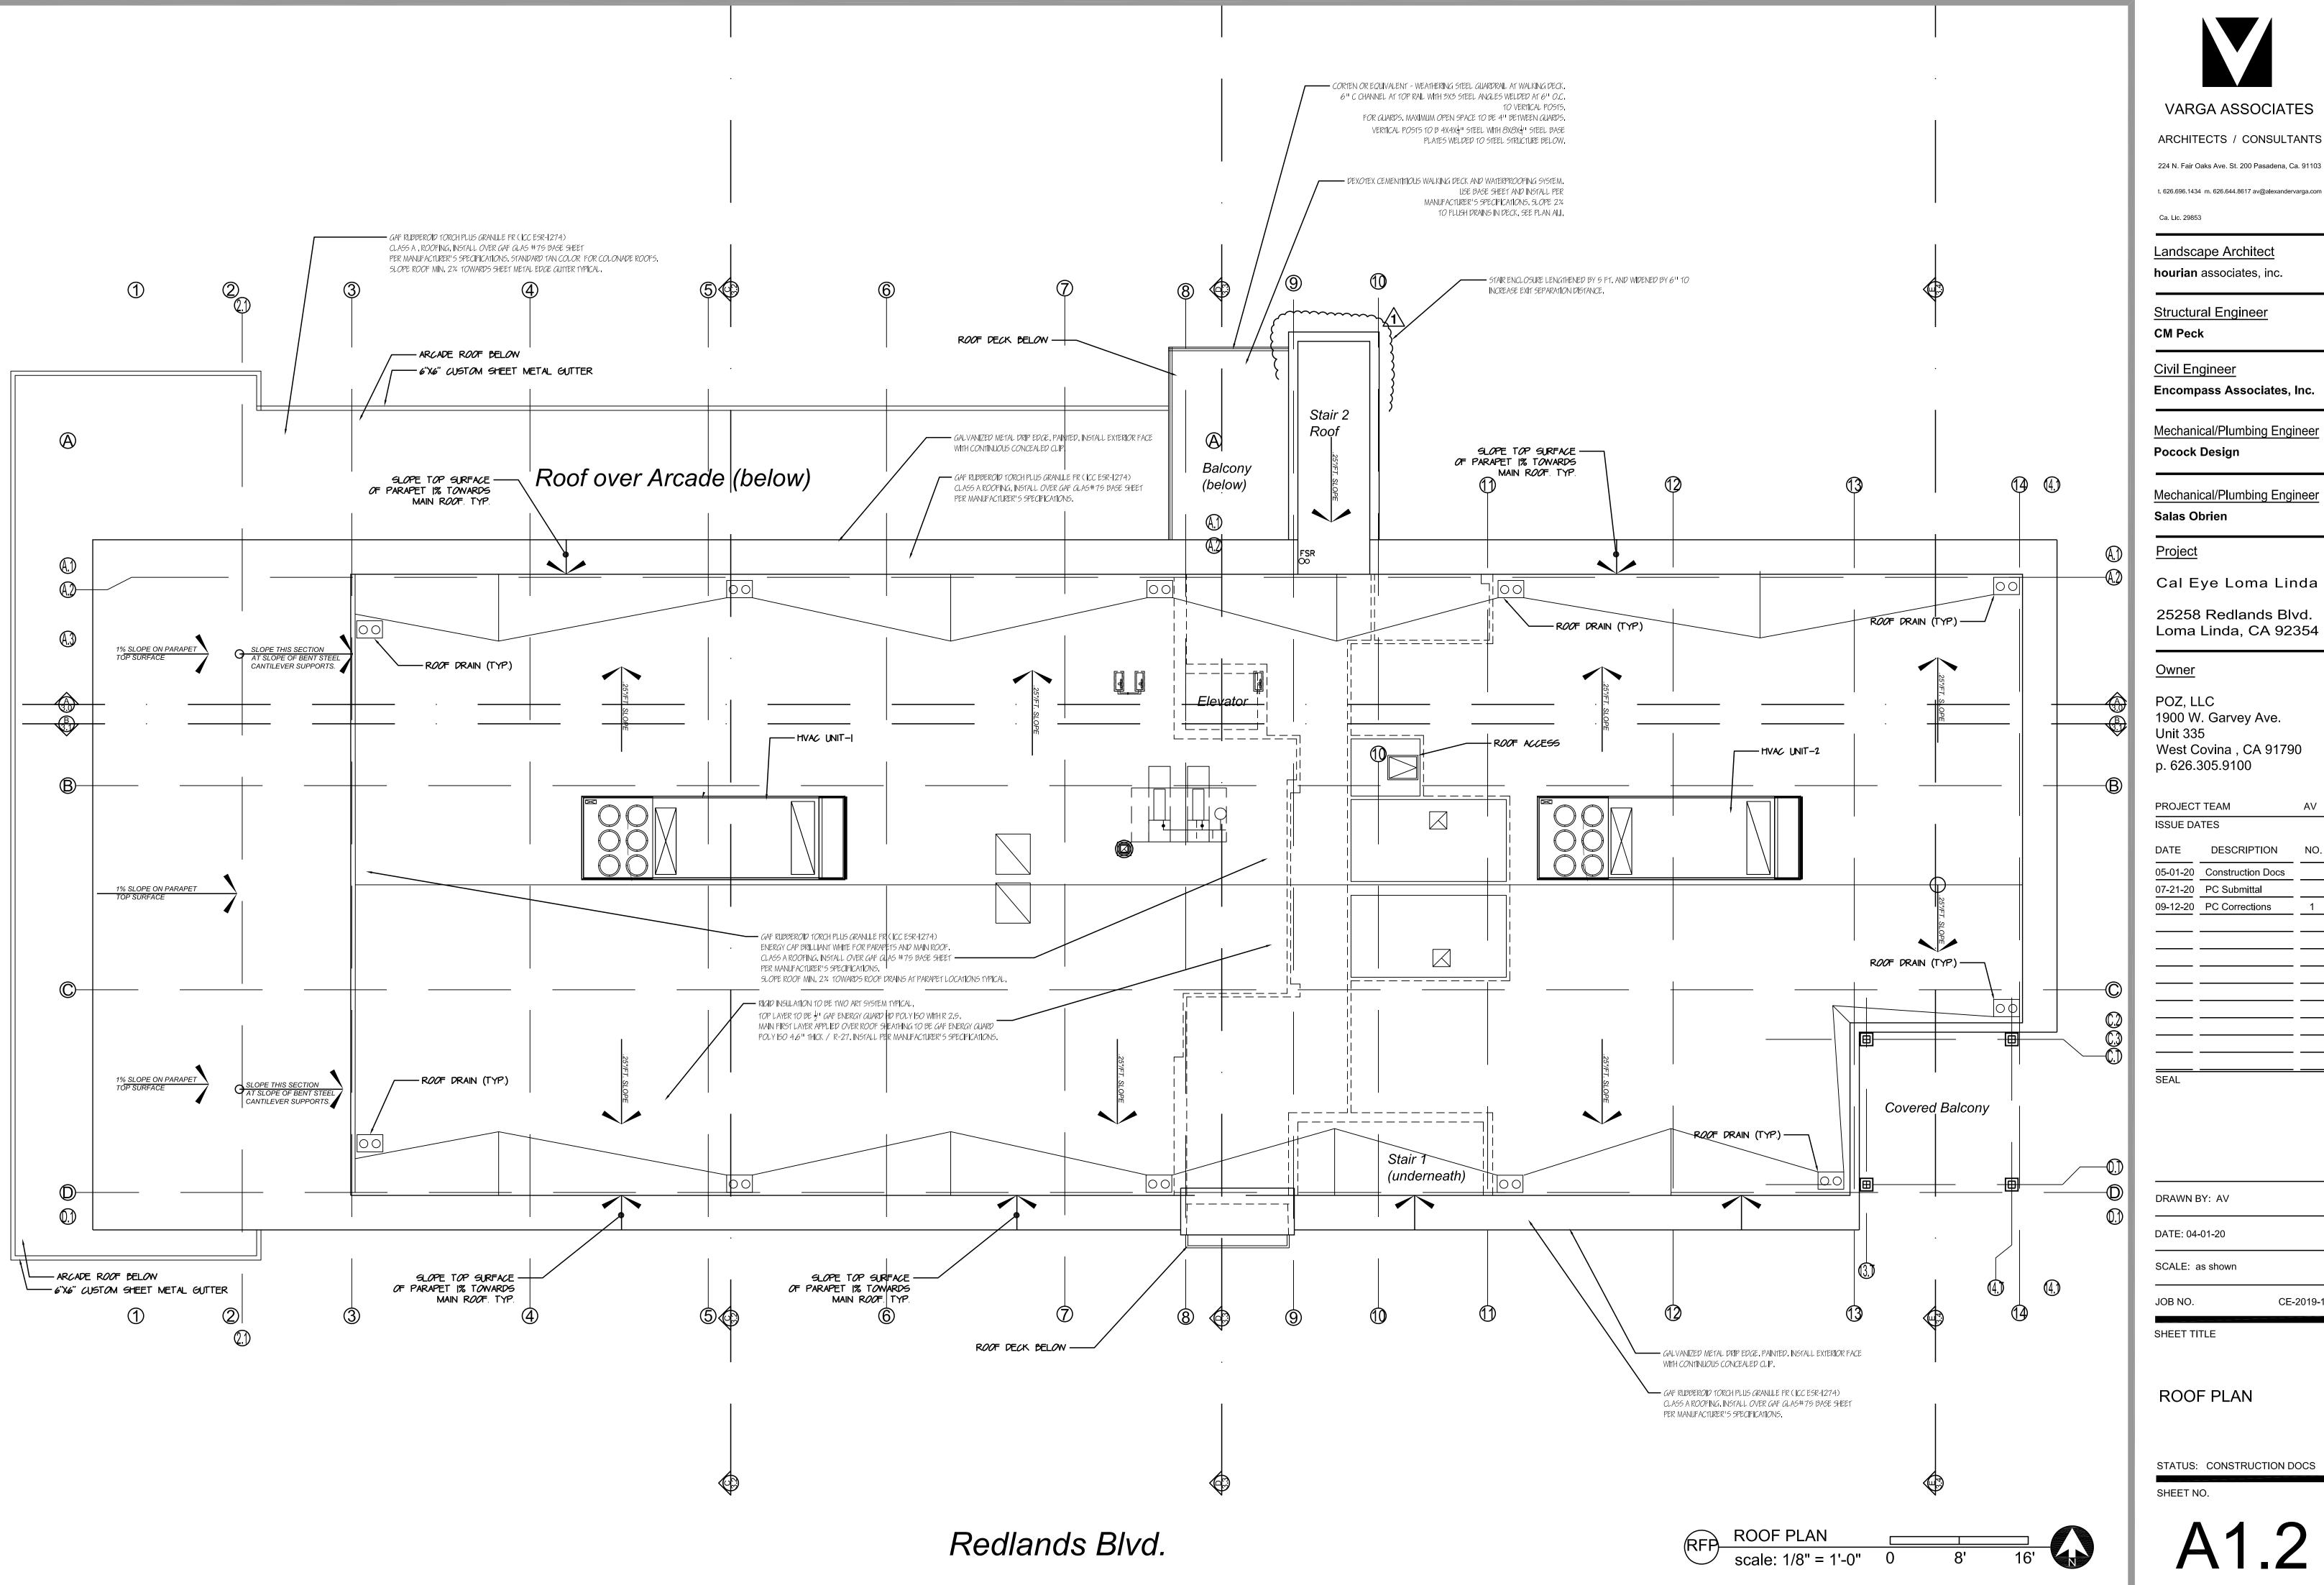
09-12-20 PC Corrections

DRAWN BY: AV

SCALE: as shown

SHEET TITLE

2ND FLOOR PLAN



ARCHITECTS / CONSULTANTS

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Landscape Architect

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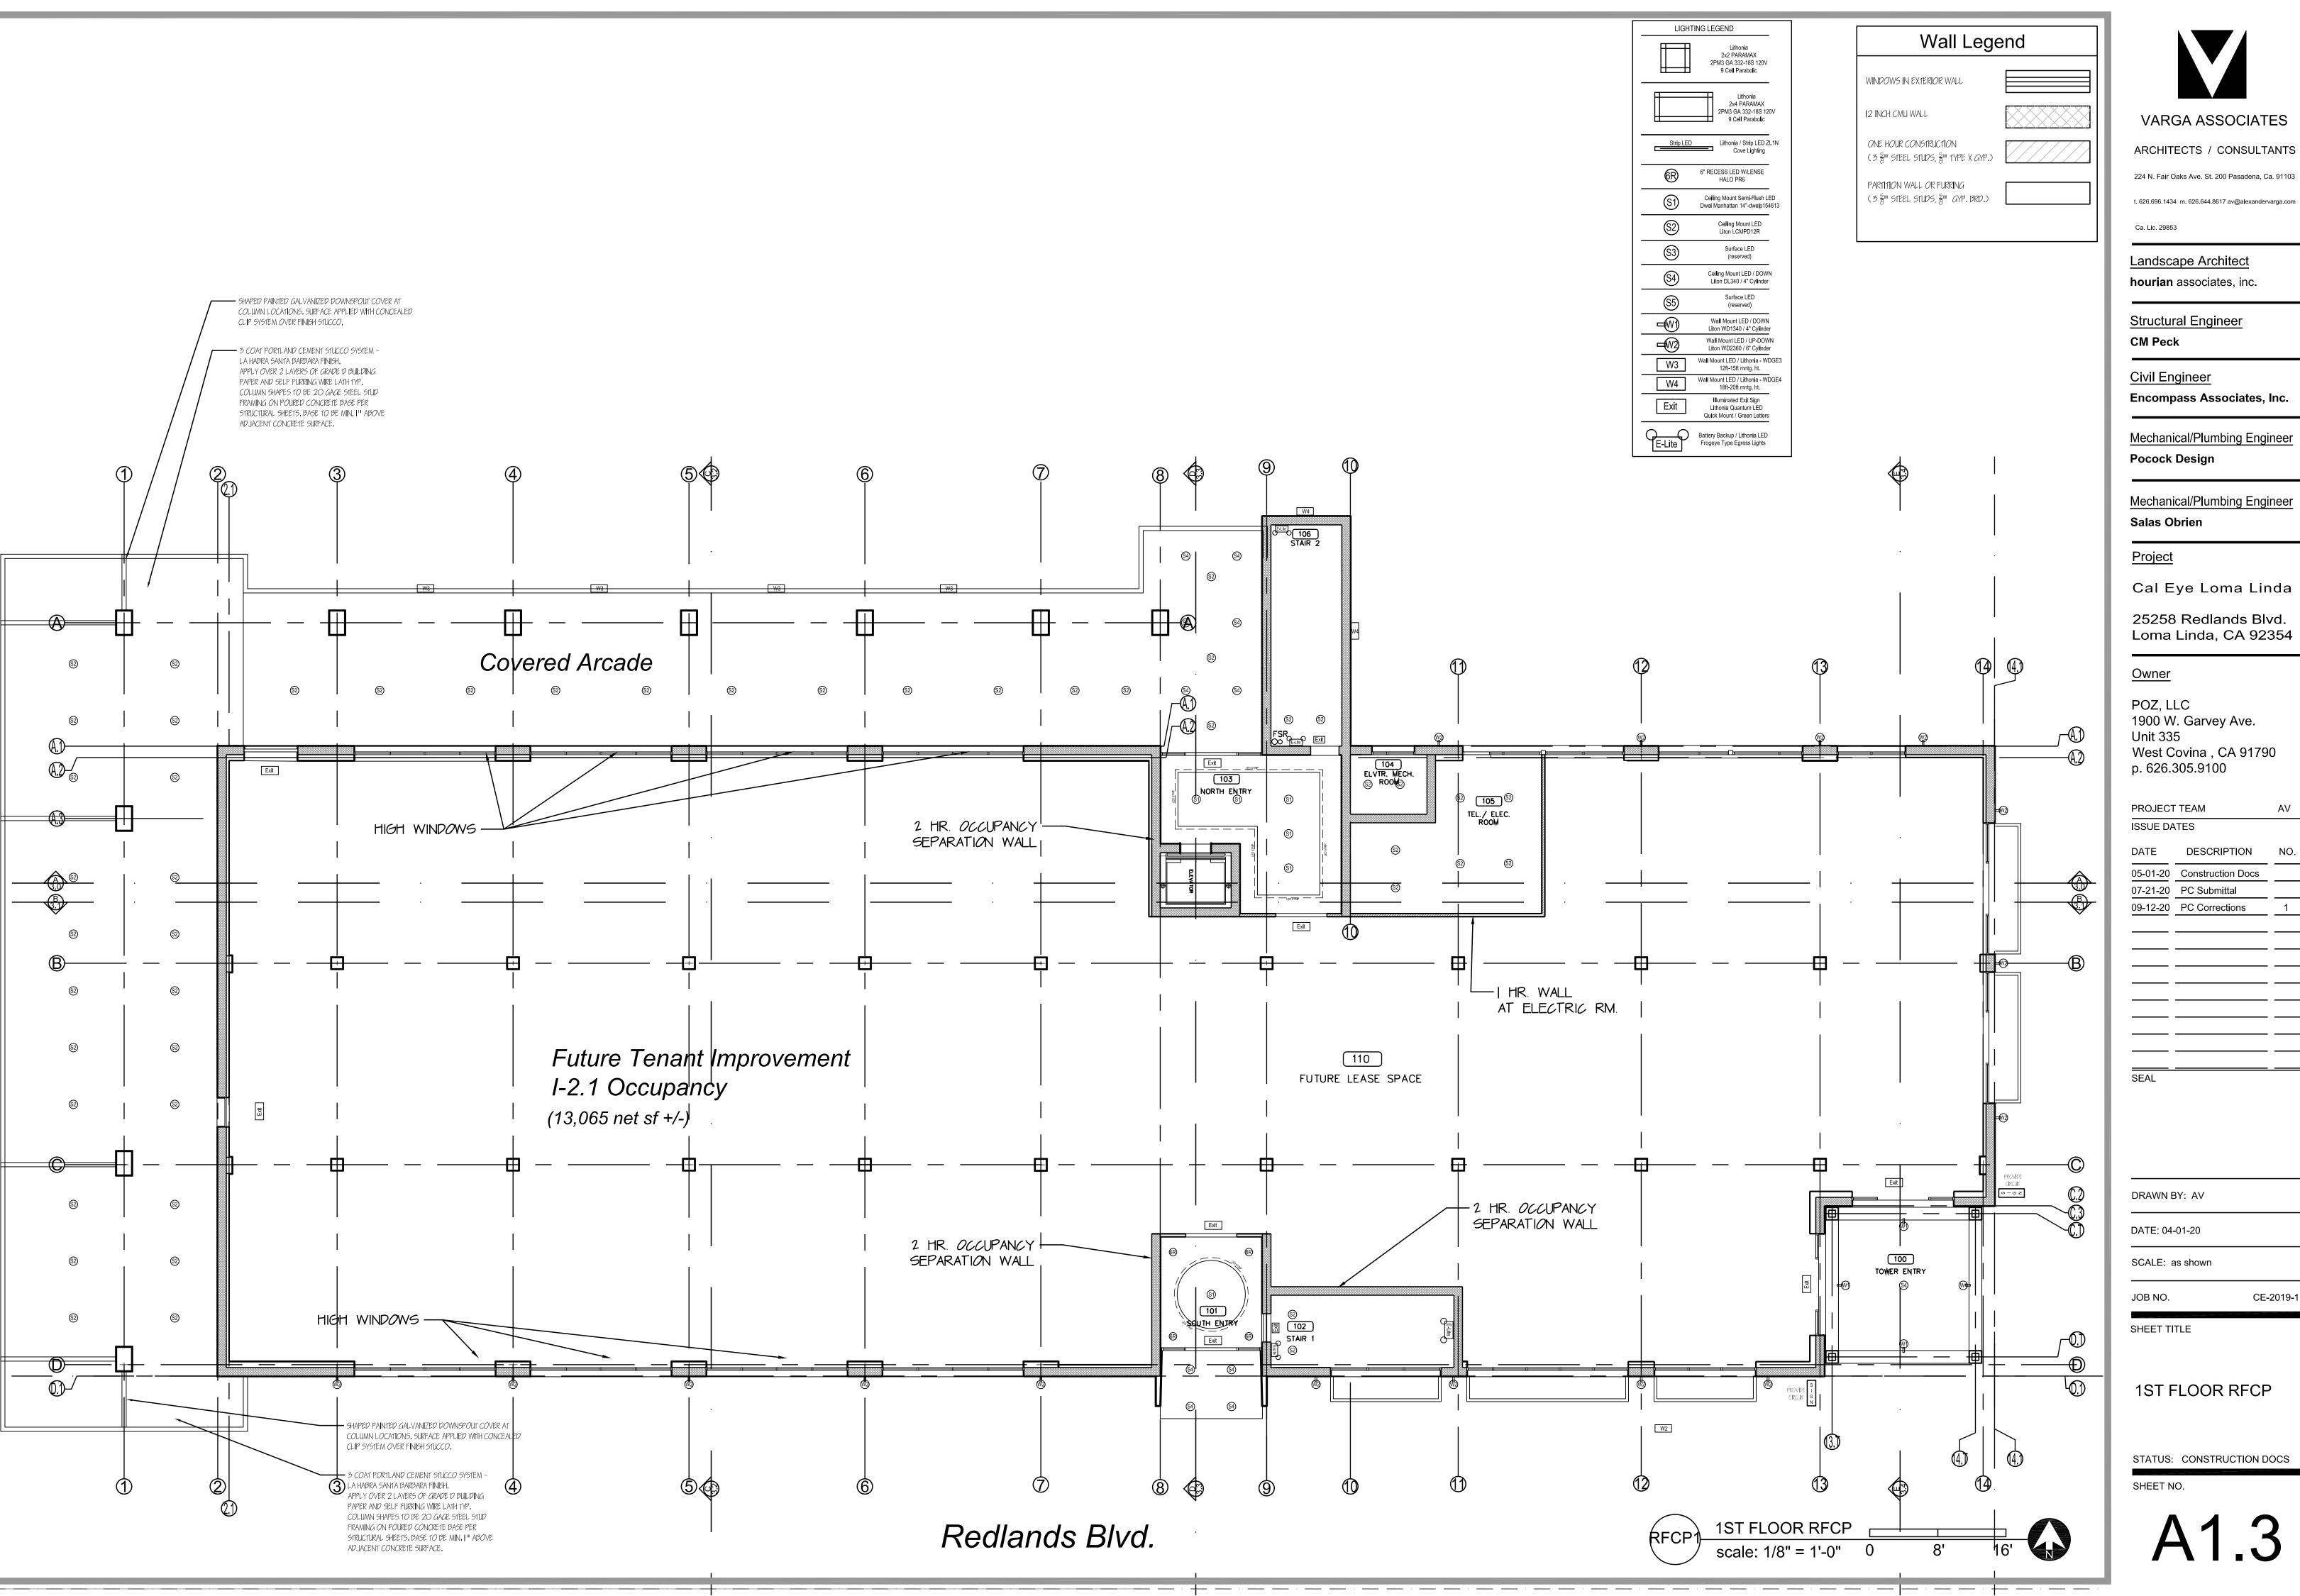
CE-2019-1

SHEET TITLE

ROOF PLAN

STATUS: CONSTRUCTION DOCS

SHEET NO.




ARCHITECTS / CONSULTANTS

Cal Eye Loma Linda

Loma Linda, CA 92354

1900 W. Garvey Ave. West Covina , CA 91790


ISSUE DATES				
DATE	DESCRIPTION	N		
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ARCHITECTS / CONSULTANTS

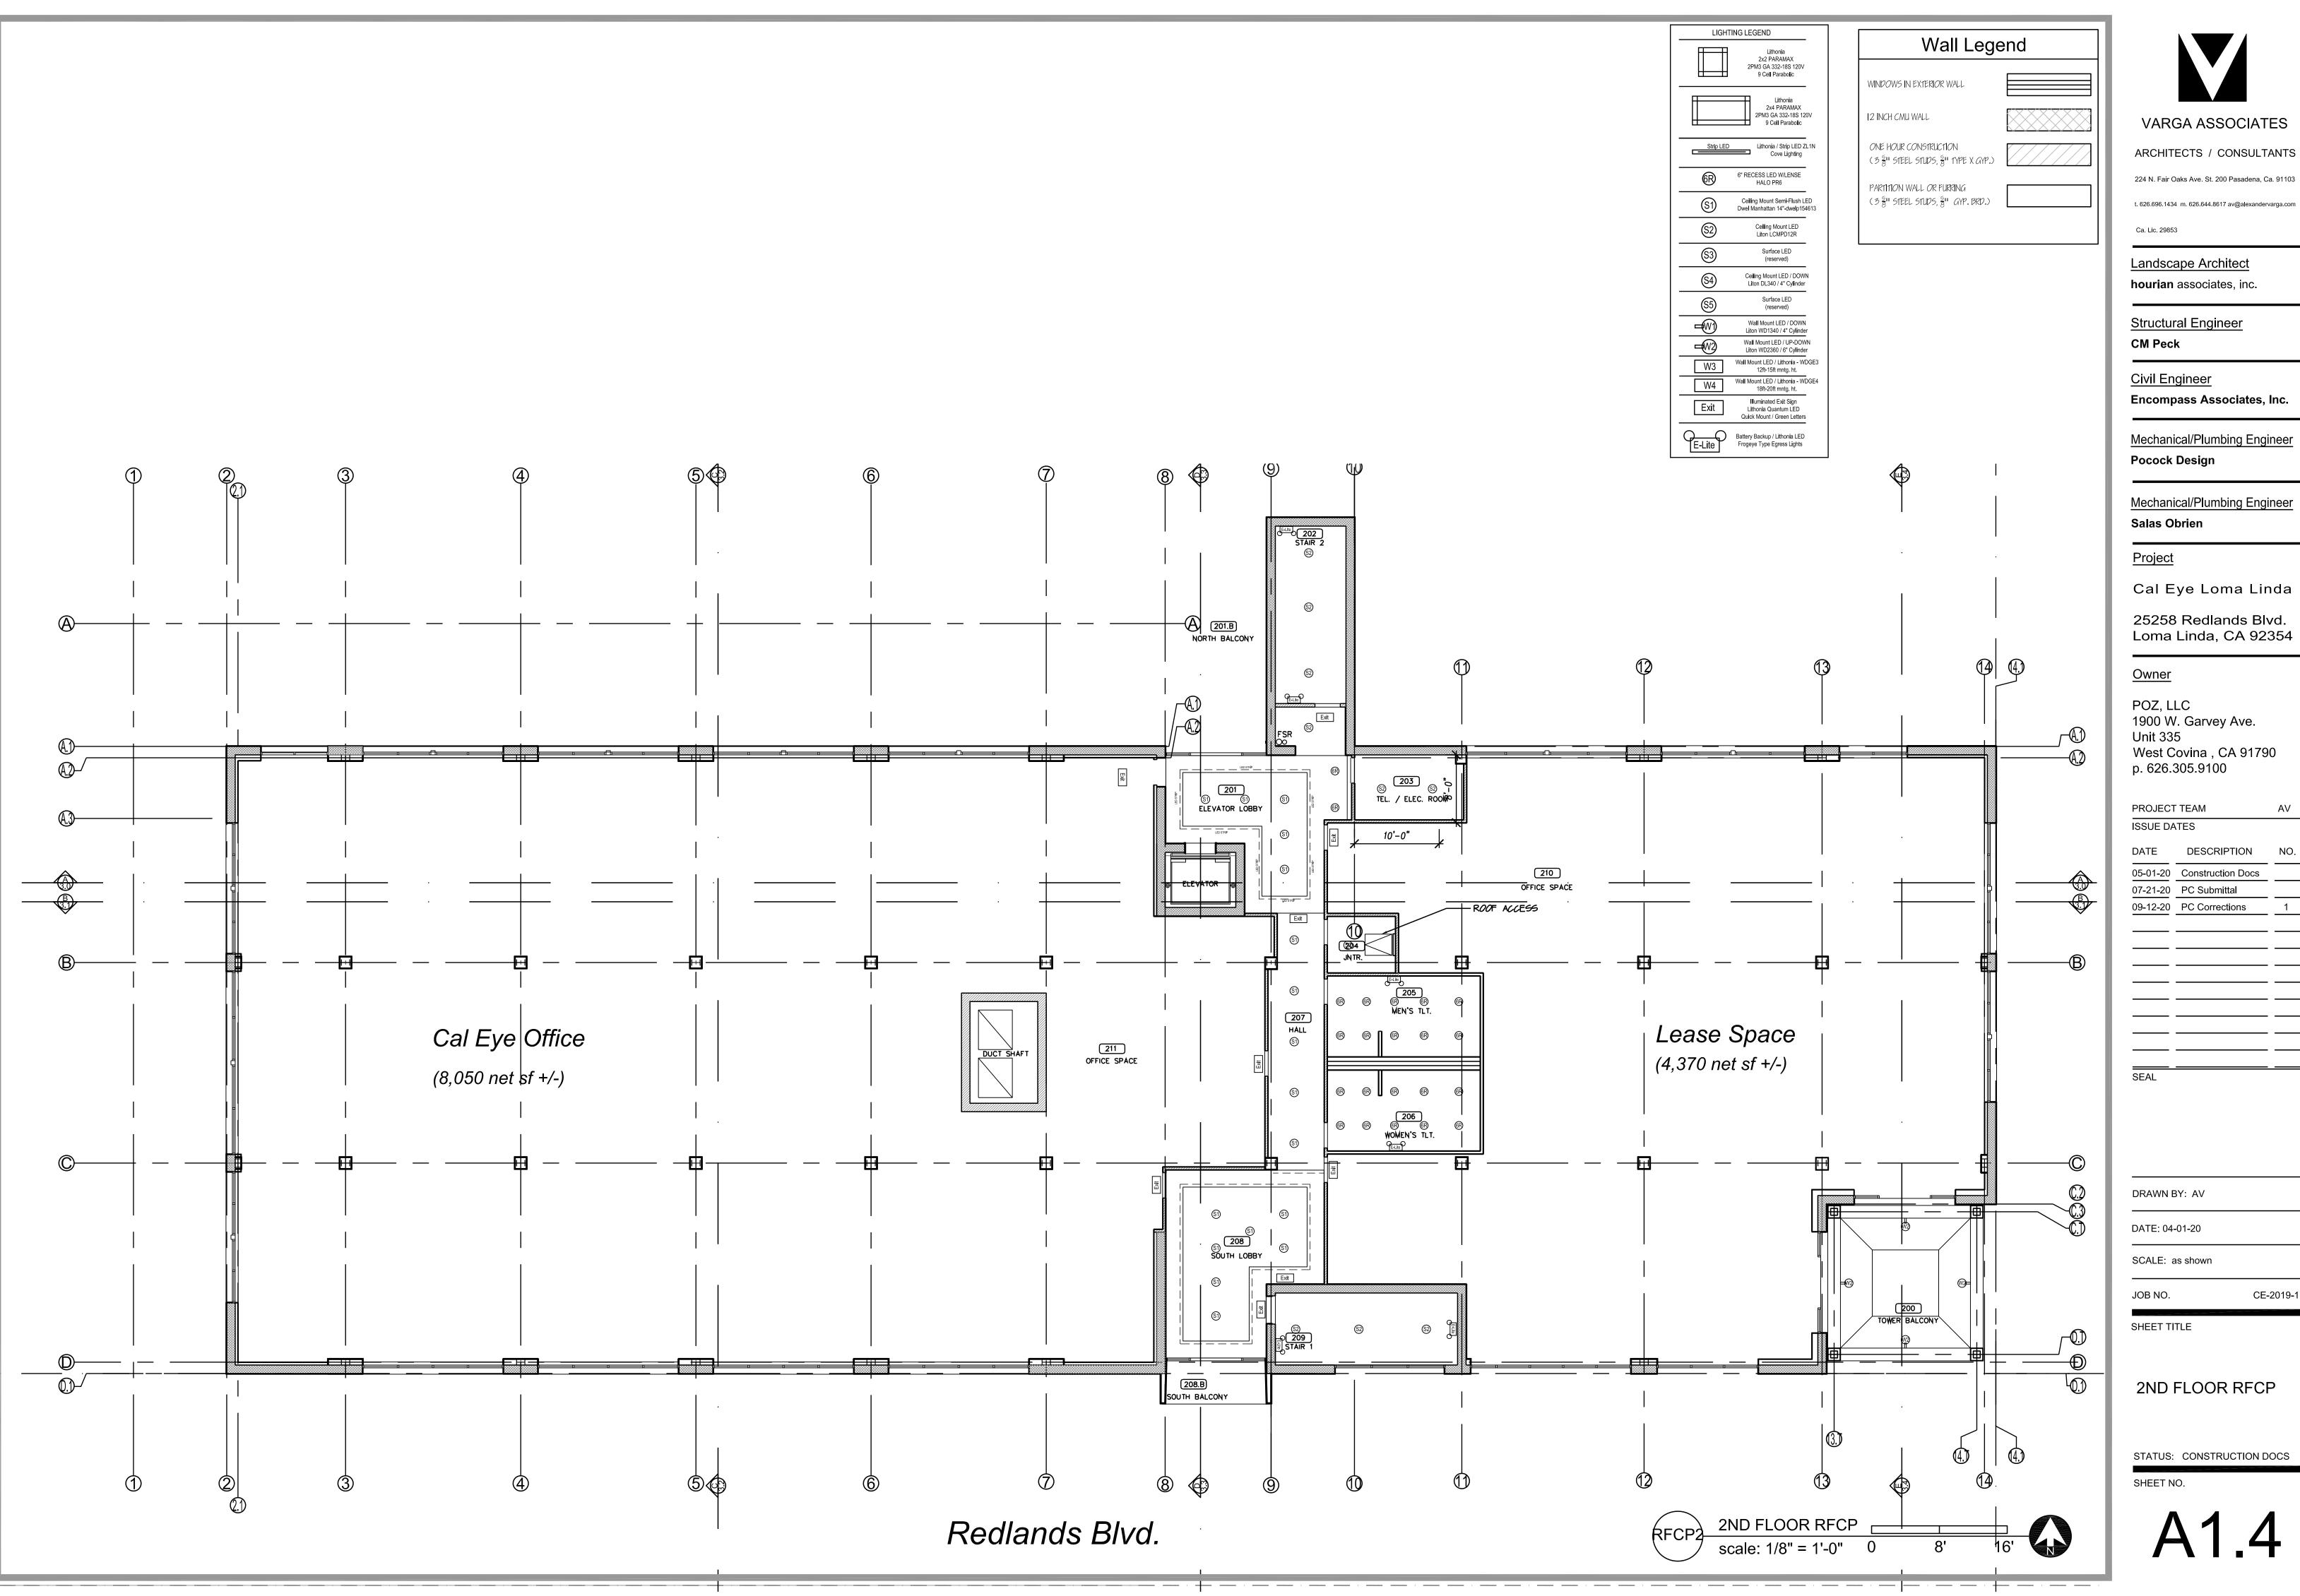Mechanical/Plumbing Engineer

Loma Linda, CA 92354



ARCHITECTS / CONSULTANTS
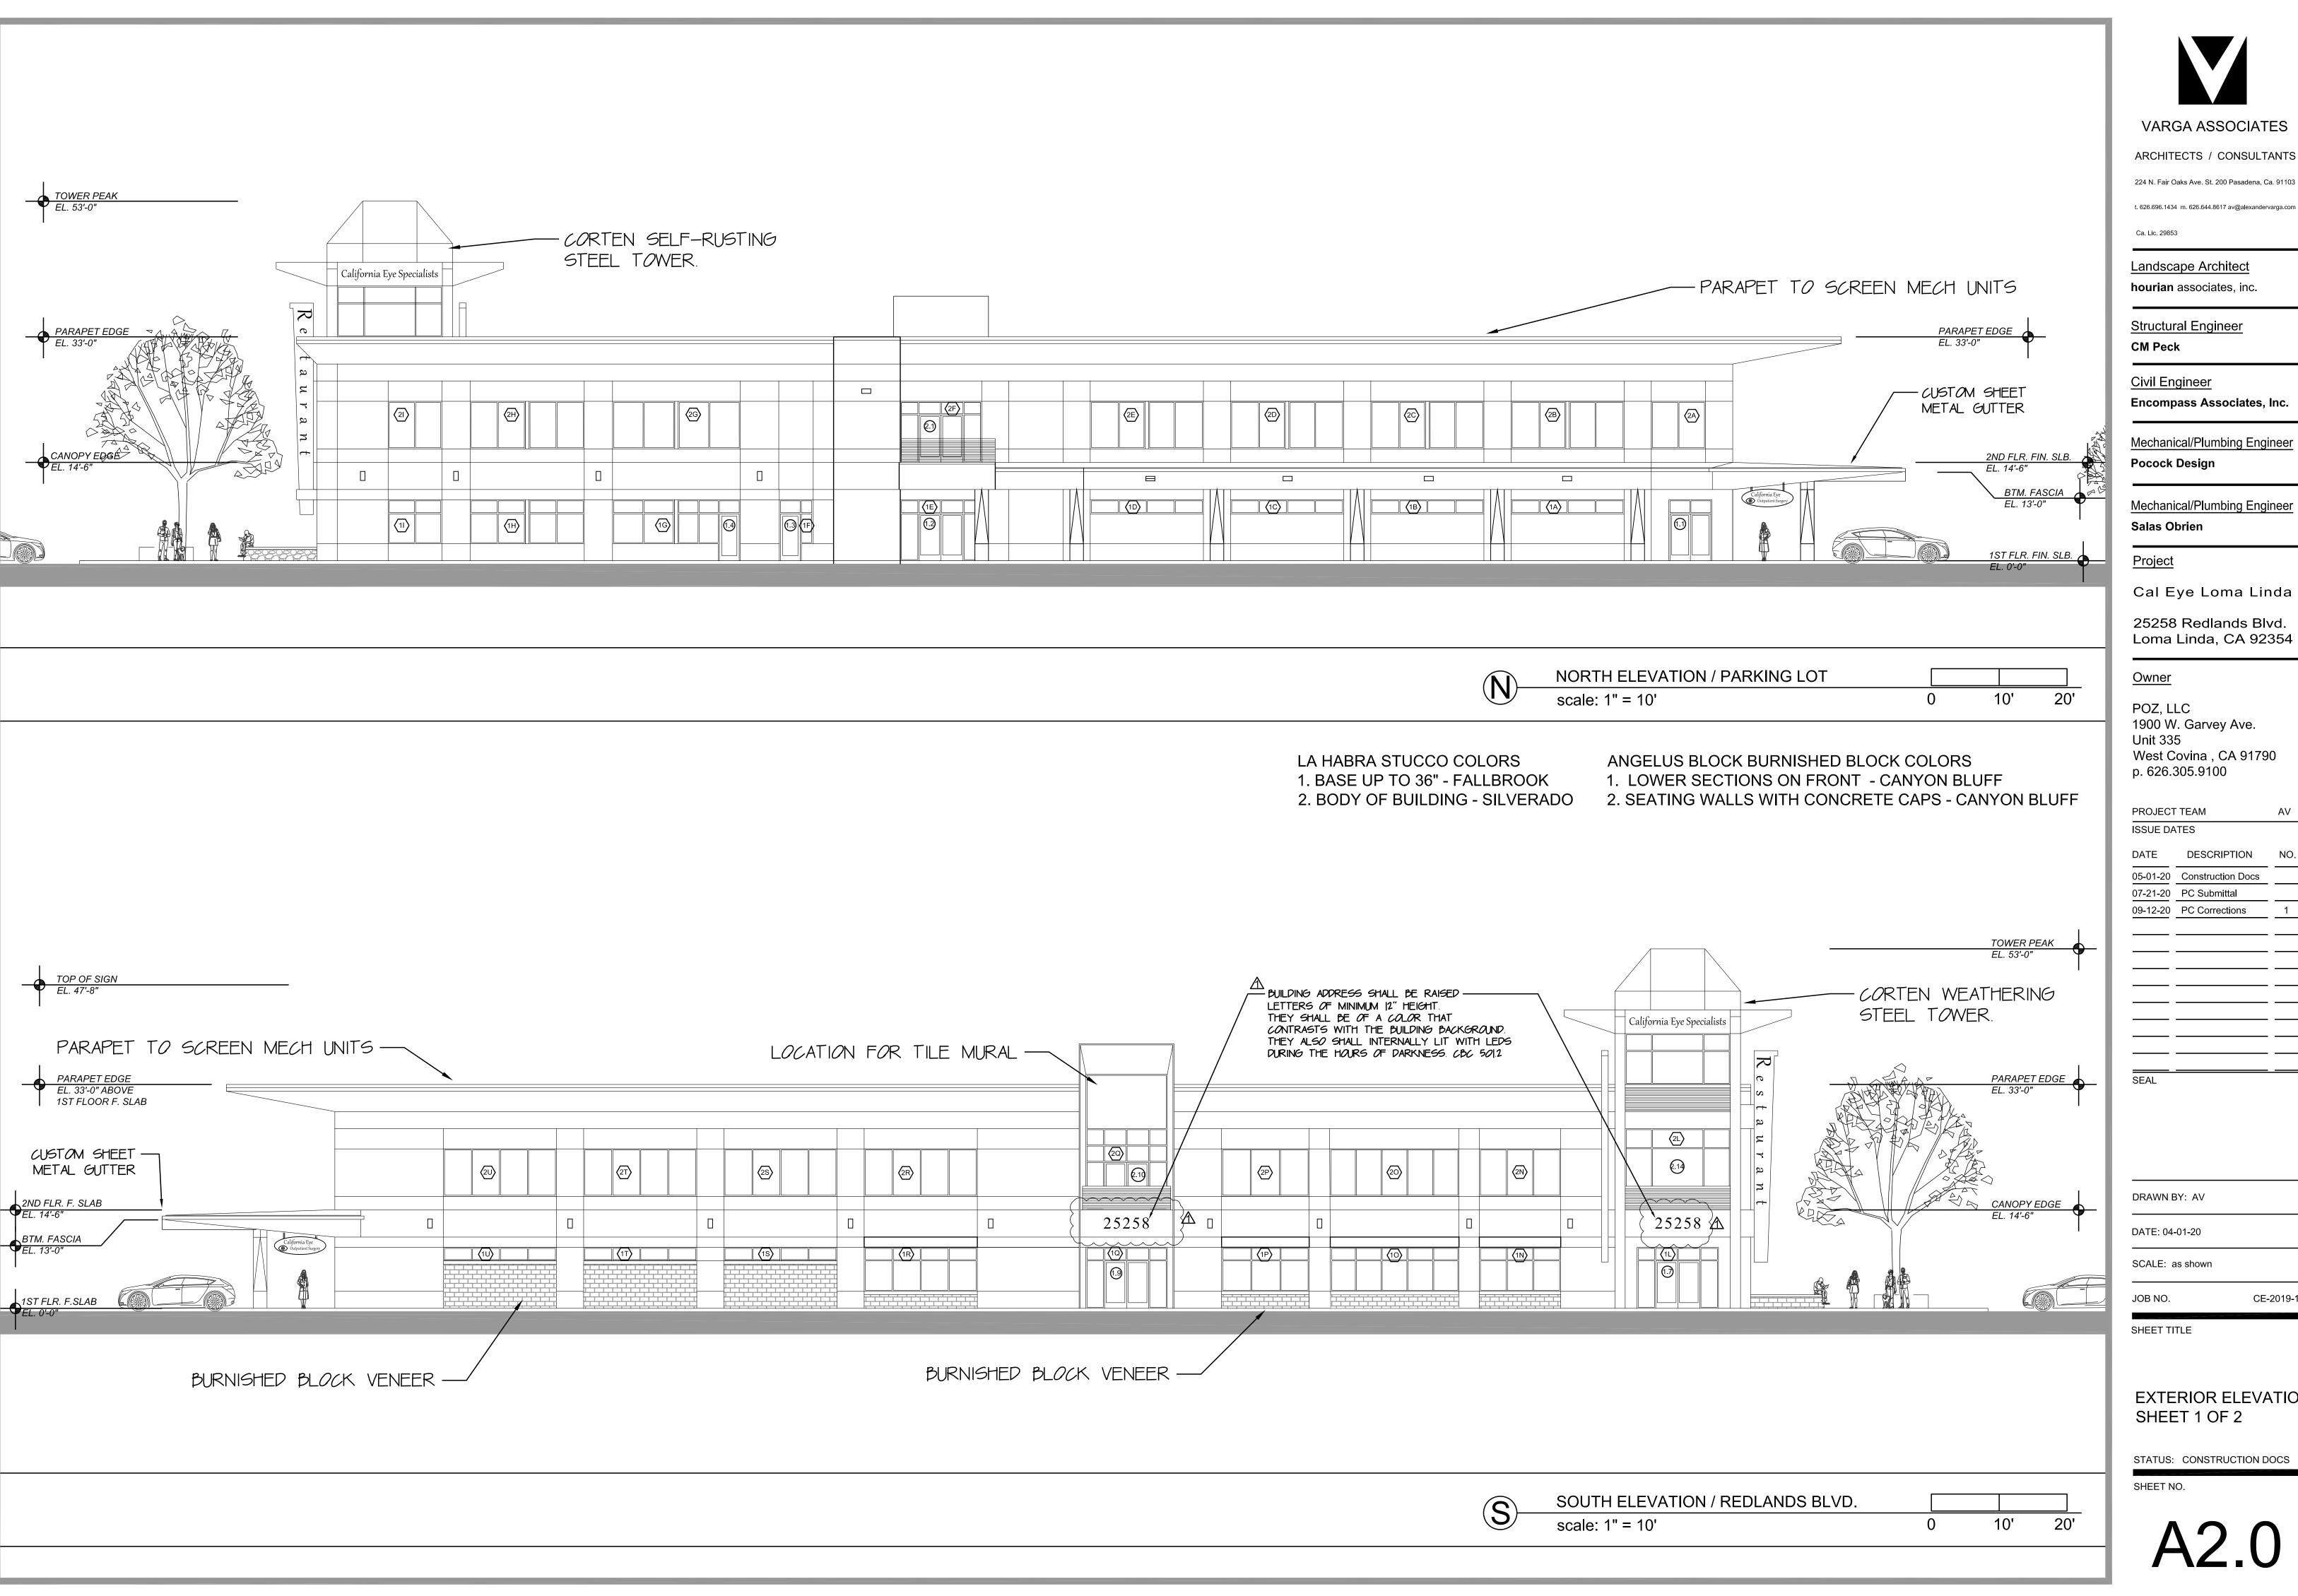
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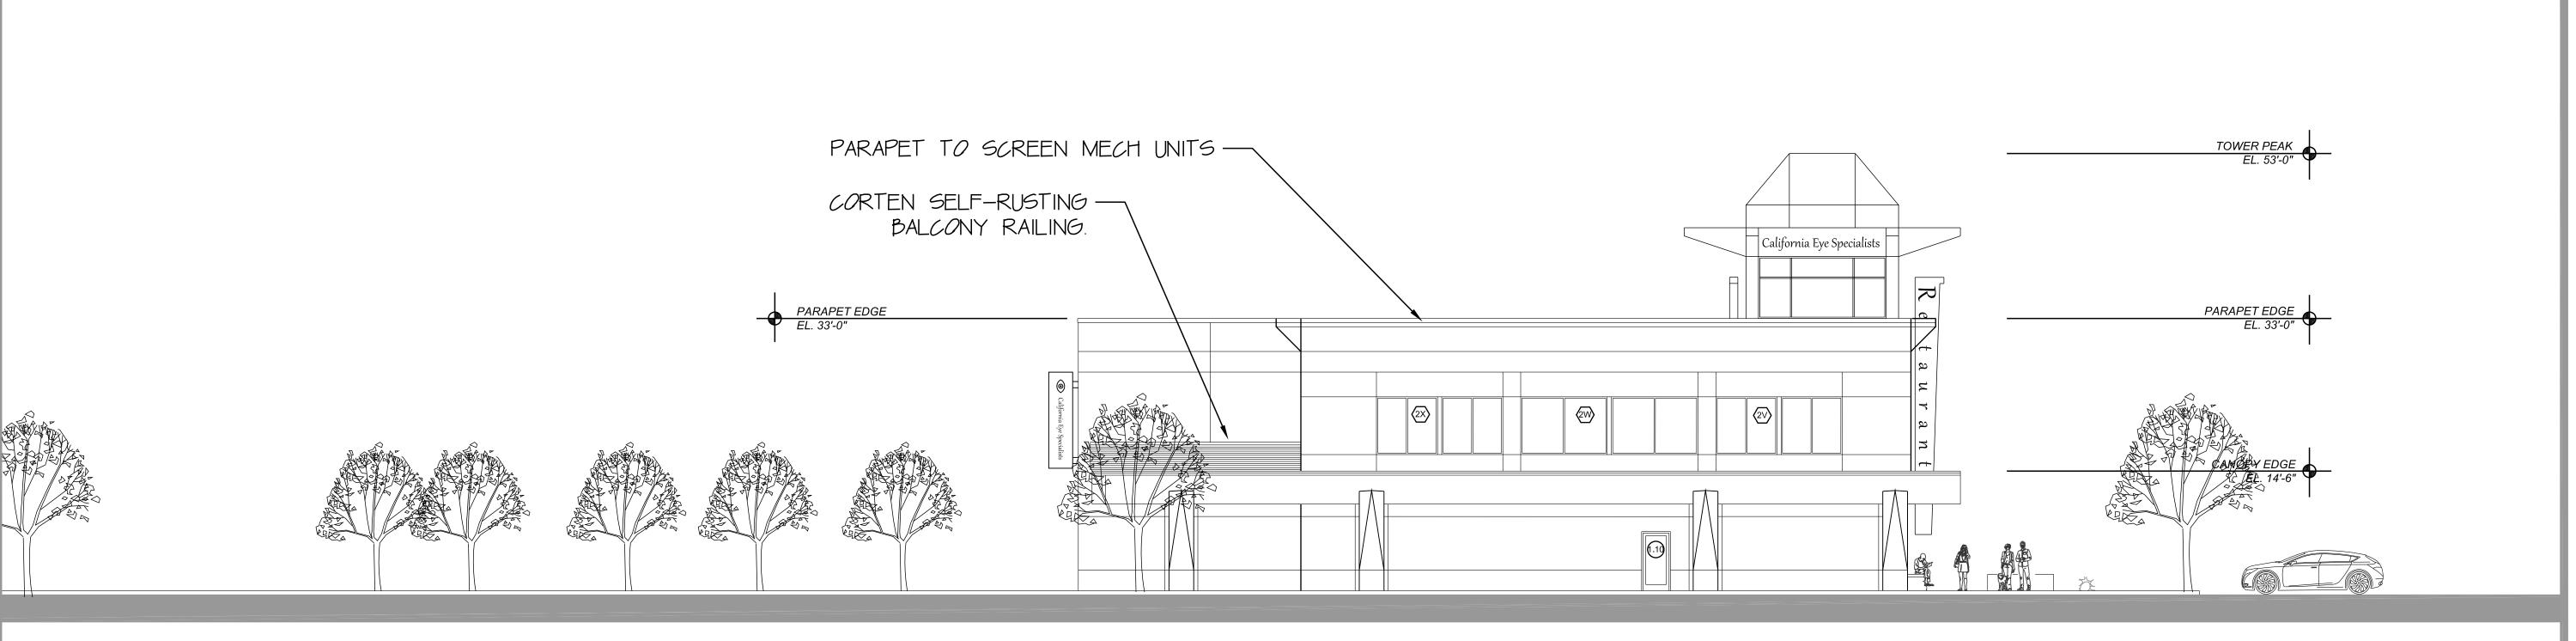
SHEET TITLE

EXTERIOR ELEVATIONS SHEET 1 OF 2

CE-2019-1

STATUS: CONSTRUCTION DOCS

SHEET NO.



LA HABRA STUCCO COLORS


1. BASE UP TO 36" - FALLBROOK

2. BODY OF BUILDING - SILVERADO

ANGELUS BLOCK BURNISHED BLOCK COLORS

1. LOWER SECTIONS ON FRONT - CANYON BLUFF

2. SEATING WALLS WITH CONCRETE CAPS - CANYON BLUFF

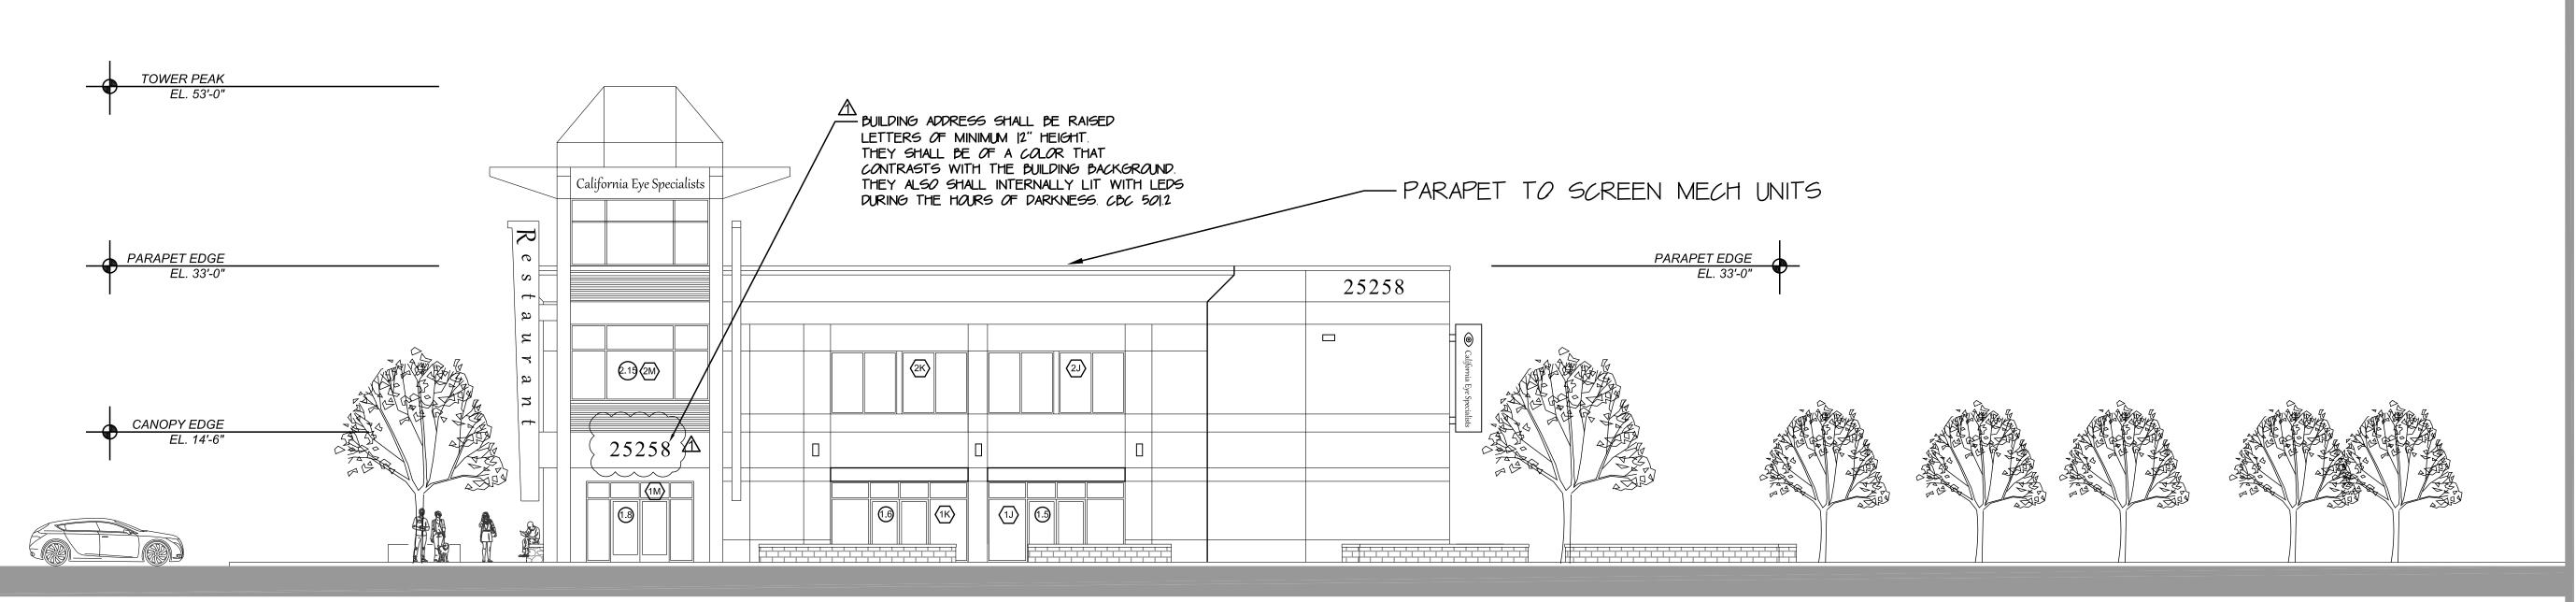

EAST ELEVATION / RICHARDSON STREET

scale: 1" = 10'

0 10' 20'

VARGA ASSOCIATES

ARCHITECTS / CONSULTANTS

224 N. Fair Oaks Ave. St. 200 Pasadena, Ca. 91103

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Landscape Architect

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hourian associates, inc.

Structural Engineer

CM Peck

Civil Engineer
Encompass Associates, Inc.

Mechanical/Plumbing Engineer

Mechanical/Plumbing Engineer
Salas Obrien

<u>Project</u>

Pocock Design

Cal Eye Loma Linda

25258 Redlands Blvd. Loma Linda, CA 92354

<u>Owner</u>

PROJECT TEAM

POZ, LLC 1900 W. Garvey Ave. Unit 335 West Covina , CA 91790 p. 626.305.9100

DATE DESCRIPTION NO.

05-01-20 Construction Docs

07-21-20 PC Submittal

09-12-20 PC Corrections 1

DRAWN BY: AV

DATE: 04-01-20

SCALE: as shown

JOB NO. CE-2019-1

SHEET TITLE

EXTERIOR ELEVATIONS SHEET 2 OF 2

STATUS: CONSTRUCTION DOCS

SHEET NO.

A2.1

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$M \wedge \Box \lor$	T		IZE Nuetcut			^CTUDED	1TCC
MARK 11	 	<u> </u>	HEIGHT	MATERIAL			TES V CLUSER
1.1 1.2	SWING DBL.	6'-0" 6'-0"	7'-0" 7'-0"	STOREFRONT ALUM			W. CLOSER W. CLOSER
1.3	SWING R.H.	3'-0"	7'-0"	STOREFRONT ALUM	+		W. CLOSER
1.4	SWING L.H.	3'-0"	7′-0″	STOREFRONT ALUM	1. ARCADIA V	VINDOW CORP. EQP. V	W. CLOSER
1.5	SWING DBL.	6′-0″	7′-0″	STOREFRONT ALUM	1. ARCADIA V	VINDOW CORP. EQP. V	w. CLOSER
1.6	SWING DBL.	6'-0"	7′-0″	STOREFRONT ALUM			w. CLOSER
1.7	SWING DBL.	6'-0"	7′-0″	STOREFRONT ALUM			W. CLOSER
1.8	SWING DBL.	6'-0" 6'-0"	7'-0" 7'-0"	STOREFRONT ALUM			W. CLOSER W. CLOSER
1.10	SWING L.H.	3'-0"	7'-0"	STOREFRONT ALUM			w. CLUSER W. CLUSER
1.11	SWING L.H.	3'-0"	7'-0"	SOLID CORE WOOD			N./W. CLOSER/SMOKE SEAL
1.12	SWING DBL.	6'-0"	7′-0″	STEEL FRAME/GLA	SS SAFTIFIRS	T CORP. 90 MI	N./W. CLOSER/SMOKE SEAL
1.13	SWING DBL.	6′-0″	7′-0″	STEEL FRAME/GLA	SAFTIFIRS	T CORP. 90 MI	N./W. CLOSER/SMOKE SEAL
1.14	SWING L.H.	3'-0"	7′-0″	SOLID CORE WOOD) TBA	60 MII	N./W. CLOSER/SMOKE SEAL
2.1	SWING DBL.	6'-0"	7'-0"	STOREFRONT ALUM		VINDOW CORP.	
2.2	SWING R.H.	3'-0"	7'-0"	SOLID CORE WOOD			N./W. CLOSER/SMOKE SEAL
2.3	SWING R.H.	3'-0"	7'-0" 7'-0"	SOLID CORE WOOD SOLID CORE WOOD			N./W. CLOSER/SMOKE SEAL N./W. CLOSER/SMOKE SEAL
2.5	SWING L.H.	3'-0"	7'-0"	SOLID CORE WOOD			N./W. CLOSER/SMOKE SEAL
2.6	SWING L.H.	3'-0"	7'-0"	SOLID CORE WOOD	- 		N./W. CLOSER/SMOKE SEAL
2.7	SWING L.H.	3'-0"	7′-0″	SOLID CORE WOOD	ТВА	60 MI	N./W. CLOSER/SMOKE SEAL
2.8	SWING L.H.	3'-0"	7'-0"	SOLID CORE WOOD			N./W. CLOSER/SMOKE SEAL
2.9	SWING L.H.	3'-0"	7′-0″	SOLID CORE WOOD			N./W. CLOSER/SMOKE SEAL
2.10	SWING DBL. SWING L.H.	6'-0" 3'-0"	7'-0" 7'-0"	STOREFRONT ALUM			W. CLOSER
2.11	SWING L.H.	3'-0"	7'-0"	SOLID CORE WOOD SOLID CORE WOOD			N./W. CLOSER/SMOKE SEAL N./W. CLOSER/SMOKE SEAL
2.13	SWING L.H.	3'-0"	7'-0"	SOLID CORE WOOD			N./W. CLOSER/SMOKE SEAL
2.14	SWING DBL.	6'-0"	7'-0"	STOREFRONT ALUM			W. CLOSER
2.15	SWING DBL.	6'-0"	7′-0″	STOREFRONT ALUM	1. ARCADIA V	VINDOW CORP. EQP. V	W. CLOSER
				OOR HARL	WARE S	CHEDULE	
MVDK	TYF						NULE C
MARK 1.1	PUSH SIDE	/ PULL	SIDE	LOCKING	MATERIAL	MANUFACTURE	
MARK 1.1 1.2		/ PULL	SIDE HANDLE				L PUSHBAR WITH DOGGING
1.1	PUSH SIDE PANIC PUSH BAR	/ PULL R / PULL R / PULL	SIDE HANDLE HANDLE	LOCKING KEYED ENTRY	MATERIAL BRUSHED S.S.	MANUFACTURES cal-royal or equa	L PUSHBAR WITH DOGGING L PUSHBAR WITH DOGGING
1.1 1.2	PUSH SIDE PANIC PUSH BAR PANIC PUSH BAR	/ PULL R / PULL R / PULL	SIDE HANDLE HANDLE	LOCKING KEYED ENTRY KEYED ENTRY	MATERIAL BRUSHED S.S. BRUSHED S.S.	MANUFACTURES CAL-ROYAL OR EQUA CAL-ROYAL OR EQUA	PUSHBAR WITH DOGGING PUSHBAR WITH DOGGING PUSHBAR WITH DOGGING
1.1 1.2 1.3 1.4 1.5	PUSH SIDE PANIC PUSH BAR	/ PULL R / PULL	SIDE HANDLE HANDLE HANDLE HANDLE	LOCKING KEYED ENTRY KEYED ENTRY KEYED ENTRY KEYED ENTRY KEYED ENTRY	MATERIAL BRUSHED S.S. BRUSHED S.S. BRUSHED S.S. BRUSHED S.S. BRUSHED S.S.	MANUFACTURES CAL-ROYAL OR EQUA	PUSHBAR WITH DOGGING
1.1 1.2 1.3 1.4 1.5 1.6	PUSH SIDE PANIC PUSH BAR	/ PULL R / PULL	SIDE HANDLE HANDLE HANDLE HANDLE HANDLE HANDLE	LOCKING KEYED ENTRY KEYED ENTRY KEYED ENTRY KEYED ENTRY KEYED ENTRY KEYED ENTRY	MATERIAL BRUSHED S.S. BRUSHED S.S. BRUSHED S.S. BRUSHED S.S. BRUSHED S.S. BRUSHED S.S.	MANUFACTURES CAL-ROYAL OR EQUA	PUSHBAR WITH DOGGING
1.1 1.2 1.3 1.4 1.5 1.6	PUSH SIDE PANIC PUSH BAR	/ PULL R / PULL	SIDE HANDLE HANDLE HANDLE HANDLE HANDLE HANDLE HANDLE	LOCKING KEYED ENTRY	MATERIAL BRUSHED S.S.	MANUFACTURES CAL-ROYAL OR EQUA	PUSHBAR WITH DOGGING
1.1 1.2 1.3 1.4 1.5 1.6	PUSH SIDE PANIC PUSH BAR	/ PULL R / PULL	SIDE HANDLE HANDLE HANDLE HANDLE HANDLE HANDLE	LOCKING KEYED ENTRY KEYED ENTRY KEYED ENTRY KEYED ENTRY KEYED ENTRY KEYED ENTRY	MATERIAL BRUSHED S.S. BRUSHED S.S. BRUSHED S.S. BRUSHED S.S. BRUSHED S.S. BRUSHED S.S.	MANUFACTURES CAL-ROYAL OR EQUA	PUSHBAR WITH DOGGING
1.1 1.2 1.3 1.4 1.5 1.6 1.7	PUSH SIDE PANIC PUSH BAR	/ PULL R / PULL	SIDE HANDLE HANDLE HANDLE HANDLE HANDLE HANDLE HANDLE HANDLE HANDLE	LOCKING KEYED ENTRY	MATERIAL BRUSHED S.S.	MANUFACTURES CAL-ROYAL OR EQUA	PUSHBAR WITH DOGGING
1.1 1.2 1.3 1.4 1.5 1.6 1.7 1.8 1.9 1.10	PUSH SIDE PANIC PUSH BAR	/ PULL R / PULL	SIDE HANDLE HANDLE HANDLE HANDLE HANDLE HANDLE HANDLE HANDLE HANDLE	LOCKING KEYED ENTRY	MATERIAL BRUSHED S.S.	MANUFACTURES CAL-ROYAL OR EQUA	PUSHBAR WITH DOGGING
1.1 1.2 1.3 1.4 1.5 1.6 1.7 1.8 1.9 1.10 1.11 1.12	PUSH SIDE PANIC PUSH BAR	/ PULL R / PULL	SIDE HANDLE	LOCKING KEYED ENTRY	MATERIAL BRUSHED S.S.	MANUFACTURES CAL-ROYAL OR EQUA	PUSHBAR WITH DOGGING
1.1 1.2 1.3 1.4 1.5 1.6 1.7 1.8 1.9 1.10 1.11 1.12 1.13	PUSH SIDE PANIC PUSH BAR	/ PULL R / PULL	SIDE HANDLE	LOCKING KEYED ENTRY	MATERIAL BRUSHED S.S.	MANUFACTURES CAL-ROYAL OR EQUA	PUSHBAR WITH DOGGING
1.1 1.2 1.3 1.4 1.5 1.6 1.7 1.8 1.9 1.10 1.11 1.12	PUSH SIDE PANIC PUSH BAR	/ PULL R / PULL	SIDE HANDLE	LOCKING KEYED ENTRY	MATERIAL BRUSHED S.S.	MANUFACTURES CAL-ROYAL OR EQUA	PUSHBAR WITH DOGGING
1.1 1.2 1.3 1.4 1.5 1.6 1.7 1.8 1.9 1.10 1.11 1.12 1.13 1.14	PUSH SIDE PANIC PUSH BAR	/ PULL R / PULL	SIDE HANDLE R HANDLE HANDLE HANDLE	LOCKING KEYED ENTRY PASSAGE KEYED ENTRY PASSAGE	MATERIAL BRUSHED S.S.	MANUFACTURES CAL-ROYAL OR EQUA	PUSHBAR WITH DOGGING
1.1 1.2 1.3 1.4 1.5 1.6 1.7 1.8 1.9 1.10 1.11 1.12 1.13 1.14	PUSH SIDE PANIC PUSH BAR	/ PULL PULL PULL PULL PULL PULL PULL PULL	SIDE HANDLE	LOCKING KEYED ENTRY PASSAGE KEYED ENTRY KEYED ENTRY KEYED ENTRY KEYED ENTRY	MATERIAL BRUSHED S.S.	MANUFACTURES CAL-ROYAL OR EQUA	PUSHBAR WITH DOGGING
1.1 1.2 1.3 1.4 1.5 1.6 1.7 1.8 1.9 1.10 1.11 1.12 1.13 1.14	PUSH SIDE PANIC PUSH BAR	/ PULL PULL PULL PULL PULL PULL PULL PULL	SIDE HANDLE	LOCKING KEYED ENTRY PASSAGE KEYED ENTRY PASSAGE	MATERIAL BRUSHED S.S.	MANUFACTURES CAL-ROYAL OR EQUA	PUSHBAR WITH DOGGING
1.1 1.2 1.3 1.4 1.5 1.6 1.7 1.8 1.9 1.10 1.11 1.12 1.13 1.14	PUSH SIDE PANIC PUSH BAR	/ PULL PULL PULL PULL PULL PULL PULL PULL	SIDE HANDLE	LOCKING KEYED ENTRY PASSAGE KEYED ENTRY PASSAGE	MATERIAL BRUSHED S.S.	MANUFACTURES CAL-ROYAL OR EQUA	PUSHBAR WITH DOGGING
1.1 1.2 1.3 1.4 1.5 1.6 1.7 1.8 1.9 1.10 1.11 1.12 1.13 1.14 2.1 2.2 2.3	PUSH SIDE PANIC PUSH BAR	/ PULL PULL PULL PULL PULL PULL PULL PULL	SIDE HANDLE R HANDLE R HANDLE R HANDLE R HANDLE R HANDLE	LOCKING KEYED ENTRY PASSAGE KEYED ENTRY KEYED ENTRY PASSAGE KEYED ENTRY PASSAGE KEYED ENTRY PASSAGE KEYED ENTRY PASSAGE	MATERIAL BRUSHED S.S.	MANUFACTURES CAL-ROYAL OR EQUA	PUSHBAR WITH DOGGING
1.1 1.2 1.3 1.4 1.5 1.6 1.7 1.8 1.9 1.10 1.11 1.12 1.13 1.14 2.1 2.2 2.3 2.4 2.5 2.6	PANIC PUSH BAR	/ PULL PULL PULL PULL PULL PULL PULL PULL	SIDE HANDLE R HANDLE R HANDLE R HANDLE R HANDLE R HANDLE	LOCKING KEYED ENTRY PASSAGE KEYED ENTRY KEYED ENTRY PASSAGE KEYED STOREROOM KEYED STOREROOM PASSAGE	MATERIAL BRUSHED S.S.	MANUFACTURES CAL-ROYAL OR EQUA	PUSHBAR WITH DOGGING
1.1 1.2 1.3 1.4 1.5 1.6 1.7 1.8 1.9 1.10 1.11 1.12 1.13 1.14 2.1 2.2 2.3 2.4 2.5 2.6 2.7	PANIC PUSH BAR PANIC	/ PULL PULL PULL PULL PULL PULL PULL PULL	SIDE HANDLE R HANDLE	LOCKING KEYED ENTRY PASSAGE KEYED ENTRY KEYED ENTRY PASSAGE KEYED STOREROOM PASSAGE PASSAGE	MATERIAL BRUSHED S.S.	MANUFACTURES CAL-ROYAL OR EQUA	PUSHBAR WITH DOGGING PUSHBAR WITH PUS
1.1 1.2 1.3 1.4 1.5 1.6 1.7 1.8 1.9 1.10 1.11 1.12 1.13 1.14 2.1 2.1 2.2 2.3 2.4 2.5 2.6 2.7 2.8	PANIC PUSH BAR PANIC	/ PULL PULL PULL PULL PULL PULL PULL PULL	SIDE HANDLE R HANDLE	LOCKING KEYED ENTRY PASSAGE KEYED ENTRY KEYED ENTRY KEYED ENTRY PASSAGE KEYED STOREROOM PASSAGE KEYED STOREROOM PASSAGE KEYED OFFICE	MATERIAL BRUSHED S.S.	MANUFACTURES CAL-ROYAL OR EQUA	PUSHBAR WITH DOGGING PUSHBAR WITH
1.1 1.2 1.3 1.4 1.5 1.6 1.7 1.8 1.9 1.10 1.11 1.12 1.13 1.14 2.1 2.1 2.2 2.3 2.4 2.5 2.6 2.7 2.8 2.9	PANIC PUSH BAR	/ PULL PULL PULL PULL PULL PULL PULL PULL	SIDE HANDLE R HANDLE	L DCKING KEYED ENTRY PASSAGE KEYED STOREROOM PASSAGE KEYED OFFICE PASSAGE	MATERIAL BRUSHED S.S.	MANUFACTURES CAL-ROYAL OR EQUA	L PUSHBAR WITH DOGGING
1.1 1.2 1.3 1.4 1.5 1.6 1.7 1.8 1.9 1.10 1.11 1.12 1.13 1.14 2.1 2.1 2.2 2.3 2.4 2.5 2.6 2.7 2.8	PANIC PUSH BAR PANIC	/ PULL PULL PULL PULL PULL PULL PULL PULL	SIDE HANDLE R HANDLE	LOCKING KEYED ENTRY PASSAGE KEYED ENTRY KEYED ENTRY KEYED ENTRY PASSAGE KEYED STOREROOM PASSAGE KEYED STOREROOM PASSAGE KEYED OFFICE	MATERIAL BRUSHED S.S.	MANUFACTURES CAL-ROYAL OR EQUA	PUSHBAR WITH DOGGING
1.1 1.2 1.3 1.4 1.5 1.6 1.7 1.8 1.9 1.10 1.11 1.12 1.13 1.14 2.1 2.2 2.3 2.4 2.5 2.6 2.7 2.8 2.9 2.10	PANIC PUSH BAR LEVER HANDLE	/ PULL PULL PULL PULL PULL PULL PULL PULL	SIDE HANDLE R HANDLE	LUCKING KEYED ENTRY PASSAGE KEYED ENTRY KEYED ENTRY PASSAGE KEYED STOREROOM PASSAGE KEYED STOREROOM PASSAGE KEYED OFFICE PASSAGE KEYED OFFICE PASSAGE KEYED OFFICE	MATERIAL BRUSHED S.S.	MANUFACTURES CAL-ROYAL OR EQUA	PUSHBAR WITH DOGGING
1.1 1.2 1.3 1.4 1.5 1.6 1.7 1.8 1.9 1.10 1.11 1.12 1.13 1.14 2.1 2.1 2.2 2.3 2.4 2.5 2.6 2.7 2.8 2.9 2.10 2.11	PANIC PUSH BAR LEVER HANDLE	/ PULL PULL PULL PULL PULL PULL PULL PULL	SIDE HANDLE R HANDLE	LUCKING KEYED ENTRY PASSAGE KEYED STOREROOM PASSAGE KEYED OFFICE PASSAGE KEYED OFFICE PASSAGE KEYED OFFICE	MATERIAL BRUSHED S.S.	MANUFACTURES CAL-ROYAL OR EQUA	PUSHBAR WITH DOGGING PUSHBAR WITH PUSHBAR
1.1 1.2 1.3 1.4 1.5 1.6 1.7 1.8 1.9 1.10 1.11 1.12 1.13 1.14 2.1 2.1 2.2 2.3 2.4 2.5 2.6 2.7 2.8 2.9 2.10 2.11 2.12	PANIC PUSH BAR	/ PULL PULL PULL PULL PULL PULL PULL PULL	SIDE HANDLE R HANDLE	L CKING KEYED ENTRY PASSAGE KEYED STOREROOM PASSAGE KEYED STOREROOM PASSAGE KEYED STOREROOM PASSAGE KEYED OFFICE PASSAGE KEYED OFFICE KEYED OFFICE KEYED OFFICE KEYED OFFICE	MATERIAL BRUSHED S.S. BRUSHED S.S.	MANUFACTURES CAL-ROYAL OR EQUA CAL-ROYAL OR EQUA	PUSHBAR WITH DDGGING L PUSHBAR WITH DDGGING

WINDOW SCHEDULE						
		5	IZE			
MARK	Туре	WIDTH	HEIGHT	MATERIAL	MANUFACTURER	NOTES
1A	FIXED	16′-8″	2'-0"	STOREFRONT ALUM.	ARCADIA WINDOW CORP.	
1B	FIXED	16′-8″	2'-0"	STOREFRONT ALUM.	ARCADIA WINDOW CORP.	
1C	FIXED	16′-8″	2'-0"	STOREFRONT ALUM.	ARCADIA WINDOW CORP.	
1 D	FIXED	16'-8"	2'-0"	STOREFRONT ALUM.	ARCADIA WINDOW CORP.	
1E	FIXED	12'-0"	2'-0"	STOREFRONT ALUM.	ARCADIA WINDOW CORP.	PART OF DOOR ASSEMBLY
1F	FIXED	5′-0″	9'-0"	STOREFRONT ALUM.	ARCADIA WINDOW CORP.	PART OF DOOR ASSEMBLY
1G	FIXED	19′-0″	6′-6″	STOREFRONT ALUM.	ARCADIA WINDOW CORP.	PART OF DOOR ASSEMBLY
1H	FIXED	17′-0″	6'-6"	STOREFRONT ALUM.	ARCADIA WINDOW CORP.	
1 I	FIXED	8′-6″	6′-6″	STOREFRONT ALUM.	ARCADIA WINDOW CORP.	
1J	FIXED	15′-6″	9'-0"	STOREFRONT ALUM.	ARCADIA WINDOW CORP.	PART OF DOOR ASSEMBLY
1K	FIXED	15′-6″	9'-0"	STOREFRONT ALUM.	ARCADIA WINDOW CORP.	PART OF DOOR ASSEMBLY
1L	FIXED	12'-0"	9'-0"	STOREFRONT ALUM.	ARCADIA WINDOW CORP.	PART OF DOOR ASSEMBLY
1M	FIXED	12'-0"	9'-0"	STOREFRONT ALUM.	ARCADIA WINDOW CORP.	PART OF DOOR ASSEMBL
1N	FIXED	12'-0"	6'-6"	STOREFRONT ALUM.	ARCADIA WINDOW CORP.	
1 🗆	FIXED	19'-0"	6'-6"	STOREFRONT ALUM.	ARCADIA WINDOW CORP.	
1P	FIXED	13'-0"	6′-6″	STOREFRONT ALUM.	ARCADIA WINDOW CORP.	
1Q	FIXED	12'-0"	9'-0"	STOREFRONT ALUM.	ARCADIA WINDOW CORP.	PART OF DOOR ASSEMBL
1R	FIXED	16′-8″	6′-6″	STOREFRONT ALUM.	ARCADIA WINDOW CORP.	
1S	FIXED	16′-8″	2'-0"	STOREFRONT ALUM.	ARCADIA WINDOW CORP.	
1 T	FIXED	16'-8"	2'-0"	STOREFRONT ALUM.	ARCADIA WINDOW CORP.	
1U	FIXED	16′-8″	2'-0"	STOREFRONT ALUM.	ARCADIA WINDOW CORP.	
	TINED					
	FIXED	8'-0"	7′-0″	STOREFRONT ALUM.	ARCADIA WINDOW CORP.	
2B	FIXED	16′-8″	7′-0″	STOREFRONT ALUM.	ARCADIA WINDOW CORP.	
2C	FIXED	16'-8"	7'-0"	STOREFRONT ALUM.	ARCADIA WINDOW CORP.	
2D	FIXED	16′-8″	7′-0″	STOREFRONT ALUM.	ARCADIA WINDOW CORP.	
2E	FIXED	16'-8"	7′-0″	STOREFRONT ALUM.	ARCADIA WINDOW CORP.	
2F	FIXED	12'-0"	9'-0"	STOREFRONT ALUM.	ARCADIA WINDOW CORP.	PART OF DOOR ASSEMBL
2G	FIXED	19'-0"	7′-0″	STOREFRONT ALUM.	ARCADIA WINDOW CORP.	PART OF DOOR ASSEMBL
2H	FIXED	17'-0"	7′-0″	STOREFRONT ALUM.	ARCADIA WINDOW CORP.	
2I	FIXED	8'-0"	7′-0″	STOREFRONT ALUM.	ARCADIA WINDOW CORP.	
	FIXED	15′-6″	7′-0″	STOREFRONT ALUM.	ARCADIA WINDOW CORP.	
2K	FIXED	15'-6"	7′-0″	STOREFRONT ALUM.	ARCADIA WINDOW CORP.	
2L	FIXED	12'-0"	9'-0"	STOREFRONT ALUM.	ARCADIA WINDOW CORP.	PART OF DOOR ASSEMBL
2M	FIXED	12'-0"	9'-0"	STOREFRONT ALUM.		PART OF DOOR ASSEMBL
2N	FIXED	12'-0"	7′-0″	STOREFRONT ALUM.	ARCADIA WINDOW CORP.	TAKT DI DUDK ASSEMBL
20	FIXED	19'-0"	7'-0"	STOREFRONT ALUM.	ARCADIA WINDOW CORP.	
2P	FIXED	13'-0"	7'-0"	STOREFRONT ALUM.	ARCADIA WINDOW CORP.	
						DADT DE DOOD ASSEMBL
2Q 2R	FIXED FIXED	12'-0" 16'-8"	12'-0" 7'-0"	STOREFRONT ALUM.	ARCADIA WINDOW CORP.	PART OF DOOR ASSEMBL
	FIXED			STOREFRONT ALUM.	ARCADIA WINDOW CORP.	
25	FIXED	16'-8"	7'-0"	STOREFRONT ALUM.	ARCADIA WINDOW CORP.	
2H		16'-8"	7'-0"	STOREFRONT ALUM.	ARCADIA WINDOW CORP.	
2V	FIXED	16'-8"	7'-0"	STOREFRONT ALUM.	ARCADIA WINDOW CORP.	
2V	FIXED	15'-6"	7'-0"	STOREFRONT ALUM.	ARCADIA WINDOW CORP.	
2V	FIXED	21'-6"	7′-0″	STOREFRONT ALUM.	ARCADIA VINDOV CORP.	
2X	FIXED	15′-6″	7′-0″	STOREFRONT ALUM.	ARCADIA WINDOW CORP.	
			I		1	1

WINDOW SCHEDULE NOTES

- 1. KYNAR PAINT FINISH (ICI TBA)
- 2. STOREFRONT ALUMINUM IN NEW OPENING / 1" INSULATED GLASS / THERMALLY BROKEN FRAME.
- 3. ALL GLAZING IN DOORS AND HAZARDOUS LOCATIONS TO BE TEMPERED SAFETY WITH LABELS.
- 4. REFER TO GRAPHIC SCHEDULE FOR WINDOW/DOOR ARRANGEMENT AND DIMENSIONS.

DOOR SCHEDULE NOTES

- 1. ALL DOOR HANDLES TO BE ACCESSIBLE, EITHER AS LEVER HANDLES OR PULL HANDLES
- 2. MAXIMUM EFFORT TO OPERATE DOOR SHALL NOT EXCEED 5 LBS. FOR EXTERIOR DOORS
- AND 5 LBS. FOR INTERIOR DOORS, PULL OR PUSH EFFORT BEING MADE AT RIGHT ANGLES TO HINGED DOOR.

- COMPENSATING DEVICES OR AUTOMATIC DOOR OPENERS MAY BE UTILIZED TO MEET THE ABOVE STANDARDS.
- 3. THE INTERNATIONAL SYMBOLS OF ACCESSIBILITY SHALL CONSIST OF A WHITE FIGURE ON A BLUE BACKGROUND. 4. DOOR HARDWARE (HANDLES, PULLS, LATCHES, LOCKS, AND OPERABLE PARTS SHALL BE 34" TO 44" MAXIMUM
- ABOVE FINISH FLOOR OR GROUND (CBC 11B-404.2.7)

VARGA ASSOCIATES

ARCHITECTS / CONSULTANTS

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224 N. Fair Oaks Ave. St. 200 Pasadena, Ca. 91103

Ca. Lic. 29853

Landscape Architect hourian associates, inc.

Structural Engineer CM Peck

Civil Engineer

Encompass Associates, Inc.

Mechanical/Plumbing Engineer **Pocock Design**

Mechanical/Plumbing Engineer Salas Obrien

<u>Project</u>

Cal Eye Loma Linda

25258 Redlands Blvd. Loma Linda, CA 92354

<u>Owner</u>

POZ, LLC 1900 W. Garvey Ave. Unit 335 West Covina , CA 91790 p. 626.305.9100

PROJECT TEAM				
ISSUE DATES				
DATE	DESCRIPTION	NC		
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07-21-20	PC Submittal			
09-12-20	PC Corrections	1		

DRAWN BY: AV

DATE: 04-01-20


SCALE: as shown

SHEET TITLE

WINDOW AND DOOR

SCHEDULE SHEET 1 OF 2

STATUS: CONSTRUCTION DOCS SHEET NO.

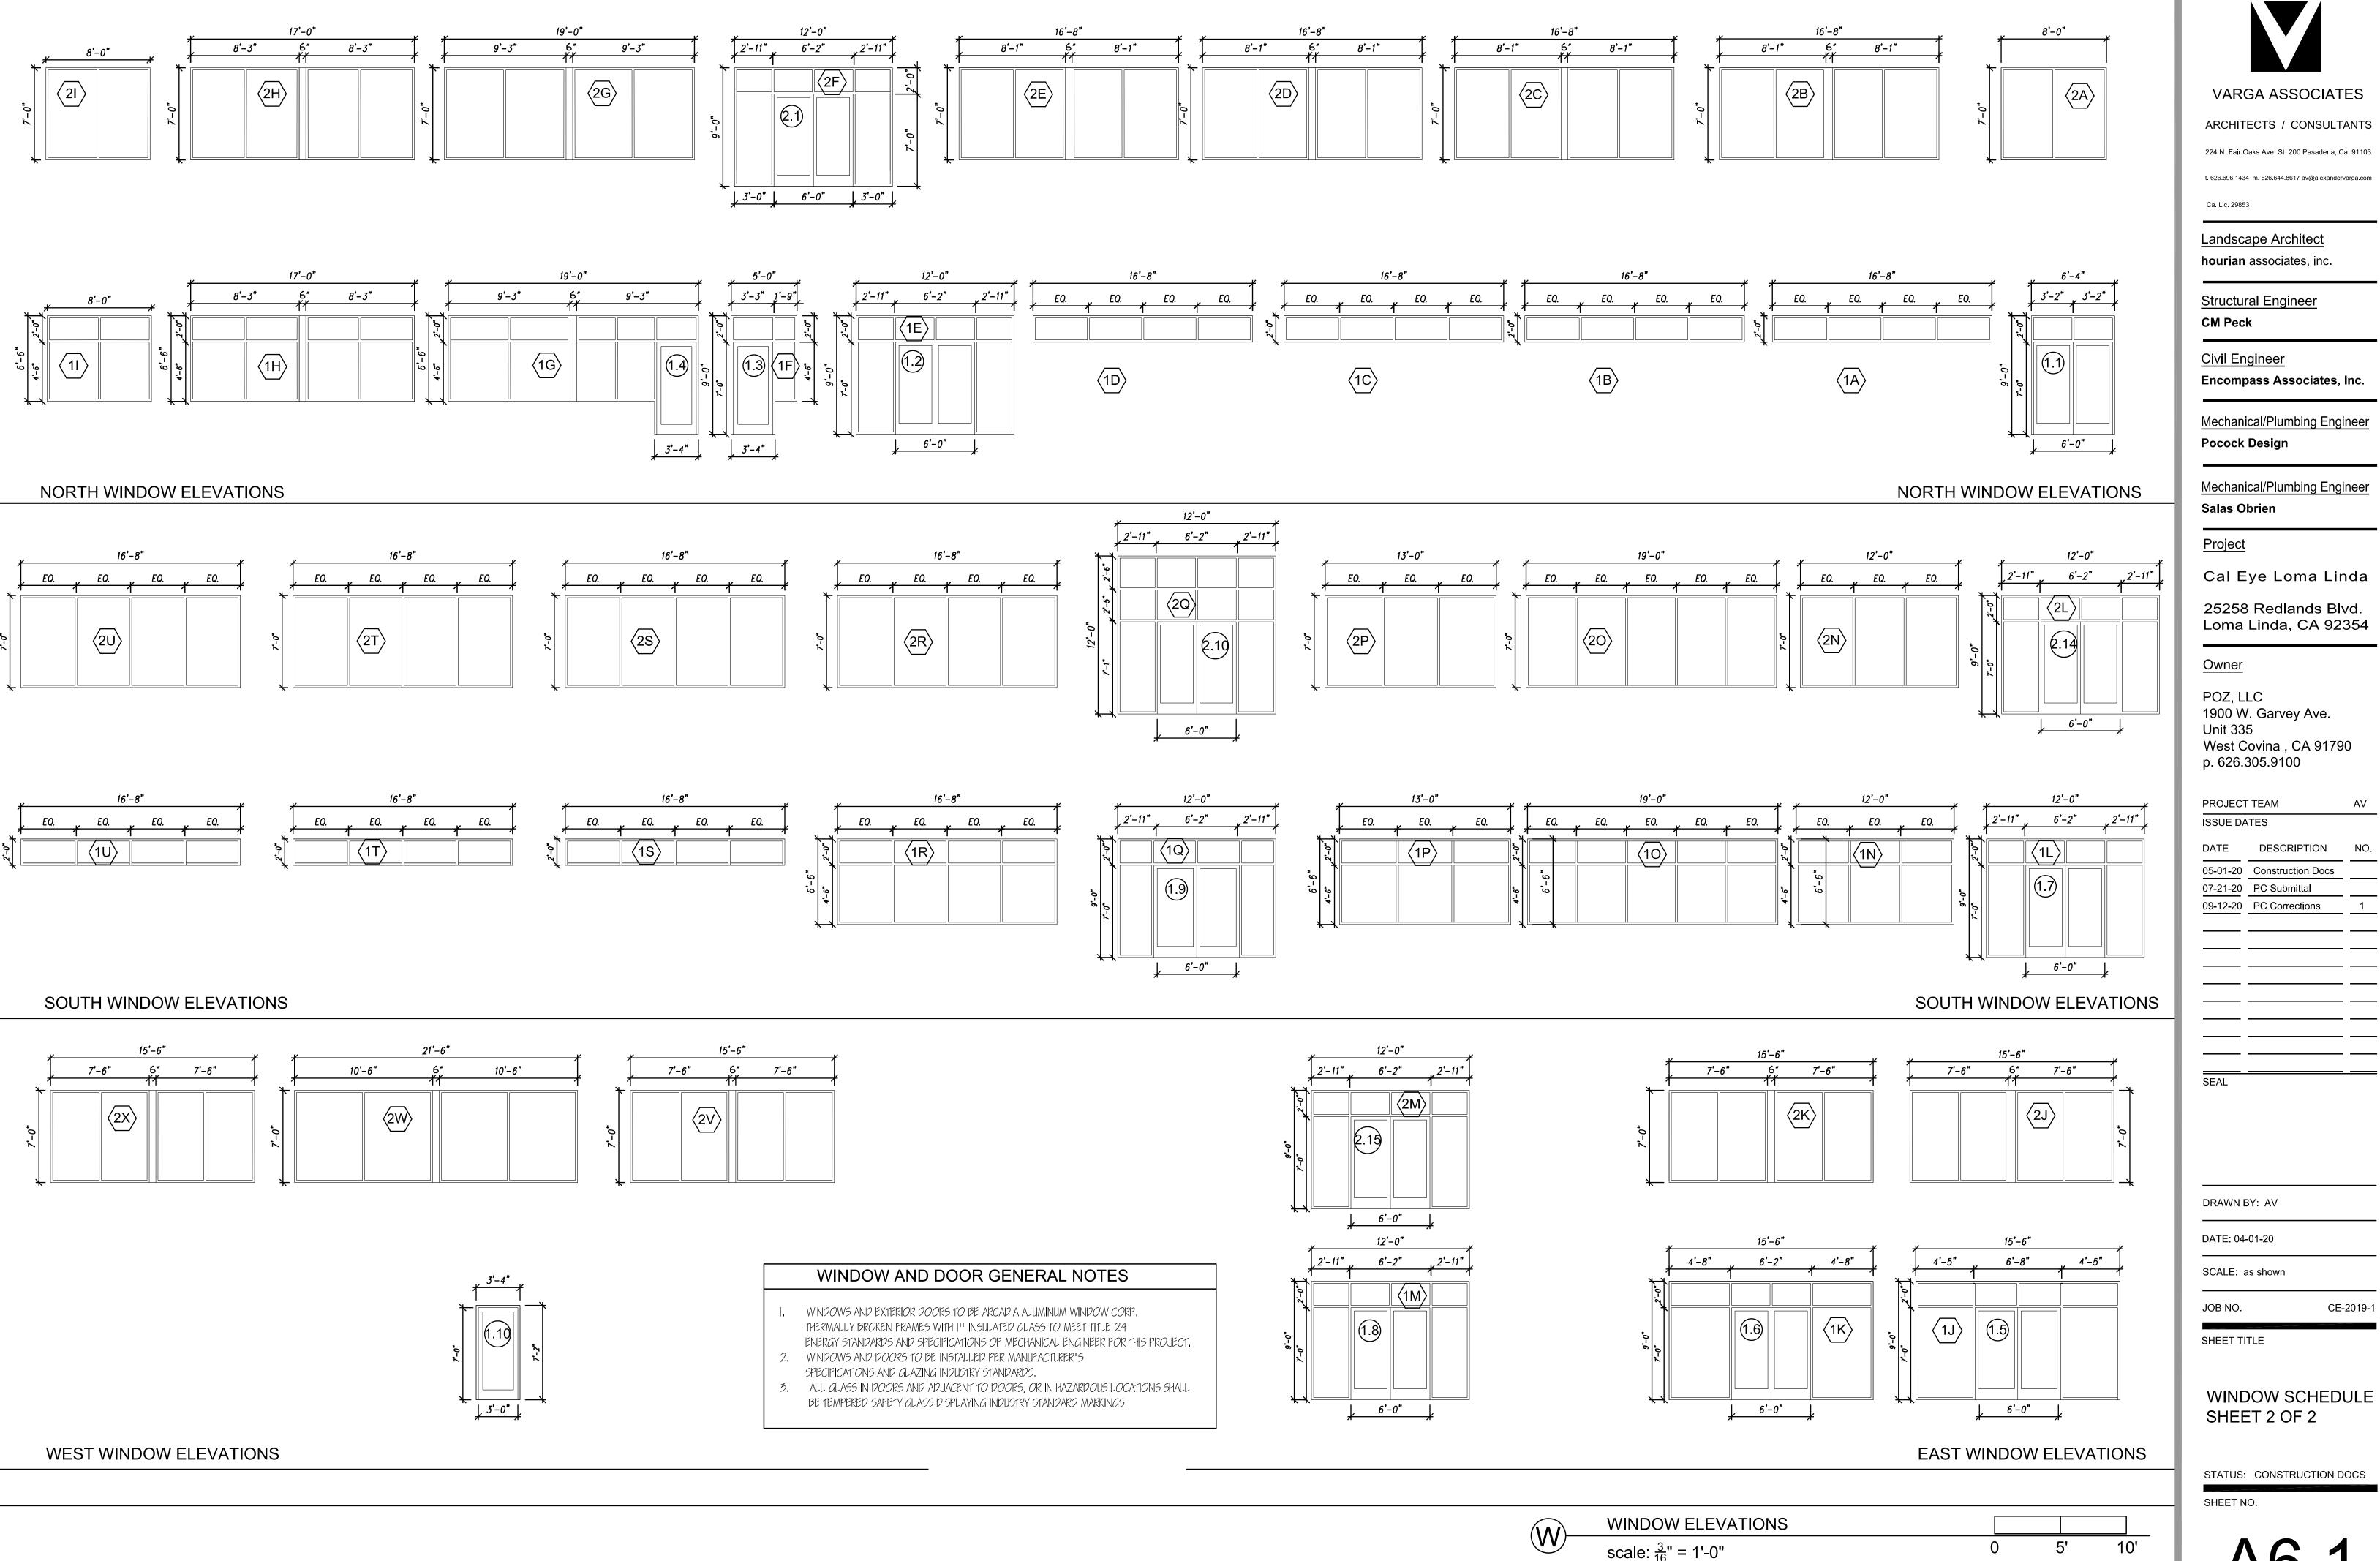

t. 626.696.1434 m. 626.644.8617 av@alexandervarga.com

Mechanical/Plumbing Engineer

Mechanical/Plumbing Engineer

Loma Linda, CA 92354

West Covina , CA 91790

DESCRIPTION NO.