## IMAGING CENTER

# COLUMBUS IMAGING ASSOCIATES

CREEKVIEW DRIVE COLUMBUS, INDIANA

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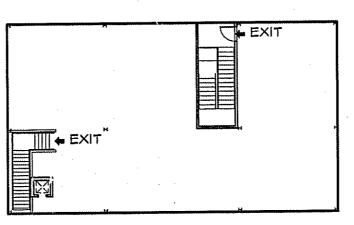
24.1 Panel Details

#### Professional Consultants, Inc.


engineering | architecture
construction management



ansville, Indiana



SECOND FLOOR

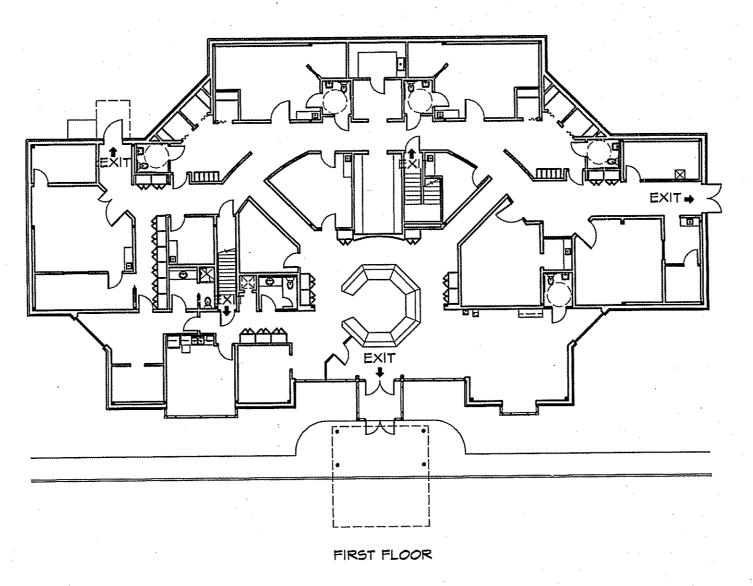



## **CODE REVIEW DATA**

THIS PROJECT HAS BEEN DESIGNED BASED UPON THE LATEST EDITION OF THE FOLLOWING BUILDING CODES AND STANDARDS

INDIANA BUILDING CODE (IBC)
GENERAL ADMINISTRATIVE RULES (GAR)
AMERICANS WITH DISABILITIES ACT (ADA)
INDIANA PLUMBING CODE (IPC)
INDIANA MECHANICAL CODE (IMC)
INDIANA ELECTRICAL CODE (IEC)
INDIANA FIRE CODE (IFC)
INDIANA ACCESSIBILITY CODE (IAC)

INDIANA ENERGY CONSERVATION CODE (IECC)

OCCUPANCY CLASSIFICATION: B2

TOTAL ENCLOSED BUILDING AREA

## CONSTRUCTION CLASSIFICATION: TYPE II-N

EXTERIOR NON-BEARING WALL STRUCTURAL FRAME ROOF/CEILING PARTITIONS SHAFT ENCLOSURES BUILDING ELEMENTS MATERIALS

NON-RATED NON-RATED NON-RATED NON-RATED I HR. NON-COMBUSTIBLE

FIRST FLOOR SECOND FLOOR

8,669 S.F. 2,630 S.F. 11,299 S.F.

PI ISSUED FOR CONTRACTOR REVIEW

ISSUED FOR STATE REVIEW

12/20/96 NOT FOR CONSTRUCTION

I ISSUED FOR STATE REVIEW

2 ISSUED FOR STATE ADDENDUM


03/21/97

02/25/97

## EQUIPMENT SCHEDULE

<u>NO.</u>	NO REQ'D	DESCRIPTION
RT-I		TRANE NO. YCDI20C PACKAGE GAS FIRED ROOF TOP UNIT WITH CURB, 0-25% OUTSIDE AIR DAMPER, PROGRAMMABLE THERMOSTAT 10 TONS COOLING 205 MBH 2 STAGE HEAT 3600 CFM @ 1.0" E.S.P. 480-30
RT-2	1	TRANE NO. YCD090D DUAL COMPRESSOR PACKAGE GAS FIRED ROOFTOP UNIT WITH CURB, 0-25% OUTSIDE AIR DAMPER, PROGRAMMABLE THERMOSTAT 7.5 TONS COOLING 205 MBH 2 STAGE HEAT 2550 CFM @ 1.0" E.S.P. 480-30
RT-3		TRANE NO. YCD036C PACKAGE GAS FIRED ROOF TOP UNIT WITH CURB, 0-25% OUTSIDE AIR DAMPER, PROGRAMMABLE THERMOSTAT 3 TONS COOLING 120 MBH HEAT 1000 CFM @ 0.5" E.S.P. 480-30
RT-4	1 .	TRANE NO. YCD036C PACKAGE GAS FIRED ROOF TOP UNIT WITH CURB, 0-25% OUTSIDE AIR DAMPER, PROGRAMMABLE THERMOSTAT 3 TONS COOLING 120 MBH HEAT 900 CFM @ 0.5" E.S.P. 480-30
RT-5	1	TRANE NO. YCD036C PACKAGE GAS FIRED ROOF TOP UNIT WITH CURB, 0-25% OUTSIDE AIR DAMPER, PROGRAMMABLE THERMOSTAT 3 TONS COOLING 120 MBH HEAT 1050 CFM @ 0.5" E.S.P. 480-30
RT-6	2	TRANE NO. YCD036C PACKAGE GAS FIRED ROOF TOP UNIT WITH CURB, 0-25% OUTSIDE AIR DAMPER, PROGRAMMABLE THERMOSTAT 3 TONS COOLING 120 MBH HEAT 950 CFM @ 0.5" E.S.P. 480-30
RT-7		TRANE NO. YCDI20C PACKAGE GAS FIRED ROOF TOP UNIT WITH CURB, 0-25% OUTSIDE AIR DAMPER, PROGRAMMABLE THERMOSTAT IO TONS COOLING 205 MBH 2 STAGE HEAT 4000 CFM @ 0.75" E.S.P. 480-30
EF-I	. <b>L</b>	JENN FAN NO. JEB 12 BELT DRIVEN CENTRIFUGAL ROOF EXHAUSTER WITH CURB, BIRDGUARD, DISCONNECT SWITCH 675 CFM @ 0.75" E.S.P. 1/2" HP @ 120V
ILF-I	<b>1</b>	JENN FAN NO. JIB Ø6 BELT DRIVEN CENTRIFUGAL INLINE FAN WITH BACKDRAFT DAMPER, MOUNTING BRACKETS, DISCONNECT SWITCH 525 CFM @ Ø.6" E.S.P. 250 CFM @ 1.0" E.S.P. ½" HP @ 120V
F-1	1	FLANDERS NO. BF-I FILTER HOUSING WITH 6" RIGID-PACK, 95% ASHRAE EFFICIENCY PREFILTER, 12" HIGH CAPACITY 99.97% DOP EFFICIENCY HEPA FILTER, II" DEEP SEPARATORLESS MEDIA PACK, 12" DEEP 99.9% EFFICIENCY NUCLEAR GRADE CARBON ADSORBER AND 0-2" W.G. MAGNAHELIC AIR FILTER GAGE
BH-I	2	MARKEL NO. 8121 7" HIGH x 8' LONG WALL MOUNTED ELECTRIC FIN TUBE CONVECTOR WITH END CAPS, INTEGRAL THERMOSTAT \$ DISCONNECT, CLEAR ANODIZED FINISH 4 KW @ 208-10
BH-2	7	MARKEL NO. 8121 7" HIGH x 4' LONG WALL MOUNTED ELECTRIC FIN TUBE CONVECTOR WITH END CAPS, INTEGRAL THERMOSTAT \$ DISCONNECT, CLEAR ANODIZED FINISH 2 KW @ 208-10
RH-I	1	JENN FAN NO. RVG 200 RELIEF HOOD WITH 12"x12" NECK AND CURB
MD-I	2	CESCO NO. MDS 24"XIO" VOLUME CONTROL DAMPER
MD-2		CESCO NO. MDS 10"X10" VOLUME CONTROL DAMPER
MD-3	1	CESCO NO. MDS 12"x6" VOLUME CONTROL DAMPER
MD-4	. 1	CESCO NO. MDS 6"x6" VOLUME CONTROL DAMPER
MD-5	1	CESCO NO. MDS 14"x4" VOLUME CONTROL DAMPER

ANEMOSTAT NO. EPL 24"x24" STEEL LAY IN DIFFUSER WITH 8" @ NECK & VOLUME CONTROL DAMPER

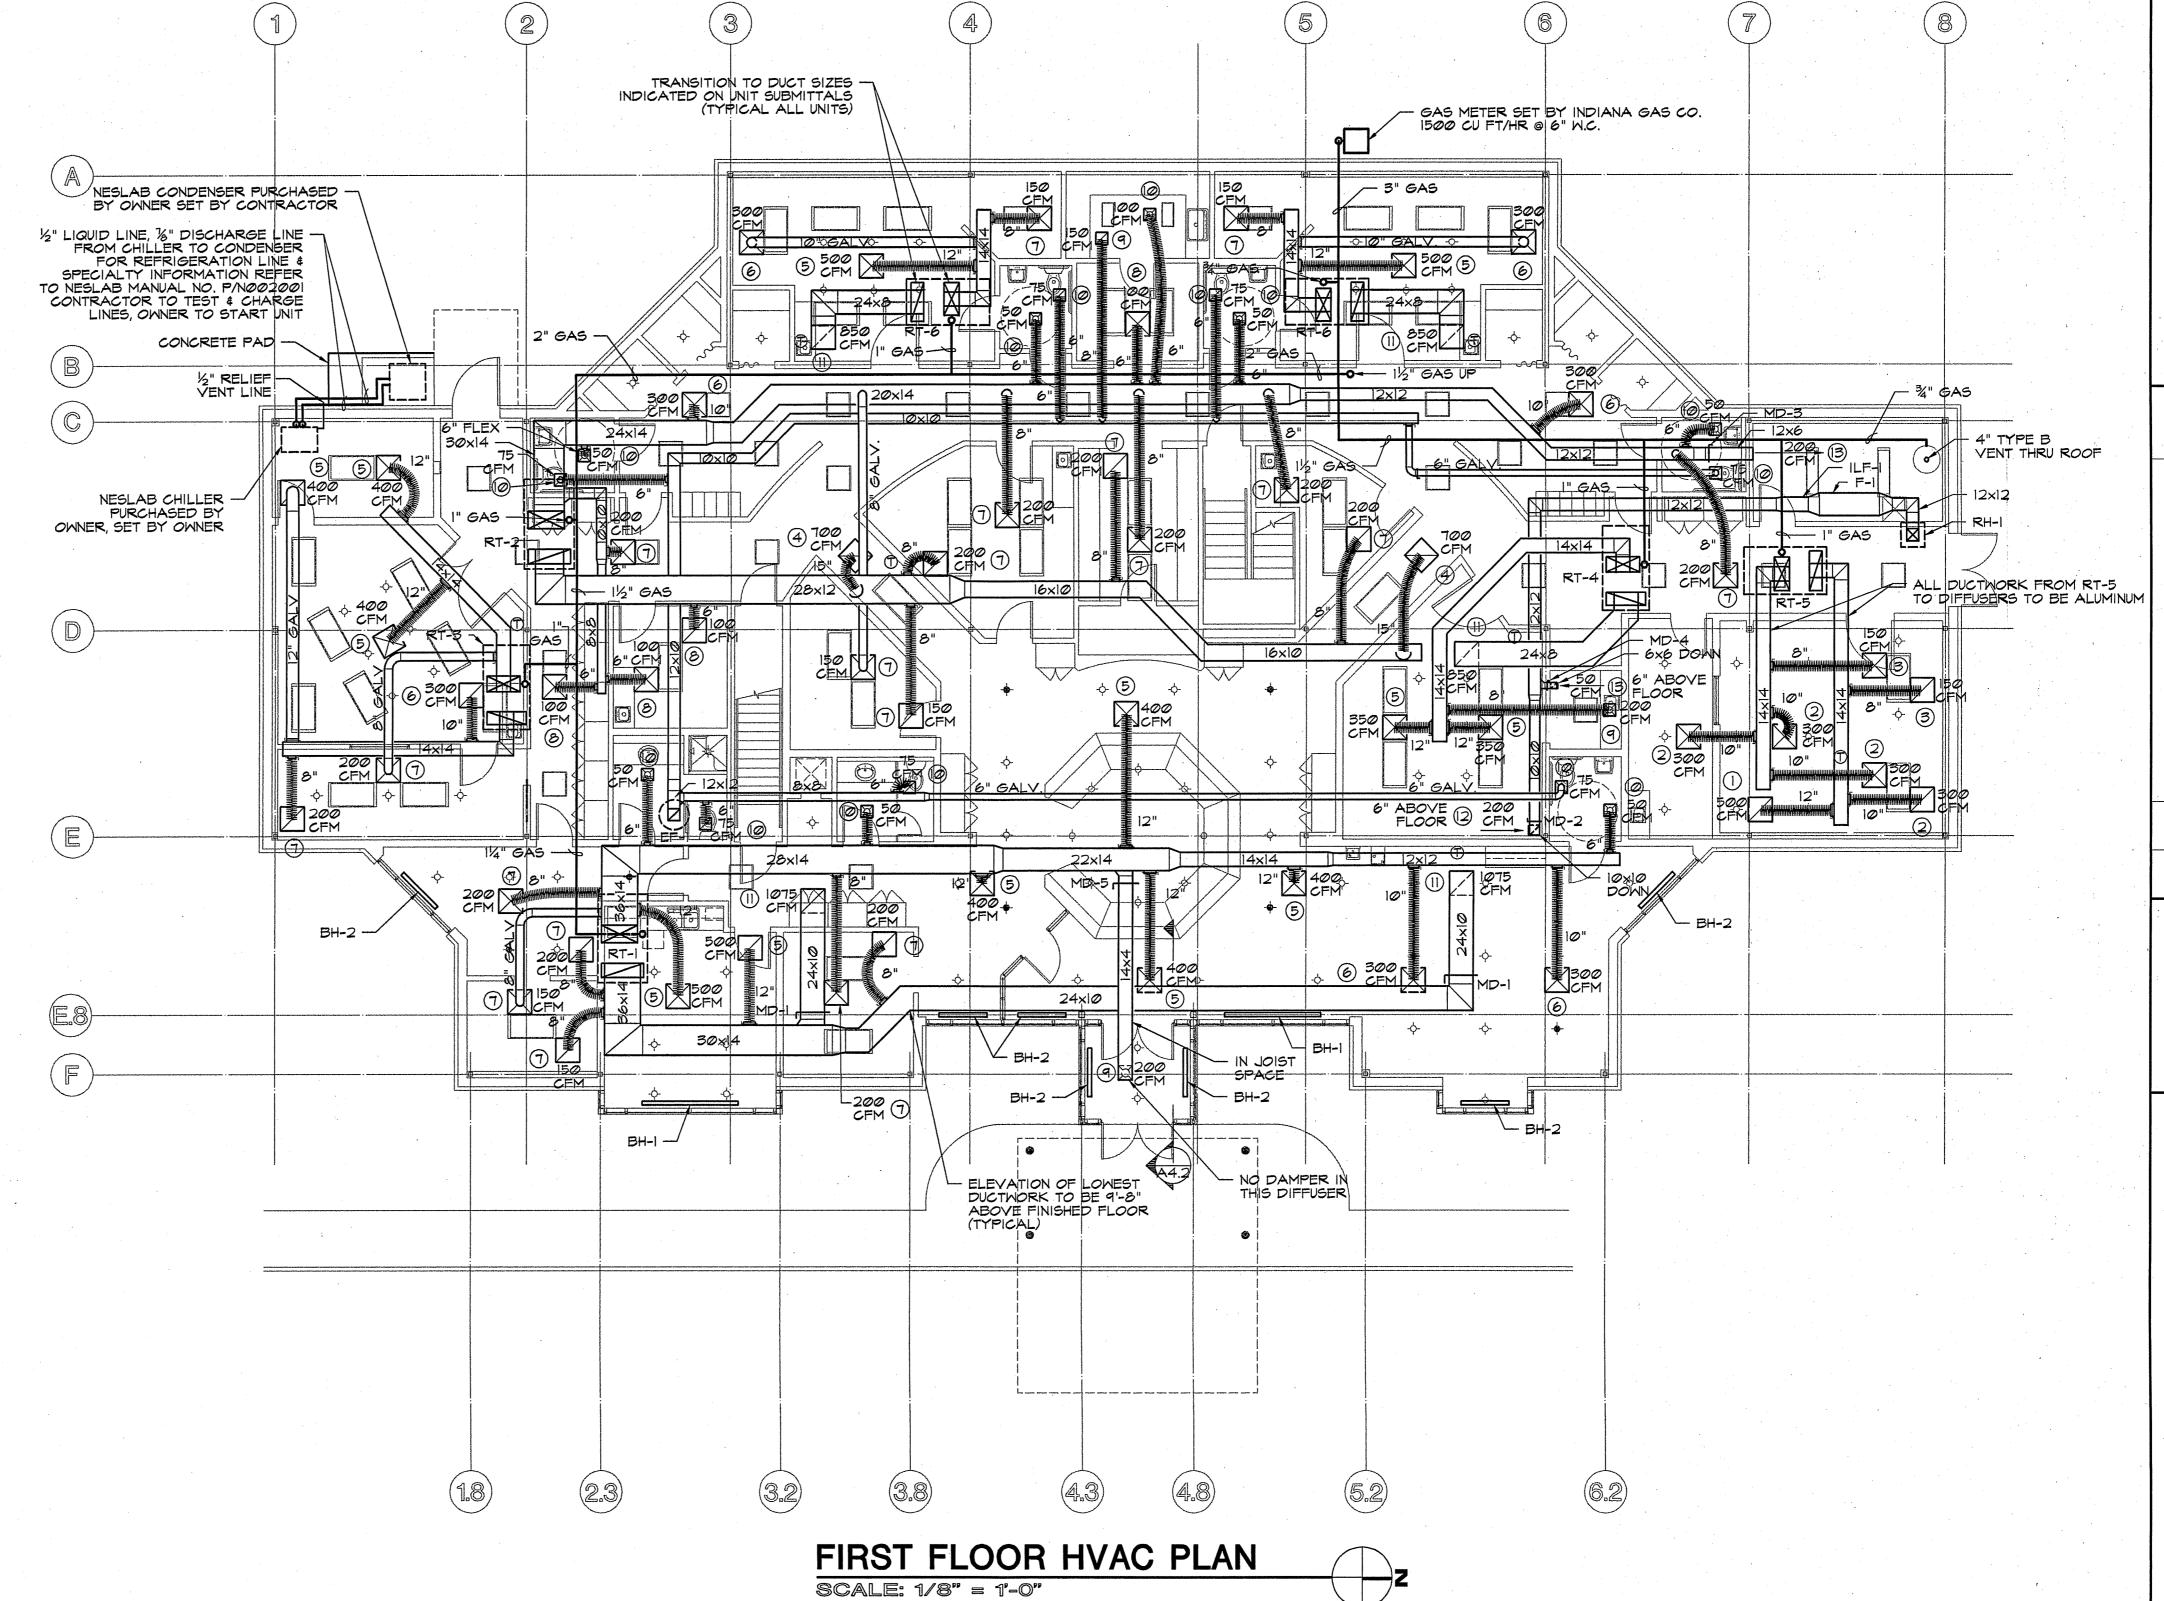

## DIFFUSER SCHEDULE

<u>NO.</u>	DESCRIPTION	NO.	DESCRIPTION
1	ANEMOSTAT NO. EPL 24"x24" ALUMINUM LAY IN DIFFUSER WITH 12" & NECK & VOLUME CONTROL DAMPER	a	ANEMOSTAT NO. EPL 24"x24" STEEL LAY IN DIFFUSER WITH 6" @ NECK & VOLUME CONTROL DAMPER
. 2	ANEMOSTAT NO. EPL 24"x24" ALUMINUM LAY IN DIFFUSER WITH 10" OP NECK & VOLUME CONTROL DAMPER	q	ANEMOSTAT NO. E-1 13.25"x13.25" STEEL SURFACE DIFFUSER WITH 8" O NECK & VOLUME CONTROL DAMPER
3	ANEMOSTAT NO. EPL 24"x24" ALUMINUM LAY IN DIFFUSER WITH 8" Ø NECK & VOLUME CONTROL DAMPER	10	ANEMOSTAT NO. E-1 13.25"x13.25" STEEL SURFACE DIFFUSER WITH 6" & NECK & VOLUME CONTROL DAMPER
4	ANEMOSTAT NO. EPL 24"x24" STEEL LAY IN DIFFUSER WITH 15" Ø NECK & VOLUME CONTROL DAMPER	11	ANEMOSTAT NO. GC5L 24"x24" LAY IN RETURN GRILLE  ANEMOSTAT NO. S2HO 8"W x 16"H RETURN GRILLE
5	ANEMOSTAT NO. EPL 24"x24" STEEL LAY IN DIFFUSER WITH 12" @ NECK & VOLUME CONTROL DAMPER	13	ANEMOSTAT NO. 93HD 5"W x 6"H RETURN GRILLE
6	ANEMOSTAT NO. EPL 24"x24" STEEL LAY IN DIFFUSER WITH 10" O NECK & VOLUME CONTROL DAMPER	14	ANEMOSTAT NO. 52HO 14"W x 12"H SUPPLY REGISTER

COLUMBUS IMAGING ASSOCIATE


COLUMBUS IMAGING ASSOCIATE

DWG. NO. 127/97

DATE

DATE

H1.1

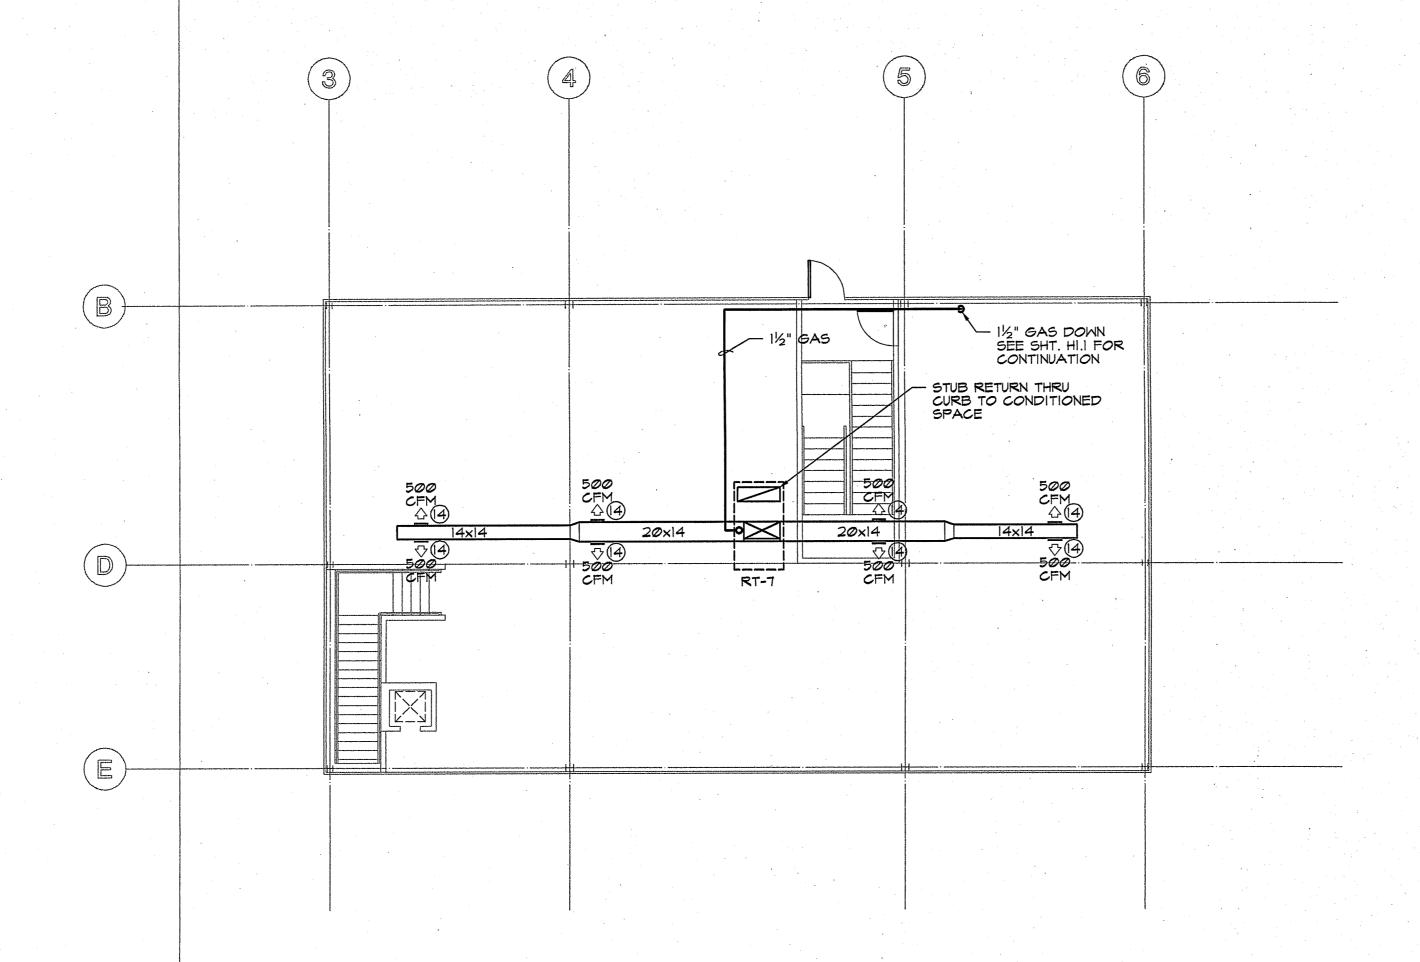

SECOND FLOOR HVAC PLAN

SCALE: 1/8" = 1'-0"

COLUMBUS, INDIANA

IMAGING CENTER

COLUMBUS, INDIANA


PROJ. NO. 4369-96

DWG. NO. 36996221

DATE 3/11/97

SHEET NO.

H2.1

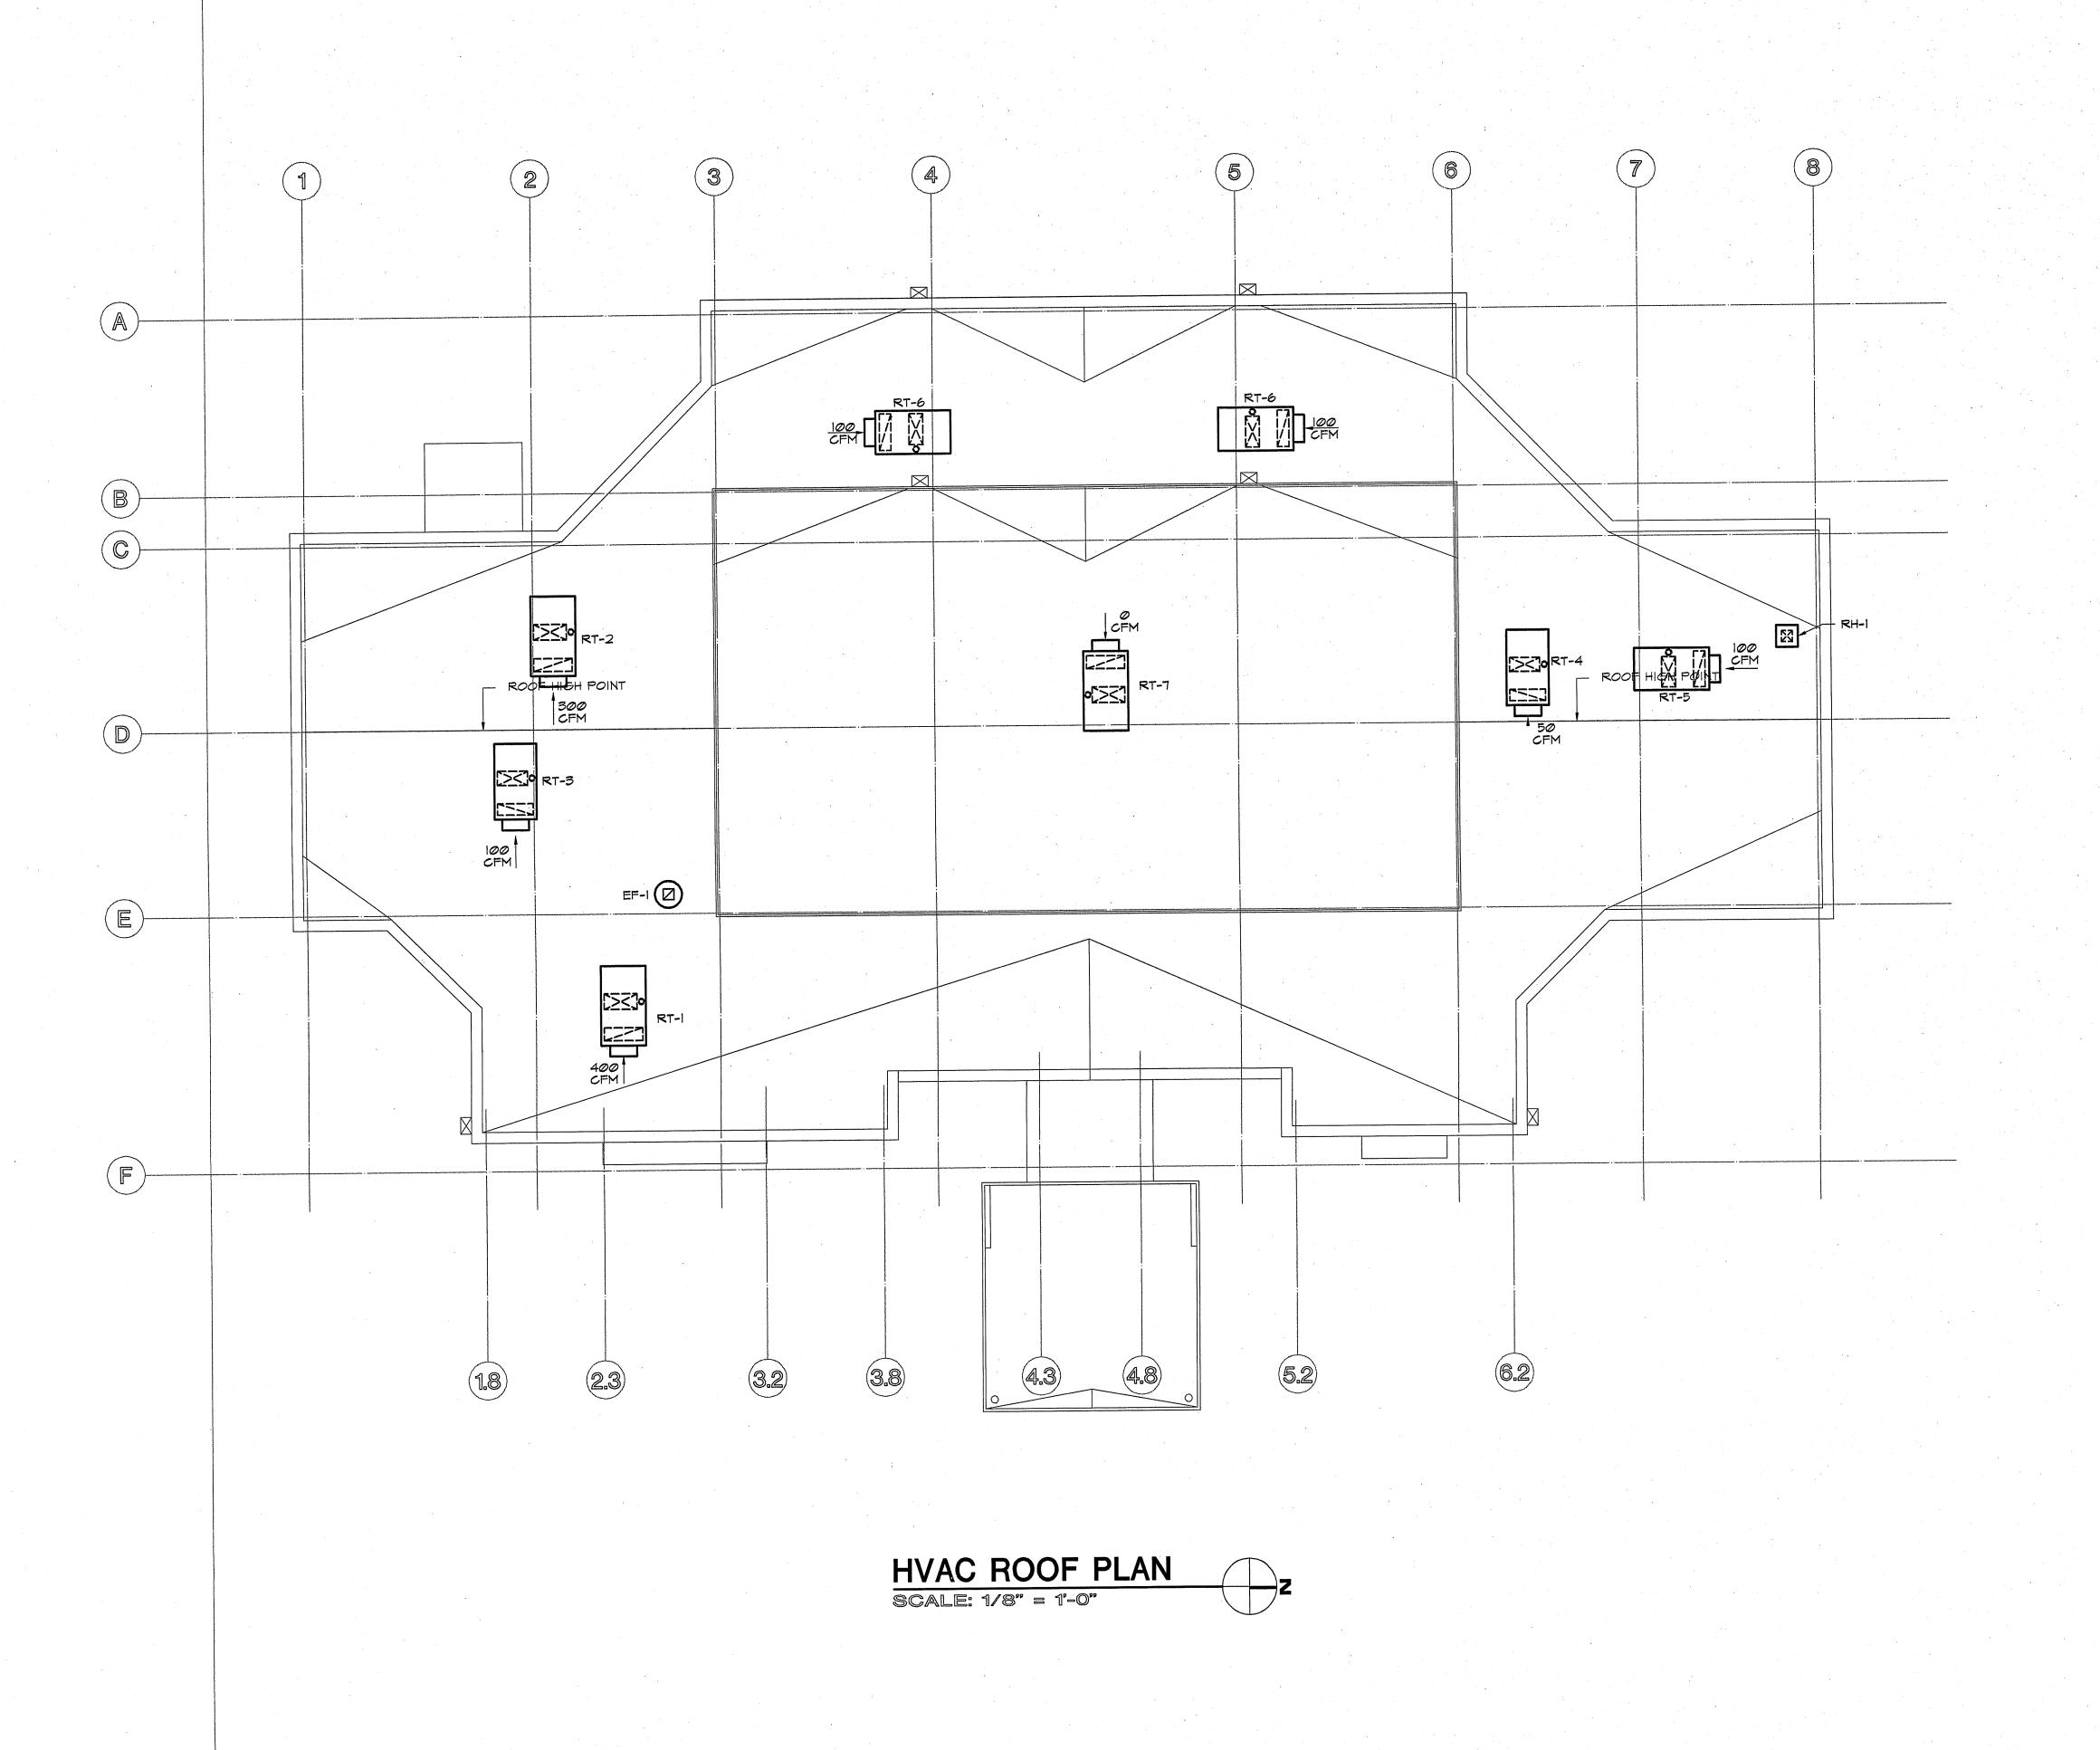

ASSOCIATES IMAGING CENTER

COLUMBUS, INDIANA

PROJ. NO. 4369-96 DWG. NO. 36996231

DATE 1/21/97 1/21/97 SHEET NO.

H3.1

## PLUMBING LEGEND

A.F.F.	ABOVE FINISHED FLOOR	SAN	SANITARY	WASTE
B.O.B. B.O.P.	BOTTOM OF BEAM BOTTOM OF PIPE	STM	STORM W	ATER
CB CI	CATCH BASIN CAST IRON		SANITARY	VENT
CO	CLEAN OUT	—-ф	BALL VAL	VE
DS DW	DOWNSPOUT DISHWASHER		BUTTERFL	Y VALVE
ET EWC	EXPANSION TANK ELECTRIC WATER COOLER		CHECK VA	ALVE
EHW FD	ELECTRIC WATER HEATER FLOOR DRAIN	——————————————————————————————————————	GATE VAI	VE
GC	GENERAL CONTRACTOR		ELBOW - I	
GD GPF	GARBAGE DISPOSER GALLONS PER FLUSH		ELBOW - 1	
GWH HB	GAS FIRED WATER HEATER HOSE BIBB		REDUCER	
IB IC	ICEMAKER BOX INSIDE CAULK		UNION	
IE KS	INVERT ELEVATION			  F VALVE
LAV	KITCHEN SINK LAVATORY	$\gamma$ $\sim$	141 1/11	- Y/LYL
MB MH	MOP BASIN MANHOLE	cs	COMBINA	ION SEWER
MV NH	MIXING VALVE NO HUB		POTABLE	COLD/CITY WATER
N.T.S.	NOT TO SCALE	HM	POTABLE	HOT WATER
OSD P	OPEN SITE DRAIN PUMP	HWR	POTABLE	HOT WATER RETURN
PC Pl	PLUMBING CONTRACTOR PRESSURE GAUGE			. •
PVC RC	PLASTIC PIPE ROOF CONDUCTOR			
RD	ROOF DRAIN			
RI RO	ROUGH-IN ROOF OVERFLOW			
RCP S	REINFORCED CONCRETE PIPE SINK			
SHR SS/EW	SHOWER COMBINATION SHOWER/EYEWASH			
T & P	TEMPERATURE & PRESSURE			
TDH TI	TOTAL DISCHARGE HEAD TEMPERATURE GAUGE	• •		
T.O.F. T.O.P.	TOP OF FOOTING TOP OF PIPE			
TYP. U.N.O.	TYPICAL UNLESS NOTED OTHERWISE			•
UR	URINAL			
V.I.F. VIT	VERIFY IN FIELD VITREOUS CLAY			
VTR WC	VENT THRU ROOF WATERCLOSET			
WF	WASHFOUNTAIN			
MH MCO	WALL HYDRANT WALL CLEANOUT			
ИНА И.О.Б.	WATER HAMMER ARRESTOR WATER, OIL, GAS			
ΥH	YARD HYDRANT			
		• .		

## PLUMBING NOTES

- I. IT IS THE INTENT OF THESE SPECIFICATIONS TO COVER FIRST CLASS WORKMANSHIP THROUGHOUT. PERSONNEL SHALL BE THOROUGHLY TRAINED AND EXPERIENCED IN THE PRODUCTS INVOLVED AND IN RECOMMENDED METHODS FOR THEIR FABRICATION AND INSTALLATION. NO ALLOWANCE SHALL BE MADE FOR LACK OF SKILL ON THE PART OF THE WORKMAN IN THE ACCEPTANCE AND/OR REJECTION OF COMPLETED WORK.
- 2. MATERIALS AND EQUIPMENT SHALL BE NEW AND INSTALLED AS INDICATED ON THE DRAWINGS AND/OR SPECIFICATIONS. THEY SHALL BE INSTALLED PLUMB, LEVEL AND TRUE-TO-LINE WITH ADJACENT WORK. WHERE INSTALLATION METHODS ARE NOT SPE CIFICALLY COVERED BY THE DRAWINGS AND/OR SPECIFICATIONS, FIRST CLASS TRADE PRACTICES AND MANUFACTURER'S INSTRUCTIONS AND RECOMMENDATIONS SHALL GOVERN.
- 3. CAREFULLY EXAMINE ALL ARCHITECTURAL, STRUCTURAL, PLUMBING, HVAC, FIRE PRO-TECTION, AND ELECTRICAL DRAWINGS PERTAINING TO THE CONSTRUCTION. COOPERATE WITH OTHER TRADES IN LOCATING DUCTWORK, PIPING, EQUIPMENT, ETG., IN ORDER TO AVOID CONFLICT WITH OTHER TRADE'S WORK. NO CLAIM FOR COSTS WILL BE ALLOWED FOR RELOCATING EQUIPMENT, PIPING, DUCTWORK, ECT., THAT INTERFERES WITH OTHER
- 4. PLUMBING CONTRACTOR SHALL KEEP ACCURATE RECORDS OF ALL UNDERGROUND AND CONCEALED PIPING AND EQUIPMENT WHICH DEVIATED FROM DRAWINGS. AT COMPLETION OF WORK, CONTRACTOR SHALL PRESENT TO THE OWNERS REPRESENTATIVE A MARKED SET OF DESIGN PRINTS INDICATING CHANGES.
- 5. MANUFACTURERS SPECIFIED FOR PLUMBING FIXTURES, EQUIPMENT, AND ACCESSORIES ARE TO ESTABLISH STANDARD QUALITY REQUIRED FOR THIS PROJECT. OTHER MANUFACTURERS WILL BE CONSIDERED FOR APPROVAL. SUBMIT (6) COPIES OF SHOP DRAWINGS TO THE ENGINEER.
- 6. VERIFY EXACT FIXTURE CARRIERS WITH CARRIER MANUFACTURER.
- 7. ALL VITREOUS CHINA PLUMBING FIXTURES SHALL BE FURNISHED IN WHITE COLOR.
- 8. TOILET ROOM ACCESSORIES SHALL BE FURNISHED AND INSTALLED BY THE GENERAL CONTRACTOR.
- 9. INSULATE ALL LAVATORY "LAV-I & LAV-2" P-TRAP & ANGLE VALVE ASSEMBLIES WITH TRUEBRO, HANDI LAV-GUARD INSULATION KIT, MODEL #102, (OR APPROVED EQUAL), WHITE COLOR WITH 3-PIECE INTERLOCKING TRAP ASSEMBLY \$ 2-PIECE INTERLOCKING ANGLE VALVE ASSEMBLIES. FASTENERS SHALL BE NYLON-TYPE SUPPLIED WITH KIT.
- 10. INSTALL PROPER ADAPTORS AT CHANGES IN PIPING MATERIALS.
- 11. INSTALL DIELECTRIC UNIONS/COUPLINGS OR INSULATED FLANGE KITS AT ALL JUNCTIONS OF DISSIMILAR METAL PIPING SYSTEMS
- 12. SHOP DRAWINGS ARE REQUIRED FOR EACH STYLE AND TYPE OF VALVE USED FOR THIS PROJECT. ALL VALVES FOR THE SAME USE SHALL BE FROM ONE MANUFACTURER.
- 13. ALL VALVES SHALL BE INSTALLED IN LOCATIONS WHERE THEY ARE ACCESSIBLE AND ABLE TO BE OPERATED AND MAINTAINED.
- 14. INSTALL INDIVIDUAL SHUTOFF VALVES AND UNIONS AT ALL PIECES OF EQUIPMENT AND PLUMBING FIXTURES.
- 15. PROVIDE P-TRAP WITH 2" MINIMUM TRAP SEAL AT FLOOR DRAINS, FORM TRAP W/ RETURN BEND AND LONG RADIUS ELL. SET FLOOR DRAINS 1/8" LOWER THAN FINISHED FLOOR.
- 16. PROVIDE POLISHED CHROME SUPPLIES, STOPS, \$ 17 GAUGE CAST BRASS P TRAP WITH CLEANOUT AT PLUMBING FIXTURES.
- 17. DRAWINGS ARE DIAGRAMMATIC AND INDICATE GENERAL ARRANGEMENT OF PIPING, ETC. DO NOT SCALE DRAWINGS. THE EXACT LOCATION AND/OR ROUTING OF PIPING, ETC., UNLESS SPECIFICALLY DIMENSIONED ON THE DRAWINGS, SHALL BE DETERMINED IN THE FIELD. MAKE REASONABLE MODIFICATIONS IN THE INSTALLATION SO ALL PIPING, ETC. FIT PROPERLY AND CAN BE SERVICED.

## FIXTURE & ACCESSORY SCHEDULE

- ZURN #ZN-415-NH/IC/NL "FLOOR & SHOWER DRAIN", DURICOATED C.I., BODY WITH BOTTOM OUTLET, COMBINATION INVERTIBLE MEMBRANE CLAMP & ADJUSTABLE COLLAR, TYPE B POLISHED NICKEL BRONZE 6" DIA. STRAINER, NO HUB OUTLET/INSIDE CAULKINEO-LOC.
- AMERICAN STANDARD #0476.028 "AQUALYN" SELF-RIMMING, 20"x17", COUNTERTOP VITREOUS CHINA LAVATORY WITH 4" FAUCET CENTERS. PROVIDE #5402.172Y.002 POLISHED CHROME FAUCET WITH 4" WRIST BLADE HANDLES & GRID DRAIN. MOUNT FIXTURE 34" FLOOR TO RIM IN COUNTERTOP & WITHIN 2" OF THE FRONT EDGE OF THE COUNTERTOP
- AMERICAN STANDARD #0355.012 "LUCERNE" 20"x18", WALL HUNG, VITREOUS CHINA LAVATORY WITH WALL HANGER/CONCEALED ARMS SUPPORT & 4" FAUCET CENTERS. PROVIDE #5402.172V.002 POLISHED CHROME FAUCET WITH 4" WRIST BLADE HANDLES, GRID DRAIN # J.R. SMITH LAVATORY CARRIER. MOUNT FIXTURE 34" FLOOR TO RIM TO PROVIDE HANDICAPPED ACCESS.
- AMERICAN STANDARD #2174.139 "CADET II EL 1.6" ELONGATED TOILET, 1.6 GPF, 12" RI, WHITE VITREOUS CHINA, ENLONGATED 14 1/2" HIGH TOILET. PROVIDE BEMIS #1955-SSC WHITE ENLONGATED OPEN FRONT SEAT.
- AMERICAN STANDARD #2216.143 "CADET II 16-1/8"H EL 1.6" ELONGATED TOILET, 1.6 GPF, 12" RI, WHITE VITREOUS CHINA, ENLONGATED 16 1/8" HIGH TOILET TO PROVIDE HANDICAPPED ACCESS. PROVIDE BEMIS #1955-SSC WHITE ENLONGATED OPEN FRONT SEAT.
- JUST #SL-2119-B-GR "STYLIST GROUP B" 20 GAUGE, 21"x19"x7" DEEP, TYPE 304 STAINLESS STEEL, SELF RIMMING, SINGLE COMPARTMENT SINK WITH #J-35 CUP STRAINER # #J-1174 KS CONCEALED MIXING FAUCET WITH 6 1/2" CHROME PLATED SWIVEL GOOSENECK SPOUT WITH AERATOR AND 4" CHROME PLATED CAST BRASS WRIST BLADE HANDLES WITH HOT/COLD HANDLE INDEXES. SINK HOLE PUNCHING SHALL MATCH FAUCET & STRAINER. MOUNT FIXTURE 36" FLOOR TO RIM IN COUNTERTOP.
- JUST #DL-2133-B-GR "STYLIST GROUP B" 20 GAUGE, 21"x33"x7" DEEP, TYPE 304 STAINLESS STEEL, SELF RIMMING, DOUBLE COMPARTMENT SINK WITH #J-35 CUP STRAINER # #J-1174 KS CONCEALED MIXING FAUCET WITH 6 1/2" CHROME PLATED SWIVEL GOOSENECK SPOUT WITH AERATOR AND 4" CHROME PLATED CAST BRASS WRIST BLADE HANDLES WITH HOT/COLD HANDLE INDEXES. SINK HOLE PUNCHING SHALL MATCH FAUCET & STRAINER. MOUNT FIXTURE 36" FLOOR TO RIM IN COUNTERTOP.
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- PVC CLEANOUT PLUG. PROVIDE EAST JORDAN #1570/#1578 CLEANOUT COVER AND ENCASE IN CONCRETE PAD 12"x12"x8" THICK.
- ZURN #ZN-1400-NH/IC/NL "LEVELTROL" ADJUSTABLE FLOOR CLEANOUT, DURICOATED C.I. BODY, POLISHED NICKEL BRONZE TOP, NO HUB OUTLET/INSIDE CAULK/NEO-LOC.
- POWERS-FIAT #MSB-2424 ONE PIECE MOLDED STONE, 24"x24"x10" WITH 3" IPS DRAIN, #E-77-AA VINYL BUMPERGUARD, #832-AA HOSE & BRACKET, #889-CC MOP MOP HANGER, #219 WHITE WITH BLACK ACCENTS COLOR. PROVIDE CHICAGO #897 FAUCET WITH VACUUM BREAKER & INTEGRAL STOP ARMS, OR CHICAGO #835 FUACET WITH VACUUM BREAKER & EXPOSED VALVE FOR SUPPLIES FROM CEILING MOUNT FAUCET 36" FLOOR TO VALVE CENTERLINE, HOSE BRACKET 18" FLOOR TO TO BRACKET CENTERLINE, AND MOP HANGER 54" FLOOR TO HANGER CENTERLINE.
- PLASTIC ODDITIES #IB-20 BOX, FRAME, CONNECTION ADAPTER, I/4" O.D. COMPRESSION VALVE. PROVIDE BALL BALVE SHUTOFF IN SUPPLY LINE.
- OASIS #M85CPM "BARRIER FREE BI-LEVEL MODULAR WATER COOLER", 8.0 GPH OF MODULAR 50°F DRINKING WATER AT 90°F AMBIENT AIR TEMPERATURE, 1/5 HP COMPRESSOR, 115/60/1 STAINLESS STEEL FINISH, BUBBLER ACTIVATED BY MECHANICAL PUSH BUTTON. MOUNT FIXTURE WITH LOWER FOUNTAIN 36" MAXIMUM FLOOR TO SPOUT OUTLET \$ 27" MINIMUM FLOOR TO BOTTOM OF LOWER FOUNTAIN TO PROVIDE HANDICAPPED ACCESS.
- A.O. SMITH MODEL #BT-100 "TANK-TYPE" COMMERCIAL GAS WATER HEATER, 100 GAL EQUIPPED TO BURN NATURAL GAS, INPUT RATING @ 80,000 BTU/HR, & A RECOVERY CAPACITY OF 72 GPH @ A TEMPERATURE RISE OF 100°F, MEETS ASHRAE 90A-1980. PROVIDE ASME RELIEF VALVE & PIPE DISCHARGE TO FLOOR DRAIN.
- BELL & GOSSETT #SLC-25B "UPSTART" WITH BRONZE BODY CONSTRUCTION, FLANGED ENDS, 3 GPM AT 10 FT. HEAD, 1/25 HP MOTOR, 115/60/1. FURNISH HONEYWELL #L6006C AQUASTAT CONTROLLER, WITH STRAP ON MOUNTING SENSING ELEMENT, SPDT SWITCH, 63°F-200°F RANGE, CIRCULATOR CONTROL, 120/60/1 AND 3/4" ACUSETTER #AS-0755 BRONZE/BRASS BALANCING/SHUT OFF VALVE, SWEAT ENDS, 1.5-13 GPM FLOW RATE, CV = 8.0. SET OUTLET AT 3 GPM.
- AMTROL #ST-12 "THERM-X-TROL" THERMAL EXPANSION ABSORBER, 4.4 GALLON TOTAL INSTALL TANK PER MANUFACTURER'S INSTALLATION PROCEDURE.
- TRERICE # B85602-4 BIMETAL THERMOMETER WITH 5" DIAL, I/2" NPT REAR CONNECTION, ADJUSTABLE ANGLE, 2-1/2" STEM, O°F TO 200°F RANGE. PROVIDE THERMOWELL.
- SYMMONS # 5-200A-W-RC "TEMPCONTROL VALVE AND PIPING ASSEMBLY" THERMOSTATIC CONTROLLER WITH SWIVEL ACTION CHECK STOPS, 3/4" INLETS x 3/4" OUTLET, I5 GPM AT 15 PSI DIFFERENTIAL, 3" FACE, 20°F - 240°F BIMETAL DIAL THERMOMETER, VOLUME CONTROL SHUTOFF VALVE, ROUGH CHROME FINISH WITH WALL MOUNTING BRACKET AND SPARE CARTRIDGE. SET OUTLET TEMPERATURE AT 110°F. MOUNT VALVE 32" A.F.F.
- IN-SINK-ERATOR #333/SS 1/2 HP MOTOR, 120/60/I, CONTINUOUS FEED OPERATION, DISHWASHER DRAIN CONNECTION, STAINLESS STEEL CONSTRUCTION.
- WOODFORD #65C EXPOSED AUTOMATIC DRAINING, FREEZELESS WALL HYDRANT WITH VACUUM BREAKER, 3/4" HOSE THREAD OUTLET, 3/4" COPPER WATER TUBE INLET, CHROME FINISH AND LENGTH AS REQUIRED FOR WALL THICKNESS. FURNISH OWNER WITH KEY STOP MOUNT HYDRANT 36" FLOOR TO BOTTOM OF BOX UNLESS NOTED OTHERWISE.
- UNIVERSAL-RUNDLE #U-R-6206T/U-R-6207T "SUMMIT 36 SM SHOWER STALL", 38" ONE-PIECE FIBERGLASS HANDICAPPED SHOWER WITH SEAT & GRAB BAR, WHITE COLOR. PROVIDE SYMMONS #S-96-300X-B30-L-V "HAND SPRAY" SHOWER UNIT (2.5 GPM) WITH 60" FLEXIBLE HOSE. ALL CONTROLS & FAUCETS SHALL BE MOUNTED ON THE SIDE WALL OPPOSITE THE SEAT. MOUNT WALL/HAND SHOWER 27" MAX. FROM RIGHT HAND (LEFT HAND SIDE FOR OPPOSITE HAND) & 43" FLOOR TO BOTTOM OF 30" SLIDE BAR, MOUNT SHOWER VALVE 43" FLOOR TO VALVE CENTERLINE.
- (SUPPLIED BY OWNER)

(SUPPLIED BY OWNER) MAKER

## PIPING SPECIFICATIONS

#### POTABLE WATER

PIPE:

WROUGHT COPPER, SOLDER JOINT, ANSI BI6.22. JOINTS SHALL

WROUGHT COPPER, SOLDER JOINT, ANSI BI6.22. JOINTS SHALL

600LB W.O.G. SOLDER ENDS, STANDARD PORT, BRONZE BODY, CHROMIUM PLATED BALL, REINFORCED TFE SEATS, APOLLO

SCH 40, PVC-DWV, PLAIN END, ASTM D-2665.

#### FITTINGS:

6" & SMALLER:

BELOW GRADE: BURIED BEYOND 5'-O" OF BUILDING: MATCH WEIGHT & TYPE OF PIPE. JOINTS SHALL BE MADE USING

PRIMER & SOLVENT CEMENT IN ACCORDANCE TO MANUFACTURE'S RECOMMENDATIONS. BELOW GRADE:

BURIED WITHIN 5'-O" OF BUILDING: MATCH WEIGHT & TYPE OF PIPE. JOINTS SHALL BE MADE USING PRIMER & SOLVENT CEMENT IN ACCORDANCE TO MANUFACTURE'S

RECOMMENDATIONS. ABOVE GRADE: MATCH WEIGHT & TYPE OF PIPE. JOINTS SHALL BE MADE USING

PRIMER & SOLVENT CEMENT IN ACCORDANCE TO MANUFACTURE'S RECOMMENDATIONS.

#### INSULATION

ALL PIPE INSULATION, ADHESIVES, JACKETS, SEALERS AND TAPES SHALL CONFORM TO NFPA 90A AND SHALL NOT EXCEED FLAME SPREAD RATING OF 25 AND SMOKE DEVELOPED RATING OF 50.

INSULATE ALL ABOVE GRADE POTABLE HOT & COLD WATER PIPING W/ 1/2" THICK FLEXIBLE FORMED ELASTOMERIC INSULATION HAVING A "K" FACTOR OF 0.28 AT A MEAN TEMPERATURE OF 75 DEG F

INSULATE ALL ABOVE GRADE HORIZONTAL SANITARY PIPING IN CEILING WITH I" THICK HIGH DENSITY FIBERGLASS INSULATION HAVING A "K" FACTOR OF 0.24 AT A MEAN TEMPERATURE OF 15 DEG F.

NO PIPING SHALL BE INSULATED UNTIL PRESSURE & LEAK TESTED AND APPROVED

#### FIBERGLASS INSULATION


OWENS-CORNING FIBERGLASS #ASJ/SSL II (OR APPROVED EQUAL) INSTALLED IN ACCORDANCE WITH THE MANUFACTURER'S INSTALLATION SPECIFICATIONS.

#### FLEXIBLE ELASTOMERIC INSULATION

ARMSTRONG "AP ARMAFLEX" (OR APPROVED EQUAL) INSTALLED IN ACCORDANCE WITH THE MANUFACTURER'S SPECIFICATIONS.

'ROJ. NO. 4369-96 DWG. NO. 36996311 11/26/96 SHEET NO.

2" & SMALLER: BELOW GRADE: SOFT, TYPE K COPPER, PLAIN END, ASTM B-88. ABOVE GRADE: HARD, TYPE L COPPER, PLAIN END, ASTM B-88. FITTINGS: 2" & SMALLER: BELOW GRADE BE SOLDERED WITH LEAD FREE, 95-5, TIN-ANTIMONY, ASTM B-32. BE SOLDERED WITH LEAD FREE, 95-5, TIN-ANTIMONY, ASTM B-32. VALVES: BALL VALVES: 2" & SMALLER: 70-200 SERIES OR APPROVED EQUAL <u>UNIONS:</u> 2" & SMALLER: WROUGHT COPPER, SOLDER JOINT, ANSI BI6.22. INSULATING UNIONS: DIELECTRIC INSULATING UNION, COPPER TO STEEL SANITARY WASTE & VENT PIPE: 6" & SMALLER: BELOW GRADE: BURIED BEYOND 5'-O" OF BUILDING: SCH 40, PVC-DWV, PLAIN END, ASTM D-2665. BELOW GRADE: BURIED WITHIN 5'-O" OF BUILDING: SCH 40, PVC-DWV, PLAIN END, ASTM D-2665.

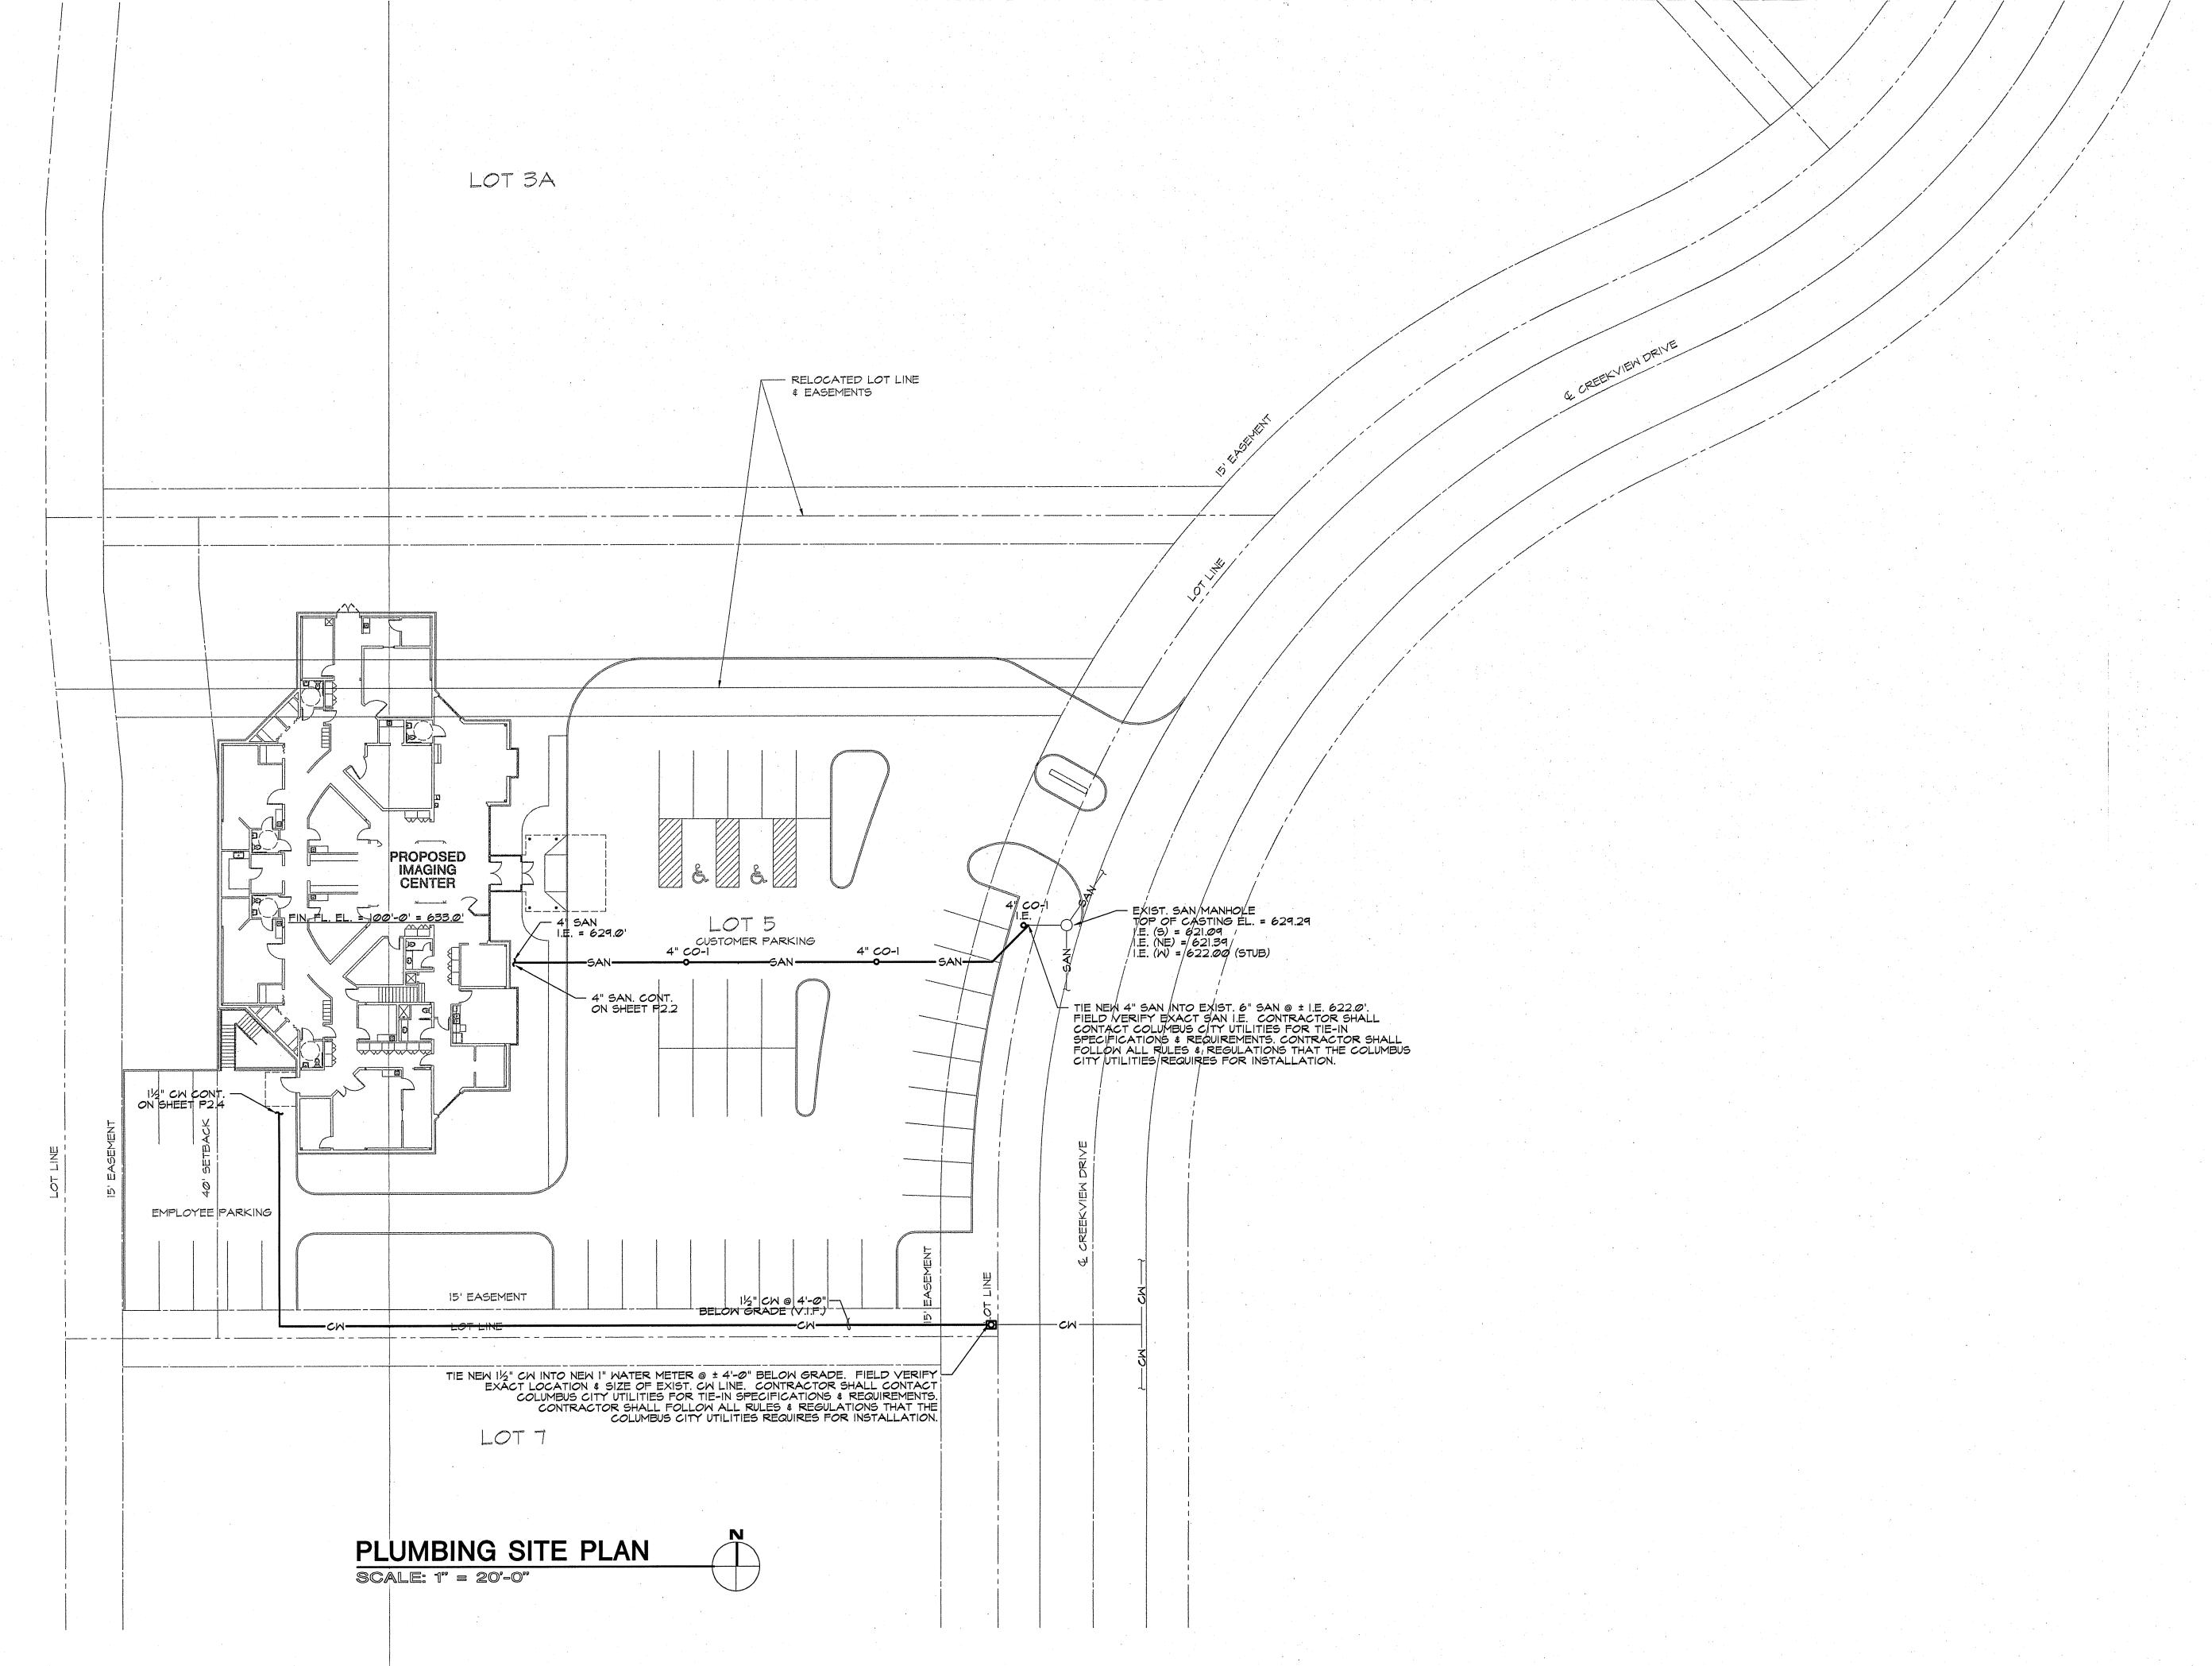

		3/2	2/2	DA
	•	ISSUED FOR ADDEDUM	ISSUED FOR STATE REVIEW	DESCRIPTION
				APPD .
		_	0	ISSUE APPD
· v				


IMAGING CENTER

COLUMBUS, INDIANA

COLUMBUS, INDIANA

PROJ. NO. 4369-96 DWG. NO. 36996321

12/30/96 SHEET NO.

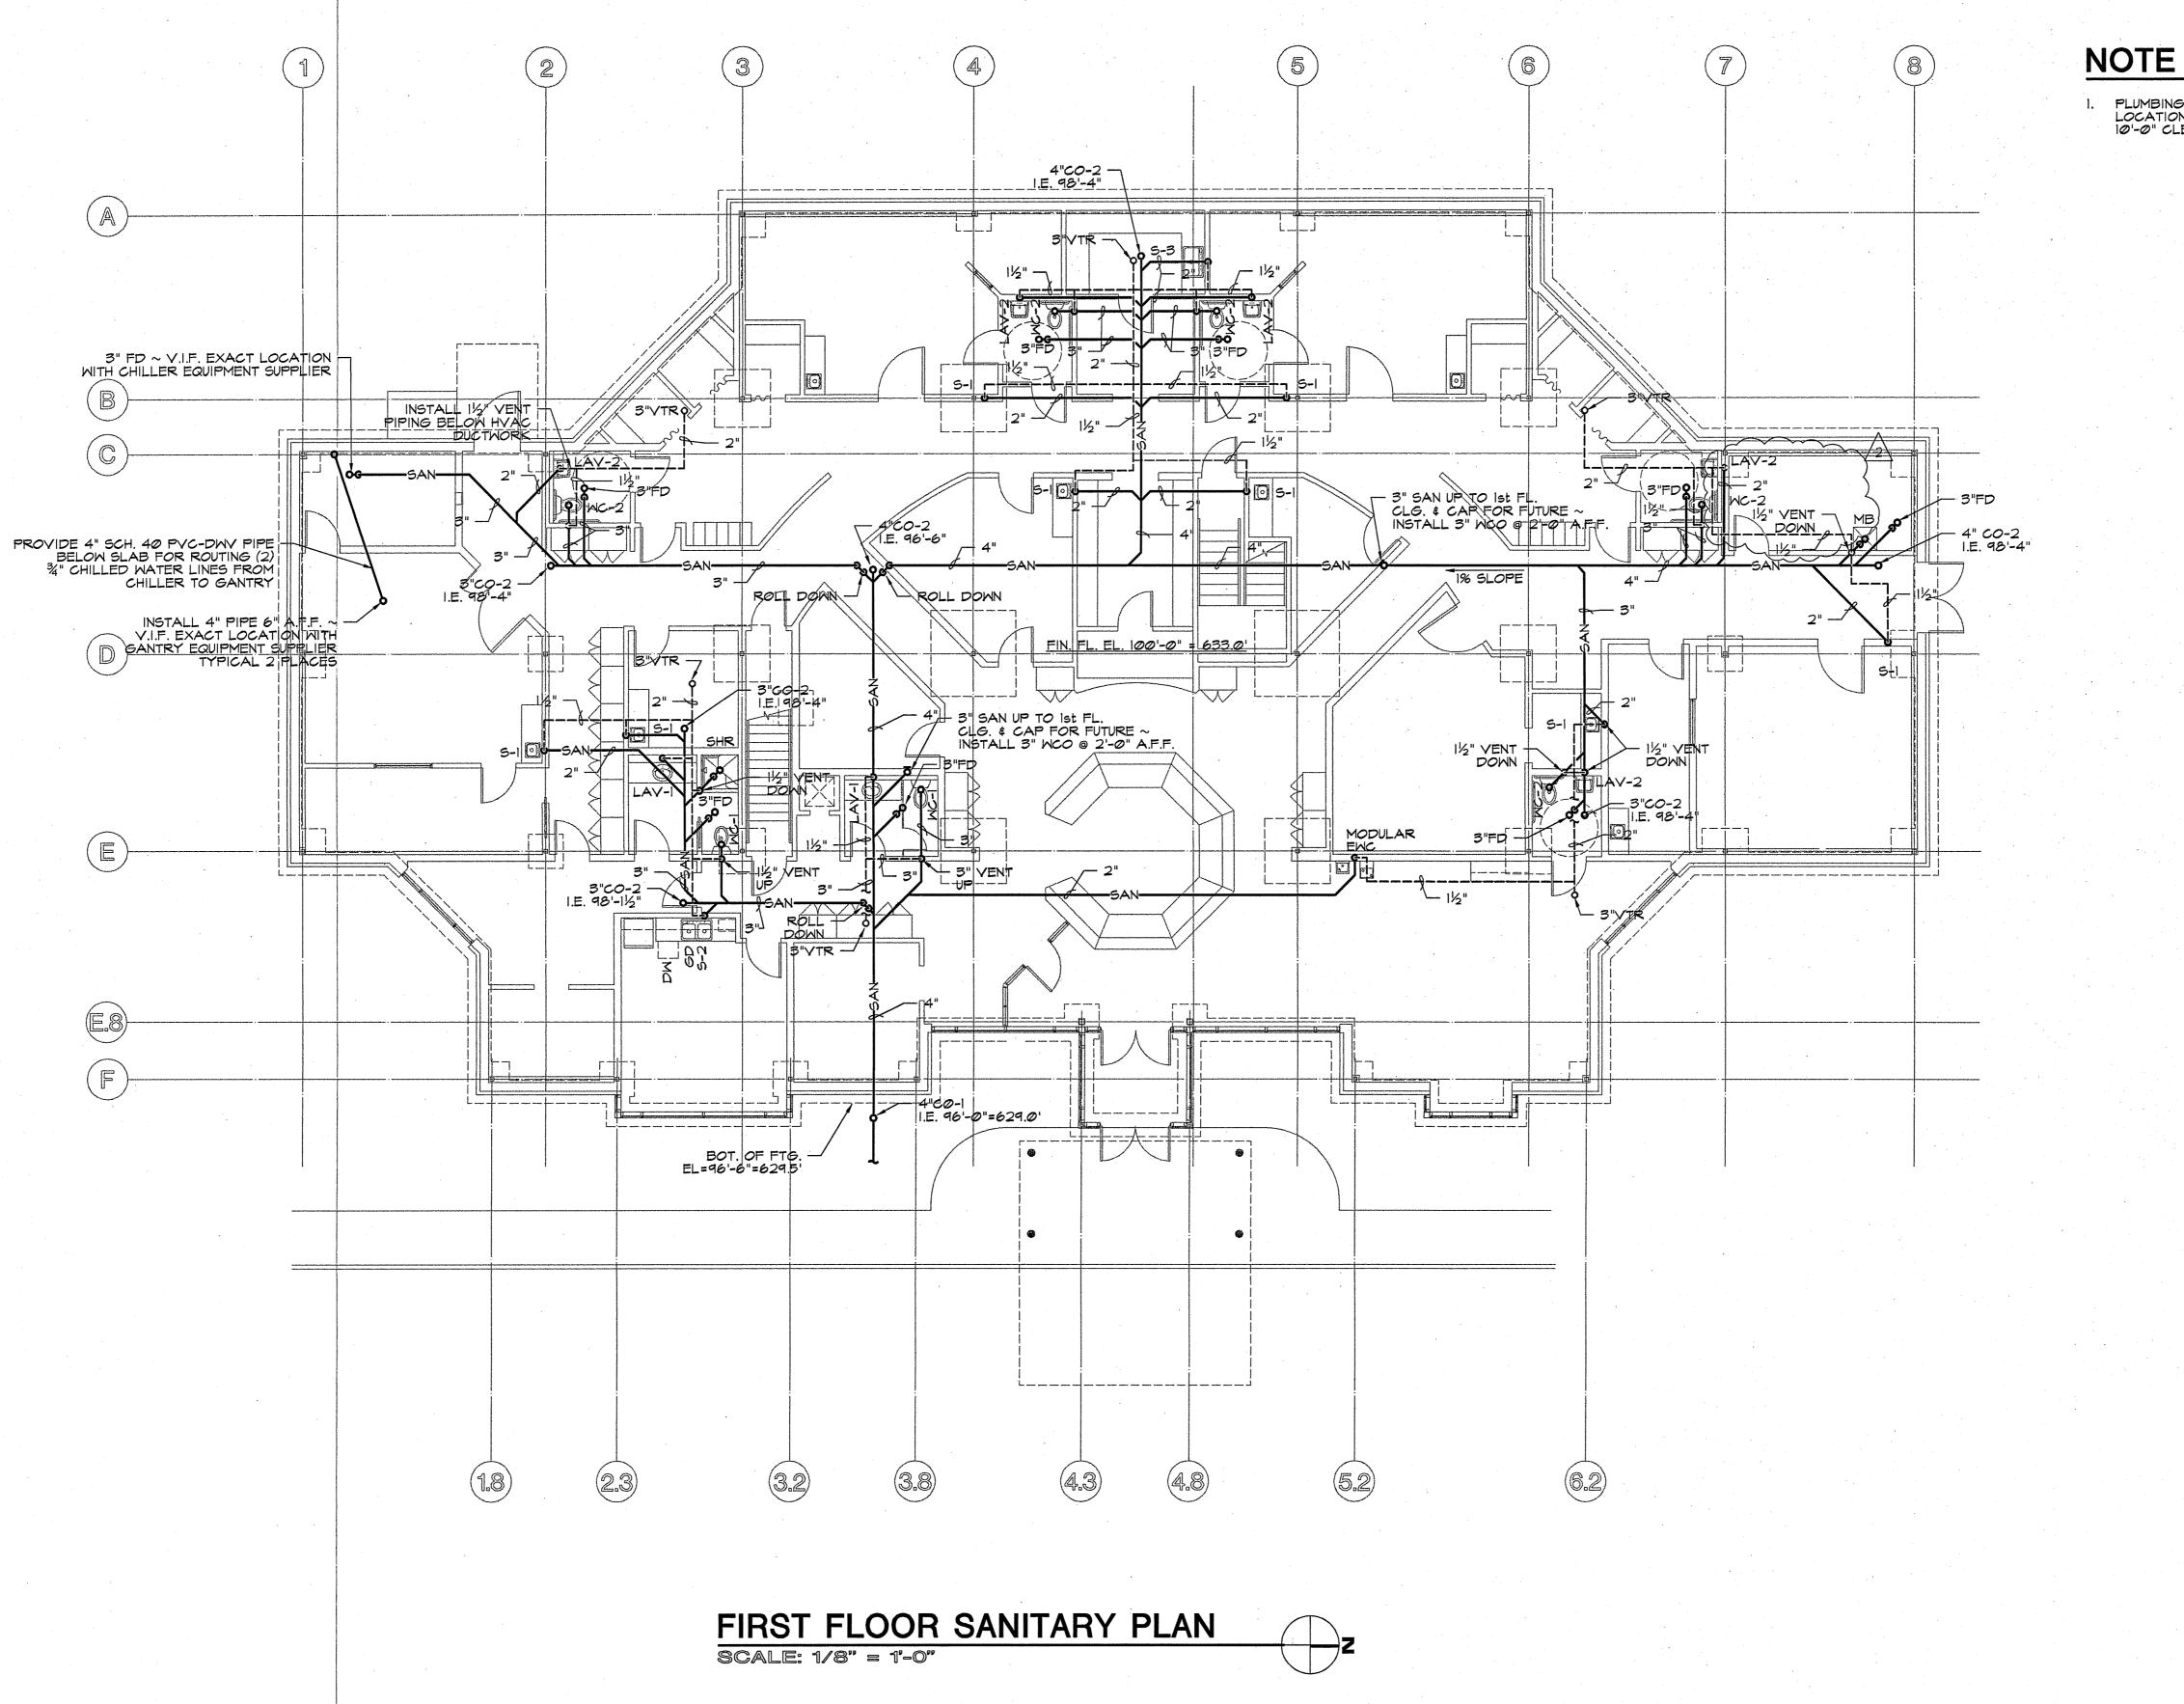

PLUMBING CONTRACTOR SHALL FIELD VERIFY EXACT LOCATION OF VENT THRU ROOF TO MAINTAIN MINIMUM 10'-0" CLEARANCE FROM HVAC ROOFTOP UNITS.


ASSOCIATES IMAGING CENTER

COLUMBUS, INDIANA


COLUMBUS, INDIANA

PROJ. NO. 4369-96 36996322 12/11/96

P2.2

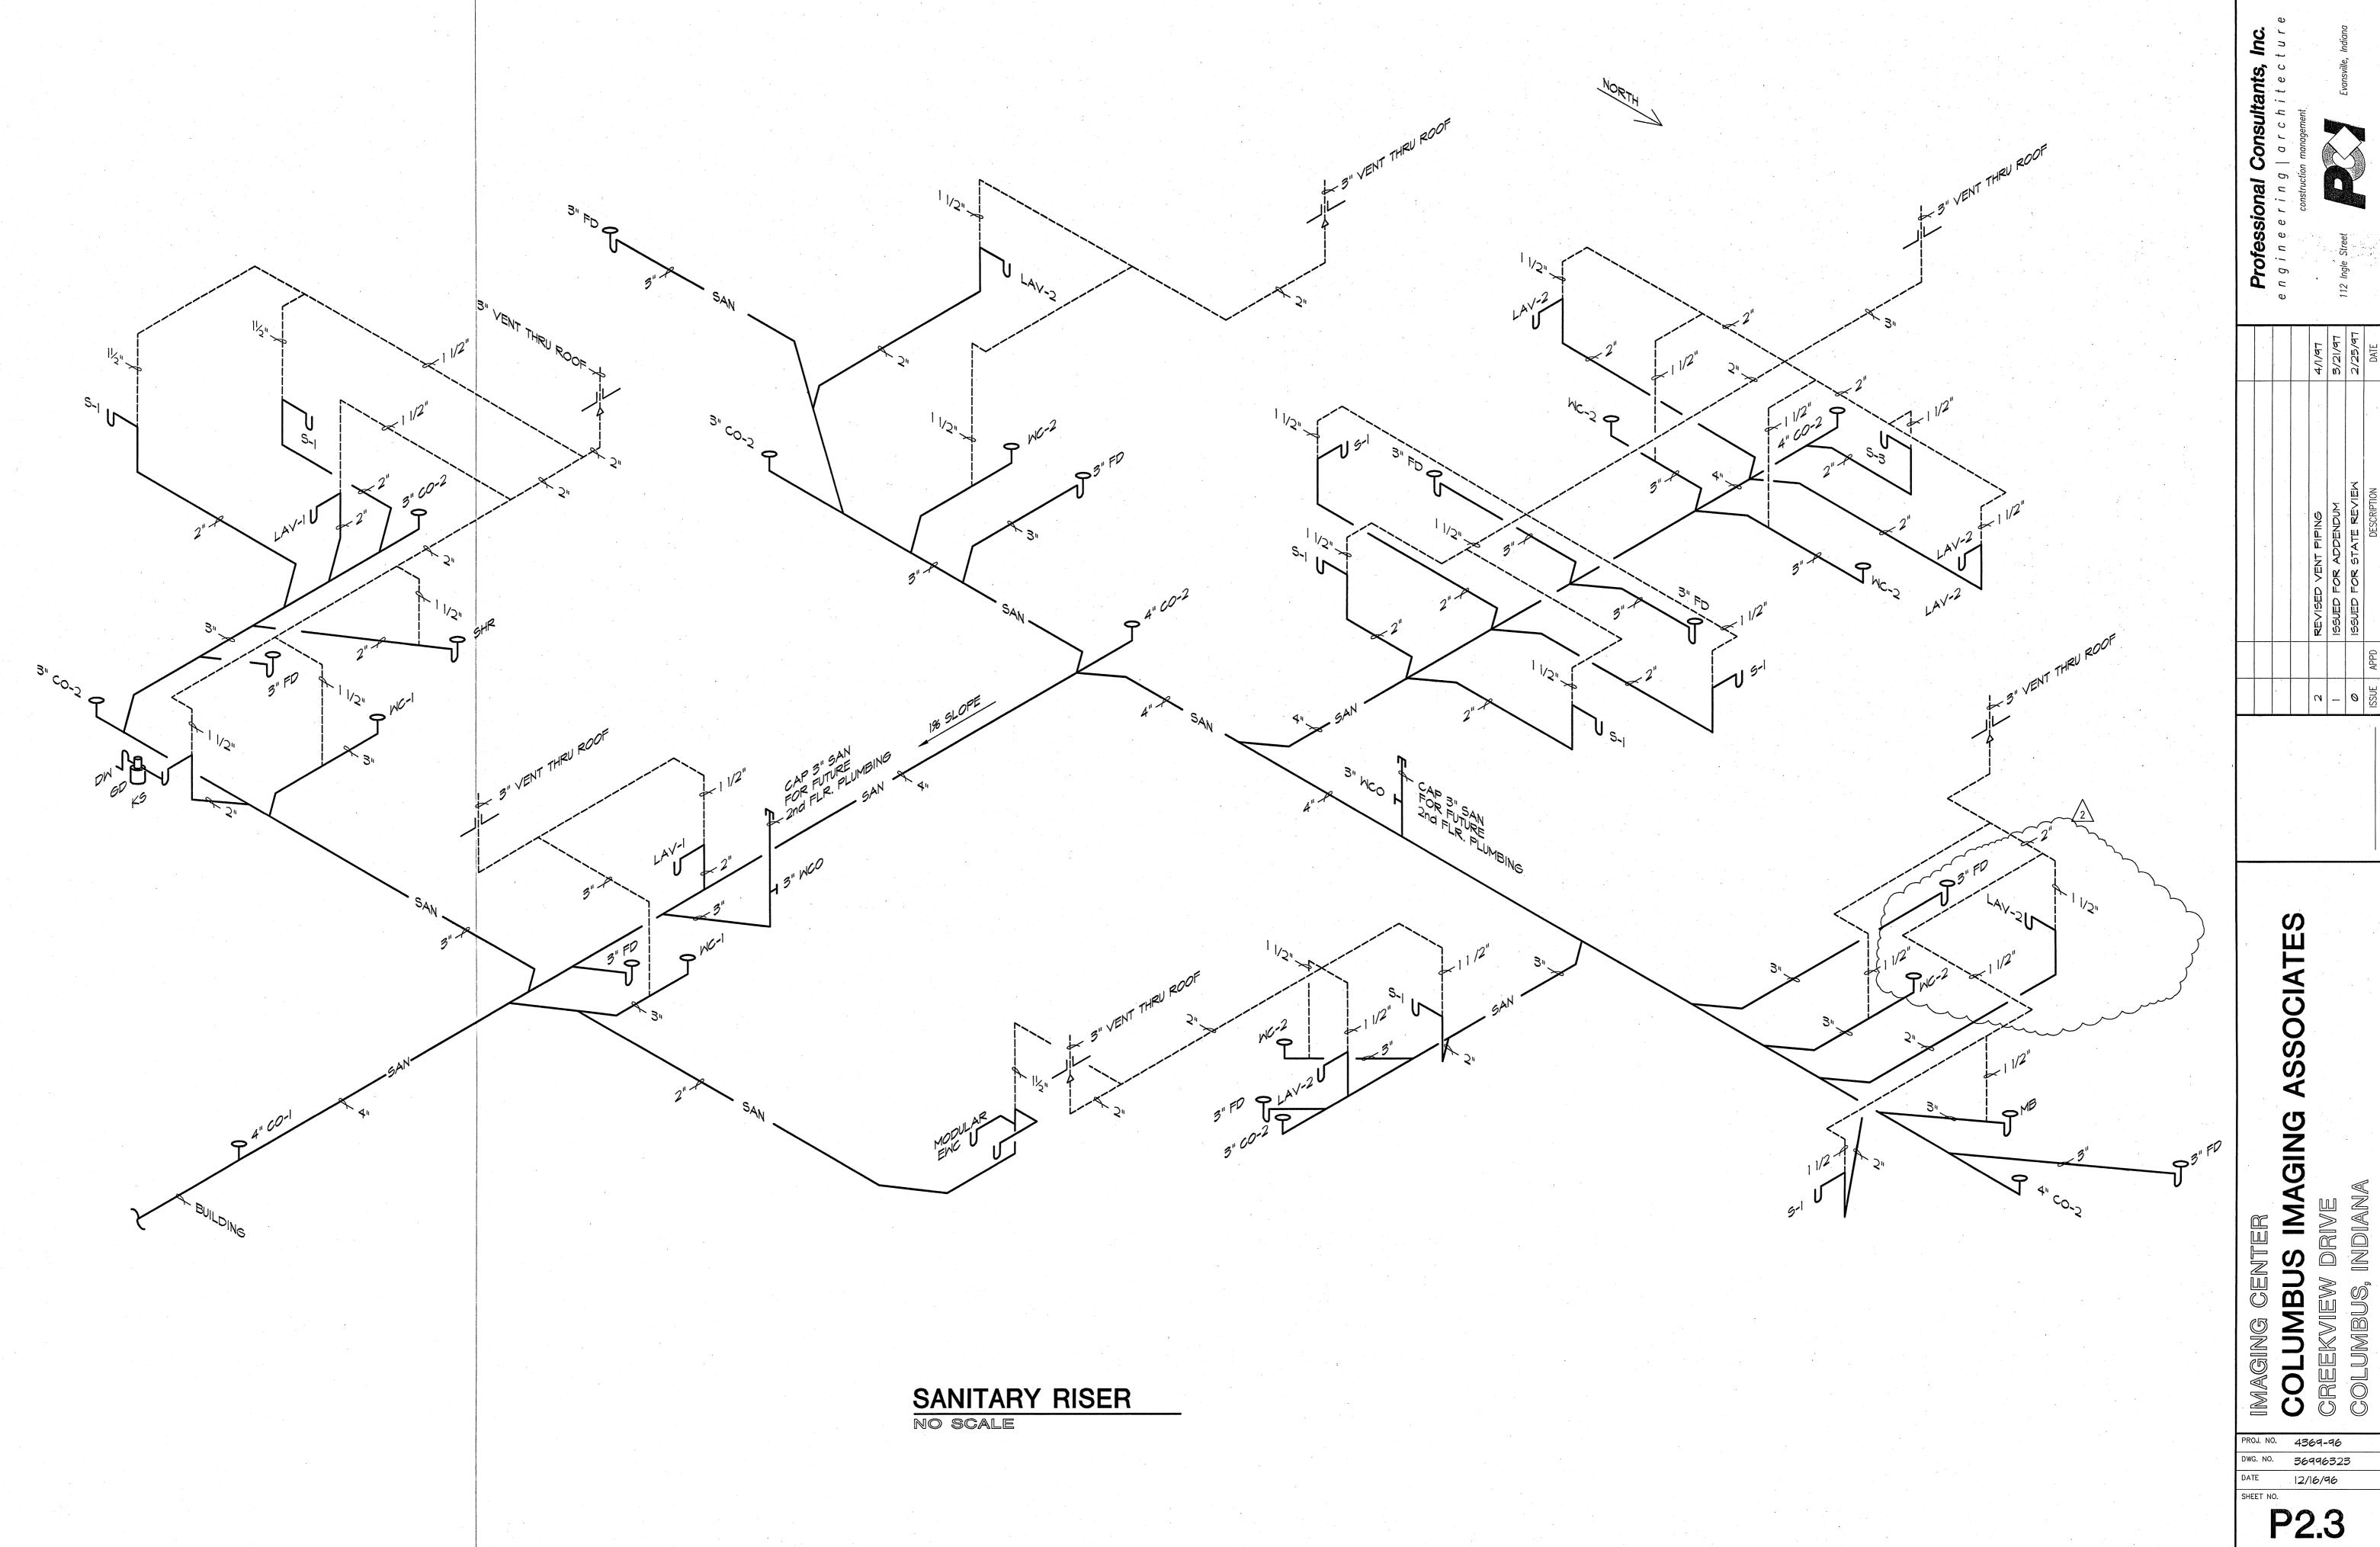

P2.3

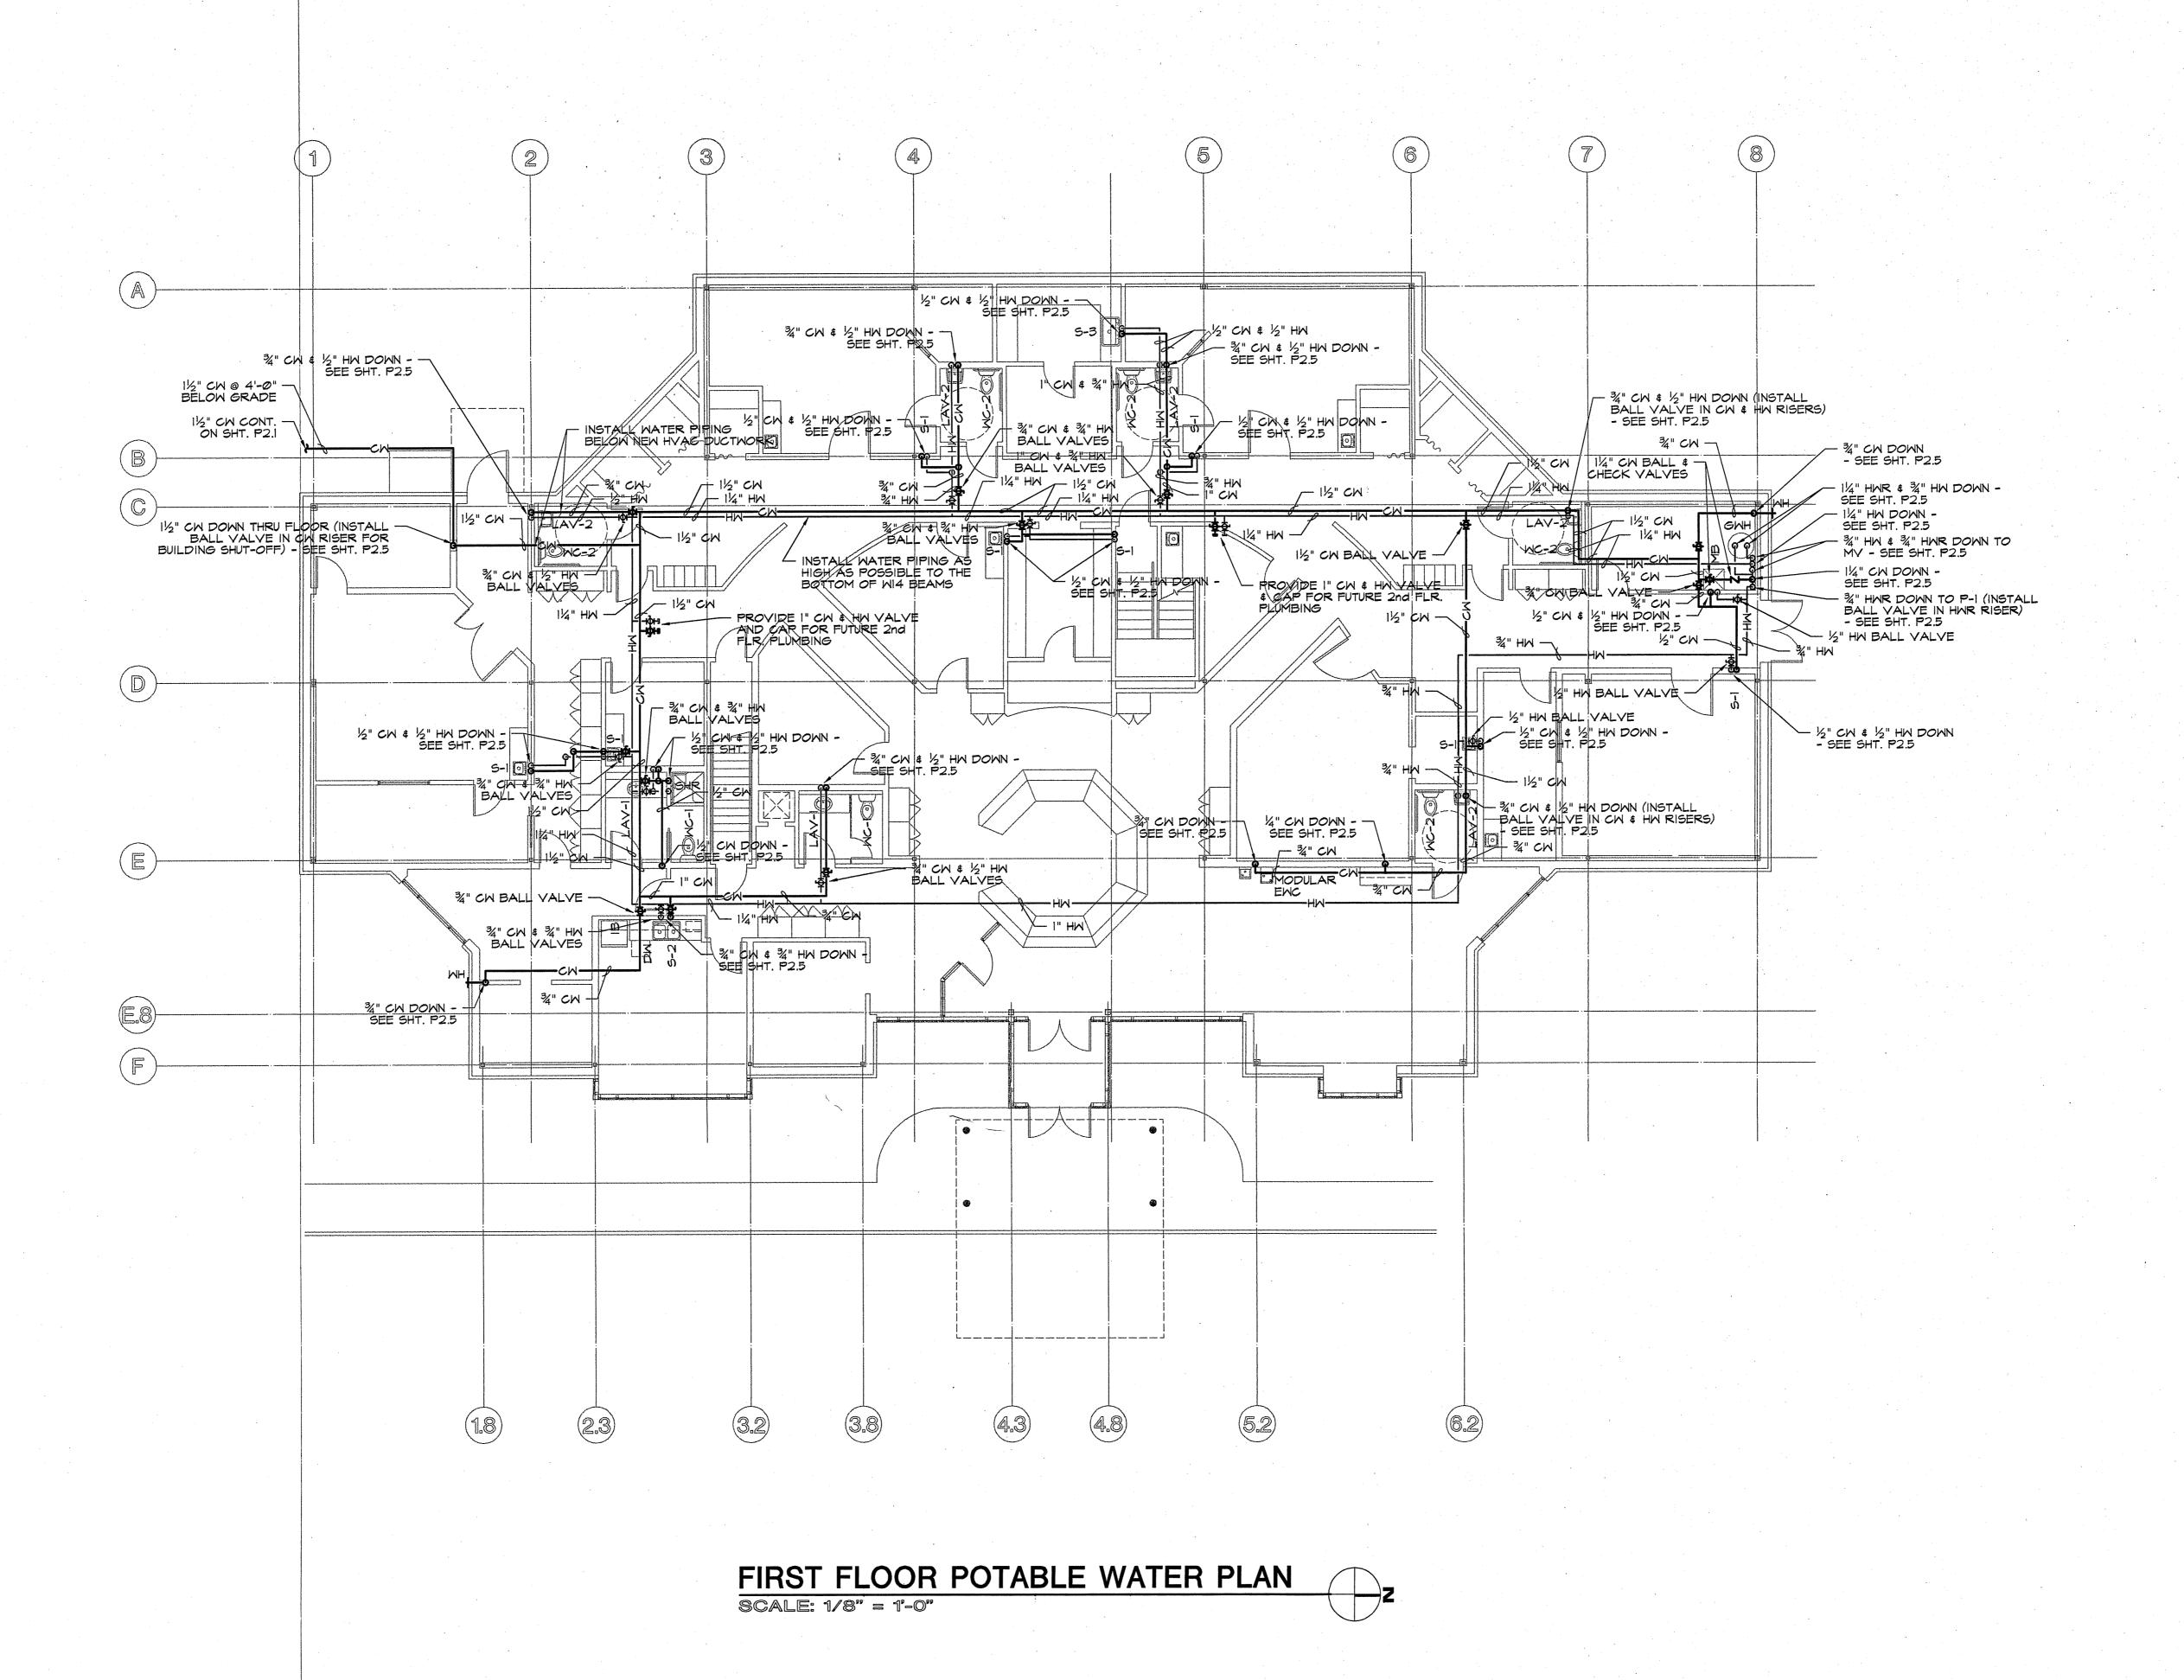


CALUMBUS IMAGING ASSOCIATES
CREEKVIEW DRIVE

PROJ. NO. 4369-96

DWG. NO. 36996324

DATE 12/11/96

P2.4

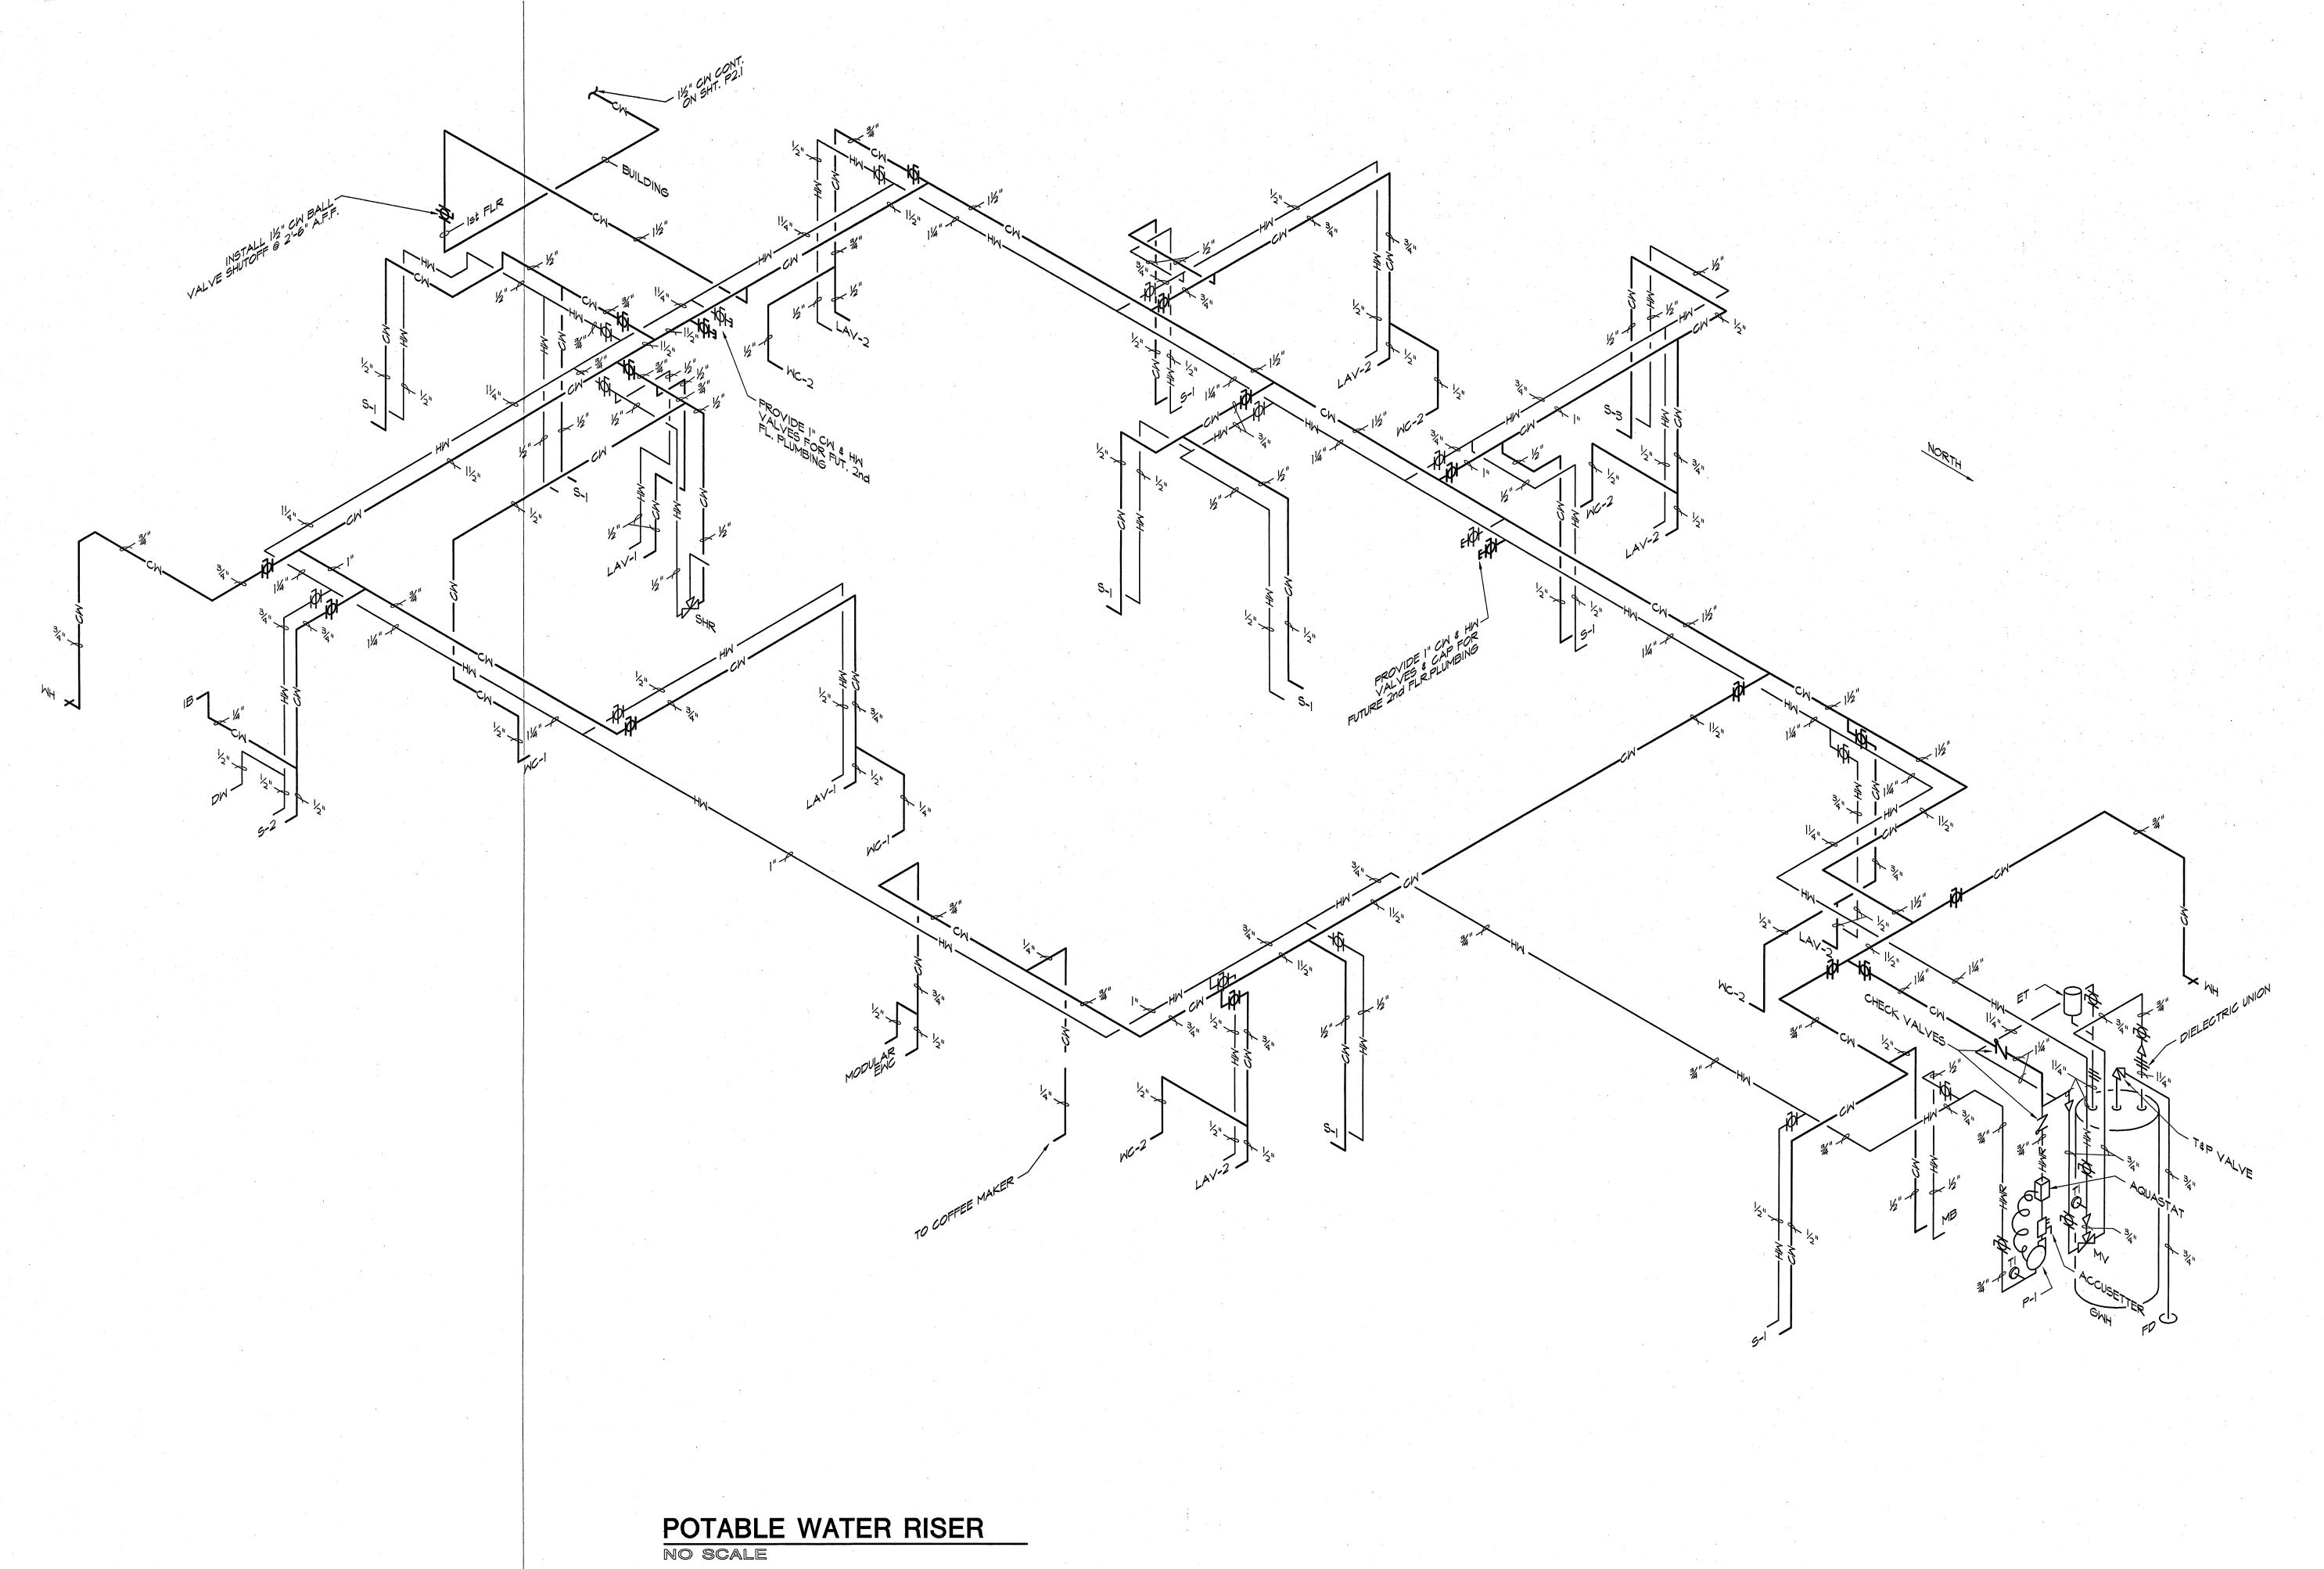

Professional Consultants, Inc.

e n g i n e e r i n g | a r c h i t e c t u r e

construction management

112 Ingle Street

FOR ADDENDUM 3/21/	OR STATE REVIEW 2/25	DESCRIPTION
ISSUED FOR ADDENDUM	ISSUED FOR STATE REVIEW	DESCRIPTION
		APPD
-	0	ISSUE APPD

ENTER US IMAGING ASSOCIATES

MAGING CENTER
SOLUMBUS IMAC

PROJ. NO. 4369-96

DWG. NO. 36996325

12/13/96
ET NO.
P2.5

	ELECTRICAL SYMBOL SCHEDULE	ELECTRICAL NOTES
SYMBOL FA	DESCRIPTION  FLUORESCENT LIGHT FIXTURE. "FA" INDICATES TYPE (SEE LIGHT	I. ELECTRICAL CONTRACTOR SHALL FURNISH ALL LABOR, MATERIAL, TOOLS, AND EQUIPMENT TO INSTALL ALL ELECTRICAL SYSTEMS AS INDICATED ON DRAWINGS.
3 a	FIXTURE SCHEDULE), "3" INDICATES CIRCUIT, "a" INDICATES SWITCH CONTROL GROUP	2. ELECTRICAL DRAWINGS ARE GENERALLY DIAGRAMMATIC AND ARE INTENDED TO CONVEY THE SCOPE OF WORK AND INDICATE GENERAL ARRANGEMENT OF EQUIPMENT. INSTALL EQUIPMENT AN MATERIAL FOR MAINTENANCE ACCESSIBILTY PURPOSES AND KEEPING IN STRICT COMPLIANCE WITH
ф ————————————————————————————————————	HID OR INCANDESCENT RECESSED DOWN LIGHT FIXTURE	NEC "WORKING SPACE" AND "CLEARANCE" STIPULATIONS.  3. ELECTRICAL CONTRACTOR SHALL CAREFULLY EXAMINE ALL ARCHITECTURAL, STRUCTURAL,
Q	WALL MOUNTED LIGHT FIXTURE	PLUMBING, AND MECHANICAL DRAWINGS PERTAINING TO THE CONSTRUCTION BEFORE INSTALLING THE WORK. CONTRACTOR SHALL COOPERATE WITH ALL OTHER CONTRACTORS IN LOCATING ELECTRICAL DEVICES, EQUIPMENT, AND SYSTEMS IN ORDER TO AVOID CONFLICT WITH OTHER
<del></del>	POLE MOUNTED HID LIGHT FIXTURE	4. ALL WORK SHALL BE DONE IN ACCORDANCE WITH ALL STATE, COUNTY, AND CITY BUILDING
•	EMERGENCY EXIT SIGN	REGULATIONS AND CODES. ALL WORK SHALL CONFORM TO THE FOLLOWING REGULATIONS, CODES, AND STANDARDS: OSHA, NFPA, NEMA, U.L., NEC, IEC, ADA, AND LOCAL COMPLIANCE.
NL NL	EMERGENCY BATTERY PACK IN FLUORESCENT LIGHT FIXTURE "NL" INDICATES NON-SWITCHED FIXTURE USED FOR NIGHT LIGHTING	5. MANUFACTURERS SPECIFIED ARE TO ESTABLISH STANDARD QUALITY REQUIRED FOR THIS PROJECT. OTHER MANUFACTURERS WILL BE CONSIDERED FOR APPROVAL. ELECTRICAL CONTRACTOR SHALL SUBMIT TEN COPIES OF SHOP DRAWINGS OF ALL ITEMS SPECIFIED, PRIOR TO PURCHASE, TO THE DESIGN ENGINEER.
L\$	EMERGENCY TWIN HEAD LIGHT UNIT	6. GROUNDING SHALL BE DONE IN ACCORDANCE WITH ARTICLE 250 OF THE NEC. THE GROUND
Y	REMOTE EMERGENCY HEAD LIGHT	RESISTANCE SHALL BE MEASURED AND A WRITTEN STATEMENT SUBMITTED TO THE DESIGN ENGINEER AND OWNER. GROUND RESISTANCE SHALL BE 5 OHMS OR LESS.
\$ <sub>a</sub>	SINGLE POLE TOGGLE TYPE SWITCH. "a" INDICATES FIXTURE CONTROL GROUP	7. ALL ELECTRICAL EQUIPMENT SHALL BE U.L. LISTED.  8. ALL SUSPENDED CEILING MOUNTED LIGHT FIXTURES SHALL BE SUPPORTED FROM THE BUILDING
\$ <sub>3</sub>	THREE-WAY TOGGLE TYPE SWITCH	STRUCTURE. HANGERS FOR CEILING RECESSED LIGHT FIXTURES SHALL BE #12 IRON WIRE AT ONE SET OF OPPOSITE CORNERS, EACH CORNER WITH AT LEAST TWO FULL TWISTS AT EACH END TIED TO THE STRUCTURE ABOVE.
\$_4	FOUR-WAY TOGGLE TYPE SWITCH	9. ELECTRICAL CONTRACTOR SHALL PROVIDE POWER AND CONTROL WIRING, INCLUDING, BUT NOT LIMITED TO BOXES, CONDUIT, WIRE, AND CONNECTIONS TO ALL UNITS OF MECHANICAL, PLUMBING, AND ARCHITECTURAL EQUIPMENT AS NECESSARY. ELECTRICAL CONTRACTOR SHALL PROVIDE
\$	DIMMER SWITCH - 600 WATT UNLESS NOTED OTHERWISE	ALL DISCONNECTS, EXCEPT WHERE NOTED OTHERWISE.
PC)	PHOTOCELL	IO. CONTROL EQUIPMENT THAT IS FURNISHED BY OTHER CONTRACTORS SHALL BE INSTALLED BY THE ELECTRICAL CONTRACTOR. CONTROL POWER TO CONTROL EQUIPMENT SHALL BE FURNISHED BY THE ELECTRICAL CONTRACTOR. TRANSFORMERS TO FURNISH CONTROL VOLTAGE SHALL BE EXPECTED TO BE FURNISHED AS A PART OF THE CONTROL EQUIPMENT.
Ψ	DUPLEX RECEPTACLE	II. ELECTRICAL INTERLOCKING OF MECHANICAL EQUIPMENT SHALL BE BY THE ELECTRICAL CONTRACTOR AS SHOWN ON THE ELECTRICAL DRAWINGS.
₽ <sub>GFI</sub> WP	GROUND FAULT INTERRUPTING DUPLEX RECEPTACLE, "WP" INDICATES WEATHERPROOF COVERPLATE	12. MINIMUM CONDUIT SIZE SHALL BE 1/2" AND MINIMUM CONDUCTOR SIZE SHALL BE #12 AWG FOR POWER WIRING AND #14 AWG FOR CONTROL WIRING. WIRING SHALL BE STRANDED COPPER, RATE AT 90°C, 600 VOLT THHN/THWN TYPE (SIZE LESS THAN #6) AND XHHW TYPE (SIZE #6 AND LARGER
<b>₽</b> Ewc	ELECTRIC WATER COOLER. REFER TO MAN'F. REQUIREMENTS FOR ROUGH-IN LOCATION	13. ALL CONDUIT SHALL BE INSTALLED PARALLEL AND PERPENDICULAR TO BUILDING STRUCTURAL MEMBERS.
•	DATA/COMM OUTLET	14. ALL CONDUITS UNDER FLOOR SLAB TO RUN AS SHALLOW AS POSSIBLE WITHOUT BEING IN SLAB.
$\nabla$	COMMUNICATION OUTLET. VOICE ONLY.	I5. ELECTRICAL CONTRACTOR SHALL KEEP ACCURATE RECORDS OF ALL UNDERGROUND AND CONCEALED ELECTRICAL LINES WHICH DEVIATE FROM THE DESIGN DRAWINGS. AT COMPLETION OF PROJECT, ELECTRICAL CONTRACTOR SHALL TURN OVER TO OWNER A RED-LINE MARKED SET OF "AS BUILT" DRAWINGS.
· J	JUNCTION BOX	16. PROVIDE PULL STRINGS IN ALL EMPTY CONDUITS.
C	DISCONNECT SAFETY SWITCH. SIZE AND TYPE AS NOTED ON DRAWINGS	17. CONDUIT USED UNDERGROUND AND UNDER FLOOR SLAB SHALL BE SCHEDULE 40 PVC WITH RIGID 90'S. INDOOR CONCEALED AND EXPOSED CONDUIT SHALL BE EMT.  EXPOSED FLEXIBLE CONDUIT FROM DISCONNECTS TO MECHANICAL EQUIPMENT SHALL BE SEALTITE.
<i>/</i> /	MOTOR. SIZE AND RATINGS AS NOTED ON DRAWINGS	OUTDOOR EXPOSED CONDUIT SHALL BE RIGID GALVANIZED STEEL. DRY TYPE TRANSFORMERS SHALL HAVE A MINIMUM OF 24" OF SEALTITE ON THE PRIMARY AND SECONDARY SIDE OF THE TRANSFORMER.
①	THERMOSTAT	18. PROVIDE PROPER SIZED SLEEVES AND EXACT LOCATIONS OF CONDUIT RUNS THROUGH WALLS (BLOCK AND FOUNDATION) TO THE GENERAL CONTRACTOR FOR HIS PLACEMENT IN WALLS. ALL
	DUCT SMOKE DETECTOR - INSTALL IN SUPPLY AND RETURN DUCTS TO SHUT UNIT DOWN WHEN ACTIVATED.	HOLES THRU WALLS AND CEILING EXPOSED TO FINISHED AREA SHALL HAVE ESCUTCHEONS FOR CONDUITS. SEAL ALL SLEEVES WITH ETHAFOAM BACK-UP ROD AND SILICON SEALANT AND USE 3M #CP 25, 2 HOUR FIRE RATED CAULKING FOR PENETRATIONS THRU FIRE WALLS AND FLOORS.
I/R	DUCT SMOKE DETECTOR REMOTE INDICATION & RESET STATIONS	19. ELECTRICAL CONTRACTOR SHALL REFER TO ARCHITECTURAL PLANS, ELEVATIONS, AND SECTIONS WHERE APPLICABLE, FOR ACTUAL MOUNTING HEIGHTS AND LOCATION OF ELECTRICAL EQUIPMENT.
N	NURSE CALL EMERGENCY STATION	20. DEVICES AT DIFFERENT ELEVATIONS SHALL BE ALIGNED VERTICALLY AND DEVICES AT SAME ELEVATION SHALL BE UNDER ONE COVERPLATE, IF APPLICABLE.
	NURSE CALL LIGHT	21. ELEVATIONS FOR DEVICES SHALL BE AS FOLLOWS, UNLESS NOTED OTHERWISE, ABOVE FINISHED FLOOR TO BOTTOM - SWITCHES: +48", RECEPTACLES: +16", THERMOSTAT: +54", DATA: +16", TELEPHONE: +16".
	PANELBOARD	22. PANELBOARDS SHALL BE AS DETAILED ON DRAWINGS. CIRCUIT BREAKERS SHALL BE 20 AMP SINGLE POLE, UNLESS NOTED OTHERWISE. PANELS SHALL HAVE SOLID NEUTRAL BUS AND GROUND
	CONCEALED CONDUIT IN WALL OR ABOVE CEILING	BAR KIT.  23. SWITCHES SHALL BE 20 AMP, I20/277 VOLT, GRAY W/STAINLESS STEEL COVERPLATE AS MANUFACTURED BY HUBBELL: SINGLE POLE - #I22IGRY, THREE WAY - #I223GRY, FOUR WAY -
	UNDERGROUND OR UNDER FLOOR SLAB CONDUIT	#1224GRY. DIMMERS SHALL BE ROTARY SINGLE POLE, 120 VOLT, BEIGE AS MANUFACTURED BY HUBBELL: 600 WATT - #AR61, 1000 WATT - #AR101
	HOMERUN TO PANELBOARD. PANEL LPI, CIRCUITS I AND 3. CROSSBARS INDICATE NUMBER OF CONDUCTORS. / INDICATES PHASE CONDUCTOR, / INDICATES NEUTRAL CONDUCTOR, / INDICATES GROUND CONDUCTOR.	24. RECEPTACLES SHALL BE 20 AMP, I25 VOLT, NEMA 5-20R (UNLESS NOTED OTHERWISE), GRAY W/STAINLESS STEEL COVERPLATE AS MANUFACTURED BY HUBBELL: DUPLEX - #5362GRY, GROUND FAULT - #GF5362GY (WEATHERPROOF COVERPLATE - #WP26).
F2 2"	MINIMUM 2-I/C #12 & 1-I/C #12 GRD IN I/2" C  CONDUIT DESCRIPTION - F2 INDICATES FEEDER NUMBER PER FEEDER SCHEDULE; 2" INDICATES CONDUIT SIZE PER SAME SCHEDULE	25. DATA/COMM OUTLETS ARE RACEWAY ONLY IN THE WALL. PROVIDE A 4" SQUARE x 2 I/2" DEEP BOX WITH SINGLE DEVICE PLASTER RING ROUGHED-IN AND 3/4" CONDUI STUBBED UP AND TURNED OUT ABOVE ACCESSIBLE CEILING WITH BUSHED END. CABLING WILL BE FURNISHED AND INSTALLED BY OWNER.
AFF	ABOVE FINISHED FLOOR	26. ELECTRICAL CONTRACTOR SHALL FURNISH AND INSTALL IN ALL UNITS W/GREATER THAN 2000 CF AIR FLOW DUCT SMOKE DETECTORS WITH REMOTE INDICATION AND RESET STATIONS. DETECTORS
BFG	BELOW FINISHED GRADE TO TOP OF CONDUIT	TO BE INSTALLED IN THE MAIN RETURN AIR DUCT AHEAD OF THE OUTSIDE AIR INLET AND ALSO IN THE SUPPLY DUCT, DOWNSTREAM OF THE FILTERS. ACTIVATION OF ANY DETECTOR SHALL CAUSE THE AIR-MOVING EQUIPMENT IN THE RESPECTIVE UNIT TO AUTOMATICALLY SHUT DOWN. COORDINA INSTALLATION WITH THE MECHANICAL CONTRACTOR. REMOTE INDICATION STATION SHALL HAVE RALARM LED, GREEN POWER ON LED, AND PIEZO SOUNDER. REMOTE STATIONS SHALL BE MOUNTED
		ALARM LED, GREEN POWER ON LED, AND PIEZO SOUNDER. REMOTE STATIONS SHALL BE MOUNTED AT +60" ABOVE FINISHED FLOOR TO BOTTOM. DEVICES SHALL BE AS MANUFACTURED BY NOTIFIED DETECTOR - #2451, HOUSING - #DH4OOACDC, SAMPLING TUBE - #ST-X (X = LENGTH AS REQ'D),

	FEEDER SCHEDULE								
FEEDER	FEEDER CONDUIT MAT'L CONDUCTORS IN EACH CONDUIT								LOAD
HVFI	(2)4"	PVC/RGS	PHASE	BY UTILITY	GRD.	INSULATION	UTILITY	_	HVXF
FI	(2)3"	PVC/RGS		#350 KCMIL		XHHW	HVXF	_	MDP
F2	1-1/4"	EMT	3-#3	#3	#8	XHHW/THWN	MDP	I	LPI
F3	3/4"	EMT	3-#6	-	#8	XHHW/THWN	MDP	3	TI
F4	1-1/2"	EMT	3-#1/0	#1/0	#6	XHHW/THWN	TI	-	RPI
F5	3/4"	EMT	3-#6		#8	XHHW/THWN	MDP	5	T2
F6	1-1/2"	EMT	3-#1/0	#1/0	#6	XHHW/THWN	T2	-	DSI
F7	1-1/2"	EMT	3-#1/0	#1/0	#6	XHHW/THWN	DSI	-	RP2
F8	3/4"	EMT	3-#8	<b> -</b>	#10	THMN	MDP	2	RT-I
F9	3/4"	EMT	3-#10	-	#10	THMN	MDP	4	RT-2
FIO .	1/2"	EMT	3-#12	<b> </b> -	#12	THWN	MDP	6	RT-3
FII	1/2"	EMT	3-#12	_	#12	THWN	MDP	8	RT-4
FI2	1/2"	EMT	3-#12		#12	THWN	MDP	10	RT-5
FI3	1/2"	EMT	3-#12	_	#12	THWN	MDP	12	RT-6A
FI4	1/2"	EMT	3-#12	-	#12	THWN	MDP	14	RT-6B
FI5	3/4"	EMT	3-#8	-	#10	THMN	MDP	16	RT-7
FI6	1"	EMT	3-#4	-	#8	XHHW/THWN	MDP	7	RAD #I CB
FI7	"	EMT	3-#4	-	#8	XHHW/THMN	RAD #I CB	-	RAD #I EQUIP
FI8	"	EMT	3-#4	-	#8	XHHW/THWN	MDP	9	RAD #2 CB
FI9	"	EMT	3-#4		#8	XHHW/THWN	RAD #2 CB	-	RAD #2 EQUIP
F20	1-1/4"	EMT	3-#3	-	#8	XHHW/THWN	MDP	11	CT CB
	1	1		T		I		I	_1

I-I/4" EMT 3-#3

27. ELECTRICAL CONTRACTOR SHALL PROVIDE A 2000 WATT, I20 VOLT, SPST, MANUALLY ADJUSTABLE LEVEL SLIDE, PHOTOCONTROL (PARAGON #CW20I-00) WIRED TO CONTROL, THRU CONTACTOR, BUILDING EXTERIOR AND SITE LIGHTING. MOUNT PHOTOCONTROL +6" ABOVE ROOF LINE AND FACE

28. ELECTRICAL CONTRACTOR SHALL REVIEW OWNER FURNISHED EQUIPMENT SUBMITTALS PRIOR TO

COORDINATE DETAILS OF EQUIPMENT CONNECTIONS WITH SUPPLIER AND INSTALLER.

INSTALLATION AND ELECTRICAL ROUGH-IN. VERIFY LOCATION, SIZE, AND TYPE OF CONNECTIONS.

REMOTE INDICATOR - #APA-451, REMOTE TEST - #RTS451.


NORTH. MOUNT CONTACTOR ADJACENT TO PANEL LPI.

ULE				
T NSULATION	SOURCE	CKT	LOAD	
	UTILITY	-	HVXF	
XHHM	HVXF	-	MDP	
MMHT/MHH)	MDP	1	LPI	
HHM/THMN	MDP	3	TI	
MMHT/MHH	TI	-	RPI	-
MMHT/MHH)	MDP	5	T2	
MMHT/MHH	T2	-	DSI	1 g et
MMHT/MHH	DSI	_	RP2	-
THMN	MDP	2	RT-I	
THMN	MDP	4	RT-2	
THMN	MDP	6	RT-3	
THMN	MDP	8	RT-4	
THMN	MDP .	10	RT-5	
THMN	MDP	12	RT-6A	
THMN	MDP	14	RT-6B	
THMN	MDP	16	RT-7	
HHWTHMN	MDP	7	RAD #I CB	
MMHT/MHH)	RAD #I CB	_	RAD #I EQUIP	
MMHT/MHH)	MDP	9	RAD #2 CB	
	·			

#8 XHHW/THWN CT CB - CT EQUIP


Panel Details


ELEC	TRICAL DRAWINGS	<b>nts, Inc.</b> t e c t u r e Evansville, Indiana	
E1.1 E1.2	Electrical Notes & Symbol Schedule Electrical Site Plan	<b>z</b> a -	
E2.1 E2.2	First Floor Lighting Plan Second Floor Lighting Plan		
E3.1 E3.2 E3.3	First Floor Power Plan Enlarged Power Plan Enlarged Power Plan	e e r i n g constructi	
E3.4 E3.5	Second Floor Power Plan Electrical Roof Plan	j n e in e street	

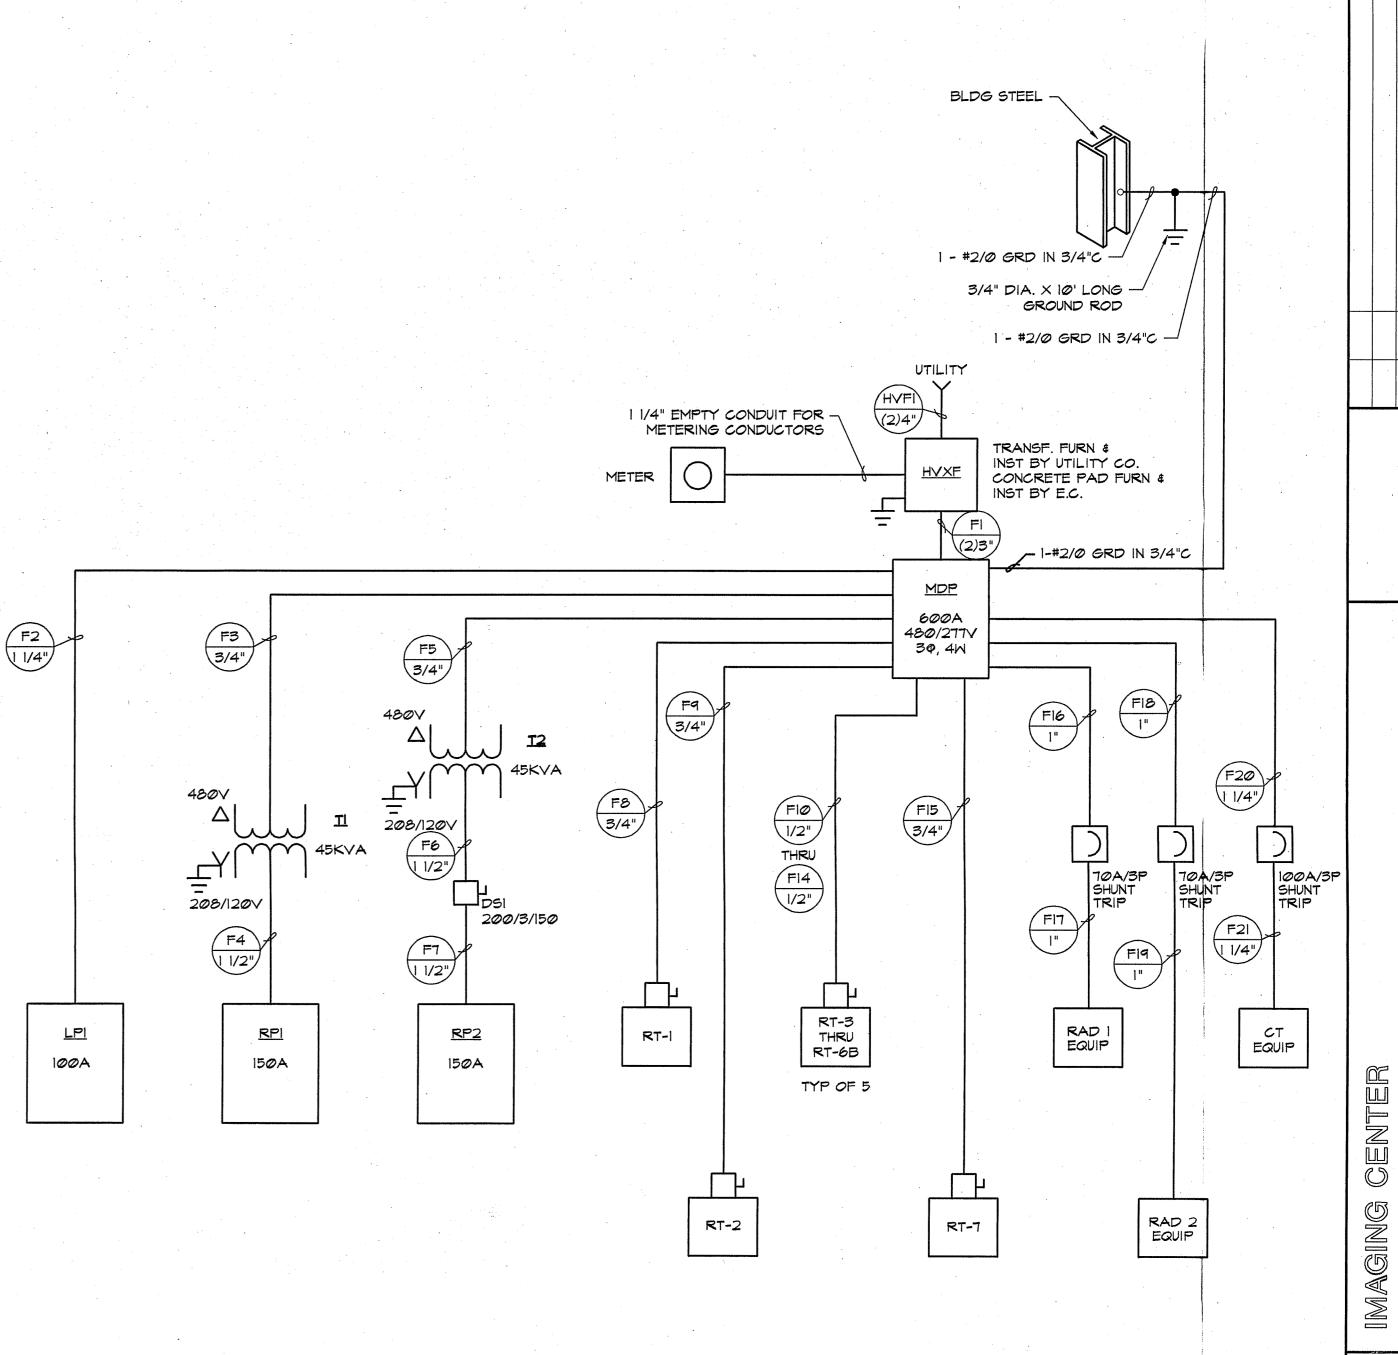

ONE LINE DIAGRAM SCALE: NONE

PROJ. NO. 4369-96 DWG. NO. 36996411 12/08/96

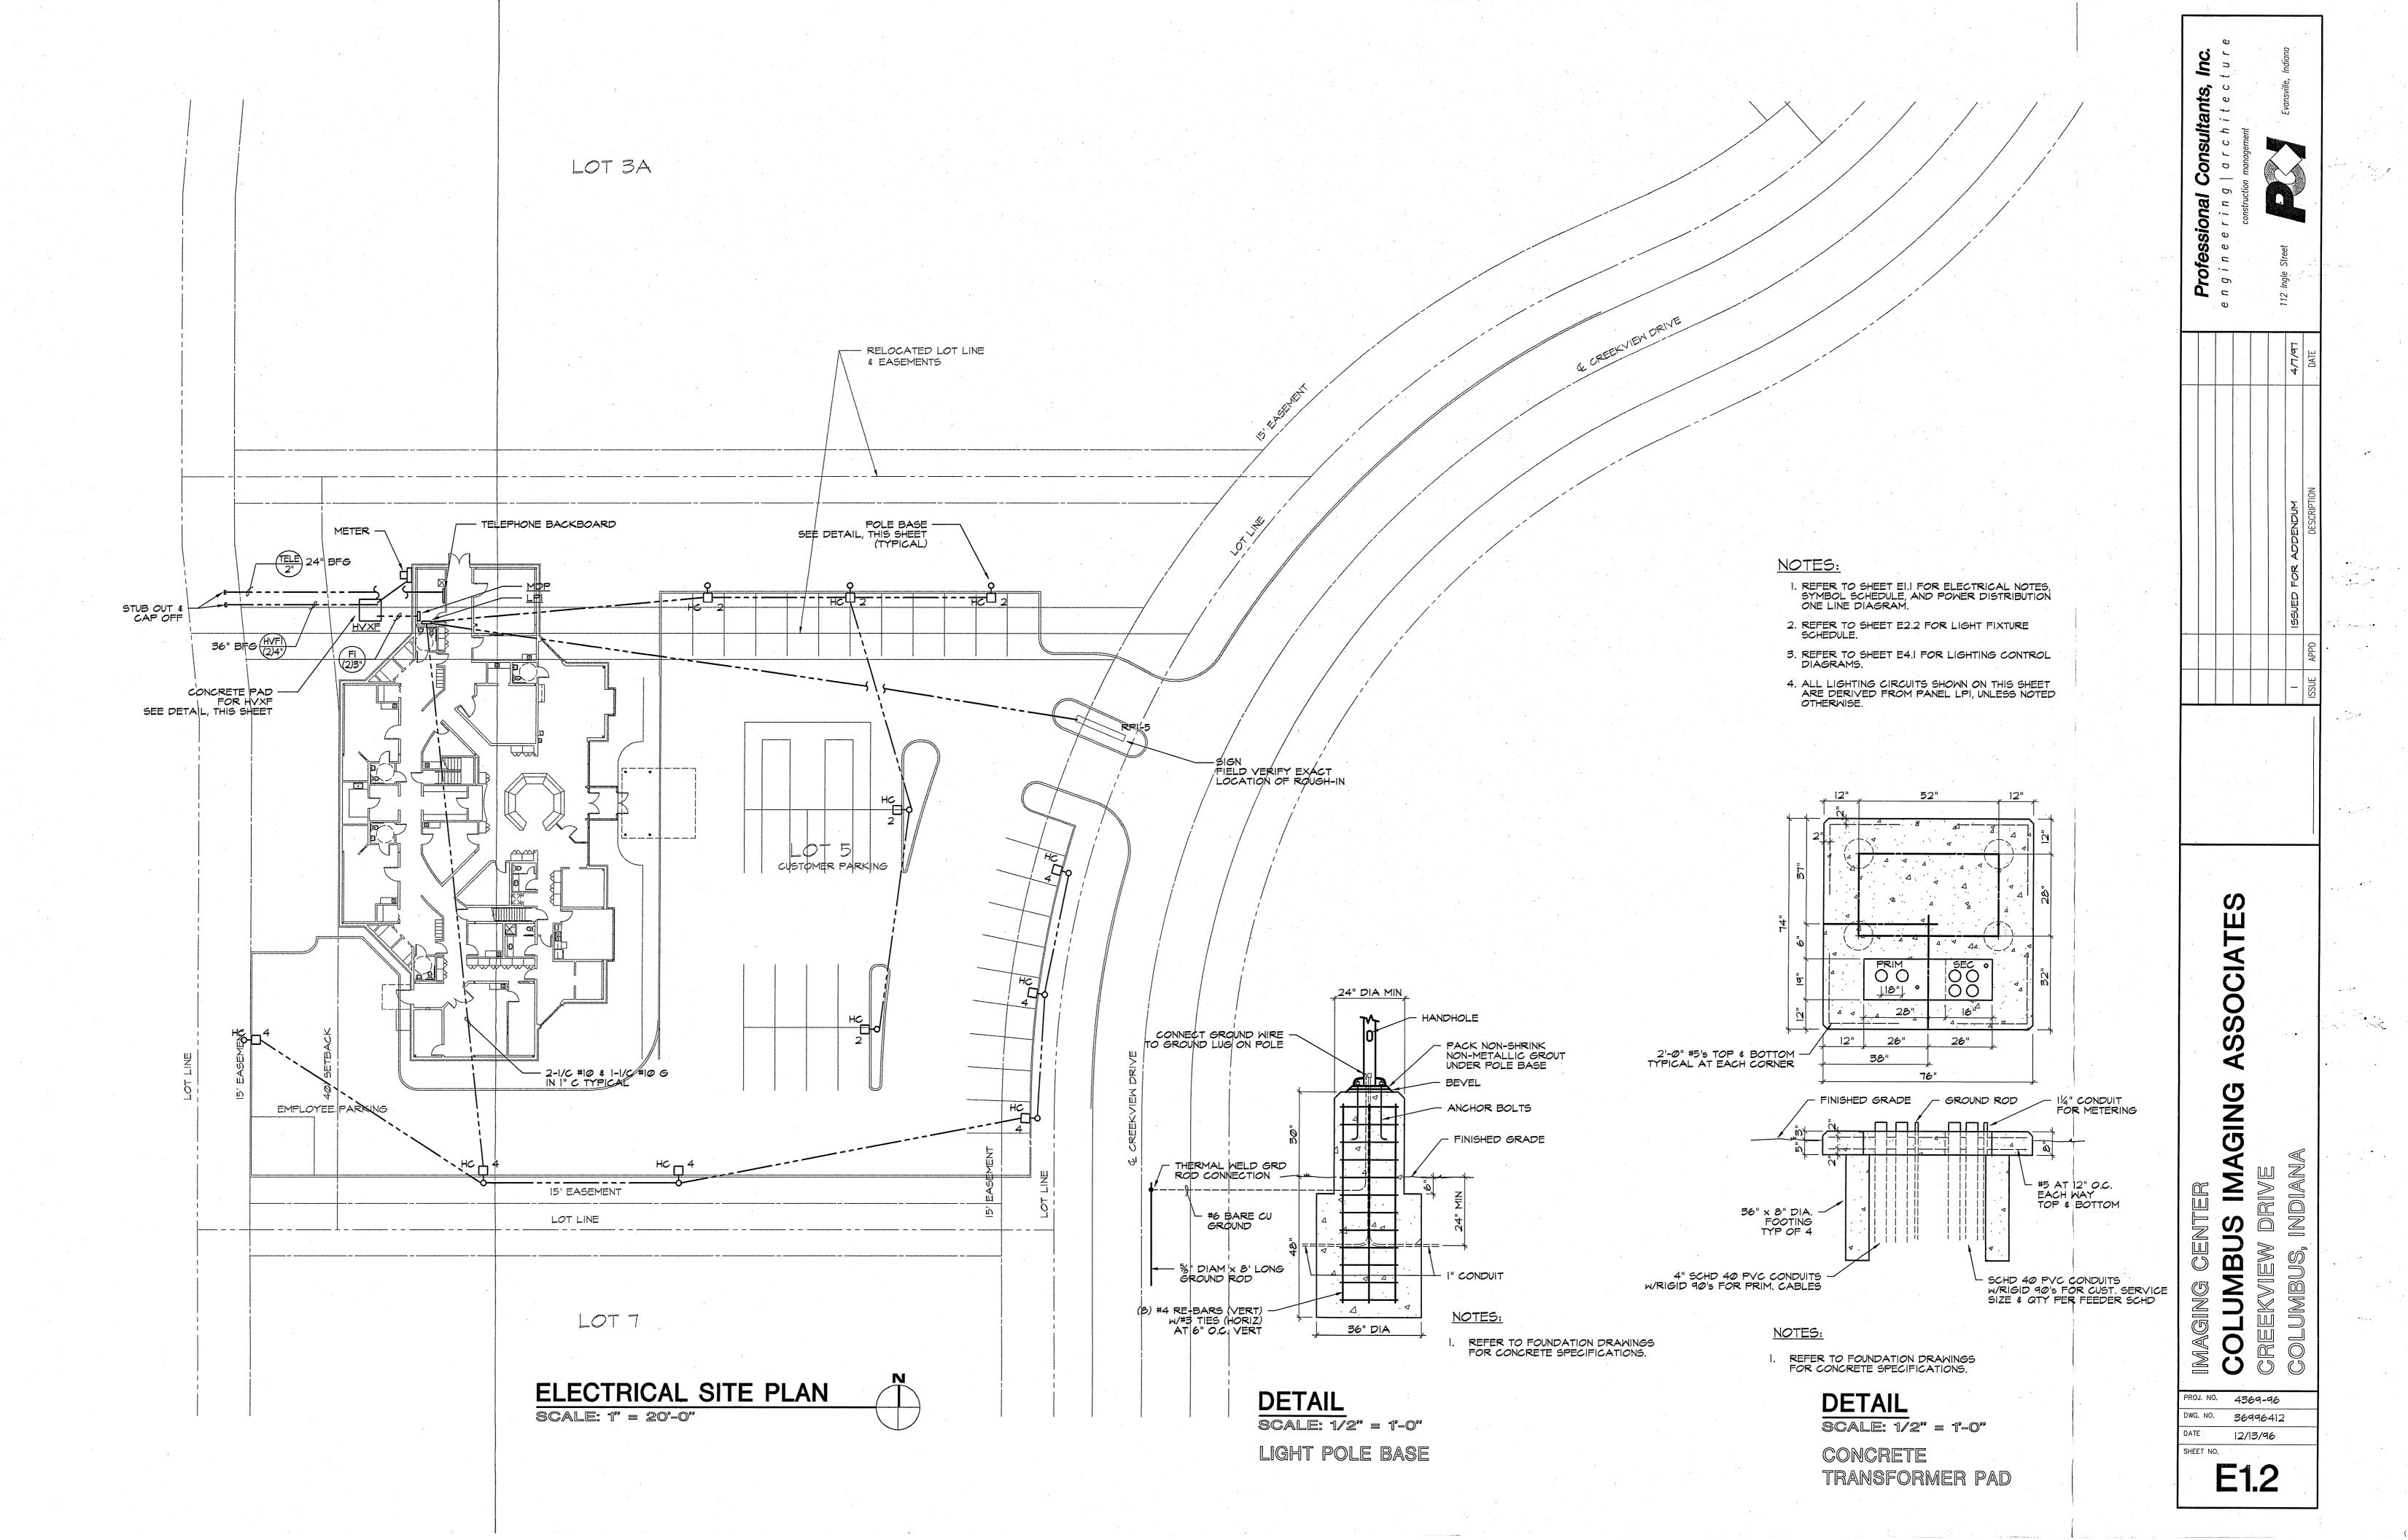

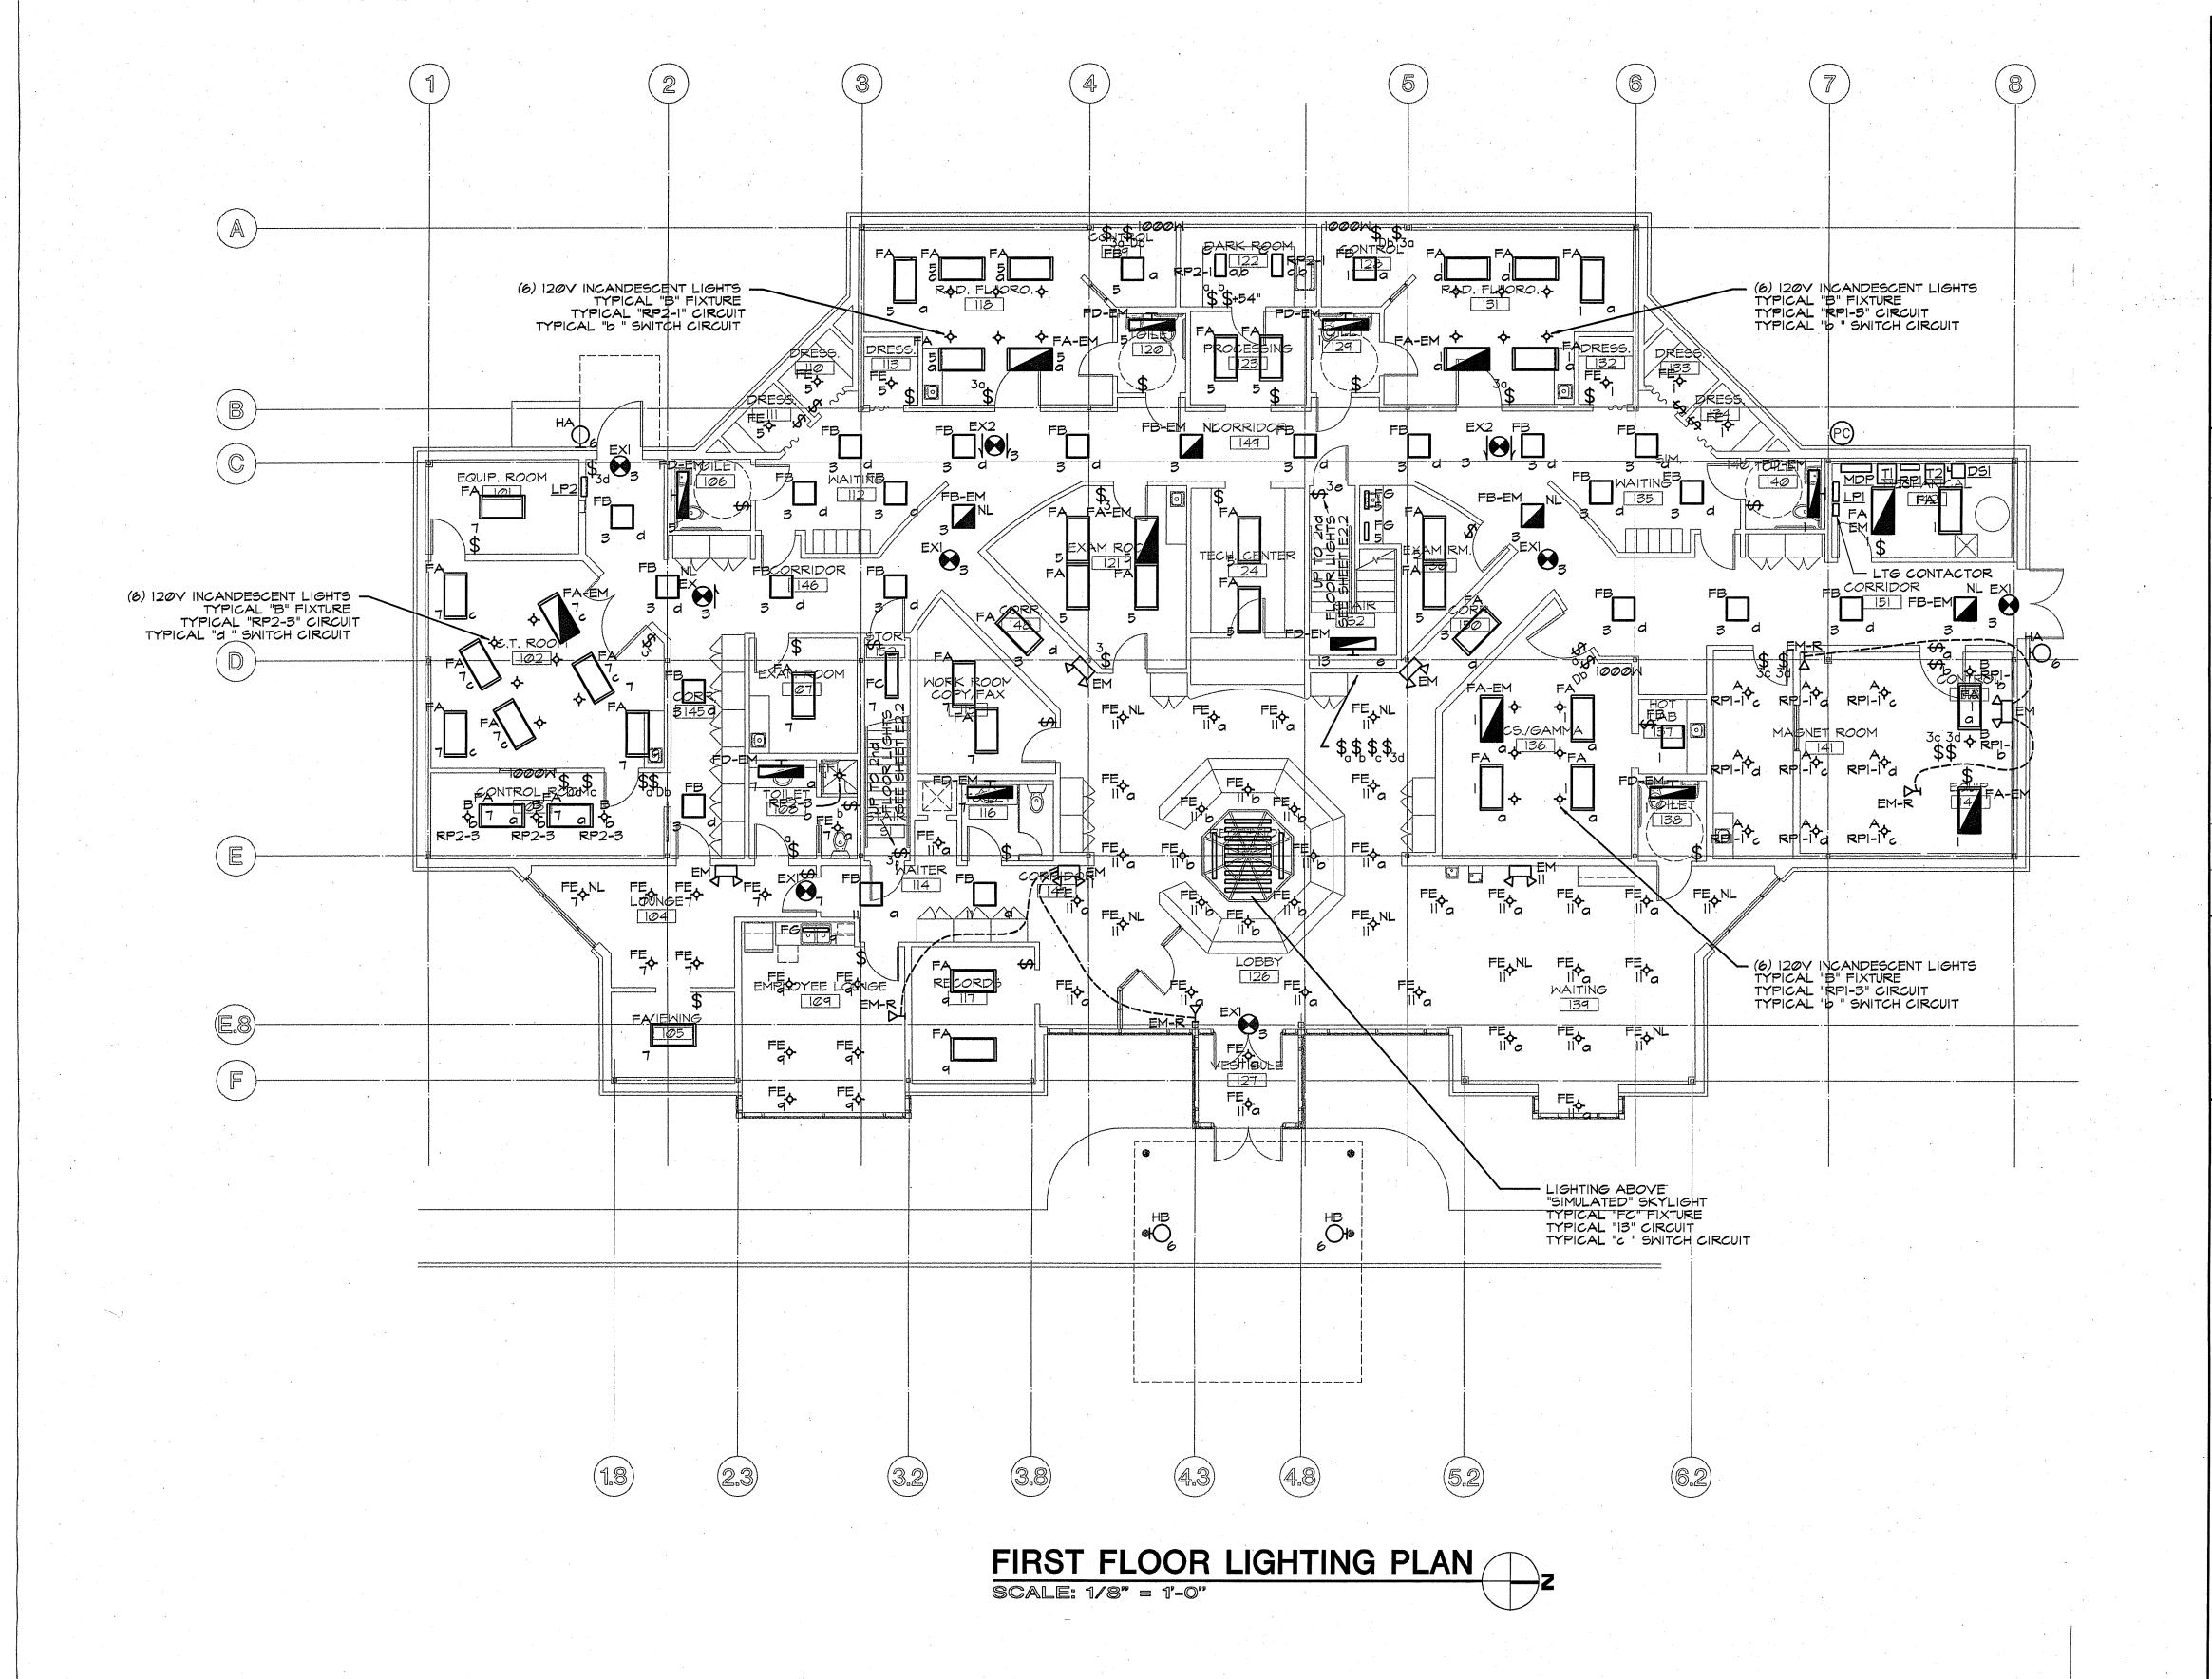

## NOTES

- 1. REFER TO SHEET EI.I FOR ELECTRICAL NOTES, SYMBOL SCHEDULE, AND POWER DISTRIBUTION ONE LINE DIAGRAM.
- 2. REFER TO SHEET E2.2 FOR LIGHT FIXTURE SCHEDULE.
- 3. ALL LIGHTING CIRCUITS SHOWN ON THIS SHEET ARE DERIVED FROM PANEL LPI, UNLESS NOTED OTHERWISE.


NG CENTER UMBUS IMAGING ASSOCIATES KVIEW DRIVE

PROJ. NO. 4369-96

DWG. NO. 36996421

SHEET NO.

12/08/96

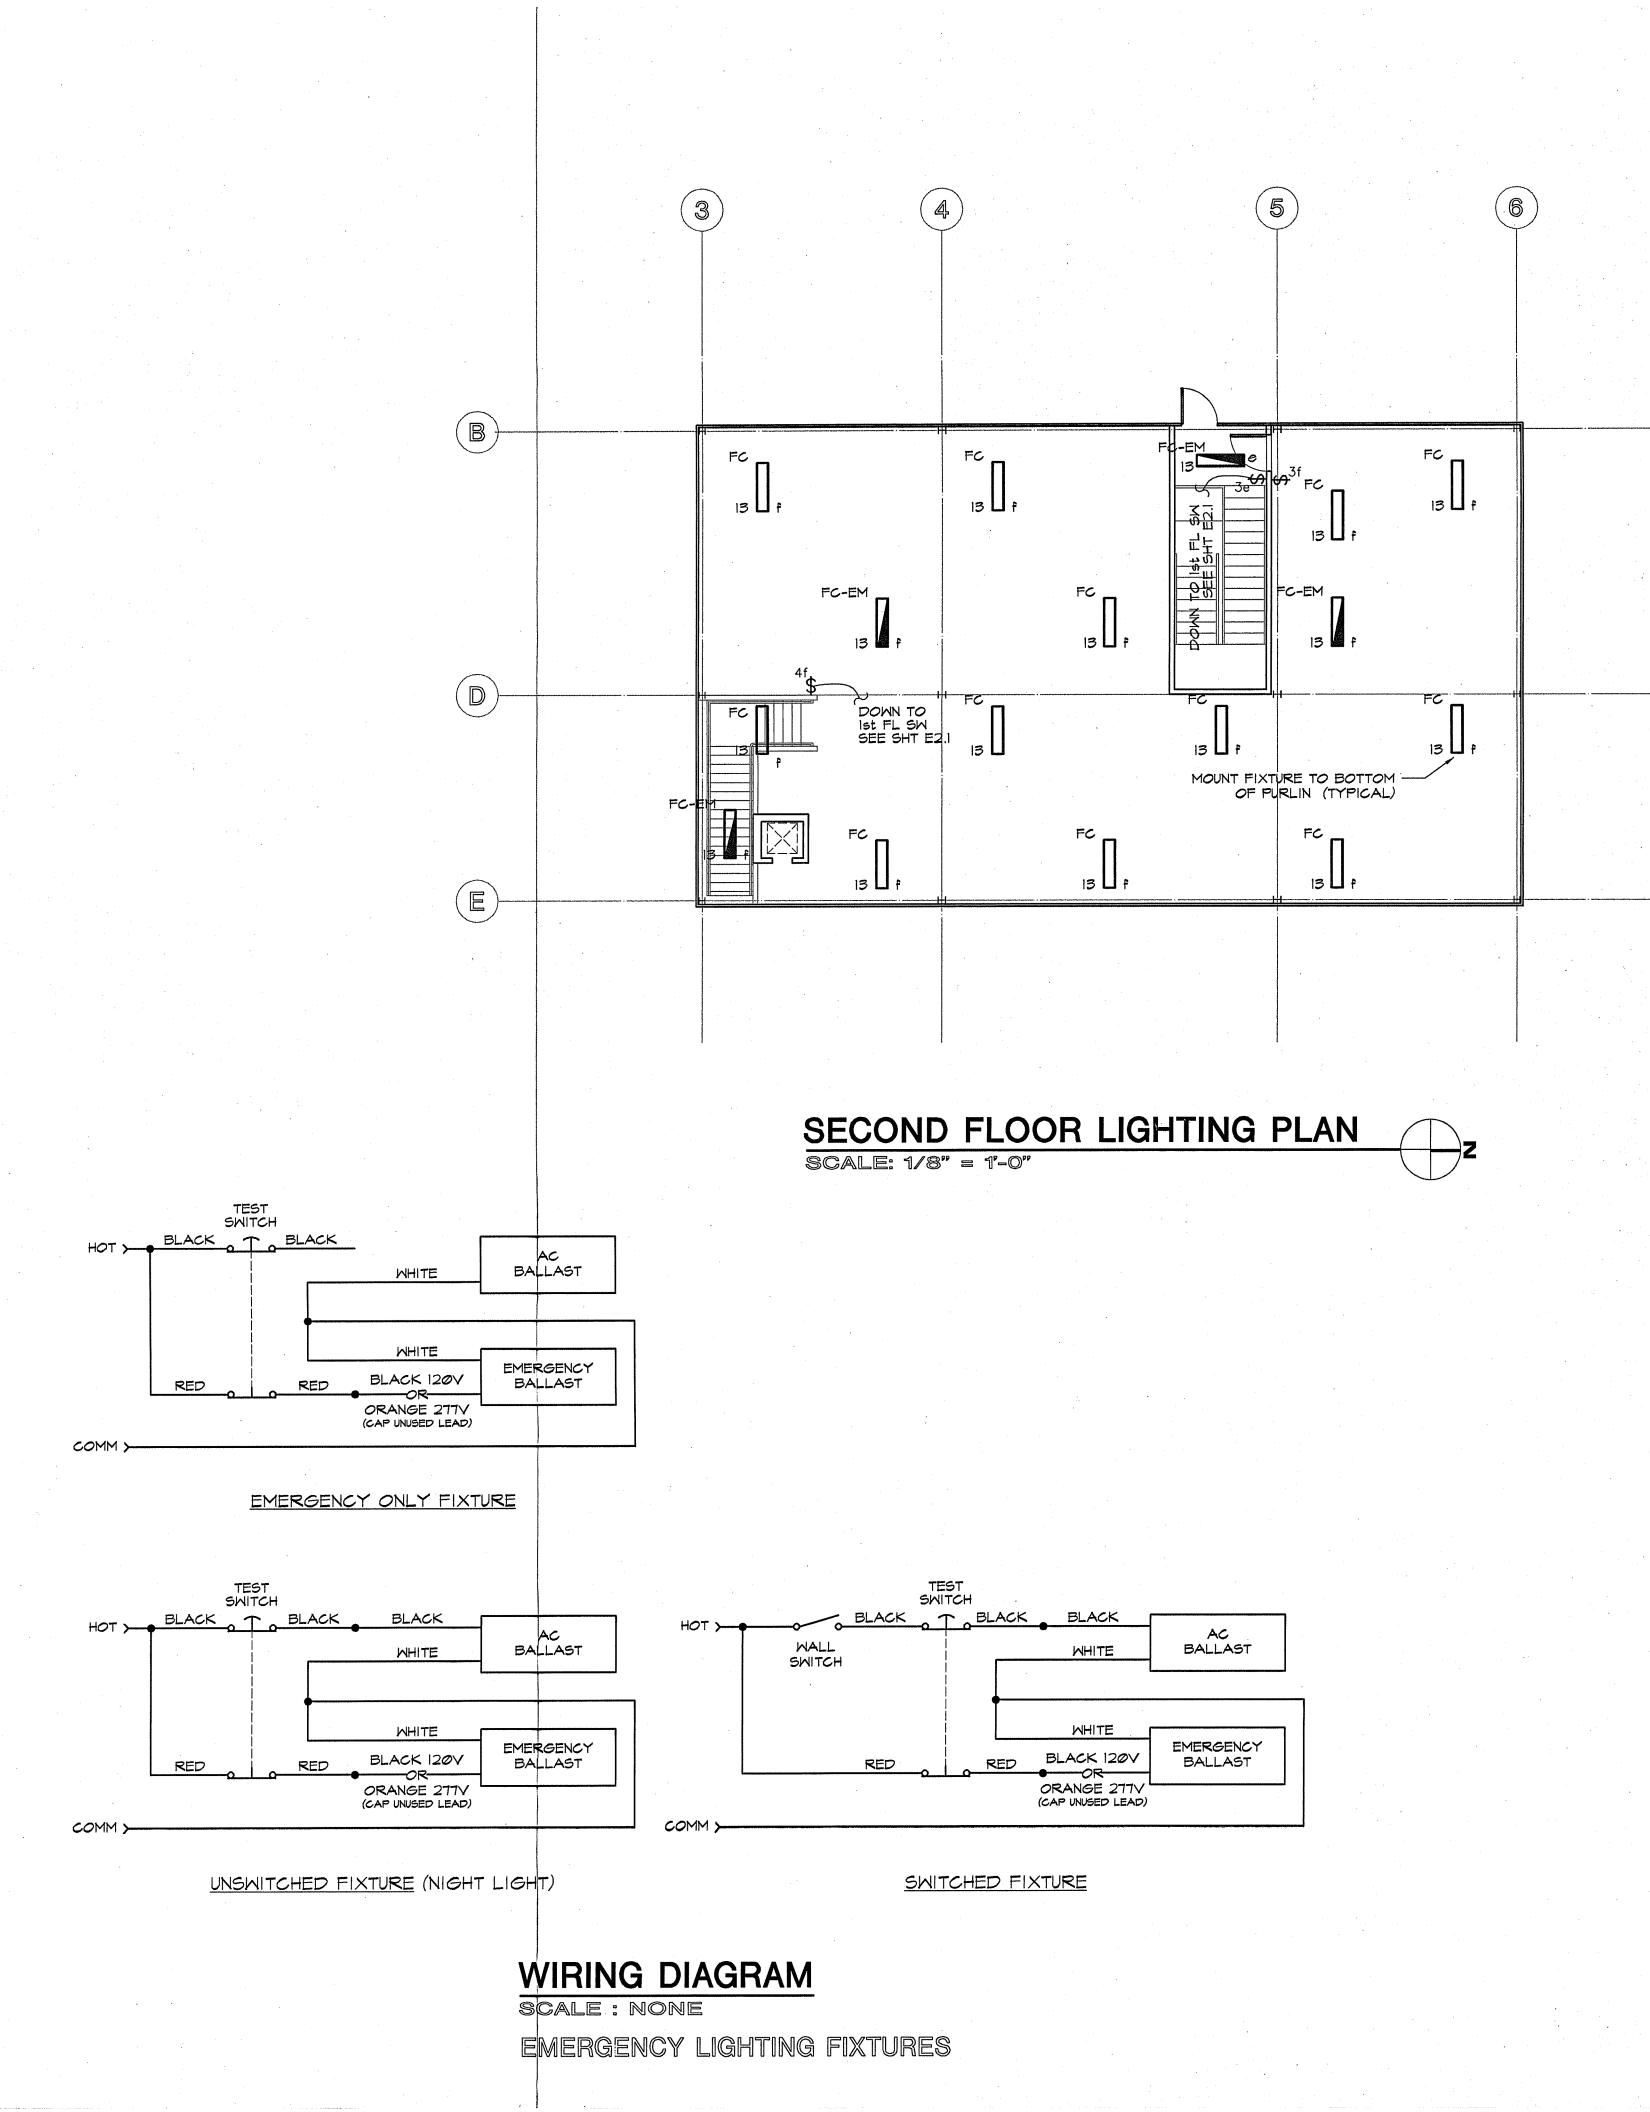

		SCHEDULE		LAMPS	
TYPE	DESCRIPTION	MAN'F & CATALOG #	VOLT	TYPE	NC
Α	6" DIAMETER RECESSED INCANDESCENT DOWNLIGHT, W/SPECULAR ALZAK REFECTOR, DIECAST ALUMINUM HOUSING MOUNTING BRACKETS AND FRAME, WHITE TRIM RING, AND ONE IOO WATT A-I9 LAMP. SUITABLE FOR USE IN MRI ROOMS.	LITHONIA A-6AR-MRI-TRM	120	SYLVANIA IOOW, AI9	
В	6" DIAMETER RECESSED INCANDESCENT DOWNLIGHT, WBLACK BAFFLE, STEEL MOUNTING FRAME, WHITE TRIM RING, AND ONE IOO WATT A-I9 LAMP	LITHONIA A-6MB-TRW	120	SYLVANIA IOOW, AI9	
С	I' X 2' DARK ROOM RECESSED SAFELIGHT, MATTE BLACK FINISH, PRISMATIC LENS WONE 200 WATT, A23 LAMP, AND ONE IS WATT, AIS LAMP W/FILTER LENS (OWNER VERIFY TYPE)	ALKCO R-2058-2	120	SYLVANIA 200W, A23 15W, A15	
FA	2' X 4', THREE LAMP, RECESSED LAY-IN FLUORESCENT FIXTURE, PRISMATIC ACRYLIC LENS, FLAT STEEL DOOR, AND ELECTRONIC BALLAST	LITHONIA 2SPG332-AI2-277-GEB	277	SYLVANIA T8-F032/835/RS	3
FA-EM	SAME AS TYPE "FA" EXCEPT W/EMERGENCY BALLAST	LITHONIA 2SPG332-AI2-277- GEB-EL	277	5YLVANIA T8-F032/835/RS	3
FB	2' X 2', TWO "U" LAMP, RECESSED LAY-IN FLUORESCENT FIXTURE, PRISMATIC ACRYLIC LENS, FLAT STEEL DOOR, AND ELECTRONIC BALLAST	LITHONIA 2SPG2U3I6-AI2-277-GEB	217	SYLVANIA T8-FB032/835/6	2
FB-EM	SAME AS TYPE "FB" EXCEPT W/EMERGENCY BALLAST	LITHONIA 2SPG2U3I6-AI2-277- GEB-EL	277	SYLVANIA T8-FB032/835/6	2
,FC	4', TWO LAMP, CHANNEL STRIP FLUORESCENT FIXTURE, SURFACE MOUNTED STEEL HOUSING AND ELECTRONIC BALLAST	LITHONIA C232-277-GEB	277	SYLVANIA T8-F032/835/RS	2
FC-EM	SAME AS TYPE "FC" EXCEPT W/EMERGENCY BALLAST	LITHONIA C232-277-GEB-EL	277	SYLVANIA T8-F032/835/RS	2
FD-EM	4', TWO LAMP WALL MOUNTED FLUORESCENT FIXTURE, W/OPAL ACRYIC DIFFUSER, WHITE STEEL HOUSING, AND EMERGENCY BALLAST. MOUNT AT +7'-4" AFF TO BOTTOM	LITHONIA WC232-AI2-277-GEB-EL	277	SYLVANIA T8-F032/835/RS	2
FE	8" DIAMETER RECESSED FLUORESCENT DOWN LIGHT, W/SPECULAR CLEAR REFLECTOR, WHITE TRIM RING, TWO 26 WATT DOUBLE TWIN TUBE LAMP, AND ELECTRONIC BALLAST	LITHONIA AF-2/26DTT-8AR- 217-GEB	277	SYLVANIA T4-CF26DD/E/835	2
FF	9" DIAMETER RECESSED FLUORESCENT SHOWER LIGHT, W/DROP OPAL LENS, TWO I3 WATT TWIN TUBE LAMP, AND ELECTRONIC BALLAST	LITHONIA LGF2/I3TT-9RW-DOL- 2T7-GEB	277	SYLVANIA T4-CFI3DS/835	2
FG	UNDERCOUNTER LOW PROFILE FLUORESCENT LIGHT FIXTURE W/WHITE HOUSING AND WHITE DIFFUSER	LITHONIA UC-21-277	277	SYLVANIA T5-FI3T5/WW	1
EXI	EMERGENCY EXIT SIGN W/CAST ALUMINUM BLACK HOUSING, SINGLE BRUSHED ALUMINUM FACE, RED LETTERS, LED ILLUMINATION, MAINTENANCE FREE NICKEL CADMIUM BATTERY, WALL MOUNT AT +6" ABOVE DOOR FAME TO BOTTOM.	LITHONIA LESIR-I20/277-ELN	277	INCLUDED	
EX2	SAME AS TYPE "EXI" EXCEPT DOUBLE FACE	LITHONIA LES2R-120/277-ELN	277	INCLUDED	-
EM	EMERGENCY TWIN HEAD LIGHTING UNIT, 50 WATT W/WHITE POLYCARBONATE HOUSING, MAINTENANCE FREE LEAD CALCUIM BATTERY, AND 12 WATT INCANDESCENT LAMPS	LITHONIA ELM4	277 VAC 12 VDC	INCLUDED	
EM-R	EMERGENCY REMOTE HEAD LIGHT FIXTURE W/WHITE POLYCARBONATE HOUSING AND 12 WATT INCANDESCENT LAMP	LITHONIA DS-NI2I2	12 VDC	INCLUDED	_
НА	70 WATT HIGH PRESSURE SODIUM EXTERIOR WALL PACK W/CAST ALUMINUM HOUSING, DARK BRONZE FINISH, POLYCARBONATE LENS, AND HIGH POWER FACTOR BALLAST. U.L. LISTED FOR WET LOCATIONS. MOUNT AT +7'-0" AFF TO BOTTOM	LITHONIA TWL705-277-HPF	277	SYLVANIA LUTO/MED	
HB	ITS WATT METAL HALIDE WALL MOUNTED UPLIGHT FOR CANOPY W/EXTRUDED ALUMINUM HOUSING, WHITE FINISH, GLASS LENS, REMOTE BALLAST, AND CUTOFF VISOR. U.L. LISTED FOR WET LOCATIONS. MOUNT AT +7'-6" AFF TO BOTTOM	ELLIPTIPAR MI52-0175-V-02-B- AVD02	277	SYLVANIA ED-IT MI75/U/MED	
НС	400 WATT HIGH PRESSURE SODIUM AREA POLE MOUNTED FIXTURE, TYPE 4 DISTRIBUTION W/ALUMINUM HOUSING, DARK BRONZE FINISH, AND GLASS LENS. POLE SHALL BE 20'-O" SQUARE STRAIGHT STEEL W/POLE BASE COVER; HANDHOLE, AND GROUND LUG	LITHONIA FIXTURE: KSF2-400S-R4-277- SP04 POLE: SSS-20-4C-DMI9-DDB	277	SYLVANIA ET-18 LU400	


- 1. REFER TO SHEET EI.I FOR ELECTRICAL NOTES, SYMBOL SCHEDULE, AND POWER DISTRIBUTION ONE LINE DIAGRAM.
- REFER TO SHEET E4.1 FOR LIGHTING CONTROL DIAGRAMS.
- ALL LIGHTING CIRCUITS SHOWN ON THIS SHEET ARE DERIVED FROM PANEL LPI, UNLESS NOTED OTHERWISE.

ASS IMAGING

PROJ. NO. 4369-96

DWG. NO. 36996422

3/1/97

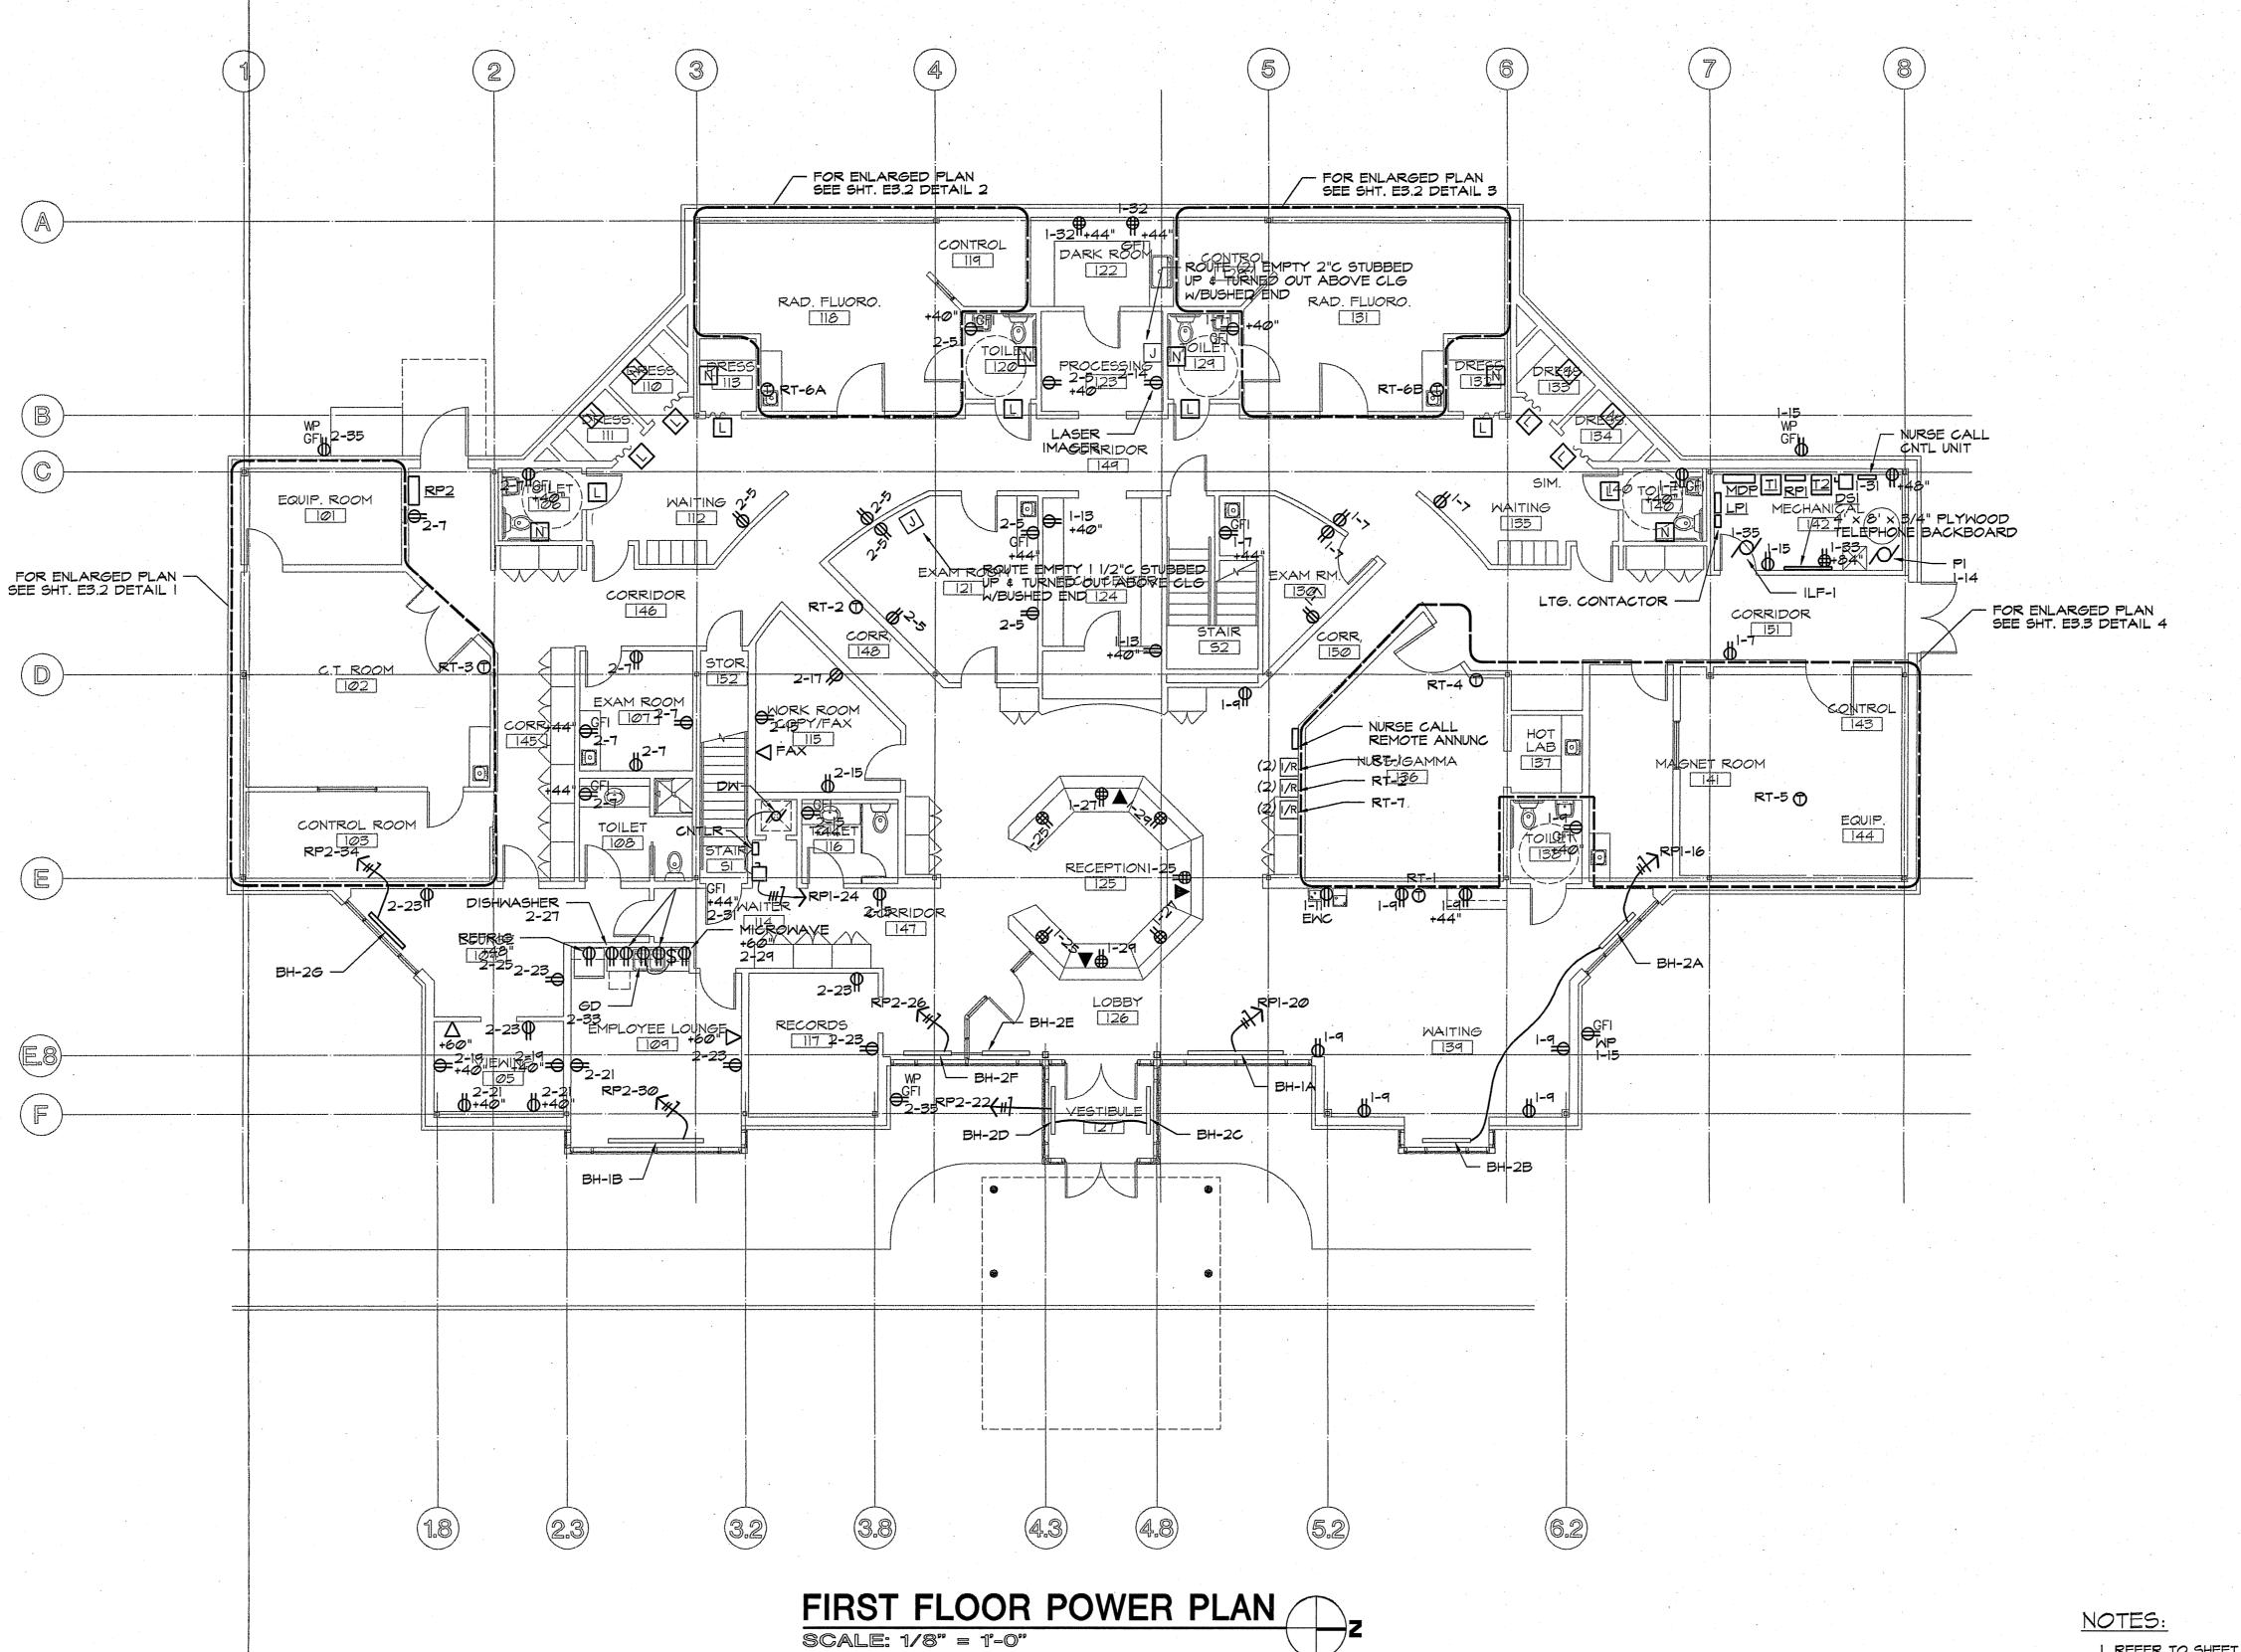

BUS IMAGING ASS


- REFER TO SHEET EI.I FOR ELECTRICAL NOTES, SYMBOL SCHEDULE, AND POWER DISTRIBUTION ONE LINE DIAGRAM.
- 2. REFER TO SHEET E3.4 FOR NURSE CALL WIRING DIAGRAM.
- 3. REFER TO SHEET E3.4 FOR MECHANICAL EQUIPMENT SCHEDULE.
- 4. ALL RECEPTACLE CIRCUITS SHOWN ON THIS SHEET ARE DERIVED FROM PANELS RPI & RP2 DENOTED BY FIRST DIGIT. ("I-7" INDICATES PANEL RPI, CIRCUIT 7)

PROJ. NO. 4369-96


DWG. NO. 36996431

DATE 12/08/96

SHEET NO.

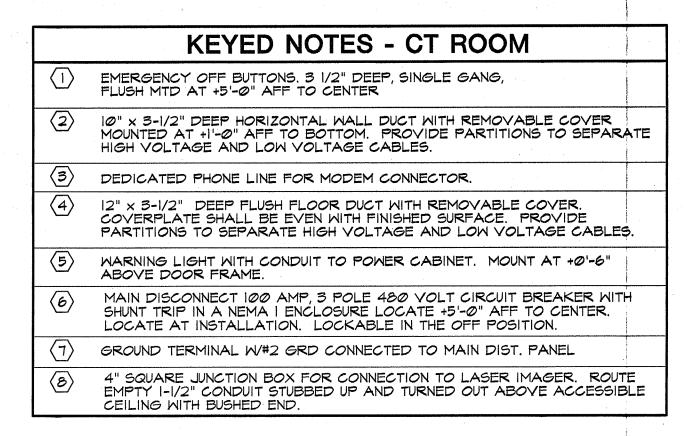




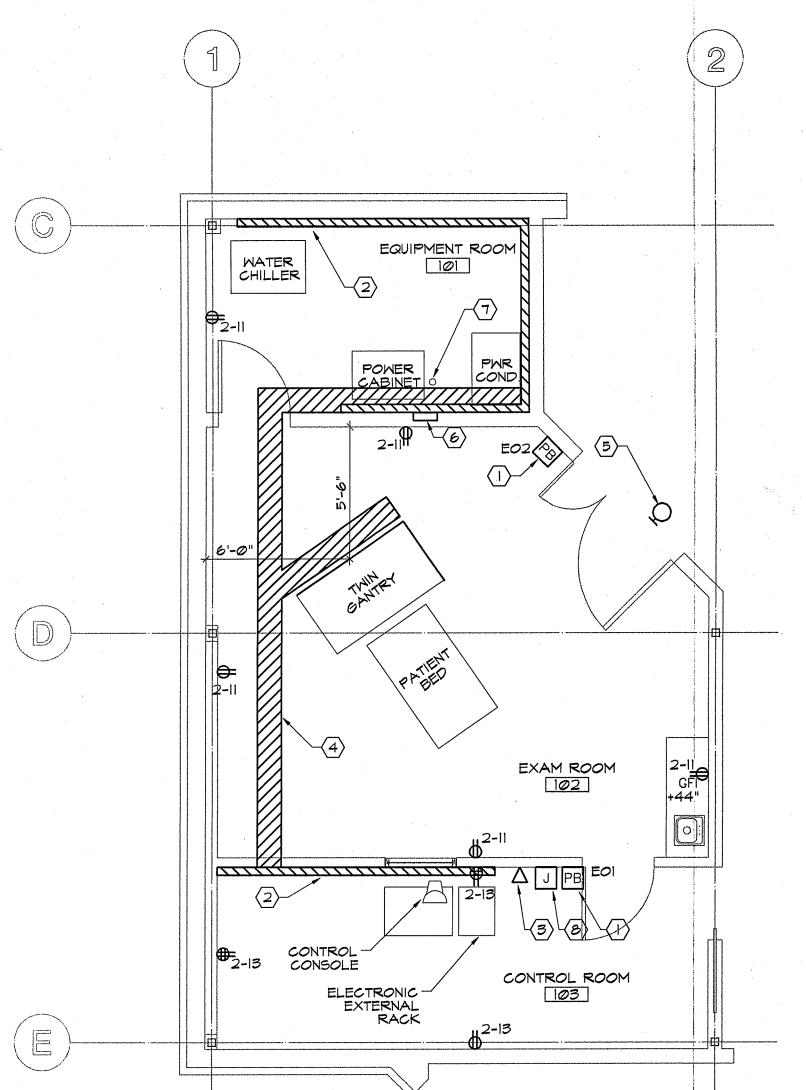


## ENLARGED POWER PLAN


SCALE: 1/4" = 1'-0"

C.T. ROOM ROOMS 101, 102 & 103

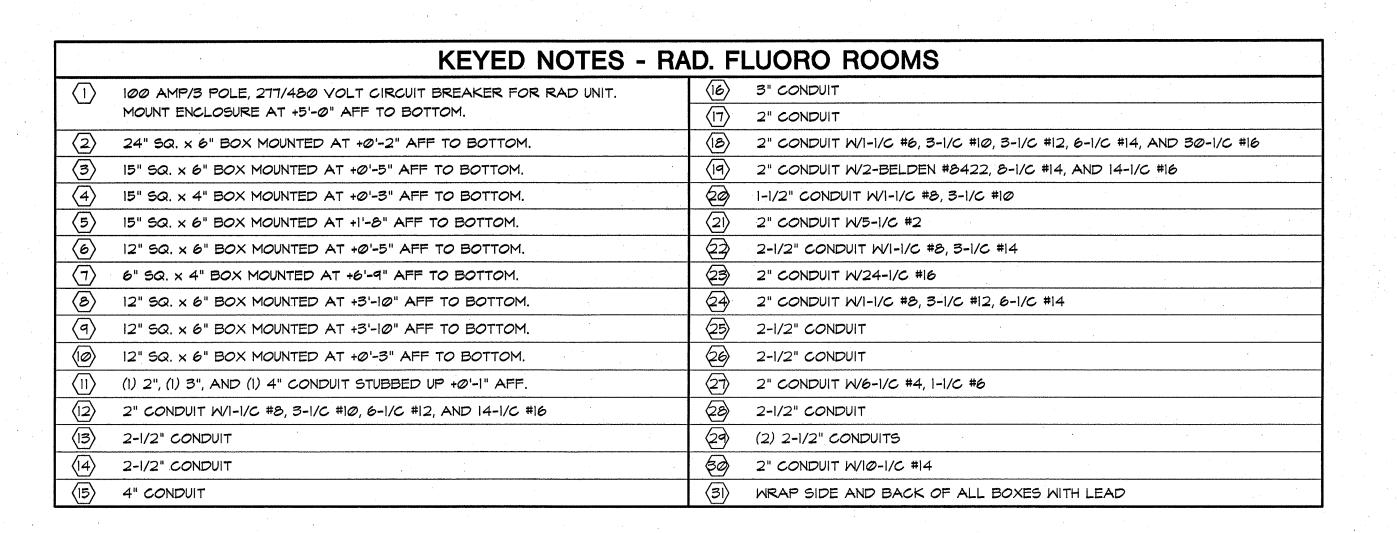

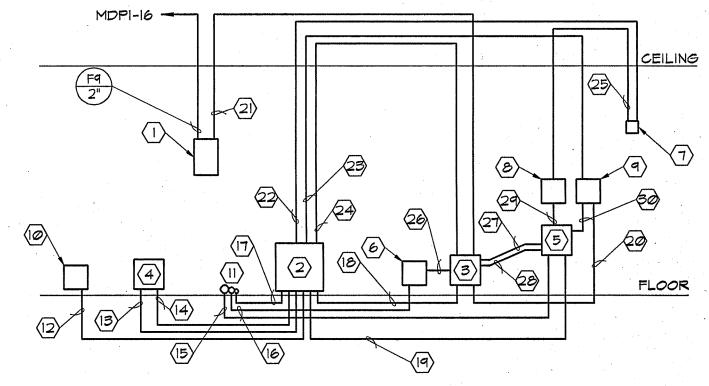


## RAD ROOM WIRING DIAGRAM

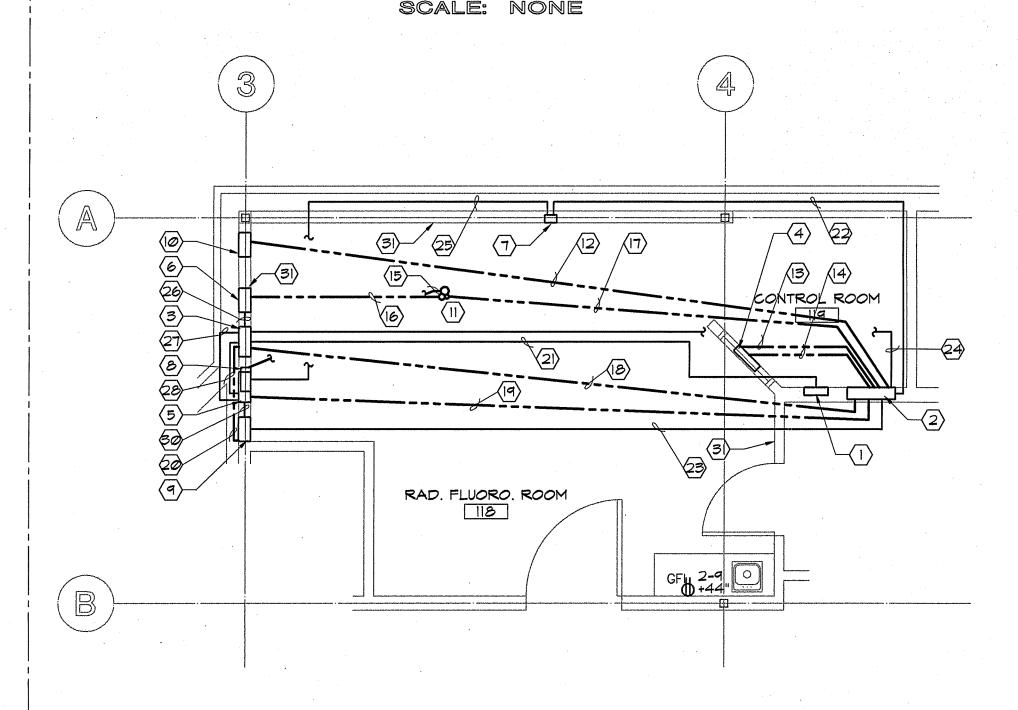

# ENLARGED POWER PLAN (2) SCALE: 1/4" = 1'-0"

RAD. FLUORO. ROOM 1 **ROOM 118** 

- 1. PROVIDE OVERSIZED COVERS ON ALL BOXES.
- 2. WIRING SHOWN SHALL BE STRANDED COPPER THAN AND EXTENDING 6' OUT OF BOXES.

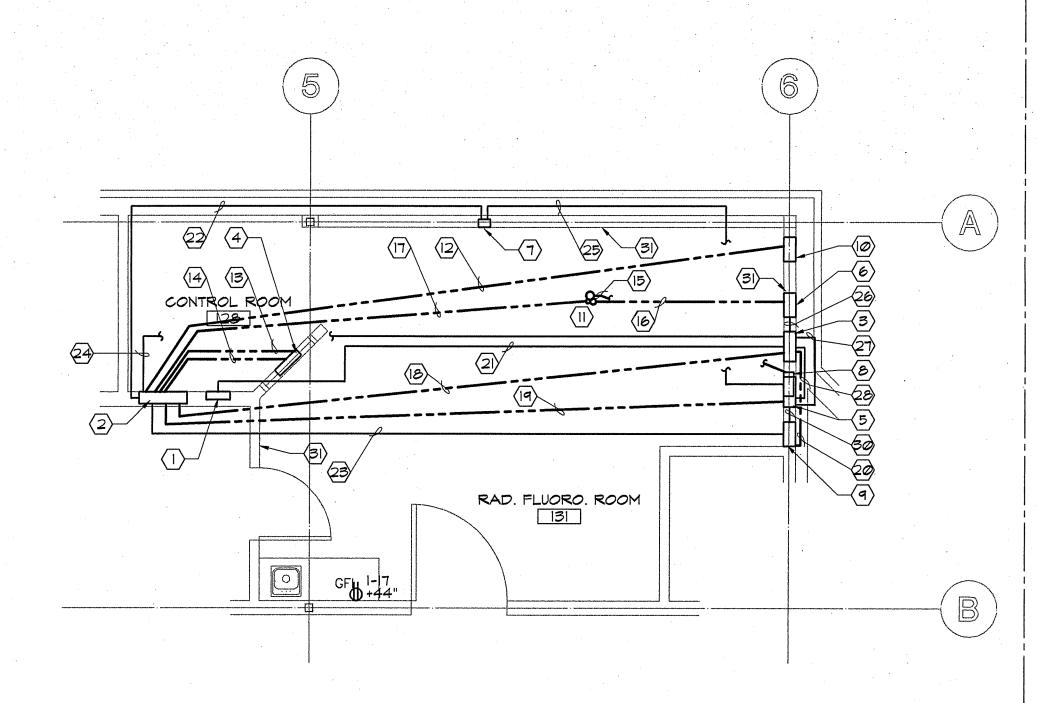



# ENLARGED POWER PLAN SCALE: 1/4" = 1'-0"


RAD. FLUORO. ROOM 2 ROOM 130

SOCIATE

PROJ. NO. 4369-96 36996432 12/08/96

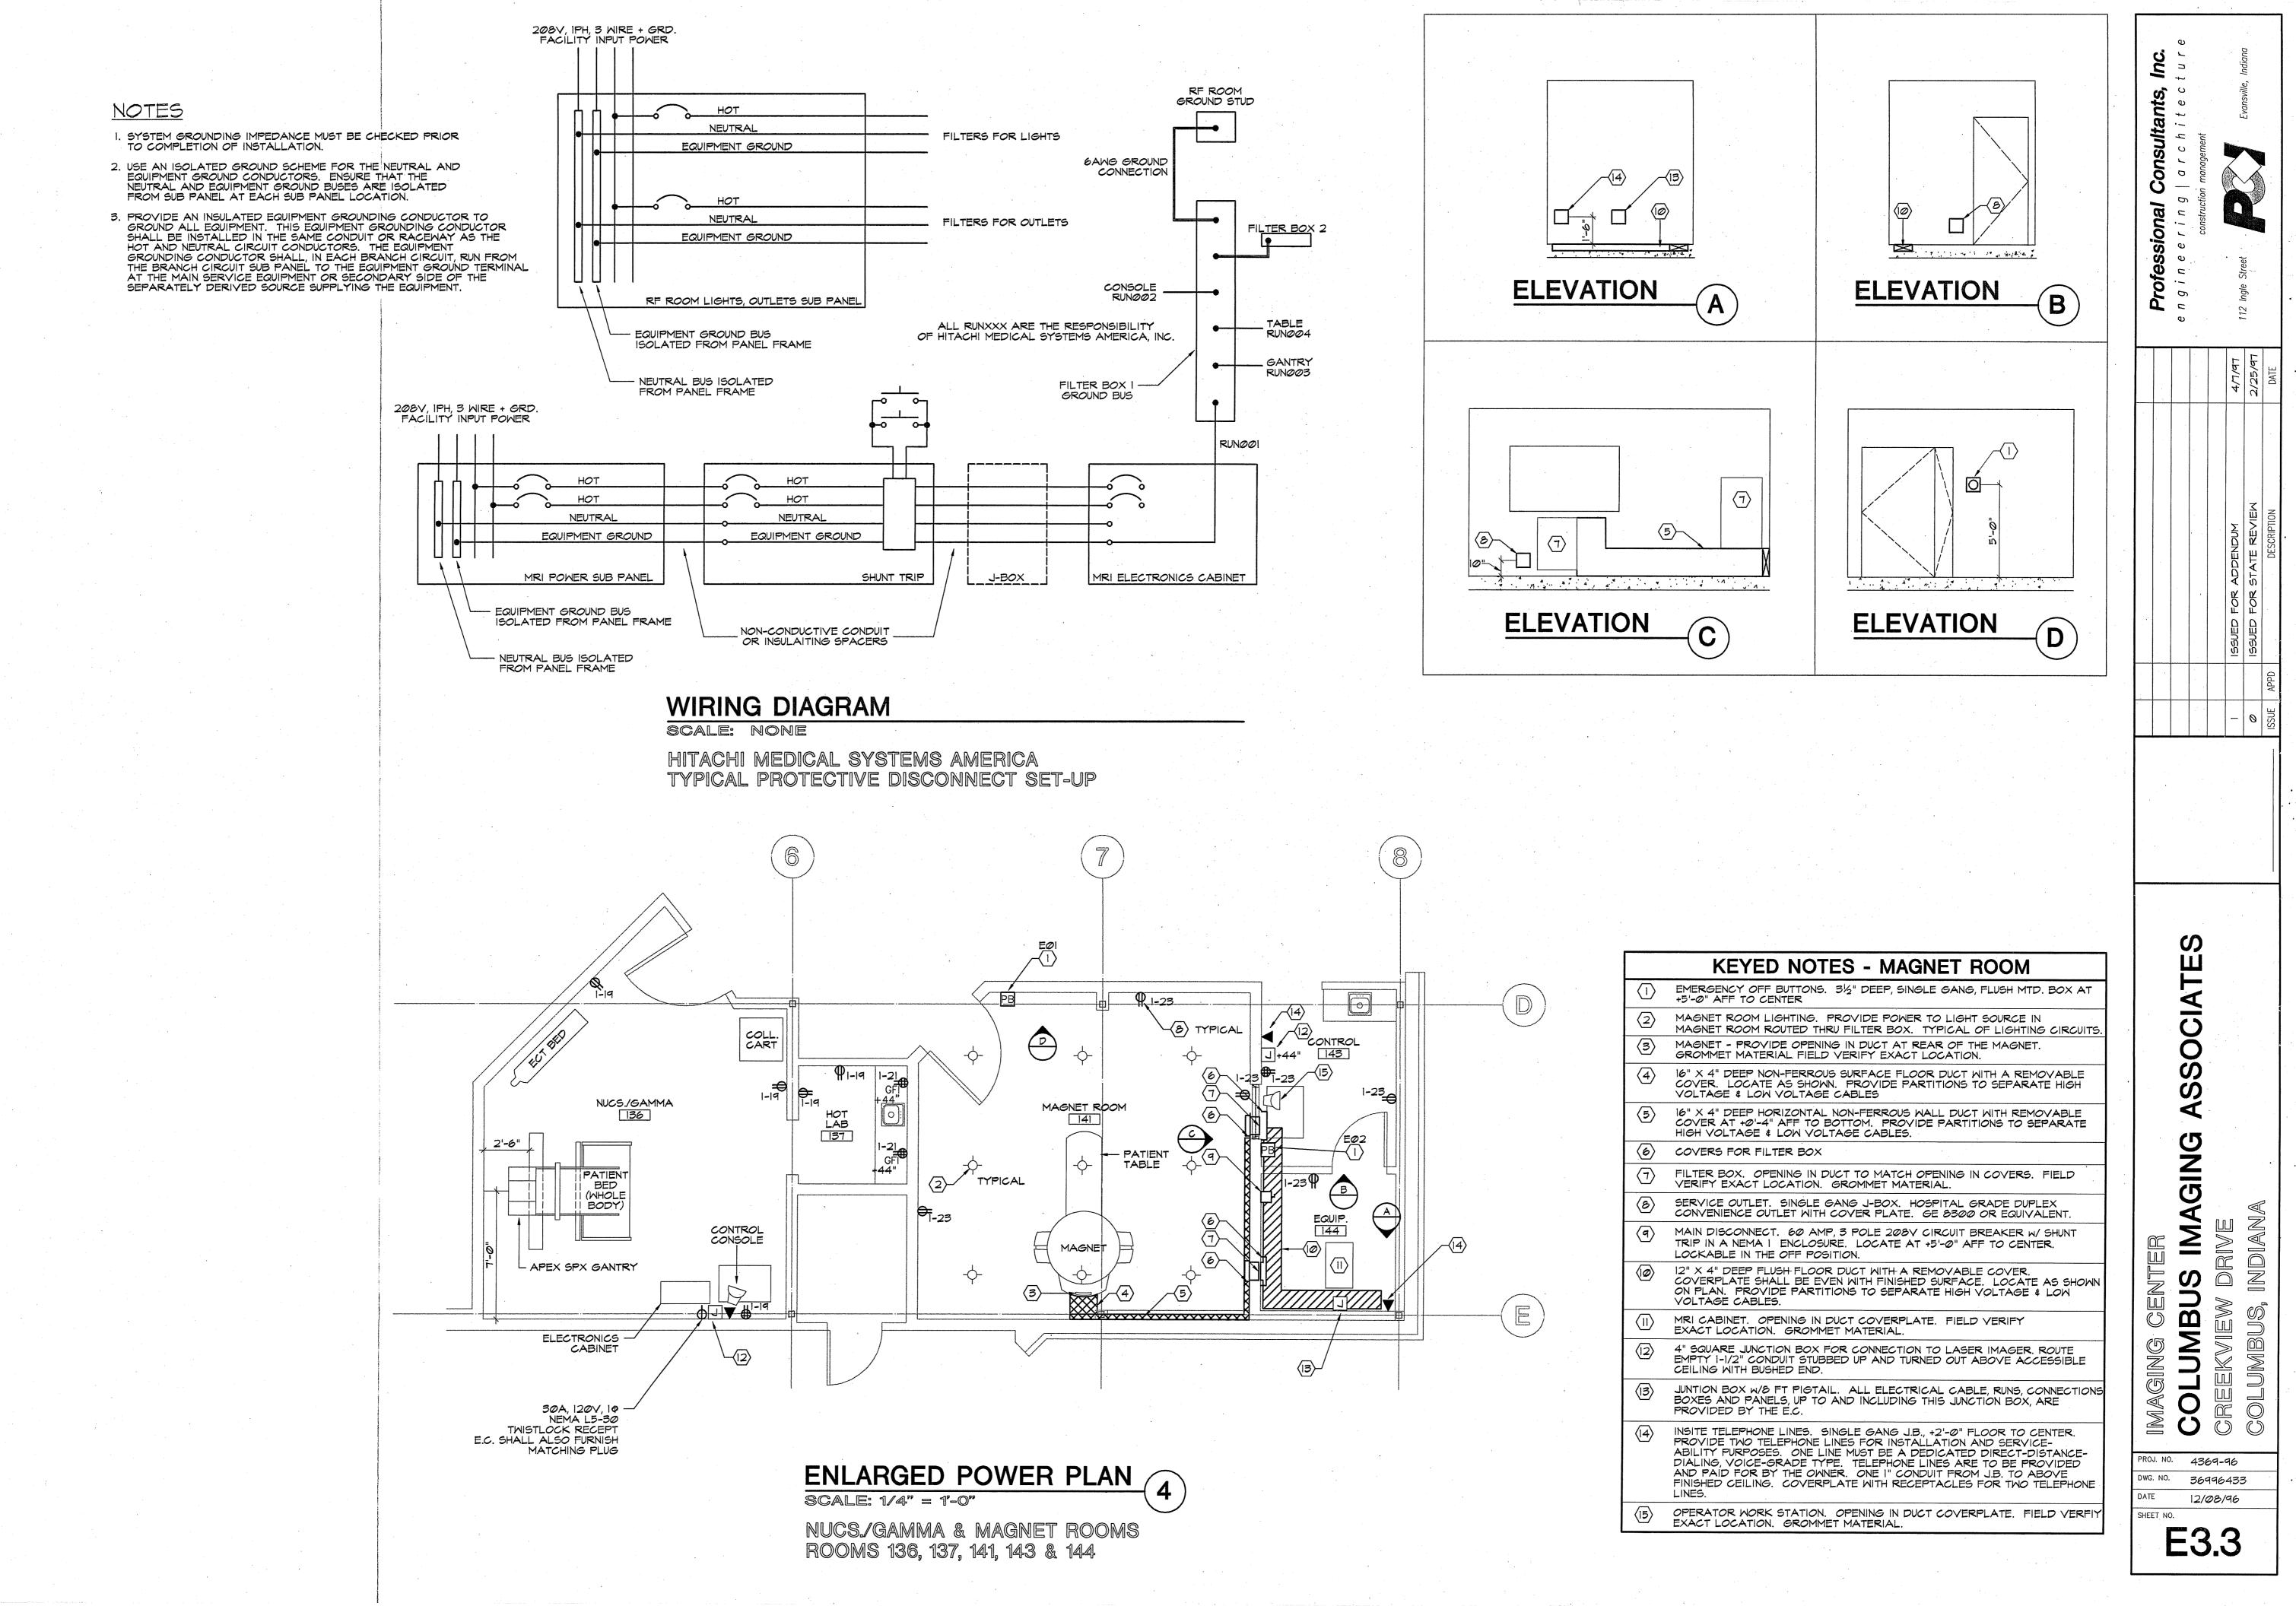

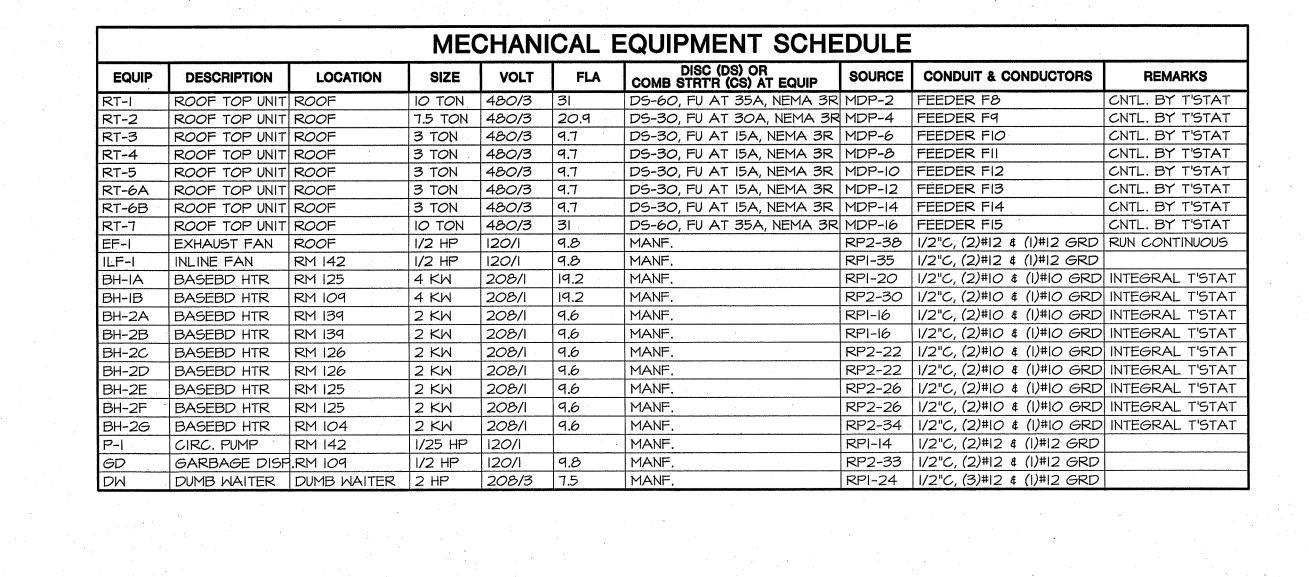

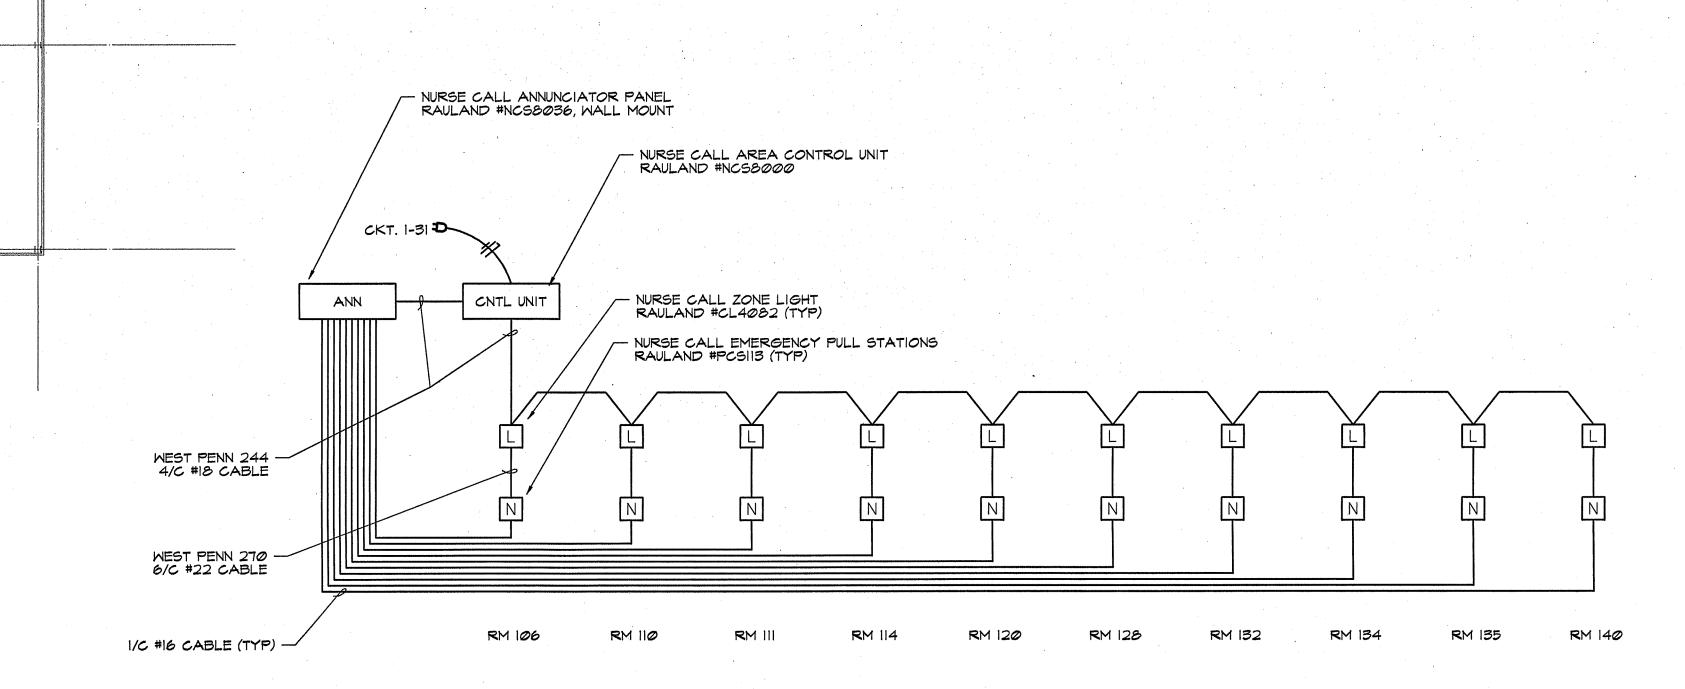

RT-7

SCALE: 1/8" = 1'-0"

SECOND FLOOR POWER PLAN

# NURSE CALL WIRING DIAGRAM SCALE: NONE

#### NOTES:

- 1. REFER TO SHEET EI.1 FOR ELECTRICAL NOTES, SYMBOL SCHEDULE, AND POWER DISTRIBUTION ONE LINE DIAGRAM.
- ALL RECEPTACLE CIRCUITS SHOWN ON THIS SHEET ARE DERIVED FROM PANEL RPI, UNLESS NOTED OTHERWISE.

Professional Consultants, Inc.

e n g i n e e r i n g | a r c h i t e c t u r e construction management

I ISSUED FOR ADDENDUM

O ISSUED FOR STATE REVIEW

APPD

DESCRIPTION

DATE:

DESCRIPTION

DATE:

DESCRIPTION


IMAGING ASSOCIATES

OLUMBUS IM,

PROJ. NO. 4369-96

DWG. NO. 36996434

DATE 1/21/97

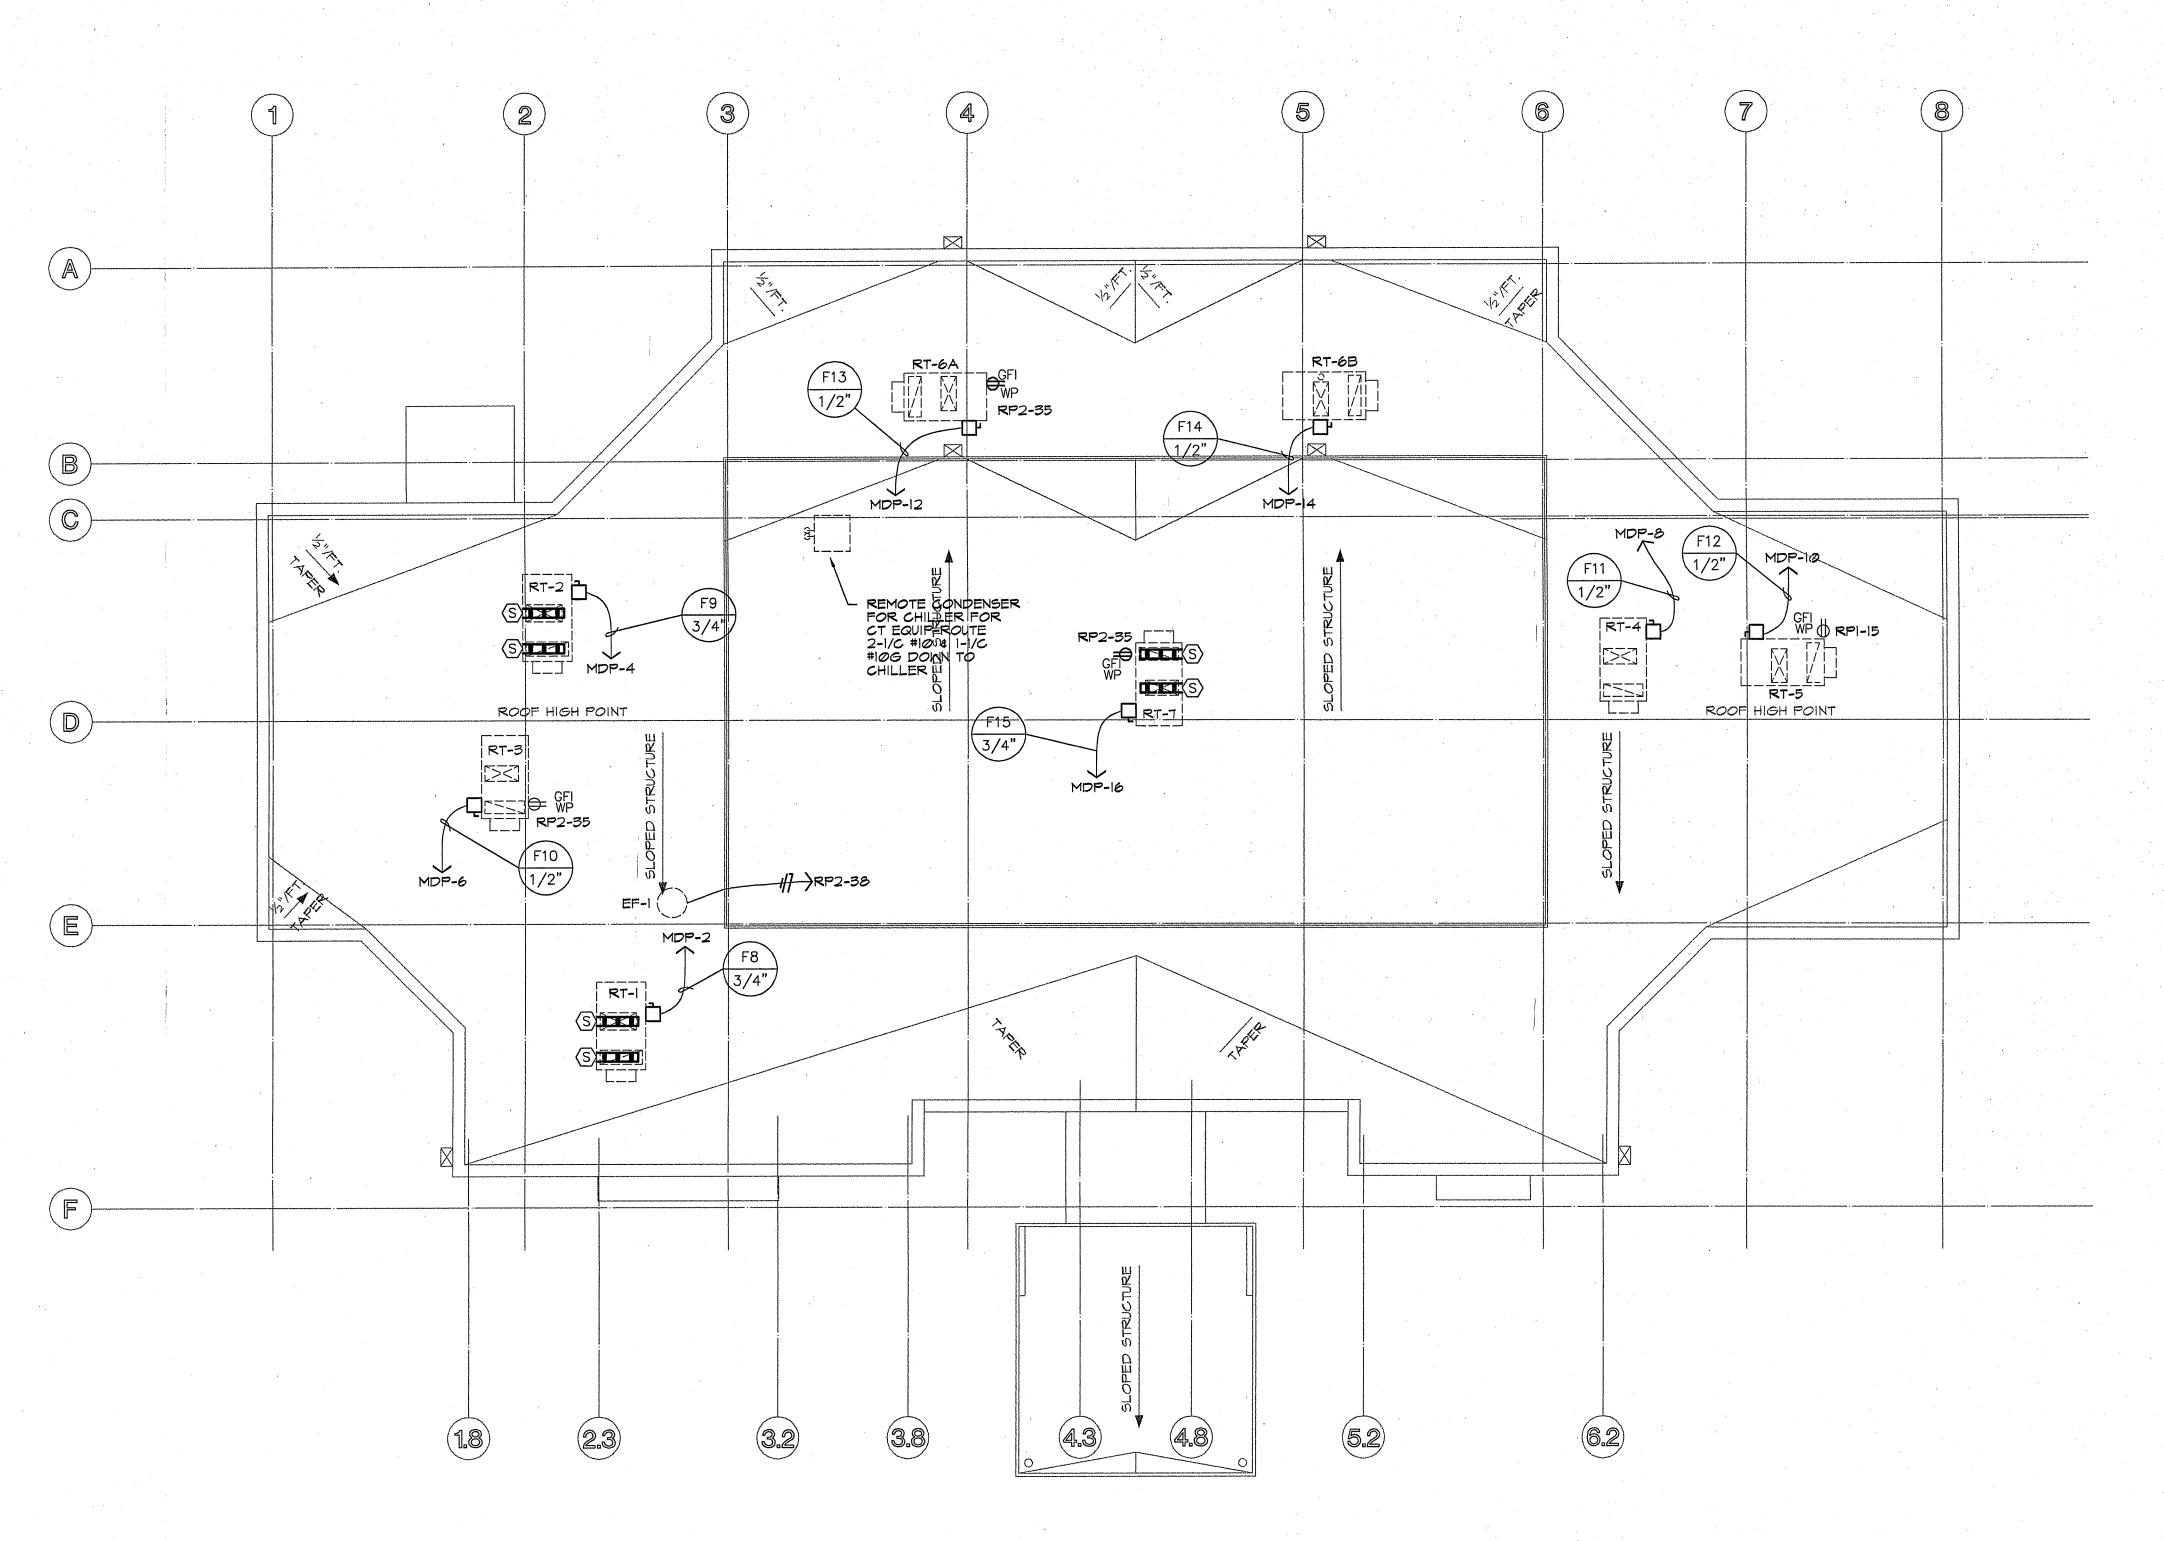

ELECTRICAL ROOF PLAN

SCALE: 1/8" = 1'-0"

NOTES:


REFER TO SHEET EI.I FOR ELECTRICAL NOTES, SYMBOL SCHEDULE, AND POWER DISTRIBUTION ONE LINE DIAGRAM.

2. REFER TO SHEET E3.4 FOR MECHANICAL EQUIPMENT SCHEDULE.

		4	2/.	
		ISSUED FOR ADDENDUM	ISSUED FOR STATE REVIEW	DESCRIPTION
		-		ISSUE APPD
		_	0	ISSUE

COLUMBUS, INDIANA
COLUMBUS, INDIANA

PROJ. NO. 4369-96 36996435 4/2/97

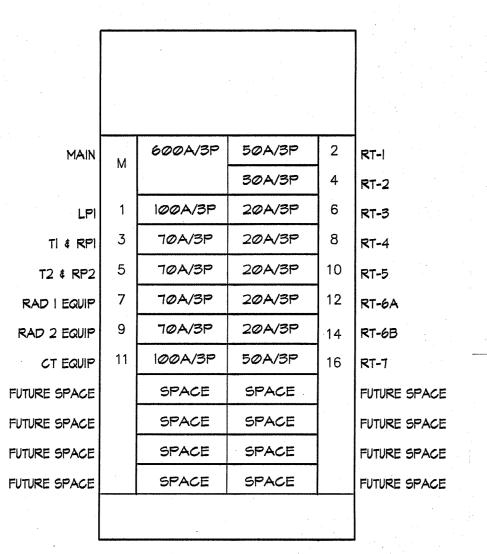

LTG - NUC, MECH, RAD 2, DRESS 1
LTG - CORRIDOR


LTG - EXAM, TECH CTR, RAD 1, DRESS 5
LTG - WORK, CT, TOILET, LOUNGE 110 SPARE
LTG - RECEPTION, WAITING 111 12 SPARE
LTG - 2ND FLOOR
SPARE SPARE
SPACE SPACE SPACE

PANEL LP1

100 AMP, 480/277 VOLT
3 PHASE, 4 WIRE

## PANEL MDP

600 AMP, 480/277 VOLT 3 PHASE, 4 WIRE

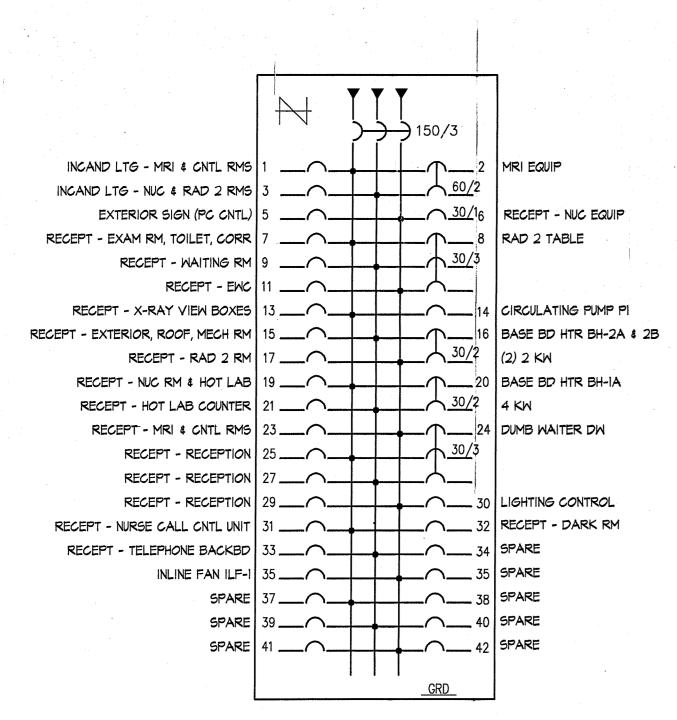


## INCAND LTG - DARK & RAD | RMS | 1 \_\_\_\_\_ X-RAY PROC I INCAND LTG - CT & CNTL RMS, & SHOWER RMS 3 RECEPT - EXAM RM, TOILET, CORR ( RECEPT - EXAM RM, TOILET, CORR RECEPT - CT & EQUIP RMS 1 RECEPT - WORK RM, TOILET, CORR RECEPT - X-RAY VIEW BOXES 19 \_\_\_\_\_ 30/2 (2) 2 KW $\frac{30}{2}$ (2) 2 KW 30/2 BASE BD HTR BH-26 20/2 RECEPT - EXTERIOR, ROOF

# PANEL RP1 150 AMP, 208/120 VOLT

3 PHASE, 4 WIRE

PANEL RP2
150 AMP, 208/120 VOLT
3 PHASE, 4 WIRE

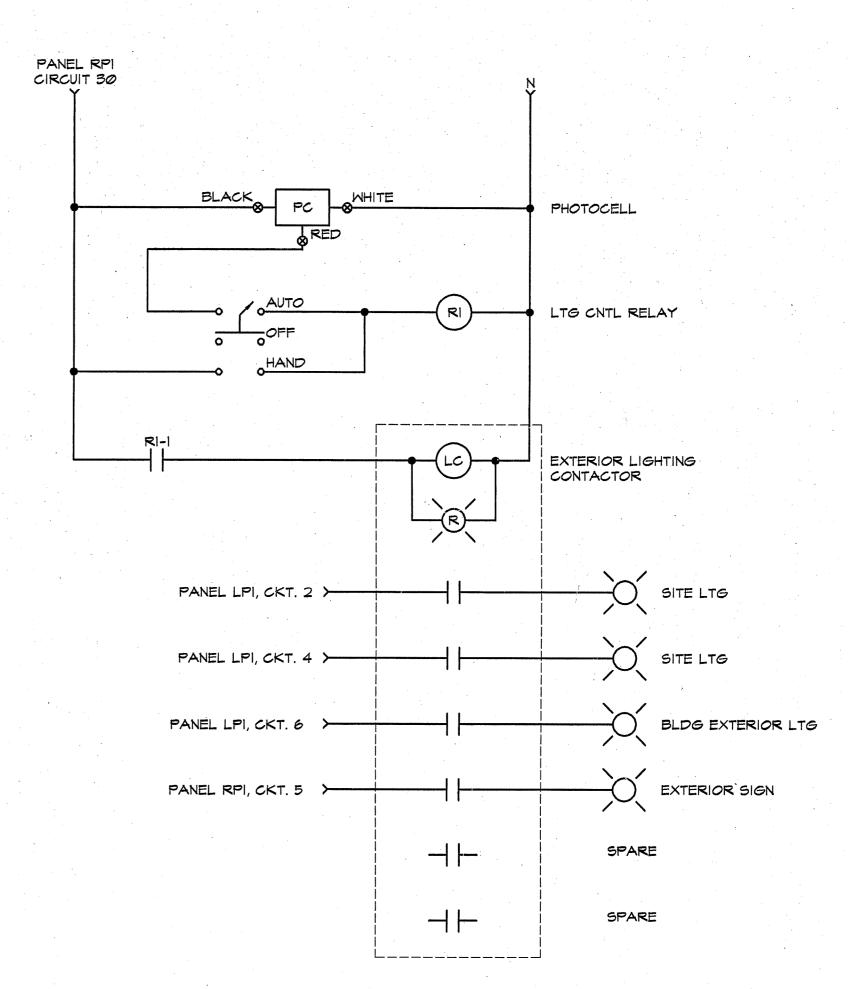

## WIRING DIAGRAM

SCALE: NONE

LIGHTING CONTACTOR

