23. A PERMIT GRANTED UNDER THIS CODE SHALL AUTOMATICALLY EXPIRE IF IT IS NOT EXERCISED OR EXTENDED WITHIN THREE YEARS OF ITS ISSUANCE, REFER TO SECTION 15-5013, EXPIRATION OF PLANNING ENTITLEMENTS, FOR MORE **INFORMATION ABOUT THE EXERCISE OF RIGHTS.** 24. NO TREE FOR WHICH A TREE REMOVAL PERMIT IS REQUIRED SHALL BE REMOVED UNTIL ALL CONDITIONS OF THE PERMIT HAVE BEEN SATISFIED AND THE DECISION HAS BECOME FINAL, IN ADDITION, TREE(S) APPROVED FOR REMOVAL IN CONJUNCTION WITH A DEVELOPMENT APPLICATION SHALL NOT BE REMOVED BEFORE THE ISSUANCE OF A BULDING PERMIT OR UNLESS ALL OF THE CONDITIONS OF APPROVAL OF THE DEVELOPMENT APPLICATIONS ARE SATISFIED. 25. NEW LANDSCAPING SHALL HAVE AN AUTOMATIC IRRIGATION SYSTEM DESIGNED TO PROVIDE ADEQUATE AND EFFICIENT COVERAGE OF ALL PLANT MATERIAL, IRRIGATION SYSTEMS SHALL COMPLY WITH THE REQUIREMENTS OF THE CALIFORNIA GREEN BUILDING STANDARDS CODE AND/OR THE CALIFORNIA MODEL WATER EFFICIENT LANDSCAPE ORDINANCE AND/OR THE CALIFORNIA PLUMBING CODE AS MAY BE AMENDED. 26. FUTURE TENANT IMPROVEMENTS SHALL BE REVIEWED AND APPROVED BY THE DEVELOPMENT AND RESOURCE MANAGEMENT DEPARTMENT TO ENSURE THAT ADEQUATE OFF-STREET PARKING IS PROVIDED. 27. APPLICANTS ARE ENCOURAGED TO PROVIDE SHARED VEHICLE AND PEDESTRIAN ACCESS BETWEEN ADJACENT PROPERTIES FOR CONVENIENCE, SAFETY, AND EFFICIENT CIRCULATION. A JOINT ACCESS COVENANT SHALL BE REQUIRED. 28. BICYCLE PARKING SPACES SHALL BE SUPPLIED ACCORDING TO TABLE 15-2429-D: REQUIRED ONSITE BICYCLE PARKING SPACES OF THE FRESNO MUNICIPAL CODE (FMC), EACH BICYCLE PARKING SPACE SHALL BE A MINIMUM OF 30 INCHES N WIDTH AND EIGHT FEET IN LENGTH AND SHALL BE ACCESSIBLE WITHOUT MOVING ANOTHER BICYCLE, AT LEAST 30 INCHES OF CLEARANCE SHALL BE PROVIDED BETWEEN BICYCLE PARKING SPACES AND ADJACENT WALLS, POLES, LANDSCAPING, STREET FURNITURE, DRIVE AISLES, AND PEDESTRIAN WAYS AND AT LEAST FIVE FEET FROM VEHICLE PARKING SPACES TO ALLOW FOR THE MANELVERING OF BIKES, OVERHEAD CLEARANCE SHALL BE A MINIMUM OF SEVEN FEET, A MINIMUM FIVE FOOT AISLE BETWEEN EACH ROW OF BICYCLE PARKING SHALL BE PROVIDED FOR BICYCLE MANEUVERING BESIDE OR BETWEEN EACH ROW, WHEN MULTIPLE ROWS ARE PROPOSED. BICYCLE PARKING SPACES SHALL NOT ENCROACH INTO PEDESTRIAN WAYS, LANDSCAPED AREAS, OR OTHER REQUIRED OPEN SPACES, AND SHALL BE LOCATED PROXIMAL to structures. 29. SCREEN ALL ROOF-MOUNTED EQUIPMENT FROM THE VIEW OF PUBLIC RIGHTS-OF-WAY, DEPICT ALL MECHANICAL EQUIPMENT ON SITE PLAN AND ELEVATIONS. 30. THIS PROJECT WAS REVIEWED BY THE FIRE DEPARTMENT ONLY FOR REQUIREMENTS RELATED TO WATER SUPPLY, FIRE HYDRANTS, AND FIRE APPARATUS ACCESS TO THE BUILDING(S) ON SITE, REVIEW FOR COMPLIANCE WITH FIRE AND LIFE SAFETY REQUIREMENTS FOR THE BULLDING INTERIOR AND ITS INTENDED USE ARE REVIEWED BY BOTH THE FIRE DEPARTMENT AND THE BUILDING AND SAFETY SECTION OF THE DEVELOPMENT AND RESOURCE MANAGEMENT WHEN A SUBMITTAL FOR BUILDING PLAN REVIEW IS MADE AS REQUIRED BY THE CALIFORNIA BUILDING CODE BY THE ARCHITECT

31. IF VIDEO SURVELLANCE CAMERAS ARE REQUIRED OR INSTALLED, PROVIDE SIGNS UNDER THE SURVELLANCE CAMERAS

33, THE OWNER/OCCUPANT SHALL PROPERLY MAINTAIN ALL LANDSCAPING TO ASSURE CONTINUOUS HEALTHY PLANT GROWTH.

34. VEHICLE REPAIR ACTIVITY SHALL BE LIMITED TO VEHICLES AND MOTORIZED EQUIPMENT USED EXCLUSIVELY ON SITE ONLY.

35. LANDSCAPING MUST BE IN PLACE BEFORE ISSUANCE OF THE CERTIFICATE OF OCCUPANCY. A HOLD ON OCCUPANCY

SHALL BE PLACED ON THE PROPOSED DEVELOPMENT UNTIL SUCH TIME THAT LANDSCAPING HAS BEEN APPROVED AND VERIFIED FOR PROPER INSTALLATION BY THE DEVELOPMENT SERVICES DIVISION.

37. SHOULD ANY UNDERGROUND STORAGE TANK(S) BE FOUND DURING THE PROJECT, THE APPLICANT SHALL APPLY FOR AND

36. SIGNS, OTHER THAN DIRECTIONAL SIGNS, IF APPLICABLE, ARE NOT APPROVED FOR INSTALLATION AS PART OF THIS APPLICATION.

SECURE AN UNDERGROUND STORAGE TANK REMOVAL PERMIT FROM THE FRESNO COUNTY DEPARTMENT OF PUBLIC HEALTH.

42. SUBMIT SIGNING AND STRIPING PLANS TO THE PUBLIC WORKS DEPARTMENT. COMPLY WITH THE CURRENT CAL TRANS STANDARDS.

44. CONTACT THE PUBLIC WORKS DEPARTMENT, TRAFFIC ENGINEERING AT 559-621-8800, 10 WORKING DAYS PRIOR TO ANY OFFSITE

46. THE PROPOSED USE AND OPERATION SHALL COMPLY WITH ARTICLE 25 - PERFORMANCE STANDARDS CONTAINED IN THE FMC.

47. THE PROPOSED USE AND OPERATION SHALL COMPLY WITH ARTICLE 25 - PERFORMANCE STANDARDS CONTAINED IN THE FMC.

48. DEPARTMENT OF PUBLIC UTILITIES (SEWER, SOLID WASTE, WATER): SEE MEMORANDA DATED SEPTEMBER 16, 2022: DPU CONDITIONS OF

77'-10"

43. PROVIDE A 4" MINIMUM PATH OF TRAVEL ALONG THE PUBLIC SIDEWALK DIRECTLY IN FRONT OF PROPERTY, TO MEET CURRENT

ACCESSIBILITY REGULATIONS, A PEDESTRIAN EASEMENT MAY BE REQUIRED IF REQUIREMENTS ARE NOT MET.

45. ALL DEVELOPMENT SHALL, TAKE PLACE IN ACCORDANCE WITH ALL CITY LAWS AND REGULATIONS.

APPROVAL FOR P22-01086 PROPOSED APARTMENT COMPLEX APN 403-532-28

38. THE PERFORMANCE OF ANY WORK WITHIN THE PUBLIC STREET RIGHT-OF-WAY REQUIRES A STREET WORK PERMIT PRIOR TO

ENVIRONMENTAL HEALTH DIVISION, CONTACT THE CERTIFIED UNIFIED PROGRAM AGENCY AT (559) 600-3271 FOR MORE INFORMATION.

COMMENCEMENT OF WORK, ALL REQUIRED STREET IMPROVEMENTS MUST BE COMPLETED AND ACCEPTED BY THE CRRV PRIOR TO

inoperative vehicles and equipment shall be removed or stored within an enclosed building <u>only,</u>

ANY UN-EALTHY OR DEAD LANDSCAPING SHALL BE REMOVED AND REPLANTED BY THE OWNER IN ACCORDANCE WITH APPROVED

WHICH NOTIFY THE PUBLIC THAT THE SUBJECT PROPERTY IS MONITORED BY VIDEO SURVEILLANCE,

OR ENGINEER OF RECORD FOR THE BUILDING.

15-2017 AND PUBLIC WORKS POLICY NO. 260.01.

40. SUBMIT STREET CONSTRUCTION PLANS TO THE PUBLIC WORKS DEPARTMENT.

41. SUBMIT STREET LIGHTING PLANS TO THE PUBLIC WORKS DEPARTMENT

LANDSCAPE PLANS.

FIRE DEPARTMENT NOTES: REQUIRED FIRE HYDRANT INSTALLATIONS AND ALL WEATHER ACCESS ROADS SHALL BE INSTALLED AND MAINTAINED IN A SERVICEABLE CONDITION PRIOR TO DELIVERY OF COMBUSTIBLE MATERIAL TO THE JOB SITE, 03.002) 2. FIRE DEPARTMENT CONNECTIONS SHALL NOT BE INSTALLED WITHIN FIVE (5) FEET OF ANY BULDING OPENING, EXCLUDING A FIRE DEPARTMENT RISER ACCESS DOOR. 3. FIRE DEPARTMENT CONNECTIONS SHALL BE LOCATED WITHIN FORTY (40) FEET OF A FIRE APPARATUS ACCESS LANE, (FFD DEVELOPMENT POLICY 405,025) THE MINIMUM SIZE OF ALL FIRE DEPARTMENT CONNECTIONS SHALL BE BASED UPON THE SYSTEM TYPE, NO CONNECTION SHALL BE LESS THAN 2½ NCH IN SIZE, (FFD DEVELOPMENT POLICY 405,025) 5. FIRE DEPARTMENT CONNECTIONS SHALL BE LOCATED ON THE STREET SDE OF BULLDINGS, FULLY VISIBLE AND RECOGNIZABLE FROM THE STREET OR NEAREST POINT OF FIRE DEPARTMENT VEHICLE ACCESS OR AS OTHERWISE APPROVED BY THE FIRE CHIEF, 2019 CFC, SECTION 6. ADDRESS IDENTIFICATION, FOR NEW AND EXISTING BUILDINGS, THE FIRE CODE OFFICIAL IS AUTHORIZED TO REQUIRE APPROVED ADDRESS OR BUILDING AREA IDENTIFICATION SIGNAGE AS NEEDED TO READLY DETERMINE THE BUILDING OR AREA OF A BUILDING PROTECTED BY FIRE DEPARTMENT CONNECTIONS, FMC SECTION 10-50912.2.3 ALL GATED RESIDENTIAL DEVELOPMENTS REQUIRE A "CLICK TO ENTER SYSTEM", WHEN REQUIRED, PROVIDE AN APPROVED VISUAL RECOGNITION/FEATURE SIGN AT THE "CLICK TO ENTER" GATE LOCATIONS. 8. PROVIDE APPROVED POLICE/FIRE BYPASS LOCK ("BEST" PADLOCK MODEL 2B700 SERIES OR ELECTRIC CYLINDER SWITCH MODEL 1W7B2) ON DRIVE ACCESS GATE(S), ALL ELECTRIFIED GATES SHALL BE EQUIPPED WITH THE BEST ELECTRIC CYLINDER LOCK IW7B2, A KNOX PADLOCK MAY NOT BE USED IN PLACE OF THE BEST PADLOCK MODEL 218700. THESE LOCKS CAN BE PURCHASED ONLY THROUGH SERRA LOCK & GLASS, 1560 N. PALM AVENUE, FRESNO, CA 93728. 9. REQUIRED FIRE APPARATUS ACCESS LANES SHALL BE PROVIDED YEAR ROUND AND MAINTAINED WITH AN APPROVED ALL-WEATHER SURFACE, CAPABLE OF SUPPORTING 80,000-POUND VEHICLES. THE FIRE APPARATUS ACCESS LANES SHALL BE A MINIMUM OF 4-INCH BASE ROCK OVER COMPACTED OR UNDISTURBED NATIVE SOL OR PER APPROVED ENGINEERING PLANS WITH A MINIMUM OF 24 FEET OF CLEAR WIDTH OR OTHER APPROVED METHOD, WHICH WOULD PREVENT SHOULDER DEGRADATION. (FFD DEVELOPMENT POLICY 403,002). IO. ALL TYPES OF VEHICLE ACCESS SHALL MAINTAIN A MINIMUM OF 13 FEET, 6 INCH VERTICAL CLEARANCE OVER THE ENTIRE WIDTH OF THE ACCESS, (FFD DEVELOPMENT POLICY 403,002) IL OVERHEAD UTILITY, POWER LINES, LARGE TREES, AND OTHER OBSTRUCTIONS SHALL NOT BE LOCATED OVER THE AERIAL FIRE APPARATUS ACCESS ROAD OR BETWEEN THE AERIAL FIRE APPARATUS ROAD AND THE BUILDING, (FFD DEVELOPMENT POLICY 403,002) 12. EMERGENCY ACCESS GATES ACROSS ENTRANCES THAT HAVE BEEN DESIGNED FOR USE BY FIRE AND POLICE PERSONNEL ONLY SHALL BE DESIGNATED ON THE PROPERTIES SITE PLAN PRIOR TO CONSTRUCTION OF THE COMPLEX, (FFD DEVELOPMENT POLICY 403,005) THE SIGN BELOW IS REQUIRED ON BOTH SIDES OF THE GATE: "FIRE LANE" (IN 6 INCH LETTERS) "VEHICLES REMOVED AT OWNER'S EXPENSE" (IN 2 NCH LETTERS) "FRESNO POLICE DEPARTMENT AT (559) 621-7000" (IN 1 INCH LETTERS). 14. BUILDINGS AND EXTERIOR STORAGE AREAS OVER 450 FEET IN DEPTH OR WIDTH, BUT LESS THAN 650 FEET IN DEPTH OR WIDTH, MAY BE ALLOWED TO HAVE A SINGLE POINT OF ACCESS WITH APPROVED TURNAROUNDS COMPLYING WITH FFD POLICY 403,002, (FFD DEVELOPMENT POLICY 403,002) 15. REGARDLESS OF PARKING CONFIGURATIONS, A MINIMUM CLEAR DRIVE WIDTH OF 20 FEET SHALL BE REQUIRED. THE FIRE MARSHAL (OR DESIGNEE) MAY REQUIRE INCREASES IN THESE WIDTHS. (FFD DEVELOPMENT POLICY 403,002). 16. LOADING ZONES SHALL NOT BE LOCATED IN REQUIRED FIRE LANES, CURRENTLY, THE PLAN INDICATES THE FIRE LANE IN FRONT OF TRASH ENCLOSURES WHICH ARE ALSO LABELED AS LOADING ZONES. 17. FIRE HOSE PULL AND EQUIPMENT ACCESS IS AN UNOBSTRUCTED WALKWAY WHICH PROVIDES CONTINUOUS ACCESS CONNECTING VEHICULAR ACCESS TO ALL BUILDING OPENINGS AND EXTERIOR STORAGE AREAS. THE WALKWAY REQUIRES UNOBSTRUCTED 36 INCH HORIZONTAL CLEARANCE AROUND OPENINGS AND CONTINUOUS 7 FOOT VERTICAL CLEARANCE. (FFD DEVELOPMENT POLICY 403.002) 18. REQUIRED WALKING ACCESS SHALL BE DESIGNED TO PREVENT SHARP TURNS AND OBSTACLES WHICH WOULD HINDER THE CARRYING OF HOSES, GROUND LADDERS AND OTHER HAND HELD EQUIPMENT. 19. ALL GATES ACROSS FIRE HOSE AND EQUIPMENT ACCESS POINTS SHALL BE A MINIMUM OF 4 FOOT CLEAR WIDTH. 20. ALL REQUIRED FIRE HOSE AND EQUIPMENT ACCESS GATES SHALL REMAIN UNLOCKED OR BE PROVIDED WITH POLICE/FIRE BYPASS LOCKS. ('BEST' PADLOCK MODEL 218700 SERIES), A KNOX PADLOCK MAY NOT BE USED, POLICE/FIRE BYPASS LOCKS CAN BE PURCHASED ONLY THROUGH SIERRA LOCK & GLASS, 1560 N. PALM AVENUE, FRESNO, CA 93728. PUBLIC WORKS DEPARTMENT NOTES: ANY SURVEY MONUMENTS WITHIN THE AREA OF CONSTRUCTION SHALL BE PRESERVED OR RESET BY A PERSON LICENSED TO PRACTICE LAND SURVEYING IN THE STATE OF CALIFORNIA. REPAIR ALL DAMAGED AND/OR OFF-GRADE CONCRETE STREET IMPROVEMENTS AS DETERMINED BY THE CONSTRUCTION MANAGEMENT ENGINEER, PRIOR TO OCCUPANCY. UNDERGROUND ALL EXISTING OVERHEAD UTILITIES WITHIN THE LIMITS OF THIS APPLICATION AS PER FRESNO MUNICIPAL CODE SECTION TWO WORKING DAYS BEFORE COMMENCING EXCAVATION OPERATIONS WITHIN THE STREET RIGHT-OF-WAY AND/OR UTILITY EASEMENTS, ALL EXISTING UNDERGROUND FACILITIES SHALL HAVE BEEN LOCATED BY UNDERGROUND SERVICES. THE PERFORMANCE OF ANY WORK WITHIN THE PUBLIC STREET RIGHT-OF-WAY REQUIRES A STREET WORK PERMIT PRIOR TO COMMENCEMENT OF WORK, ALL REQUIRED STREET IMPROVEMENTS MUST BE

COMPLETED AND ACCEPTED BY THE CITY PRIOR TO OCCUPANCY.

6. DEEDS ARE REQUIRED TO PROVIDE EASEMENTS TO THE CITY FOR REQUIRED PUBLIC

8. SUBMIT STREET CONSTRUCTION PLANS TO THE PUBLIC WORKS DEPARTMENT.

IO WORKING DAYS PRIOR TO ANY OFFSITE CONCRETE CONSTRUCTION.

10. SUBMIT SIGNING AND STRIPING PLANS TO THE PUBLIC WORKS DEPARTMENT. COMPLY

12. CONTACT THE PUBLIC WORKS DEPARTMENT, TRAFFIC ENGINEERING AT 559-621-8800,

ALL DEVELOPMENT SHALL TAKE PLACE IN ACCORDANCE WITH ALL CITY LAWS AND

SUBMIT STREET LIGHTING PLANS TO THE PUBLIC WORKS DEPARTMENT.

IMPROVEMENTS, THEY SHALL BE PREPARED BY THE OWNER / DEVELOPER'S ENGINEER.

7. UNDERGROUND ALL EXISTING OVERHEAD UTILITIES WITHIN THE LIMITS OF THIS APPLICATION

II. PROVIDE A 4' MINIMUM PATH OF TRAVEL ALONG THE PUBLIC SIDEWALK DIRECTLY IN FRONT

OF PROPERTY, TO MEET CURRENT ACCESSIBILITY REGULATIONS. A PEDESTRIAN EASEMENT

603.54' PROPERTY LINE

EXECUTED COPIES SHALL BE SUBMITTED TO THE CITY WITH VERIFICATION OF OWNERSHIP

AS PER FRESNO MUNICIPAL CODE SECTION 15-2017 AND PUBLIC WORKS POLICY NO.260.01.

DAYS PRIOR TO ANY OFF-SITE CONCRETE CONSTRUCTION.

PRIOR TO THE ISSUANCE OF BUILDING PERMITS.

WITH THE CURRENT CALTRANS STANDARDS.

REGULATIONS.

B24-O9277

MAY BE REQUIRED IF REQUIREMENTS ARE NOT MET.

5. CONTACT THE PUBLIC WORKS DEPARTMENT, TRAFFIC ENGINEERING AT (559) 621-8800, IO WORKING

SITE INFORMATION <u>+</u> 91,738 SQ. FT. (2.11 AC) 24,915 SQ.FT (27 %) SETBACKS REQ. FRONT: IOFT MIN. 20FT MAX. IOFT TOTAL SETBACKS PROVIDED: PARKING REQ. PARKING PROVIDED: (2 ACCESSIBLE CARPORT SPACES) 28 OPEN SPACES (4 ACCESSIBLE OPEN SPACES) NOTE: 5% ACCESSIBLE PARKING SPACES REQ TOTAL SPACES PROVIDED = 68 40 CARPORT SPACES X IO% = 4 28 OPEN SPACES X IO% = 3 EV PARKING REQ.: TOTAL EV SPACES REQUIRED = 1 IO CARPORT SPACES

4 OPEN SPACES EV PARKING PROVIDED: TOTAL EV SPACES PROVIDED = 14 BICYCLE PARKING REQ. PARKING PROVIDED: 2 SPACES MIN. 2 SPACES LOT AREA 91,738 SQ. FT. X 0.2 - 18,348 SQ.FT.

PROP. RIGHT OF WAY -

PROJECT DIRECTORY 1554 SHAW AVENUE CLOVIS, CA 9361 (559) 765-4603 10YAHOO.COM ARCHITECT: ARCHITECT - LIC.# C-1779! LOVIS, CA 9361 DBREMSETHOSBCGLOBAL.NET PROJECT DATA SITE ADDRESS: 8715 N. CHESTNUT AVENUE FRESNO, CA 93619 APN: 403-532-28 EXISTING ZONING: RS-4/UGM PROPOSED ZONING: RM-I/MEDIUM HIGH DENSITY GENERAL PLAN RESIDENTIAL MEDIUM - LOW DENSITY LAND USE GENERAL PLAN RESIDENTIAL MULTI-FAMILY MEDIUM HIGH DENSITY OCCUPANCY: LEGAL DESCRIPTION: THE LAND REFERRED TO IS SITUATED IN THE COUNTY OF FRESNO, CITY OF FRESNO, STATE OF CALIFORNIA, AND IS DESCRIBED AS FOLLOWS: THE NORTH 152 FEET OF LOT 12 OF GARFIELD PARK COLONY, ACCORDING TO THE MAP THEREOF RECORDED IN BOOK 2 PAGE 66 OF RECORDS OF SURVEYS, IN THE OFFICE OF THE FRESNO COUNTY RECORDS. APN: 403-532-28

SECTION LINE & CENTERLINE

— SECTION LINE ξ CENTERLINE

EX. RIGHT OF WAY

REVISIONS:


03-31-2025

DONALD R. BREMSETH ARCHITECT · C-11195 PH (559) 797-4946 CELL (559) 681-1070 dbremseth@sbcglobal.net

PROJECT NO .: 07-10-24

SHEET NO .:

OF ____ SHEETS

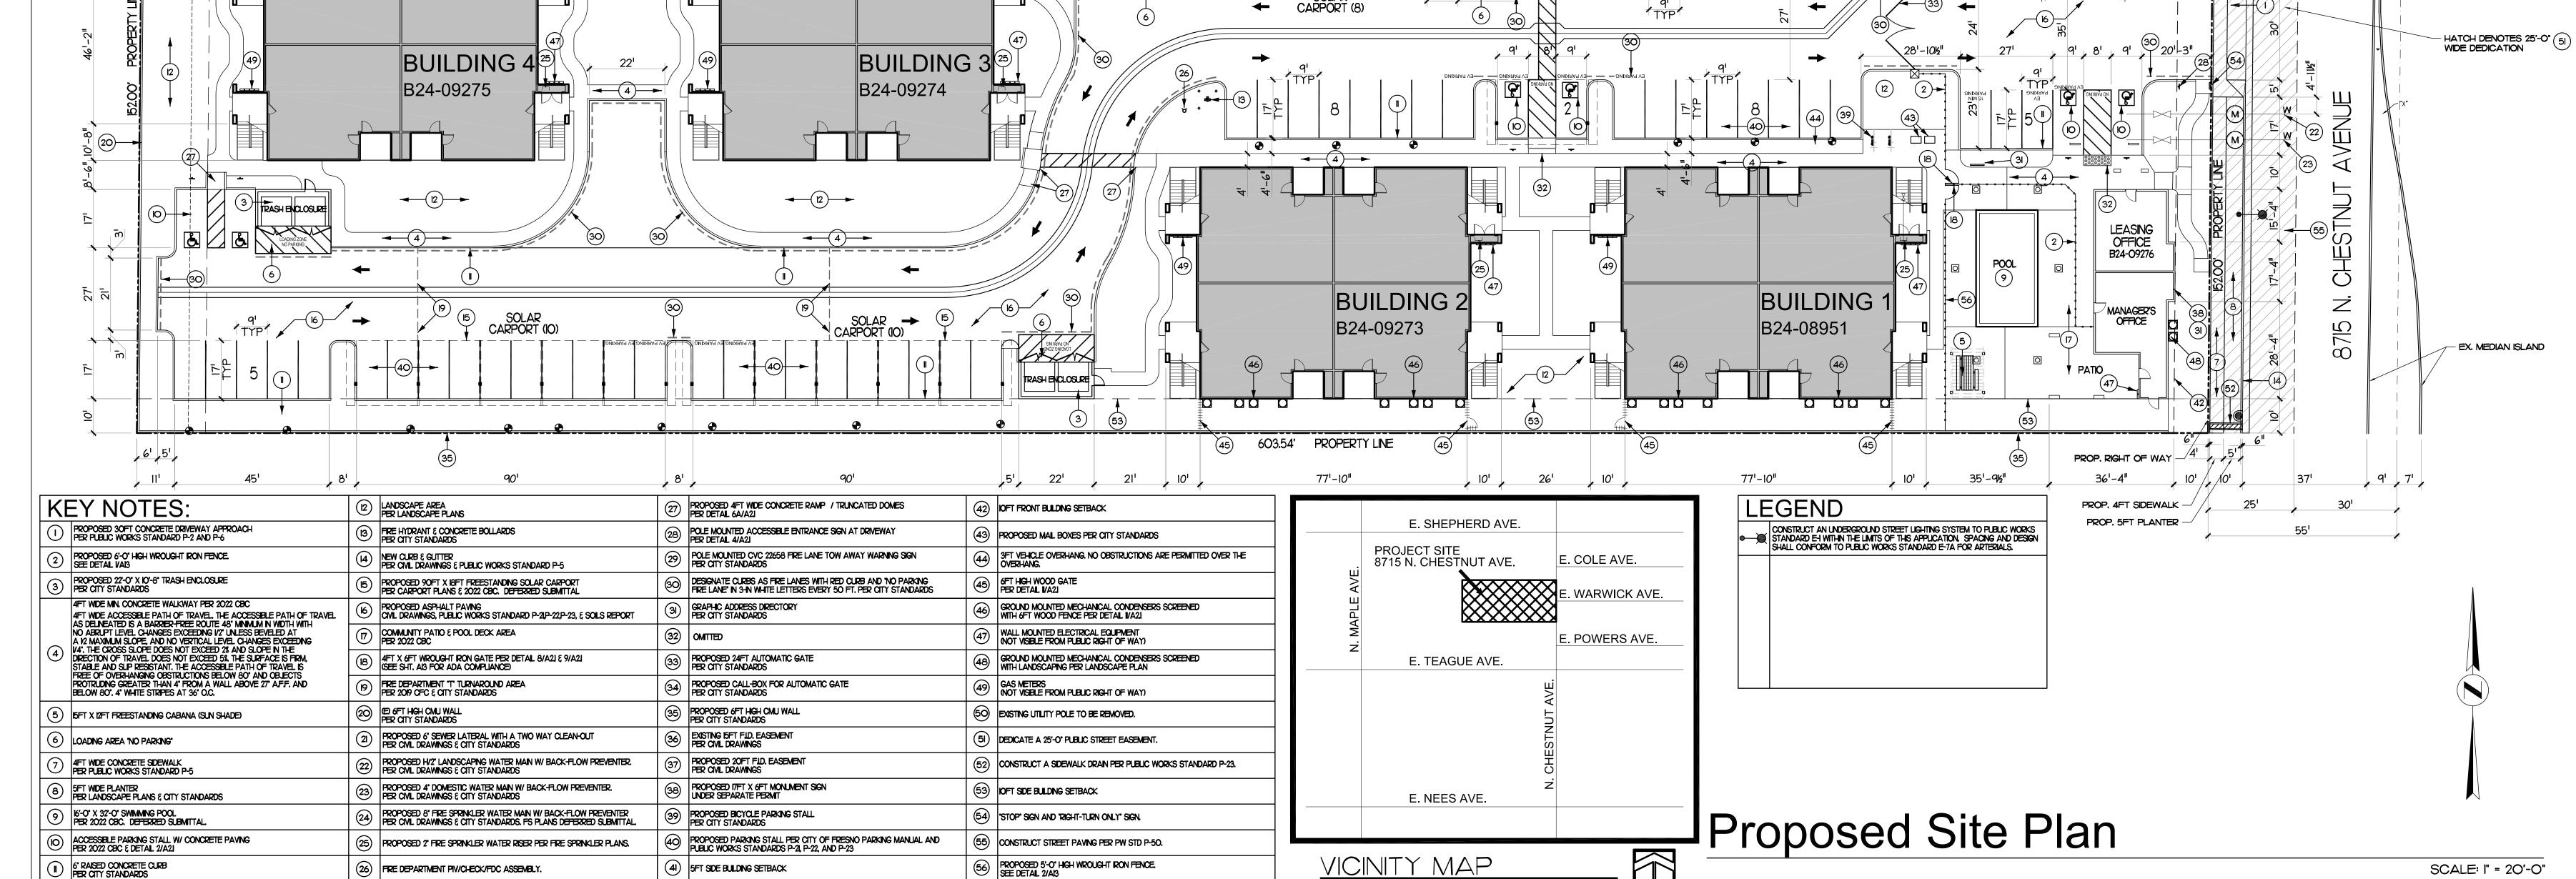

NO SCALE

2. SECURITY CODE ORDINANCE COMPLIANCE REQUIREMENTS 2. STEEL PLATE AT DEADBOLT STRIKER, SOLID SHIM 6" ABOVE AND BELOW WITH 2-#8X2" SCREWS. 3. WINDOWS SHALL MEET MINIMUM STANDARDS AS

4. PROVIDE DEAD BOLTS AT ALL EXTERIOR DOORS 3. NO THUMB LATCHES OR KEYED CYLINDER DEAD BOLTS ARE ALLOWED ON ANY DOORS UNLESS OPERATED BY A SINGLE ACTION WITH A LEVER. LEVER HARDWARE AT ALL

FLUSH BOLTS AND SURFACE BOLTS OR ANY TYPE OF DEVICE THAT MAY BE USED TO CLOSE OR RESTRAIN THE DOOR OTHER THAN THE OPERATION OF THE LOCKING

DEVICE SHALL NOT BE USED ARE PROHIBITED. 5. REGARDLESS OF THE OCCUPANT LOAD SERVED EXIT DOORS SHALL BE OPENABLE FROM THE INSIDE WITHOUT THE USE OF A KEY OR ANY SPECIAL KNOWLEDGE OR

6. ESCAPE OR RESCUE WINDOWS SHALL HAVE A MINIMUM NET CLEAR OPENABLE AREA OF 5.7 SQUARE FEET. THE FINISHED SILL HEIGHT SHALL NOT BE MORE THAN 44"

ABOVE THE FLOOR. 7. INTERIOR DOORS FOR BATHROOMS AND BEDROOMS SHALL PROVIDE A MIN. NET CLR. OPENING OF 32" WHEN OPEN AT 90 DEGREES. CBC 1132.A.3.

8. STRIKE SIDE CLEARANCE SHALL BE A MIN. OF 18". CBC 1132A.5..2. 9. DOOR MANUVERING SPACE MIN. 42" DEEP BOTH SIDES OF INTERIOR DOORS.

10. PROVIDE DOOR SIGNALING DEVICE 48" ABOVE GRADE (TO TOP) CBC 1132.10. II. ACCESSIBLE ADAPTABLE UNIT ENTRY DOORS SHALL

HAVE A "PEEP" HOLE AT A MAX. 46" ABOVE FINISH

12. OPTION '2' WILL BE USED FOR RESTROOM DESIGN FOR ACCESSIBILITY. 13. MAXIMUM OF 48" TO TOP OF THE THERMOSTAT. CBC

14. ACCESSIBILITY REACH SHALL BE A MAXIMUM OF 24" AT WASHER & DRYER AT AT KITCHEN COUNTERS. CBC 1142A

HAGER COMPANY MODEL NO, - RC1842-1C312 3 1/2" FULL MORTISE HINGE | 3/4" THK, DOOR (TYPICAL) 16. PROVIDE BRADLEY MODEL 8370-108 SWING UP GRAB BAR 30" LENGTH WITH INTEGRAL TOILET PAPER HOLDER AT BATH I AT EACH UNIT ON FIRST FLOOR, SEE DETAIL

SHEET A.14 17. FIRE TEST CRITERIA. FIRE-RESISTANT JOINT SYSTEMS SHALL BE TESTED IN ACCORDANCE WITH THE

REQUIREMENTS OF EITHER ASTM EI966 OR UL 2079 PER CBC 715.3. 18. THRESHOLDS FOR INTERIOR & SECONDARY EXTERIOR

DOORS PER CBC 1132A.414 A) PRIMARY ENTRY AND REQUIRED EXIT DOORS - MAX. 1/2"H B) SECONDARY EXTERIOR DOORS -MAXIMUM 34"H

C) INTERIOR DOORS FOR MATERIAL DIFFERENCES - 1/2"H 1/4"H THRESHOLD CHANGE IN HEIGHT MAY BE VERTICAL 34"H THRESHOLD CHANGE SHALL BE ≤1:

18. ALL FIRST FLOOR UNITS SHALL BE ADAPTABLE AND COMPLIANT WITH 2019 CBC CHAPTER IIA

IST FLOOR

FLOOR PLAN BUILDING NO. SCALE: 1/4" = 1'-0" 4,928 SQ. FT.

ELECTRICAL METER LOCATIONS/TYPICAL AT EACH BUILDING

FIRE PARTITION NOTES

└=========

LIVING RM.

BD'RM. I

BD'RM. I

LIVING RM.

FIRE PARTITIONS SHALL EXTEND FROM THE TOP OF THE FOUNDATION OR FLOOR/CEILING ASSEMBLY BELOW TO THE UNDERSIDE OF THE FLOOR OR ROOF SHEATHING, SLAB OR DECK ABOVE OR TO THE FIRE-RESISTANCE-RATED FLOOR/CEILING OR ROOF/CEILING ASSEMBLY ABOVE, AND SHALL BE SECURELY ATTACHED TO ON THE FOLLOWING: A) THE UNDERSIDE OF THE FLOOR OR ROOF SHEATHING,

DECK OR SLAB ABOVE B) THE UNDERSIDE OF THE FLOOR /CEILING OR ROOF/ CEILING ASSEMBLY HAVE A FIRE RESISTANCE RATING NOT LESS THAN FIRE RESISTANCE RATING OF THE FIRE PARTITION PER CBC 708.4.

JOINTS INSTALLED IN OR BETWEEN FIRE-RESISTANCE RATED WALLS, FLOOR OR FLOOR/CEILING ASSEMBLIES AND ROOFS OR ROOF/CEILING ASSEMBLIES SHALL BE PROTECTED BY AN APPROVE FIRE-RESISTANT

JOINT SYSTEM DESIGNED TO RESIST THE PASSAGE OF FIRE FOR A TIME PERIOD NOT LESS THAN THE REQUIRED FIRE-RESISTANCE RATING OF THE WALL, FLOOR OR ROOF IN OR BETWEEN WHICH THE SYSTEMS

INSTALLED PER 2019 CBC 715.

NEW I-HOUR FIRE PARTITION WALL: PARTY WALL 2x6 DF#2 WOOD STUDS @ 16" O.C. w/ 5/8" TYPE 'X' GYP. BD. ON ONE SIDE AND 5/8" TYPE 'X' GYP. BD. OVER RESILIANT CHANNELS ON THE OTHER SIDE PROVIDE R-19 BATT INSULATION GA FILE NO. 3242

NEW INTERIOR NON-BEARING WALLS : NEW 2x4 DF#2 WOOD STUDS @ 16" O.C. w/ 5/8"" GYP. BD. EACH SIDE

/////////////////////////// NEW PLUMBING WALL: NEW 2x6 DF#2 WOOD STUDS @ 16" O.C. w/ 5/8"" GYP. BD. EACH SIDE

NEW EXTERIOR WALL: 2x6 DF#2 WOOD STUDS @ 16" O.C. w/ 5/8"" GYP. BD. AT INTERIOR AND STUCCO AT EXTERIOR OVER I" THK. FOAM BOARD OVER 5/8" THK PLY. PROVIDE R-19 BATT INSULTION AT ALL EXTERIOR WALLS.

NEW EXTERIOR WALL (WALLS AT PATIO): 2x4 DF#2 WOOD STUDS @ 16" O.C. W/ IX6 WD. SIDING & STUCCO AT EXTERIOR MEW I/2 WALL AT KITCHEN 2x4 DF#2 WOOD STUDS @ 16" O.C. w/ I/2" GYP. BD ON BOTH SIDES

RESTROOM NOTES:

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OPTIONS: OPTION I. ALL BATHROOMS WITHIN THE DWELLING UNIT SHALL BE

DESIGNED TO COMPLY WITH THE FOLLOWING:

SHALL COMPLY WITH SECTION 1134A.8.

BATHROOMS SHALL COMPLY WITH ONE OF THE FOLLOWING

I. TOILET, BATHING AND SHOWER FACILITIES SHALL COMPLY WITH SECTION 1134A.4. 2. BATHTUBS SHALL COMPLY WITH SECTION 1134A.5. 3. SHOWERS SHALL COMPLY WITH SECTION 1134A.6. 4. WATER CLOSETS SHALL COMPLY WITH SECTION 1134A.7. 5. LAVATORIES, VANITIES, MIRRORS AND TOWEL FIXTURES

6. BATHROOMS SHALL BE PROVIDED WITH AN ACCESSIBLE ROUTE INTO AND THROUGH THE BATHROOM. 7. IF A DOOR IS PROVIDED, IT SHALL COMPLY WITH THE

REQUIREMENTS OF SECTION 1132A.5. 8. A MINIMUM 18-INCH (457 MM) CLEAR MANEUVERING SPACE SHALL BE PROVIDED ON THE SWING SIDE OF THE DOOR AT THE STRIKE EDGE OF THE DOOR. 9. SWITCHES, OUTLETS AND CONTROLS SHALL COMPLY

WITH SECTION 1142A. IO. REINFORCED WALLS TO ALLOW FOR THE FUTURE INSTALLATION OF GRAB BARS AROUND THE TOILET, TUB AND SHOWER SHALL COMPLY WITH SECTIONS 1134A.5 FOR BATHTUBS, 1134A.6 FOR SHOWERS AND 1134A.7 FOR WATER CLOSETS. GRAB BARS SHALL COMPLY WITH

OPTION 2.

ONLY ONE BATHROOM WITHIN THE DWELLING UNIT SHALL BE DESIGNED TO COMPLY WITH THE FOLLOWING: I. TOILET, BATHING AND SHOWER FACILITIES SHALL COMPLY WITH SECTION 1134A.4.

SECTIONS 1127A.4- AND 1127A.2.2, ITEM 4.

2. BATHTUBS SHALL COMPLY WITH SECTION 1134A.5. 3. SHOWERS SHALL COMPLY WITH SECTION 1134A.6. 4. WATER CLOSETS SHALL COMPLY WITH SECTION 1134A.7. 5. LAVATORIES, VANITIES, MIRRORS AND TOWEL FIXTURES

SHALL COMPLY WITH SECTION 1134A.8. 6. WHERE BOTH A TUB AND SHOWER ARE PROVIDED IN THE BATHROOM, AT LEAST ONE SHALL BE MADE ACCESSIBLE. ADDITIONAL REQUIREMENTS APPLY TO DWELLING UNITS CONTAINING TWO OR MORE BATHROOMS WHEN A BATHTUB IS PROVIDED AS THE ACCESSIBLE BATHING FIXTURE.

WHERE TWO OR MORE BATHROOMS ARE PROVIDED WITHIN THE SAME DWELLING UNIT AND A BATHTUB IS INSTALLED TO COMPLY WITH OPTION 2, ITEM 6 IN ONE BATHROOM AND A SHOWER STALL IS PROVIDED IN A SUBSEQUENT BATHROOM, BOTH THE BATHTUB SELECTED TO COMPLY WITH OPTION 2, ITEM 6 AND AT LEAST ONE SHOWER STALL WITHIN THE DWELLING UNIT SHALL MEET ALL THE APPLICABLE ACCESSIBILITY REQUIREMENTS PROVIDED IN SECTION 1134A. (SEE SECTION 1134A.5 FOR BATHTUBS, OR SECTION 1134A.6 FOR SHOWERS.)

1,232 SQ. FT.

4050X0

LIVING RM.

BD'RM. I

BD'RM.

LIVING RM.

DINING

/B.O./SOF/FIT /AT +8'-0"/

/B.O./SOF/FIT /AT +&'-0"/

DINING

BD'RM. 2

BD'RM. 2

1,232 SQ. FT.

(A4)

LOCATE WATER METERS

AT THIS WALL/TYP. AT BUILDING

I. WHEN TWO OR MORE LAVATORIES ARE PROVIDED, AT LEAST ONE SHALL BE MADE ACCESSIBLE AND COMPLY WITH SECTION 1134A.8. . BATHROOMS SHALL BE PROVIDED WITH AN ACCESSIBLE


ROUTE INTO AND THROUGH THE BATHROOM. 3. IF A DOOR IS PROVIDED, IT SHALL COMPLY WITH THE REQUIREMENTS OF SECTION 1132A.5.


4. A MINIMUM 18-INCH (457 MM) CLEAR MANEUVERING SPACE SHALL BE PROVIDED ON THE SWING SIDE OF THE DOOR AT THE STRIKE EDGE OF THE DOOR.

5. SWITCHES, OUTLETS AND CONTROLS SHALL COMPLY WITH SECTION 1142A. 6. REINFORCED WALLS TO ALLOW FOR THE FUTURE INSTALLATION OF GRAB BARS AROUND THE TOILET, TUB AND SHOWER SHALL COMPLY WITH SECTIONS 1134A.5 FOR BATHTUBS, 1134A.6 FOR SHOWERS AND 1134A.7 FOR WATER CLOSETS. GRAB BARS SHALL COMPLY WITH

WHEN OPTION 2 IS USED, ALL ADDITIONAL BATHROOMS MUST COMPLY WITH ITEMS 8 THROUGH 12 ABOVE.

SECTIONS 1127A.4 AND 1127A.2.2, ITEM 4

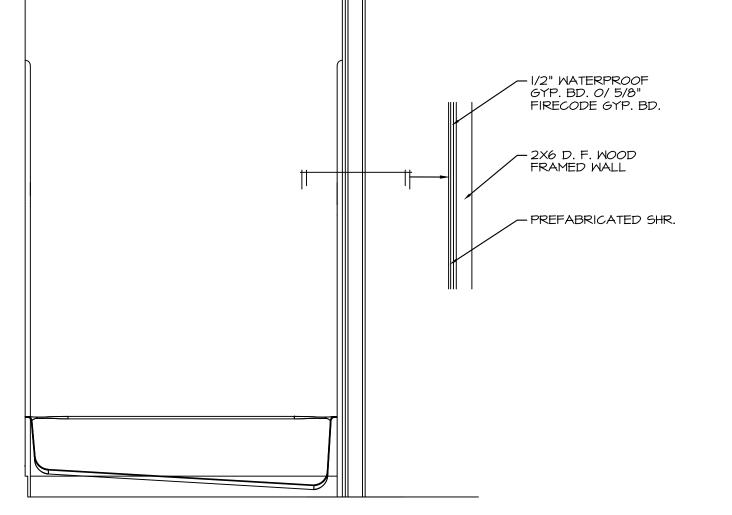

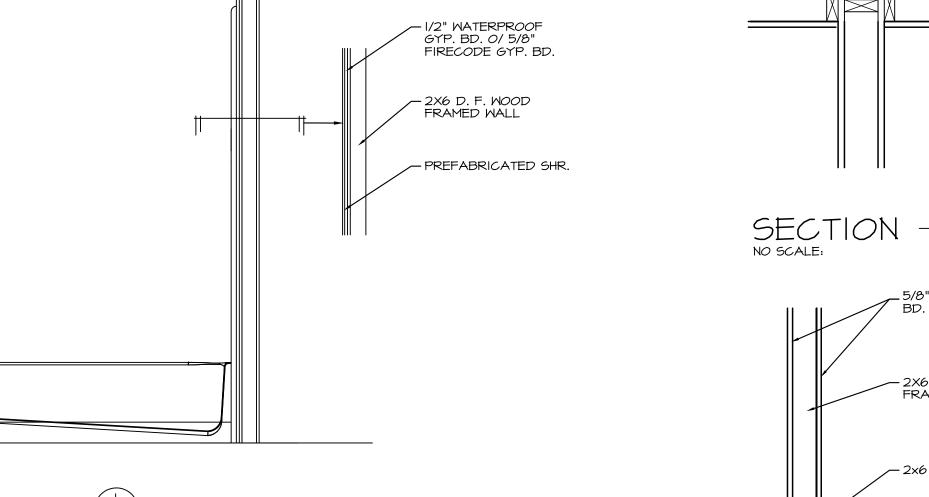

- PATIO

BD'RM. 2

BATH 2

BD'RM. 2

\A4 /

DINING


KITCHEN

B.O. SOFFIT AT +81-0"

B.O. SOFFIT AT +81/0

DINING

1,232 SQ. FT.

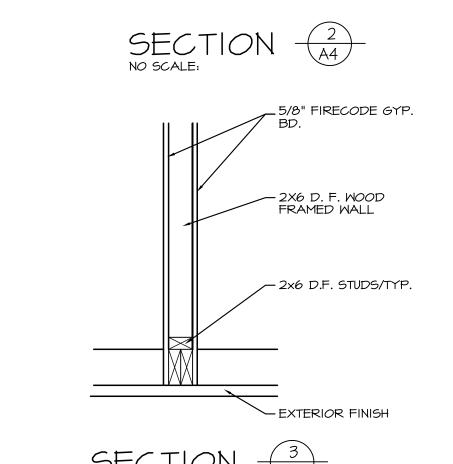

NO SCALE:

NOTE:

I/2" WATERPROOF GYP. BD. O/ 5/8"

FIRECODE GYP. BD.

1,232 SQ. FT.



15. PROVIDE DOOR HINGE AT ALL DOORS: Donald Bremseth 03-31-2025 RENEWAL DATE

> CLOVIS, CA 93611 PH (559) 797-4946 CELL (559) 681-1070 dbremseth@sbcglobal.net

DONALD R. BREMSETH ARCHITECT · C-17195

750 W. ALLUVIAL AVE. #1029

REVISIONS:

07-03-24 SHEET NO .:


PROJECT NO .:

IST FLOOR DIMENSION PLAN SCALE: 1/4" = 1'-0" DONALD R. BREMSETH ARCHITECTURE & PLANNING

SPOSD 32 UNIT APARTMENT COMPLEX.

WBURY APARTMENT COMPLEX.

FRESNO, CALIFORNIA 93619

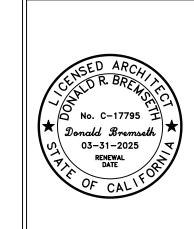

DONALD R. BREMSETH
ARCHITECT · C-11195

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CELL (559) 681-1010

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PROJECT NO.:

DATE:
07-03-24

SHEET NO.:

A-4A

OPTIONS:

OPTION 2.

6. WHERE BOTH A TUB AND SHOWER ARE PROVIDED IN

THE BATHROOM, AT LEAST ONE SHALL BE MADE

DWELLING UNITS CONTAINING TWO OR MORE

ACCESSIBLE BATHING FIXTURE.

ACCESSIBLE. ADDITIONAL REQUIREMENTS APPLY TO

BATHROOMS WHEN A BATHTUB IS PROVIDED AS THE

KEY NOTES:

- BATHTUB (60"x32") AND SHOWER. PROVIDE A HARD NON-ABSORBENT SURFACE TO A HEIGHT OF NOT LESS THAN 72" ABOVE THE DRAIN INLET. PROVIDE WATER-RESISTANT GYP. BD. BACKING BOARD WHEN GYP. BD. IS USED AS A BASE FOR TILE OR WALL PANELS AT SHOWERS
- (2) CURTAIN AND ROD AT TUB / SHOWER.
- (3) WATER CLOSET W/ MIN. 30 INCHES IN WIDTH \$ 24 INCHES CLEAR IN FRONT / 1.28 GALLON MAX. CAPACITY AND SHALL BE LOW-FLOW WATER TYPE.
- (4) LAVATORY
- (5) 50 GAL. WATER HEATER.
- (6) CLOTHES WASHER SPACE & DRYER SPACE. DRYER VENT DUCT SHALL BE 6" DIAMETER (OR EQUAL CROSS SECTION) SMOOTH SHT. METAL EXTENDING TO EXTERIOR W/ BACK DRAFT DAMPER PER CMC 504.3 \$ 905.
- (7) UPPER CABINET / WALL MOUNTED. VERIFY DOOR DESIGN WITH MANUFACTURER.
- (8) GRANITE COUNTER TOP AND SPLASH WITH CABINETS BELOW. VERIFY DOOR DESIGN W/ MANUFACTURER.
- (9) TWO COMPARTMENT KITCHEN SINK WITH DISPOSAL VERIFY MITH OWNER.
- (10) BUILT-IN DISHWASHER. INSTALL AS PER MANUFACTURER'S RECOMMENDATIONS.
- (11) REFRIGERATOR SPACE. PROVIDE WATER FOR ICE MAKER (COORDINATE WITH PLUMBING).
- (12) 4 BURNER ELEC. RANGE WITH 42" WIDE HOOD W/ TWO SPEED FAN AND LIGHT ABOVE . PROVIDE 6" HORIZ. CLEARANCE FROM BURNERS AND 30" VERTICAL CLEARANCE TO COMBUSTIBLE MATERIAL. INSTALL PER MANUFACTURER'S
- (13) PROVIDE 15" BREAD BOARD
- (14) PANTRY
- (15) SAFETY REQUIREMENTS:
- A. PROVIDE A PEEP HOLE OR VISION PANEL AT DOOR.
- B. PROVIDE A STEEL PLATE AT THE DEAD BOLT STRIKER, SOLID SHIM 6" ABOVE ABOVE AND BELOW WITH 2- #8 X 2" LG. SCREWS.
- C. WINDOWS SHALL MEET THE MIN. STANDARDS AS STABLISHED BY THE U.B.C. STANDARDS.
- D. PROVIDE DEAD BOLTS AT ALL EXTERIOR DOORS.

GENERAL NOTES:

- I. A MAXIMUM OF I/2"-INCH OFFSET AT THRESHOLDS AND AT ANY CHANGE OF FLOORING MATERIAL. OFFSETS GREATER THAN 1/4-INCH REQUIRES AMAXIMUM BEVELED SLOPE OF I UNIT VERTICAL TO 2 UNITS HORIZONTAL EXCEPT THAT LEVEL CHANGES NOT EXCEEDING 1/4-INCH MAY BE VERTICAL.
- 2. SECURITY CODE ORDINANCE COMPLIANCE REQUIREMENTS
- (FMC 13-100.1010): PEEP HOLE OF VISION PANEL. 2. STEEL PLATE AT DEADBOLT STRIKER, SOLID SHIM
- 6" ABOVE AND BELOW WITH 2-#8X2" SCREWS. 3. WINDOWS SHALL MEET MINIMUM STANDARDS AS ESTABLISHED BY CBC STANDARDS.
- 4. PROVIDE DEAD BOLTS AT ALL EXTERIOR DOORS 3. NO THUMB LATCHES OR KEYED CYLINDER DEAD BOLTS ARE ALLOWED ON ANY DOORS UNLESS OPERATED BY A SINGLE ACTION WITH A LEVER. LEVER HARDWARE AT ALL
- 4. MANUALLY-OPERATED EDGE OR SURFACE-MOUNTED FLUSH BOLTS AND SURFACE BOLTS OR ANY TYPE OF DEVICE THAT MAY BE USED TO CLOSE OR RESTRAIN THE DOOR OTHER THAN THE OPERATION OF THE LOCKING DEVICE SHALL NOT BE USED ARE PROHIBITED.
- 5. REGARDLESS OF THE OCCUPANT LOAD SERVED EXIT DOORS SHALL BE OPENABLE FROM THE INSIDE WITHOUT THE USE OF A KEY OR ANY SPECIAL KNOWLEDGE OR
- 6. ESCAPE OR RESCUE WINDOWS SHALL HAVE A MINIMUM NET CLEAR OPENABLE AREA OF 5.7 SQUARE FEET. THE FINISHED SILL HEIGHT SHALL NOT BE MORE THAN 44"
- ABOVE THE FLOOR. 7. INTERIOR DOORS FOR BATHROOMS AND BEDROOMS SHALL PROVIDE A MIN. NET CLR. OPENING OF 32" WHEN OPEN AT 90 DEGREES. CBC 1132.A.3.
- 8. STRIKE SIDE CLEARANCE SHALL BE A MIN. OF 18". CBC 1132A.5..2. 9. DOOR MANUVERING SPACE MIN. 42" DEEP BOTH SIDES OF
- INTERIOR DOORS.
- 10. PROVIDE DOOR SIGNALING DEVICE 48" ABOVE GRADE (TO TOP) CBC 1132.10. II. ACCESSIBLE ADAPTABLE UNIT ENTRY DOORS SHALL
- HAVE A "PEEP" HOLE AT A MAX. 46" ABOVE FINISH 12. OPTION '2' WILL BE USED FOR RESTROOM DESIGN FOR
- ACCESSIBILITY. 13. MAXIMUM OF 48" TO TOP OF THE THERMOSTAT. CBC 14. ACCESSIBILITY REACH SHALL BE A MAXIMUM OF 24" AT
- 15. PROVIDE DOOR HINGE AT ALL DOORS: HAGER COMPANY MODEL NO, - RC1842-1C312 3 1/2" FULL MORTISE HINGE | 3/4" THK, DOOR (TYPICAL)

WASHER & DRYER AT AT KITCHEN COUNTERS. CBC 1142A

- 16. PROVIDE BRADLEY MODEL 8370-108 SWING UP GRAB BAR 30" LENGTH WITH INTEGRAL TOILET PAPER HOLDER AT BATH I AT EACH UNIT ON FIRST FLOOR, SEE DETAIL SHEET A.14
- 17. FIRE TEST CRITERIA. FIRE-RESISTANT JOINT SYSTEMS SHALL BE TESTED IN ACCORDANCE WITH THE REQUIREMENTS OF EITHER ASTM EI966 OR UL 2079 PER CBC 715.3.
- 18. THRESHOLDS FOR INTERIOR & SECONDARY EXTERIOR DOORS PER CBC 1132A.414 A) PRIMARY ENTRY AND REQUIRED EXIT DOORS - MAX. 1/2"H
- B) SECONDARY EXTERIOR DOORS -MAXIMUM 34"H C) INTERIOR DOORS FOR MATERIAL DIFFERENCES - 1/2"H 1/4"H THRESHOLD CHANGE IN HEIGHT MAY BE VERTICAL 34"H THRESHOLD CHANGE SHALL BE ≤1:
- 18. ALL FIRST FLOOR UNITS SHALL BE ADAPTABLE AND COMPLIANT WITH 2019 CBC CHAPTER IIA

2ND FLOOR

PROVIDE R-19 BATT INSULTION AT ALL

W/ IX6 MD. SIDING & STUCCO AT EXTERIOR

2x4 DF#2 WOOD STUDS @ 16" O.C.

2x4 DF#2 WOOD STUDS @ 16" O.C.

w/ I/2" GYP. BD ON BOTH SIDES

EXTERIOR WALLS.

MEW I/2 WALL AT KITCHEN

NEW EXTERIOR WALL (WALLS AT PATIO):

NO SCALE:

NOTE:

I/2" WATERPROOF GYP. BD. O/ 5/8"

FIRECODE GYP. BD.

SCALE: 1/4" = 1'-0" 4,928 SQ. FT.

A-5

OF ____ SHEETS

REVISIONS:

Donald Bremseth

O

O3-31-2025 RENEWAL DATE

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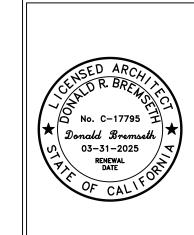
PROJECT NO .: 07-03-24 SHEET NO .:

2ND FLOOR DIMENSION PLAN SCALE: 1/4" = 1'-0" DONALD R. BREMSETH
ARCHITECTURE & PLANNING

PROPOSID 32 UNIT APARTMENT COMPLEX.

LEWBURY APARTMENT COMPLEX.

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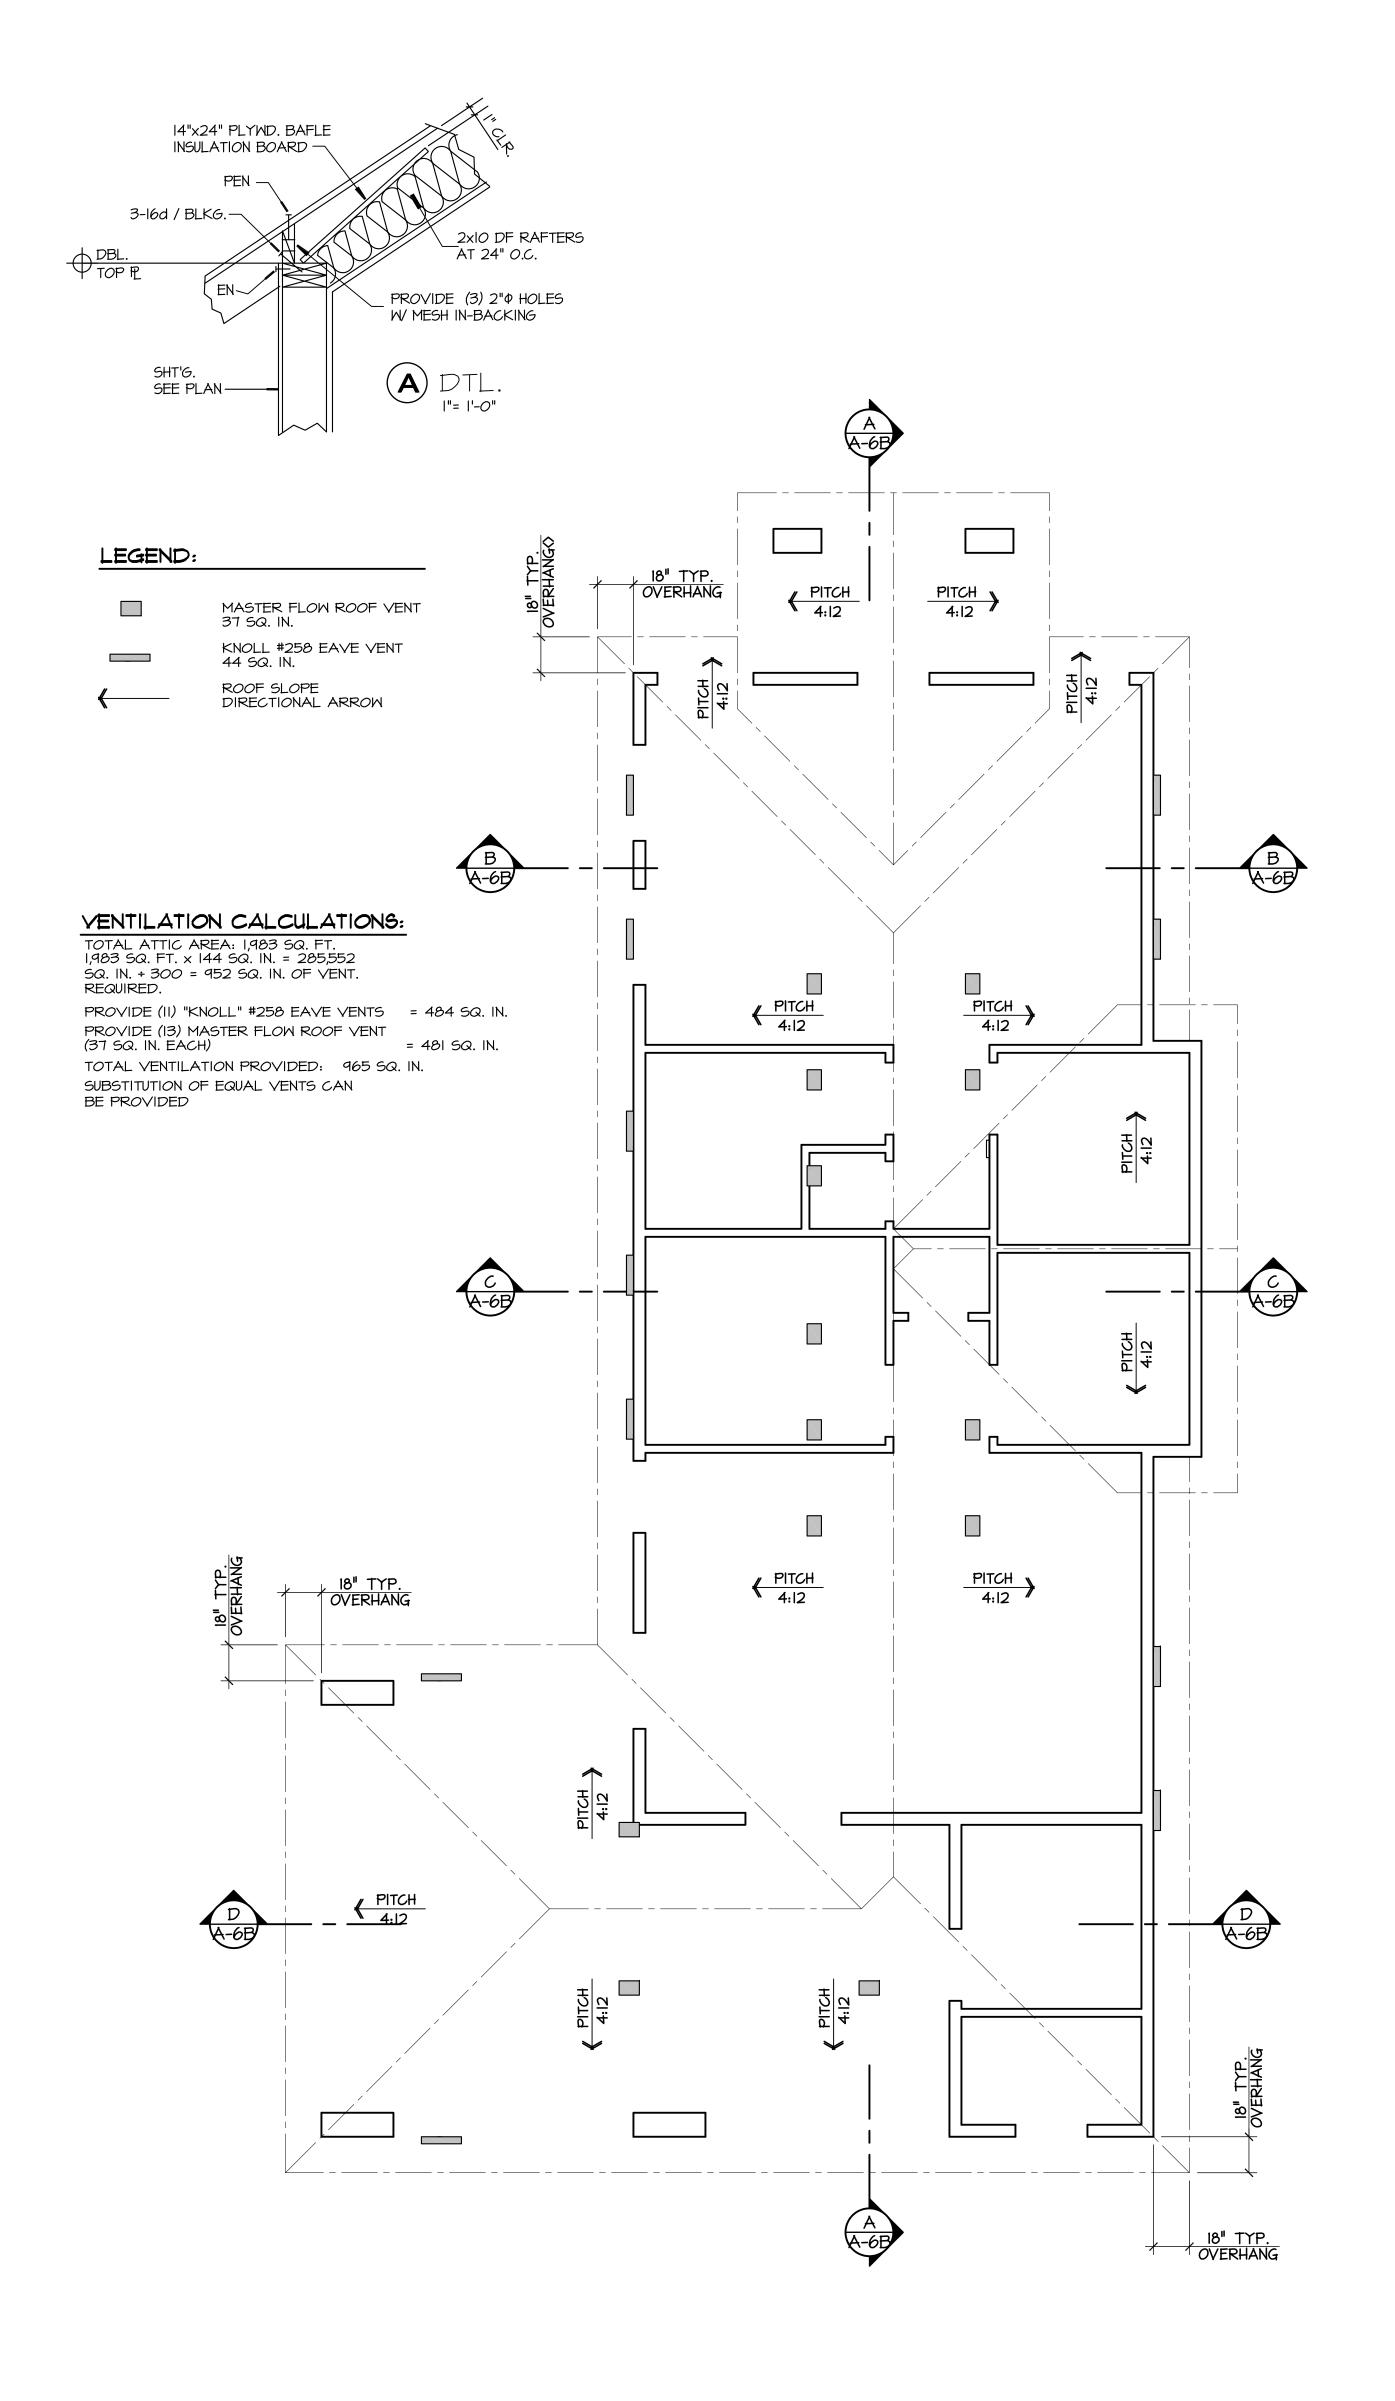
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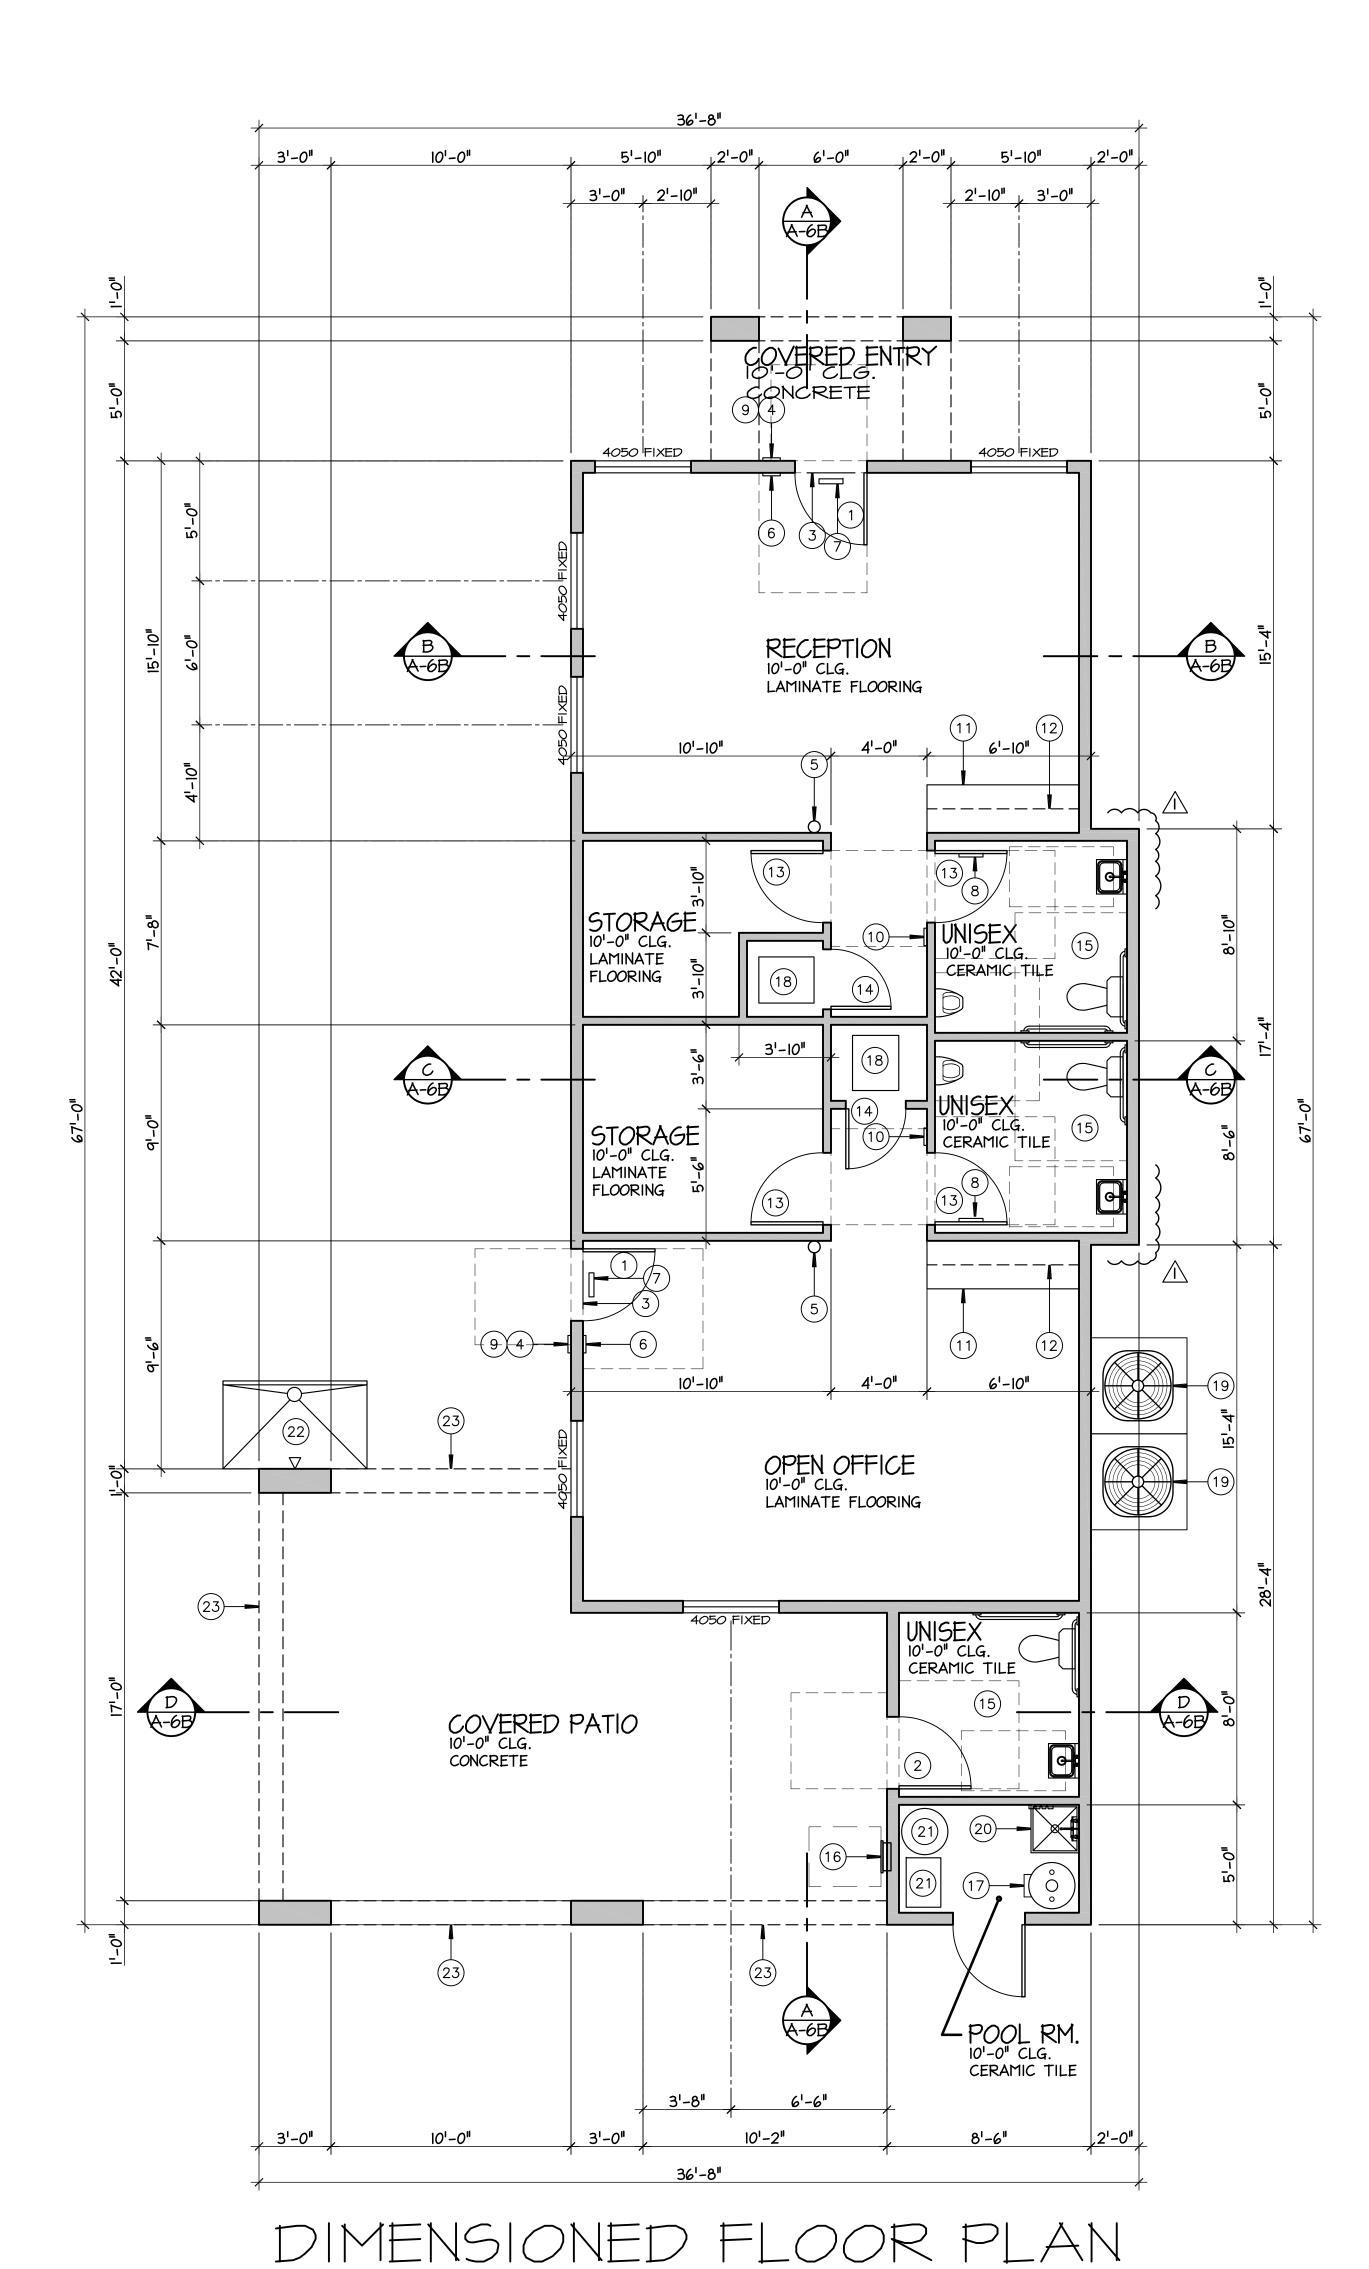
DATE:
07-03-24

SHEET NO.:

A-5A



ROOF PLAN



KEY NOTES :

- (1) 3'-0"x7'-0" STOREFRONT ENTRY DOOR
- (2) 3'-0"x7'-0" METAL DOOR
- (3) PROVIDE SIGNAGE: "THIS DOOR TO REMAIN UNLOCKED WHEN
- BUILDING IS OCCUPIED" (4) PROVIDE SIGNAGE: "NO SMOKING"
- 5) PROVIDE A (2A-10:BC) FIRE EXTINGUISHER. MOUNT AT +48" A.F.F.
- (6) TACTILE EXIT SIGN TO READ "EXIT" MOUNTED PER DETAIL II/A-I2

REVISIONS:

BUILDING P.C

^{\(\)} |2-04-2024

- ON LATCH SIDE OF DOOR .
- (7) ILLUMINATED EXIT SIGNS WITH BATTERY BACK-UP 8) RESTROOM DOOR SIGNS / SEE DETAIL 12/A-12
- 9) PROVIDE A 6"x6" ACCESSIBILITY SIGN.
- (10) PROVIDE BRAILLE RESTROOM SYMBOLS / SEE DTL. 12/A-12
- (11) +34" HIGH ACCESSIBLE COUNTERTOP W/ CABINETS BELOW VERIFY DESIGN WOWNER AND ARCHITECT
- (12) UPPER CABINETS,
- VERIFY DESIGN WOWNER AND ARCHITECT (13) 3'-0"x7'-0" SOLID CORE WOOD DOOR
- (14) 2'-6"x7'-0" SOLID CORE WOOD DOORS
- 15) ACCESSIBLE RESTROOM, SEE RESTOOM PLAN, SHEET A-6C
- (16) ELECTRICAL PANEL, SEE ELECTRICAL DRAWINGS MAINTAIN 30"X36" CLEARANCE IN FRONT OF PANEL
- (17) 30 GAL. ELECT. WATER HEATER, SEE PLUMBING & ELECTRICAL DWGS.
- (18) FURNACE UNIT, SEE MECHANICAL DRAWINGS (19) CONDENSOR UNIT, SEE MECHANICAL DRAWINGS
- (20) MOP SINK, SEE PLUMBING DRAWINGS
- (21) POOL EQUIPMENT, BY OTHERS
- (22) OUTDOOR SHOWER, SEE PLUMBING DRAWINGS
- (23) ARCHED SOFFIT, SEE EXTERIOR ELEVATIONS AND STRUCTURAL DRAWINGS

WALL LEGEND

NEW INTERIOR NON-BEARING WALLS : NEW 2x4 DF#2 WOOD STUDS @ 16" O.C. w/ 5/8"" GYP. BD. EACH SIDE

NEW EXTERIOR WALL:

NEW EXTERIOR MALL:

2x6 DF#2 WOOD STUDS @ 16" O.C.

W/ 5/8"" GYP. BD. AT INTERIOR AND

STUCCO AT EXTERIOR

PROVIDE R-19 BATT INSULATION

BUILDING DATA:

FLOOR AREA: COVERED ENTRY 60 SQ. FT. OFFICE 1,185 SQ. FT. COVERED PATIO 418 SQ. FT.

2 PROVIDED

1,663 SQ. FT.

OCCUPANCY GROUP:

OCCUPANCY LOAD: 33 PERSONS MAX. V-B (NON-SPRINKLERED) CONSTRUCTION TYPE

AUTOMATIC FIRE SPRINKLERS REQ'D: NO ALLOWABLE AREA:

OFFICE BUILDING

SEISMIC DESIGN CATAGORY: D OCCUPANT LOAD:

EXITS:

SCALE: 1/4" = 1'-0"

CCUPANT LOAD:				
	RECEPTION:	335 S.F. / 150	=	2.23
	OPEN OFFICE:	335 S.F. / 150	=	2.23
	STORAGE:	61 S.F. / 500	=	0.12
	STORAGE:	86 S.F. / 500	=	0.17
	TOTAL :			4.75

5 OCCUPANTS

(I) ONE EXIT REQUIRED (MIN.)

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SHEET NO .:

A-6A


DONALD R. BREMSETH ARCHITECT · C-17195

750 W. ALLUYIAL AVE. *1029 CLOVIS, CA 93611

DESCRIPTION / COLOR

EXTERIOR FINISH SCHEDULE

MATERIAL

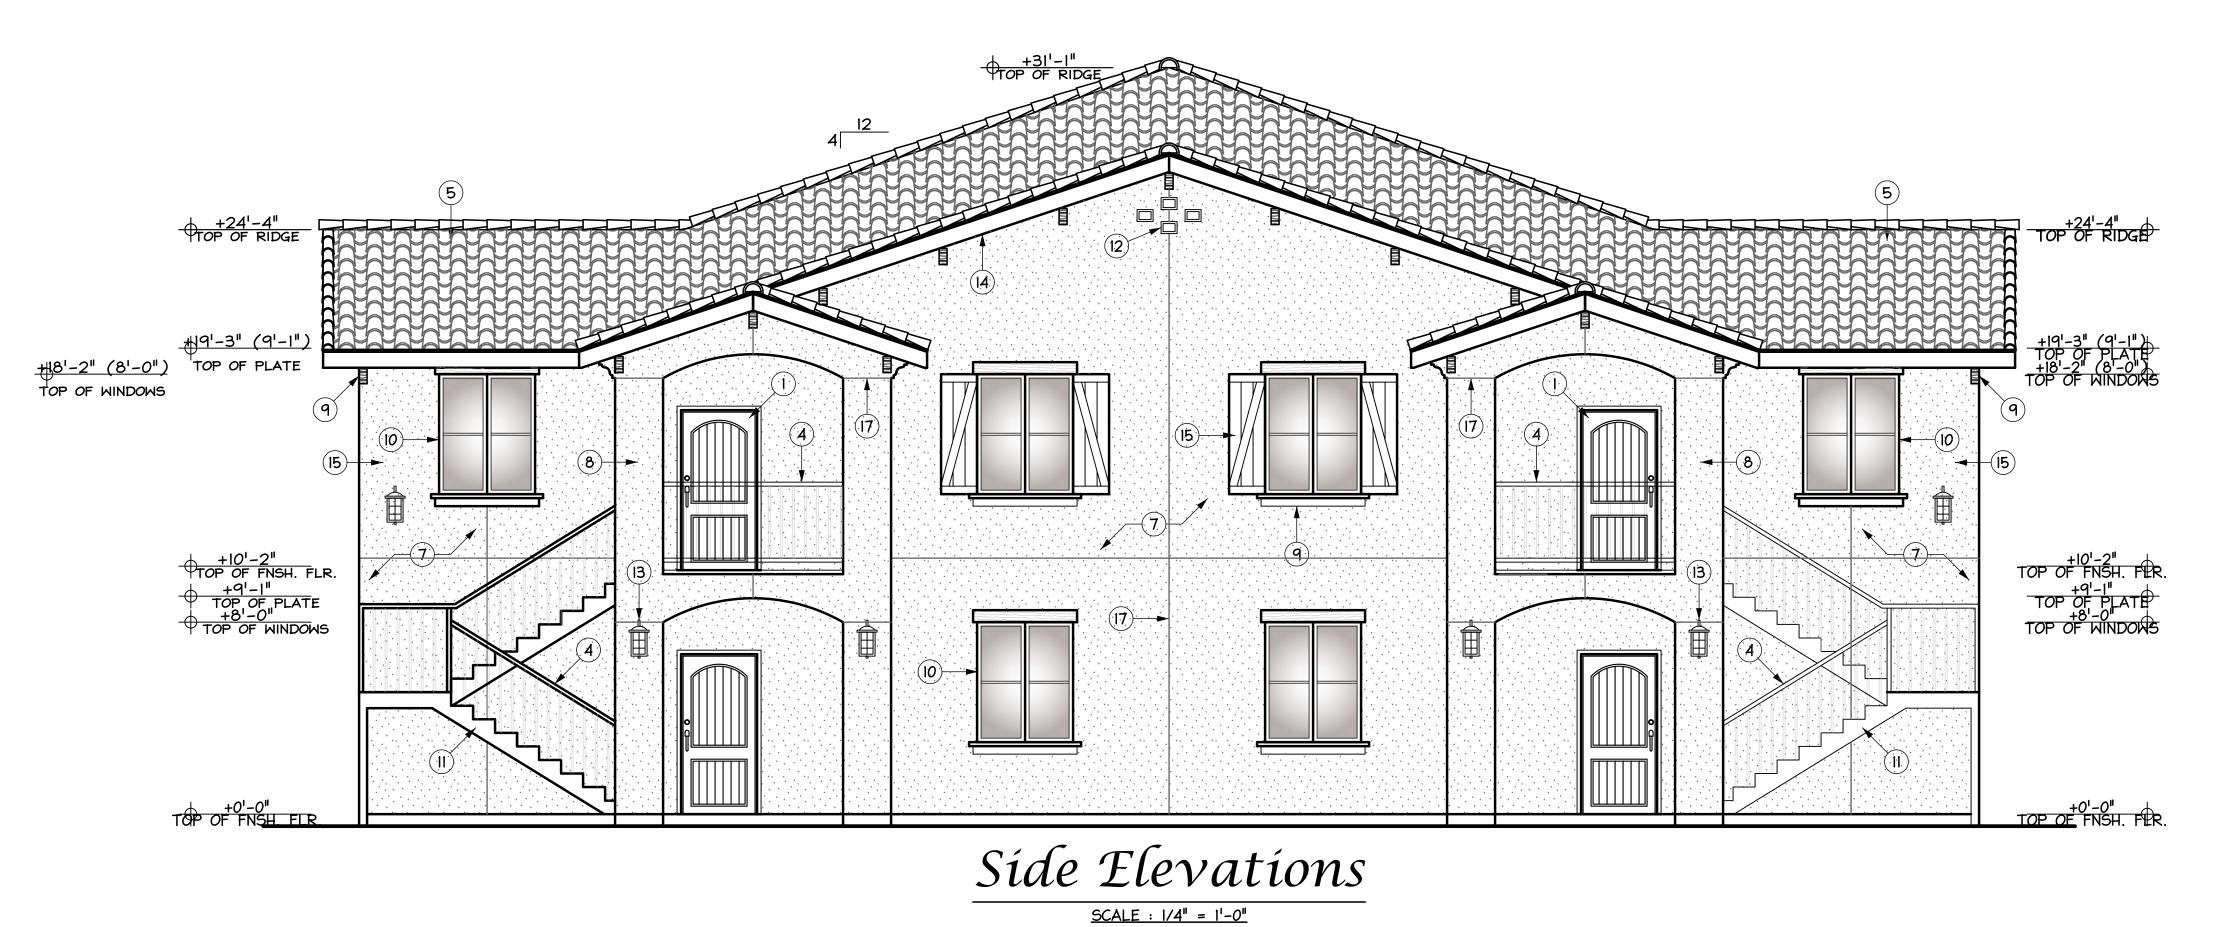

Front & Rear Elevation

SCALE: 1/4" = 1'-0"


Exterior Elevations

SCALE: 1/4" = 1'-0"

R. BREWSETH
JRE & PLANNING
2, CLOVIS, CALIFORNIA 43612

REVISIONS:

EMBURY APARTMENT COMPLEX:

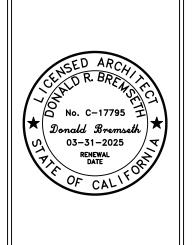


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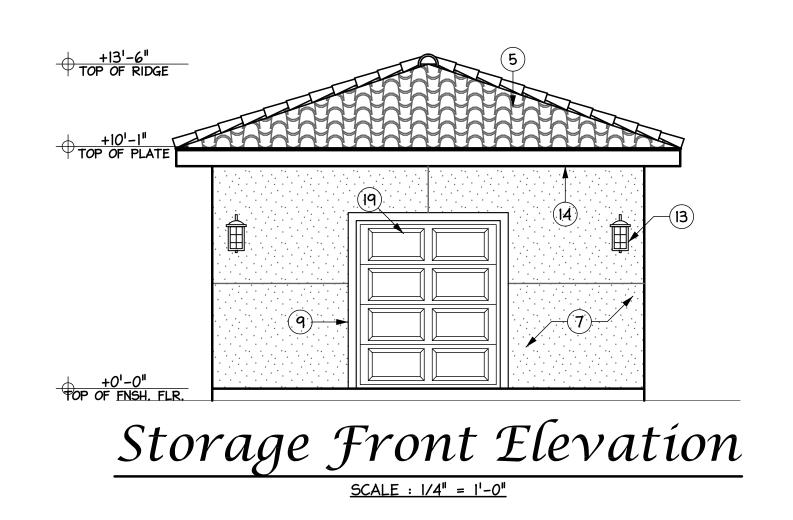
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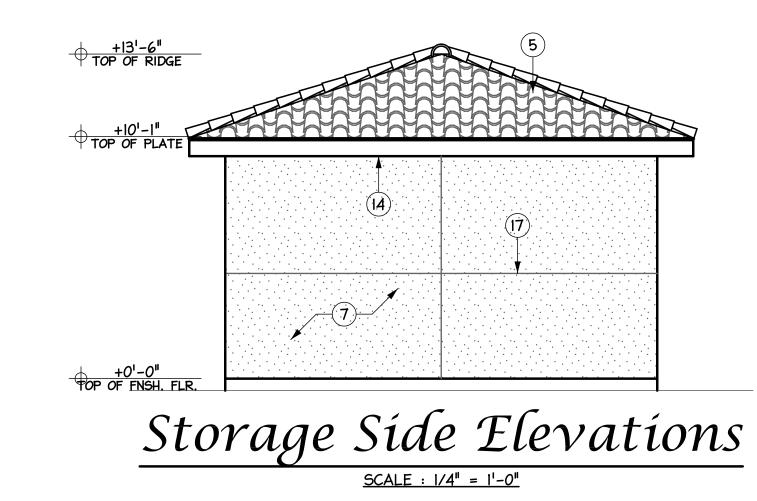
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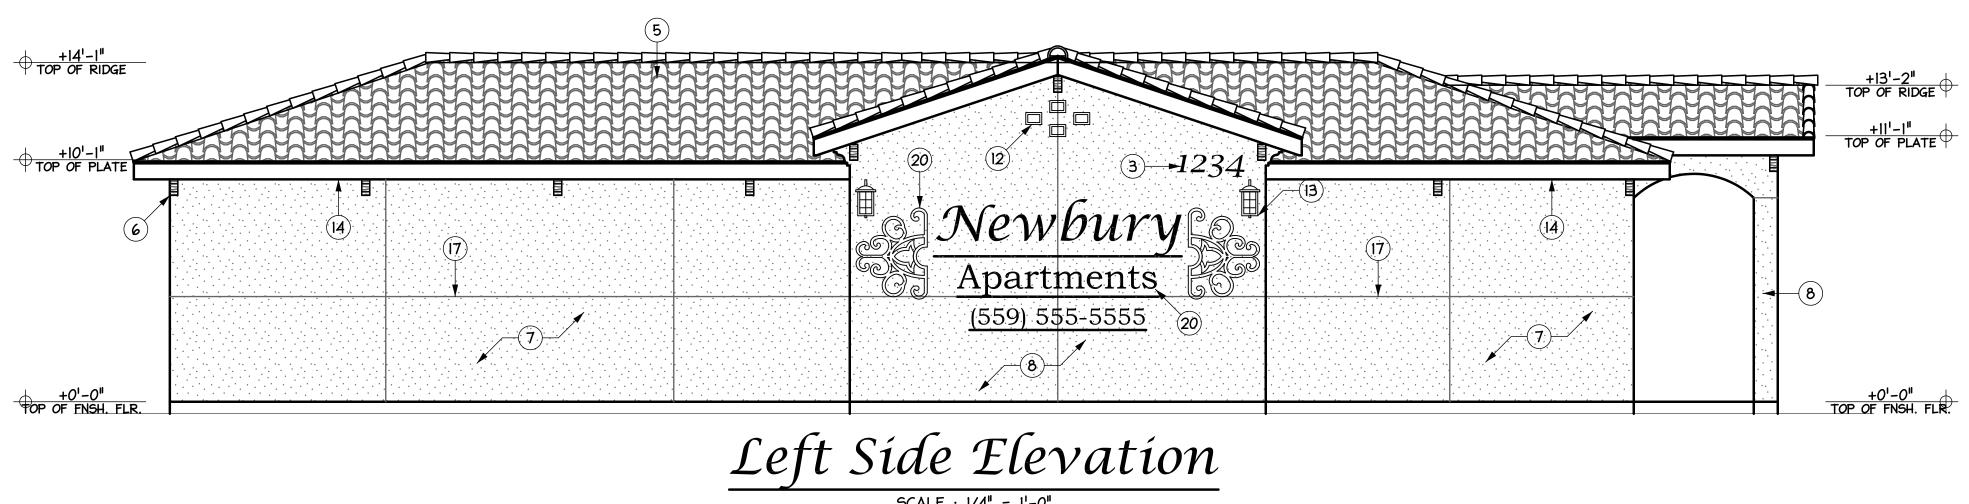














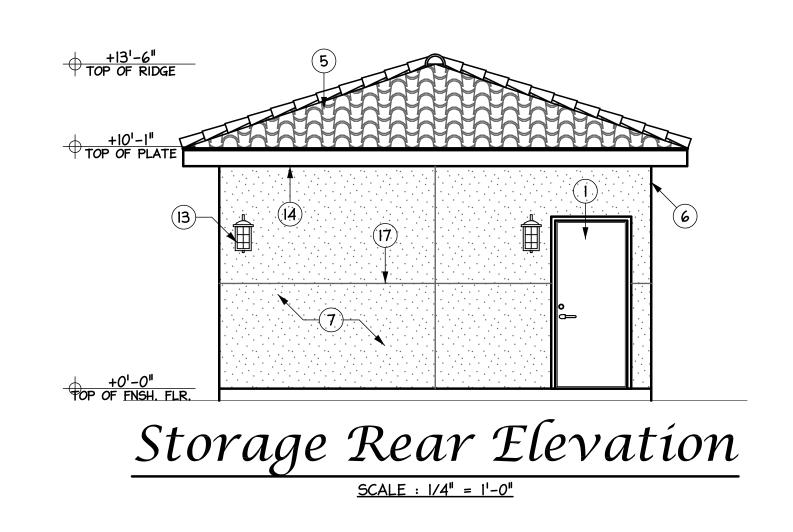

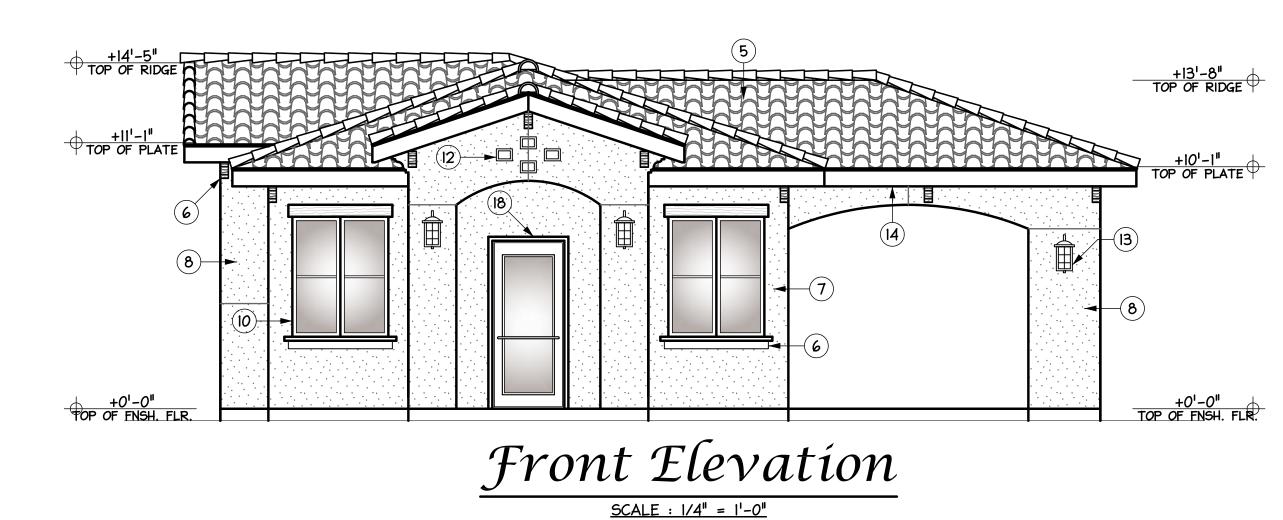

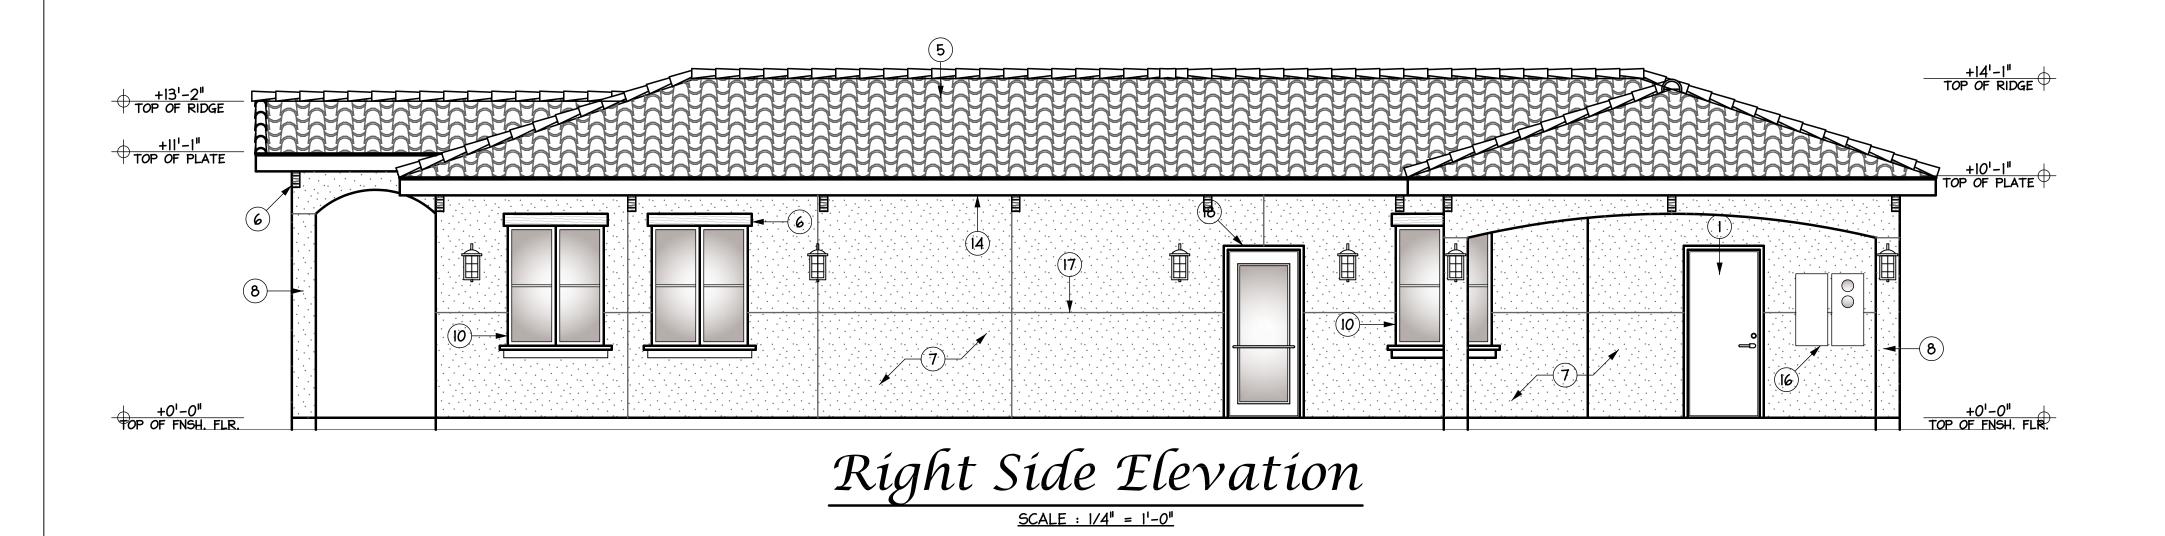

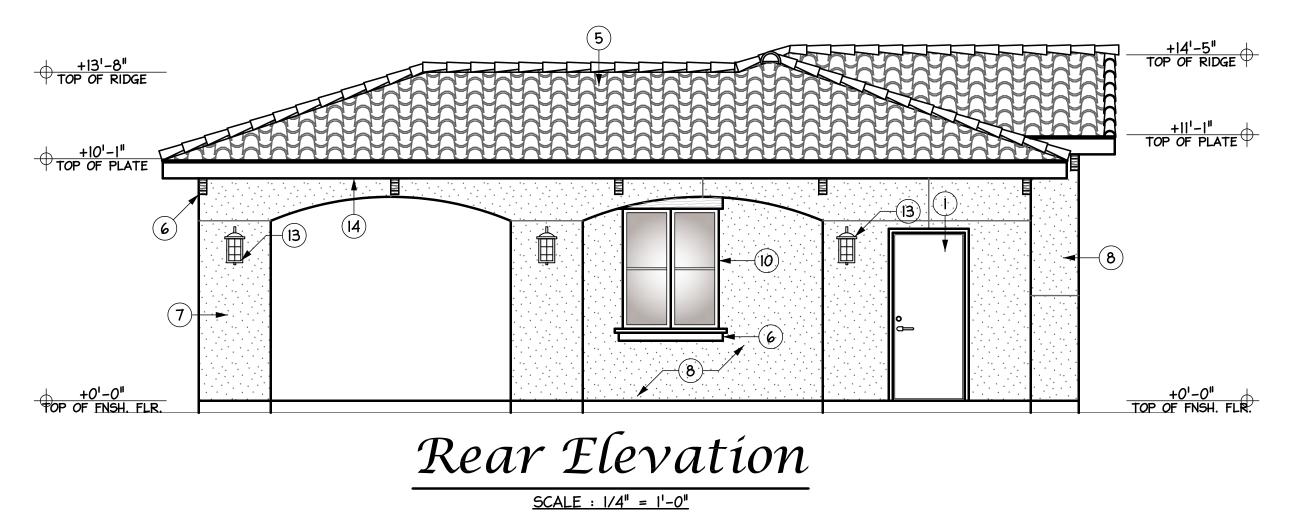

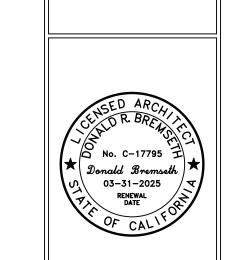

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PROJECT NO.:

|GM-024-00|D|
| DATE:
| 07-03-24|
| SHEET NO.:

Community Building & Storage Exterior Elevations