
CONSULTANT:

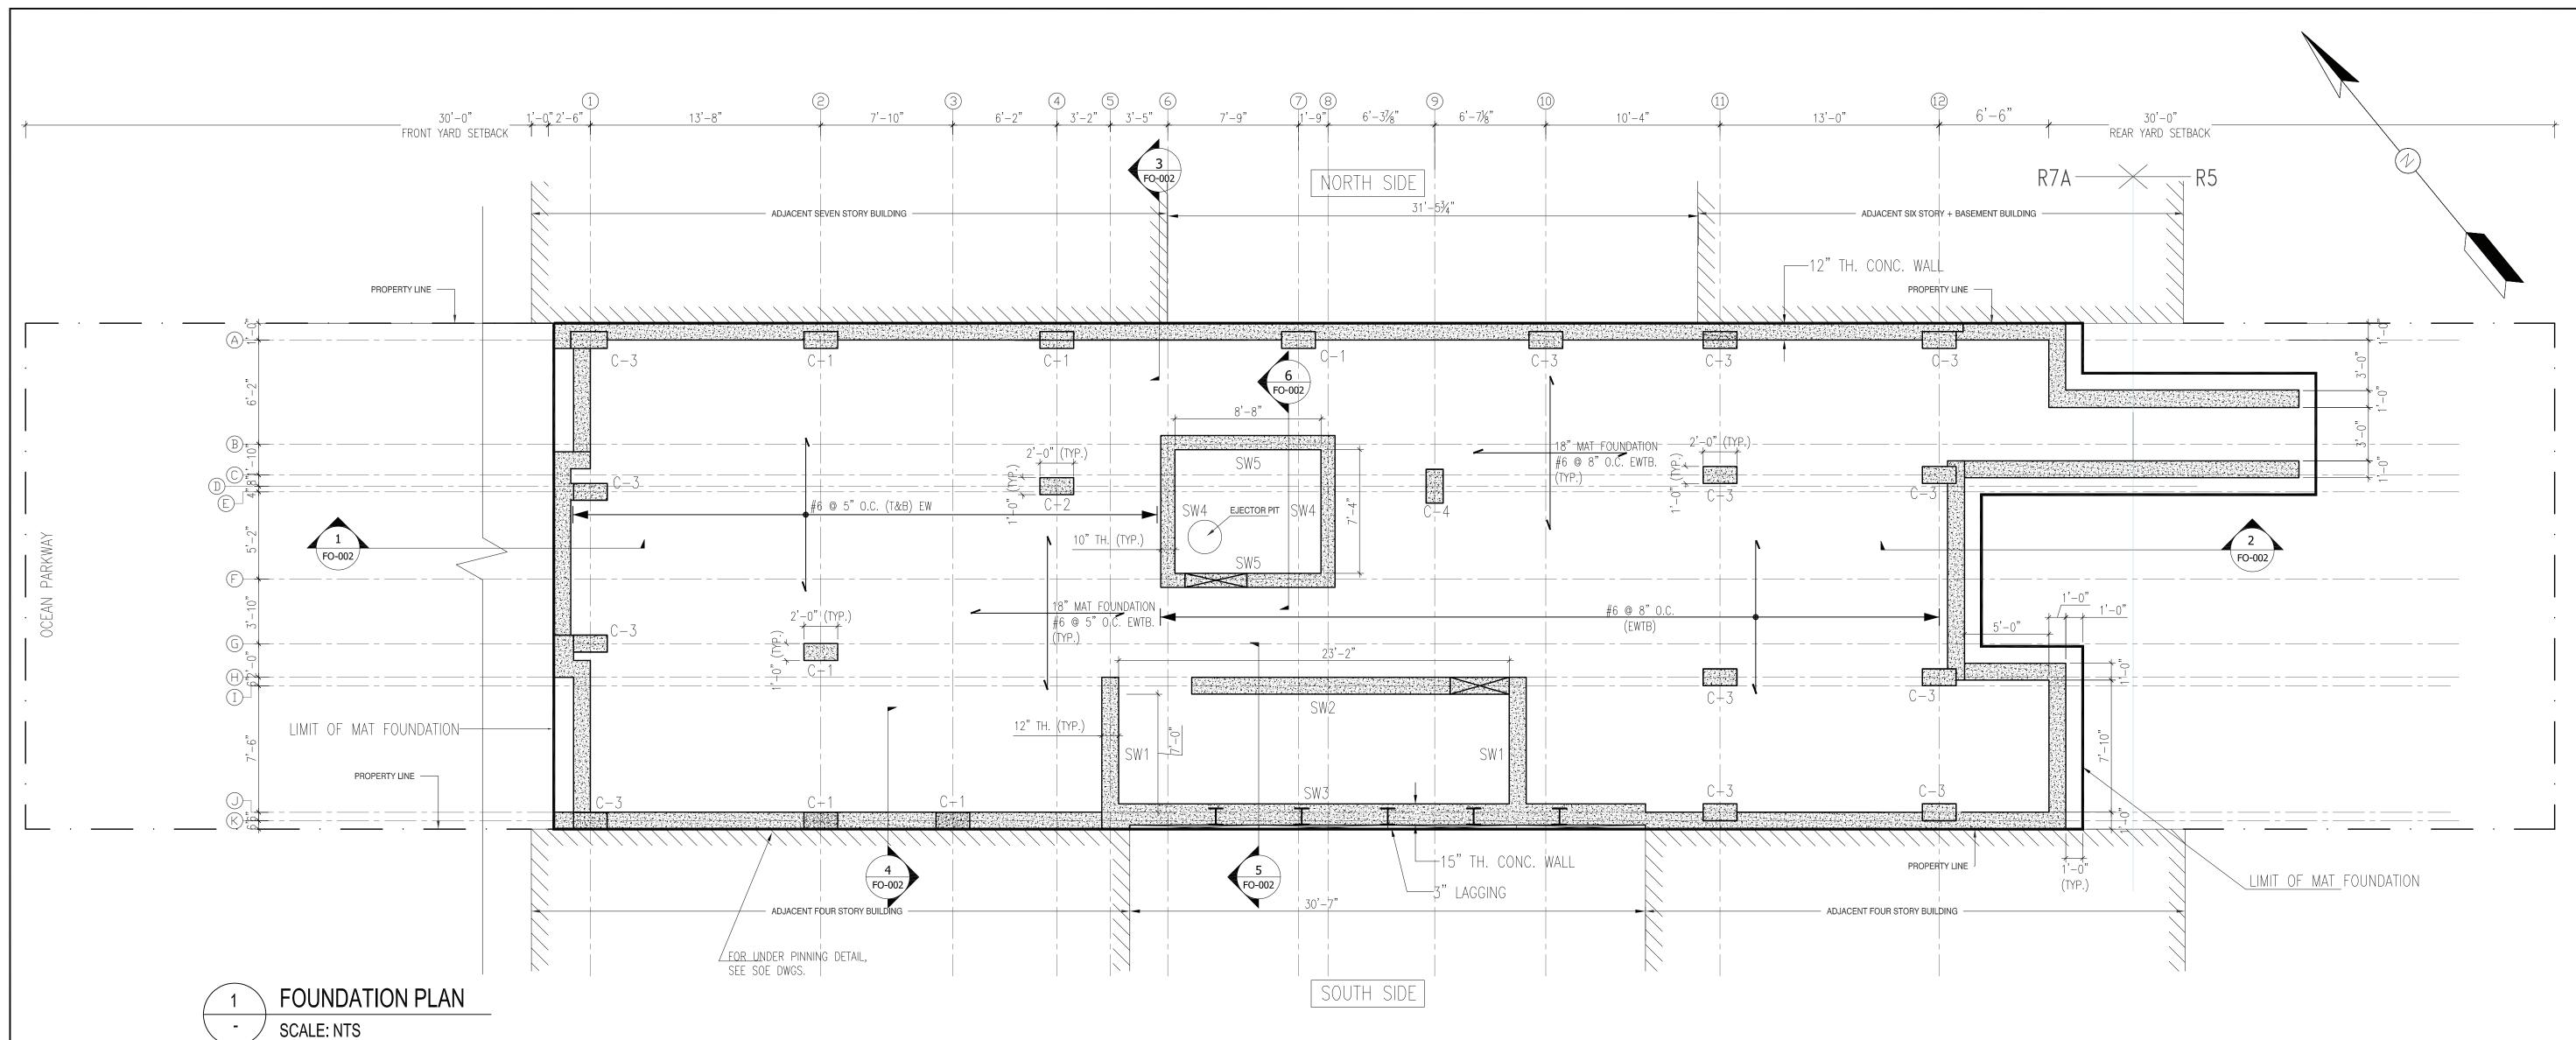

# **ENERGY CODE PROGRESS INSPECTIONS**

Y	N	PROGRESS INSPECTIONS
		INSULATION PLACEMENT AND R VALUES (IA2), (IIA2)
		FENESTRATION THERMAL VALUES AND RATINGS (IA3), (IIA3)
		FENESTRATION AREAS (IA5), (IIA5)
		AIR SEALING AND INSULATION - VISUAL (IA6), (IIA6)
		LIGHTING IN DWELLING UNITS (IIC2)
		INTERIOR LIGHTING POWER (IC2), (IIC3)
		EXTERIOR LIGHTING POWER (IIC4)
		LIGHTING CONTROLS (IIC5)
		EXIT SIGNS
		PERMAMENT CERTIFICATE (ID2)

SPECIAL INSPECTION ITEMS REQUIRED			
YES	NO	SPECIAL INSPECTIONS	
		FIRE-RESISTANT PENETRATIONS & JOINTS (BC 1704.27)	
		ENERGY CODE COMPLIANCE INSPECTIONS (BC 110.3.5)	

## SUPPORTING DOC. REFERENCE GUIDE:

INFORMATION INDICATED IN THE ENERGY ANALYSIS CAN BE FOUND ON DRAWING EN - A100 TO EN - A105

## NYCECC COMPLIANCE NOTE

" TO THE BEST OF MY KNOWLEDGE, BELIEF AND PROFESSIONAL JUDGMENT, THESE PLANS AND SPECIFICATIONS ARE IN COMPLIANCE WITH THE NYCECC 2016"

ERIOR CONCRETE W/ FURRING	ASSEMBLY R - VAL
VARIES 28"  UNDERSIDE OF	12" CONCRETE WALL = R 0.00 2" STUD = R 0.00 BATT INSULATION = R 8.00 GYP. BOARD = R 0.00
FLOOR ABOVE	(U-FACTOR 0.125) = R 8.00
THERMAFAST J-TRACK TO SECURE RIGID FOAM INSULATION	
PROVIDE 1 LAYER OF	
5/8" GYP. BD.	
THERMAFAST Z-TRACK	
INSTALLED BETWEEN EVERY	
24" RIGID FOAM INSULATION	
CONCRETE WALL	
√	
2" R-8 RIGID FOAM INSULATION	
THERMAFAST J-TRACK TO SECURE RIGID FOAM INSULATION	

ENERGY ANALYSIS: 2016 NYCECC CHAPTER 4 — CLIMATE ZONE 4				
CITATION	ITEM DESCRIPTION	PROPOSED DESIGN VALUE	CODE PRESCRIPTIVE VALUE	SUPPORT Elena Tugusheva DOCUMENTATION
ECC C402 TABLE 402.1.3	WALLS, BELOW GRADE (FOUNDATION WALL)	R-8 CI	R-7.5 CI	APPROVED Under Directive 2 of 1975 AMENDED APPLICATION Date: 10/83/2019 TYPES  NYC Development Hub

SWX - SHEAR WALL

#### NOTES:

- 1. SEE COLUMN SCHEDULE ON DWG. S-200 FOR REINF. & SIZE.
- 2. FOR OTHER NOTES, SEE DWG. S-001.
  3. FOR UNDER PINNING & SHEET PILING
- 3. FOR UNDER PINNING & SHEET PILING DETAILS, SEE "SOE" DRAWINGS.
- 4. FOR OPENINGS IN FLOOR/WALLS ETC., SEE ARCHITECTURAL DWGS.

ARCHITECTURE & ENGINEERING GROUP
66 BRUNSWICK WOODS DRIVE,
EAST BRUNSWICK, NJ 08816
1441 BROADWAY, 6TH FLOOR,
SUITE 6093, NEW YORK, NY 10018

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REVISIONS		
NO.	DATE	DESCRIPTION
06	06-20-19	REVISED PER ARCH. DWGS
05	02-04-19	REVISED SET
04	11-20-18	REVISED SET
03	10-10-18	REVISED SET
02	05-07-18	REVISED SET
01	10-13-17	REVISED SET

#### SEAL & SIGNATURE



NEW YORK CITY BUILDING DEPARTMENT NOTE

THIS PLAN IS APPROVED ONLY FOR WORK INDICATED ON THE APPLICATION SPECIFICATION SHEET. ALL OTHER MATTERS SHOWN ARE NOT TO BE RELIED UPON, OR TO BE CONSIDERED AS EITHER BEING APPROVED OR IN ACCORDANCE WITH APPLICABLE CODES. THIS PLAN FILED FOR STRUCTURAL WORK ONLY.

it is a violation unlawful for any person, unless s/he is acting under the direction of a licensed professional engineer licensed in this State to alter this drawing in any way.

#### LOCATION:

491 OCEAN PARKWAY BROOKLYN, NY 11218

DRAWING TITLE:
FOUNDATION PLAN


DATE: 05-07- 2018 PROJECT NO. 2017-20

DRAWN BY: AQEEL | CHECKED BY: YT

DRAWING NO:

FO-001.01

SHEET NO:

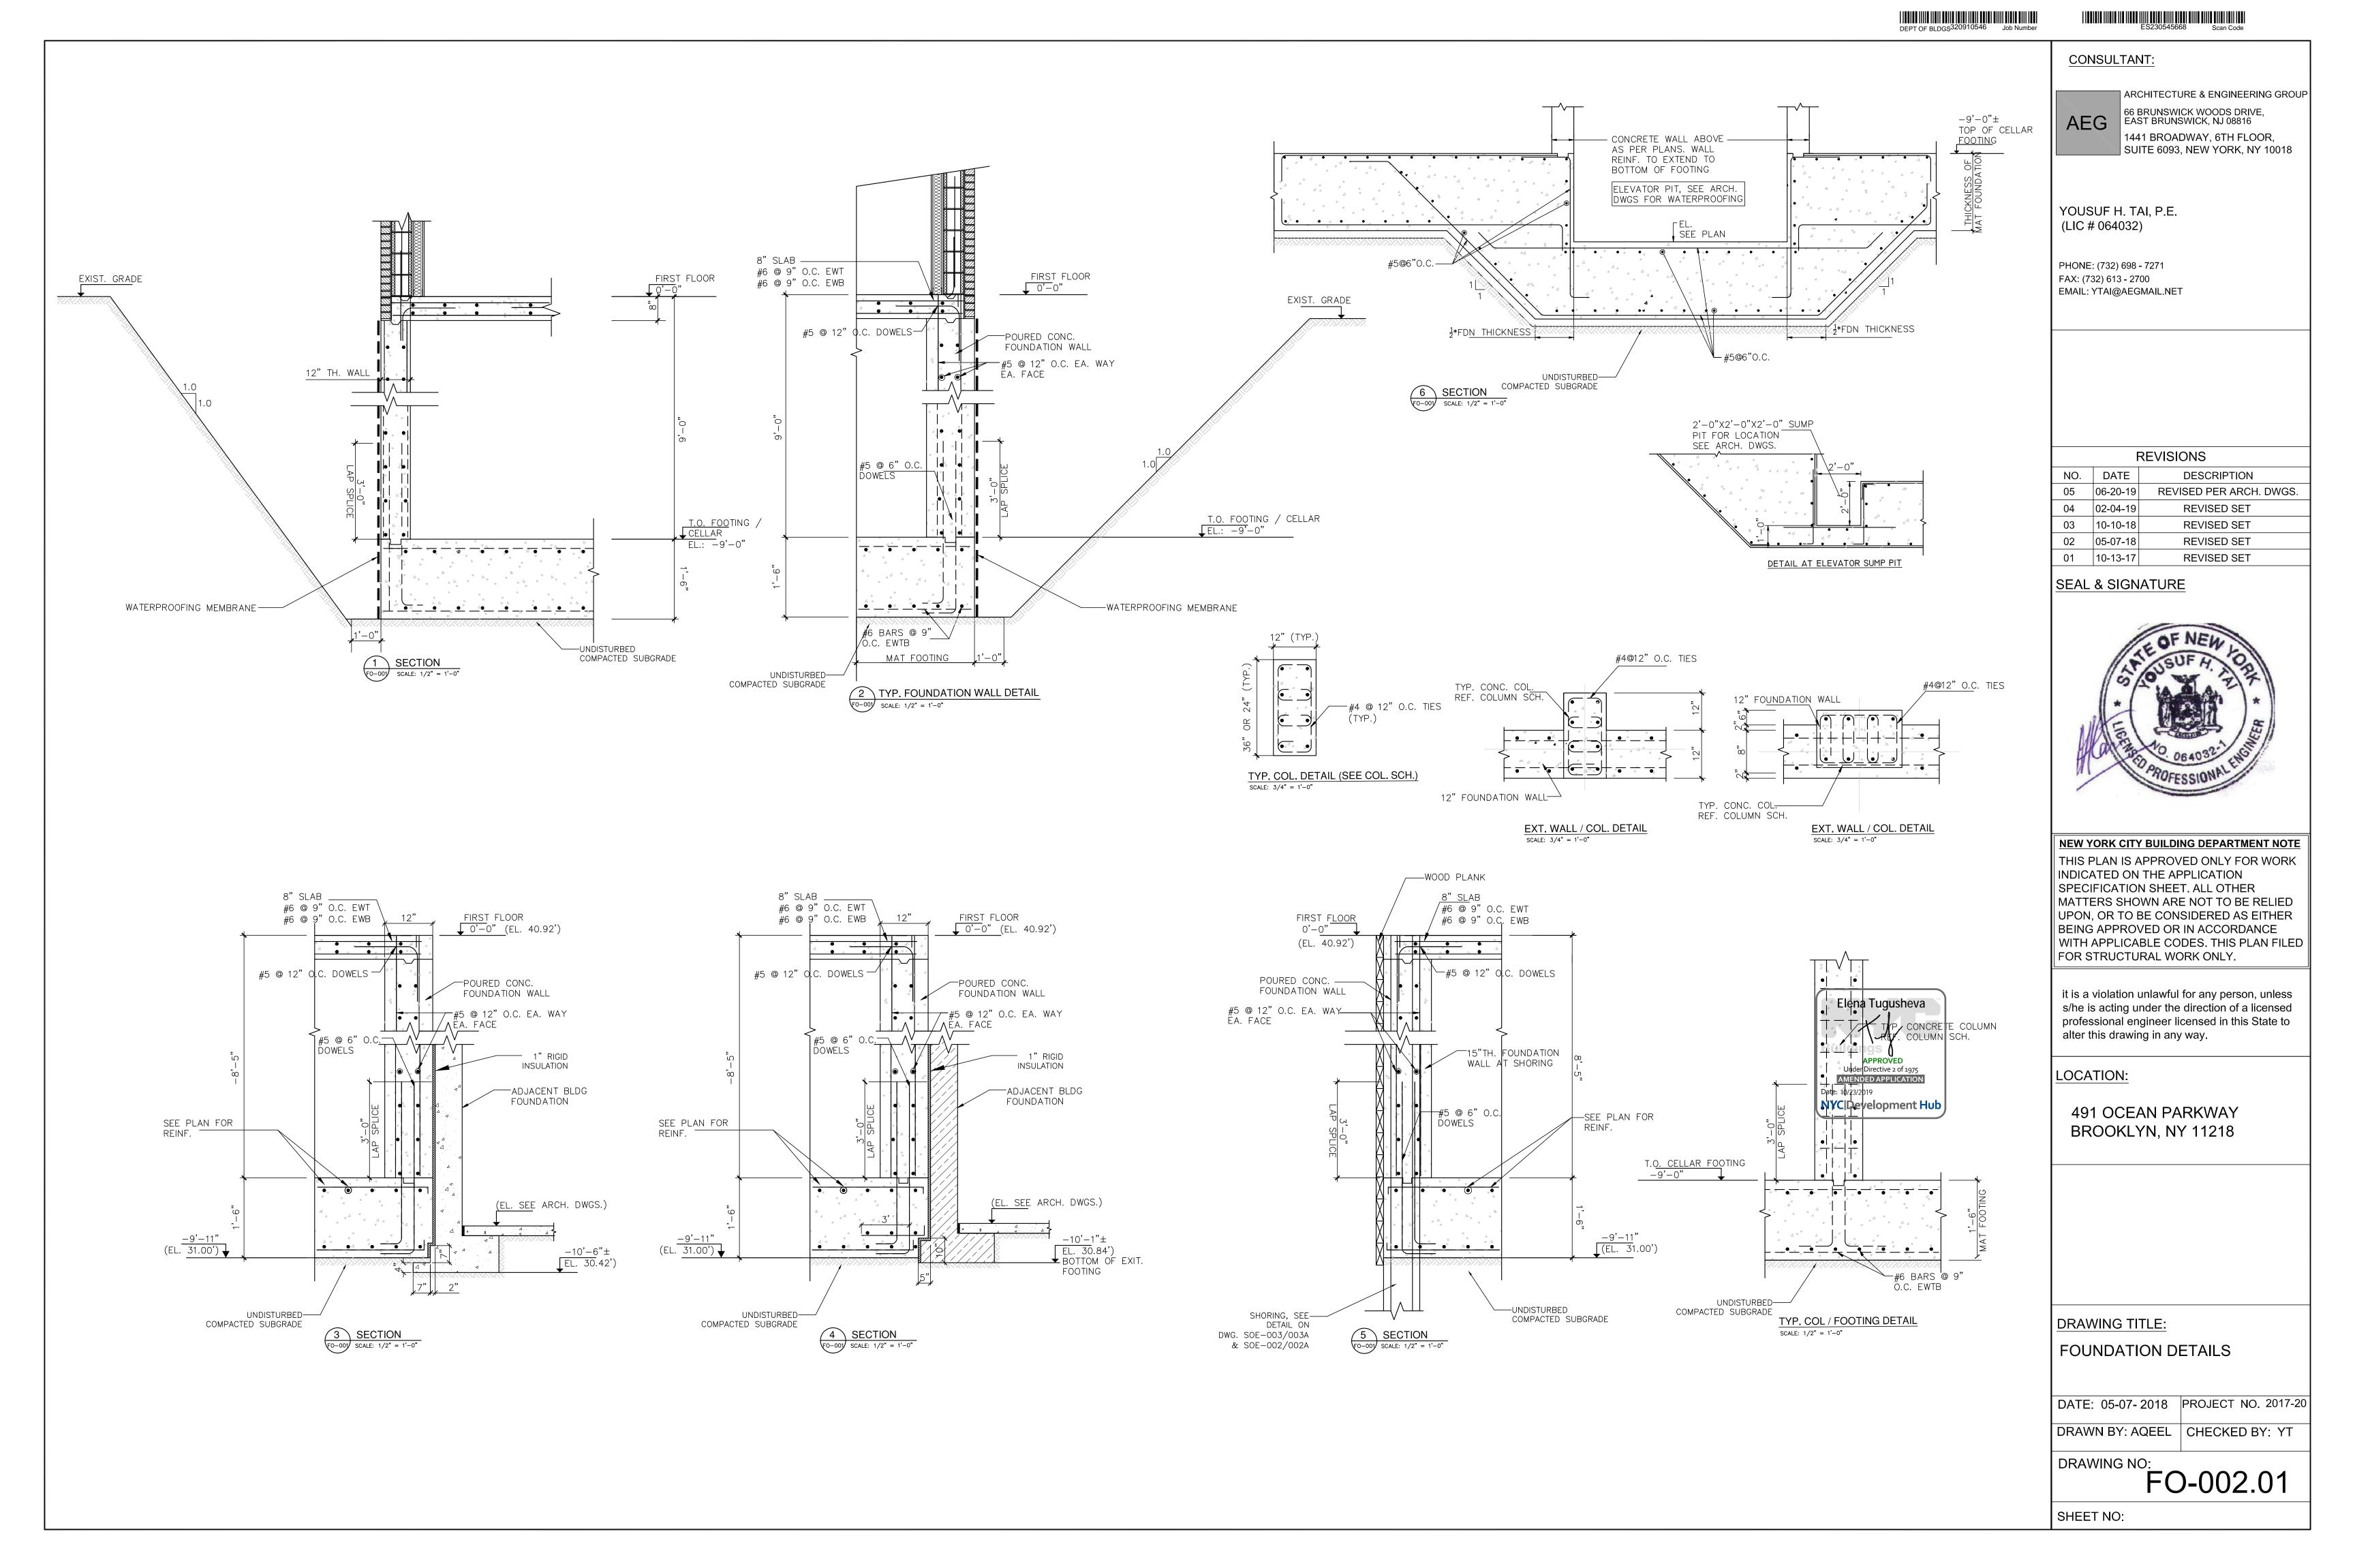

#### GENERAL NOTES - EXCAVATION AND SHORING:

- 1. TEN DAYS PRIOR STARTING WORK, CONTACT THE NEW YORK STATE UNDERGROUND UTILITIES PROTECTIVE ORGANIZATION (1-800-962-7962)TO MARK LOCATIONS OF EXISTING UTILITIES. LOCATE ALL ADJACENT UTILITIES BY THE TEST HOLES PRIOR TO EXCAVATION OR INSTALLATION OF SOLDIER BEAMS. RELOCATE SHEETING OR INTERFERING UTILITIES AS REQUIRED. VERIFY LOCATION OF ALL ADJACENT UTILITIES AND FOUNDATION PILES.
- 2. MAINTAIN SAFE CLEARANCE BETWEEN ANY OVERHEAD OR UNDERGROUND UTILITIES AND CRANE, HOE, OR DRILL RIG BOOMS DURING INSTALLATION OF SOLDIER BEAMS, TIEBACK ANCHORS, AND WALES.
- 3. INSTALL SOLDIER BEAMS IN THE LOCATIONS AND THE DEPTHS REQUIRED. ADJUST LOCATIONS FOR SOLDIER BEAMS AS REQUIRED TO AVOID EXISTING UTILITIES.
- 4. A SAFETY HANDRAIL AND KICKBOARD SHALL BE INSTALLED ALONG THE TOPS OF THE SHEETING WALLS PER OSHA STANDARDS PRIOR TO A MAXIMUM EXCAVATION DEPTH OF 4 FEET.
- 5. EXCAVATE AND INSTALL TIMBER LAGGING IN(2'-0" MAXIMUM VERTICAL LIFTS BRACING. DECREAS HEIGHT OF LAGGING LIFTS IF REQUIRED TO MAINTAIN A STABLE VERTICAL FACE. LAGGING SHALL BE TUCKED BEHIND OR BE ATTACHED TO THE FLANGES OF THE SOLDIER BEAMS. LAGGING SHALL BE 3" NOMINAL THICKNESS, UNTREATED, MIXED HARDWOODS., EACH LIFT OF LAGGING SHALL BE BACKFILLED AS NECESSARY SO THAT THE SOIL IS TIGHT AGAINST THE LAGGING.
- 6. INSTALL 17 LOUVER BLOCKS BETWEEN TIMBER LAGGING BOARDS. IF REQUIRED, PACK LOUVER SPACE WITH STRAW OR POROUS GEOTEXTILE FABRIC TO CONTROL GROUND WATER LEAKAGE AND PREVENT SOIL LOSS FROM BEHIND THE LAGGING
- 7. CONTINUE EXCAVATING AND LAGGING TO SUBGRADE AND CONSTRUCT THE PROPOSED FOUNDATION.
- 8. DURING BACKFILL. THE TOPS OF THE SOLDIER BEAMS SHALL BE CUT OFF AND REMOVED TO 3'-0''BELOW FINAL GRADE.
- 9. STRUCTURAL MEMBERS OF EQUIVALENT OR GREATER STRENGTH MAY BE SUBMITTED FOR THOSE SHOWN, ENGINEER SHALL BE NOTIFIED OF PROPOSED MEMBER SUSTITUTING PRIOR TO OTHER INSTALLATION.

## EXCAVATION AND FOUNDATION NOTES:

- 1. ALL MATERIAL, FABRICATION, INSTALLATION AND INSPECTION REQUIREMENTS RELATING TO THE FOUNDATIONS SHALL CONFORM TO THE LOCAL BUILDING CODE.
- 2. ALL STRUCTURAL WORK SHALL BE COORDINATED AND VERIFIED WITH THE ARCHITECTURAL, MECHANICAL, ELECTRICAL AND PLUMBING REQUIREMENTS.
- 3. THE CONTRACTOR SHALL DEMOLISH AND REMOVE EXISTING ELEMENTS AS INDICATED IN THE CONTRACT DOCUMENTS. THE CONTRACTOR  $_{\wedge}$ SHALL REMOVE, TRANSPORT AND DISPOSE OF ALL DEBRIS PROMPTLY (AS REQUIRED)
- 4. DEMOLITION SHALL BE DONE CAREFULLY. TAKE SPECIAL CARE NOT TO DAMAGE ANY EXISTING UNDERSLAB UTILITIES OR OTHER ELEMENTS NOT DESIGNED FOR REMOVAL.
- 5. THE CONTRACTOR SHALL PROTECT ALL EXCAVATIONS FROM FLOODING AND EXISTING WATER TABLE AND PROVIDE CONTINUOUS PUMPING AS REQUIRED FOR PERFORMANCE OF WORK. THE DEPTH OF EXCAVATION SHALL NOT BE CARRIED DEEPER THAN SPECIFIED IN THE CONTRACT DOCUMENTS WITHOUT THE ENGINEER OF RECORD'S CONSENT (RĚFEŘ ĞEŎ-ŤECH
- REPORT FOR GROUND WATER TABLE.
- 6. THE SUBGRADE FOR FOOTINGS AND SLABS SHALL BE INSPECTION AGENCY IMMEDIATELY PRIOR TO PLACING FOUNDATION CONCRET
- ALL MEANS & METHODS FOR UNDERPINNING, SHPETNIC SHORING OR OTHER SHINLAR CONSTRUCTION REQUIRED SHALL BE THE CONTRACTOR'S RESPONSIBILITY AND SHALL BE SUBJECT TO SPECIAL INSPECTIONS AS REQUIRED BY THE LOCAL CITY BUILDING CODE.
- 8. DO NOT PLACE CONCRETE WITHOUT APPROVED STRUCTURAL SHOP DRAWINGS AND MECHANICAL/ARCHITECTURAL SHOP DRAWINGS RELATED TO THE CONCRETE WORK.

- 9. THE CONTRACTOR SHALL PROVIDE ALL MEASURES AND PRECAUTIONS NECESSARY TO PREVENT DAMAGE AND SETTLEMENT (HORIZONTAL AND VERTICAL) OF EXISTING OR NEW CONSTRUCTION, INSIDE OR OUTSIDE THE PROJECT LIMITS.
- 10. THE CONTRACTOR SHALL PROVIDE ALL MEASURES NECESSARY TO CONTROL ICE, FROST, SURFACE AND SUBSURFACE WATER SO THAT THE FOUNDATION WORK IS PERFORMED ON DRY SUBGRADE.
- 11. NEW EXCAVATION SHALL NOT UNDERMINE NOR DISTURB ANY EXISTING ADJACENT FOOTINGS. NEW FOOTINGS SHALL BE SUPPORTED IN A MANNER TO MAINTAIN AN EXCAVATION SLOPE BETWEEN THE BOTTOM OF FOOTINGS AND EXCAVATION OF ONE VERTICAL TO TWO HORIZONTAL.
- 12. REROUTE ANY UNDERGROUND UTILITIES IF REQUIRED.
- 13. ALL FILL REQUIRED BELOW ANY PORTION OF THE STRUCTURE SHALL BE COMPACTED IN 8" LIFTS TO AT LEAST 95% OF THE MAXIMUM DRY DENSITY PER ASTM D-1557. REMOVE UNSUITABLE FILL AND REPLACE WITH CONTROLLED FILL AS REQUIRED FOR SOUND PLACEMENT OF FOUNDATIONS.
- 14. PROVIDE CONTINUOUS WATER STOPS IN ALL WATERPROOFING AND DAMPROOFING DETAILS.
- 15. SEE ARCHITECTURAL DRAWINGS FOR ALL WATERPROOFING AND DAMPPROOFING DETAILS

- 16. THE PERIMETER OF THE GENERAL EXCAVATION SHALL BE RETAINED BY A TEMPORARY SOIL/ROCK RETENTION SYSTEM. THE INSTALLATION, MAINTENANCE AND REMOVAL (WHEN REQUIRED) SHALL BE THE COMPLETE AND SOLE RESPONSIBILITY OF THE CONTRACTOR. THE CONTRACTOR SHALL PROVIDE ALL MEASURES AND PRECAUTIONS NECESSARY TO PREVENT DAMAGE AND SETTLEMENT OF EXISTING OR NEW CONSTRUCTION INSIDE OR OUTSIDE THE PROJECT LIMITS, CAUSED BY CONSTRUCTION TECHNIQUES OR MOVEMENTS OF THE SOIL/ROCK RETENTION SYSTEM, IS THE RESPONSIBILITY OF THE
- 17. THE CONTRACTOR SHALL COORDINATE ALL ELEMENTS OF THE SOIL/ROCK RETENTION SYSTEM WITH ALL ELEMENTS OF THE PERMANENT BUILDING.

- 18.ANY CHANGE IN TEMP. RETENTION SYSTEM SUGGESTED BY THE G.C. THE G.C.
- PROFESSIONAL ENGINEER REGISTERED IN THE STATE OF NEW YORK AND RETAINED BY THE CONTRACTOR. THE DRAWINGS SHALL INCLUDE PLANS AND SECTIONS OF EXCAVATION SEQUENCES. THE EXCAVATION SEQUENCES SHALL BE CONTROLLED TO MATCH THE REQUIREMENT OF THE DESIGN OF THE SOIL RETENTION SYSTEM.
- 19. THE GENERAL EXCAVATION SHALL CONSIST OF EXCAVATING AND REMOVING THE EXISTING SURFICIAL FILL MATERIALS TO REACH THE DESIRED SUBGRADE LEVEL. THE EXPOSED SUBGRADE SHOULD BE PROOFROLLED AND COMPACTED TO A FIRM AND UNJIELDING CONSISTENCY. THE EXCAVATION FOR FOOTINGS, PITS, ETC. SHALL BE EXCAVATED ON AN INDIVIDUAL, LOCALIZED BASIS DOWN FROM THE SLAB-ON-GRADE SUBGRADE LEVEL. EACH EXCAVATION SHALL BE TRIM, LEVEL SURFACE.
- 20. ALL EXCAVATION BELOW THE SLAB LEVEL REQUIRED FOR PITS SHALL BE RETAINED BY LOCALIZED SOIL RETENTION SYSTEMS AS MAY BE NECESSARY BASED ON A DESIGN USING APPROPRIATE EARTH AND HYDRAULIC PRESSURES AND OTHER CONSTRUCTION LOADINGS.
- 21. THE CONTRACTOR SHALL PROVIDE POSITIVE PROTECTION (MAT/SHEET COVERINGS) FOR ALL EXCAVATION SLOPES TO PROTECT SLOPES FROM INSTABILITY AND DETERIORATION DUE TO RAIN, WIND OR SNOW/ICE.

## STRUCTURAL NOTES:

- 1. ALL WORK SHALL COMPLY WITH THE REQUIREMENTS OF THE LOCAL BUILDING CODE AND STATE OF NEW YORK.
- 2. COORDINATE THE STRUCTURAL DRAWINGS WITH THE ARCHITECTURAL AND M/E/P DRAWINGS.
- 3. EXISTING CONDITIONS, ELEVATORS, DIMENSIONS AND SYSTEMS SHOWN ON PLANS ARE BASED ON LIMITED FIELD OBSERVATIONS. THE CONTRACTOR SHALL FIELD-VERIFY ALL DETAILS, DIMENSIONS AND ASSUMPTIONS PRIOR TO ANY WORK. WHERE EXISTING CONDITIONS DIFFER FROM OR PRECLUDE THE EXECUTION OF THE OUTLINED DETAILS, THE ENGINEER SHALL BE NOTIFIED.
- 4. CONTRACTOR SHALL BE RESPONSIBLE FOR COORDINATING ALL FINAL FIELD-VERIFIED DIMENSIONS AND SHALL SUBMIT FIELD-VERIFIED DIMENSIONED SHOP DRAWINGS.
- 5. THE CONTRACTOR SHALL PROVIDE ALL TEMPORARY SHORING AND BRACING REQUIRED FOR PLUMBNESS, STABILITY AND SAFETY WHENEVER REQUIRED TO SUPPORT LOADS AS MAY BE IMPOSED UPON THE STRUCTURE DURING CONSTRUCTION. BRACING AND SHORING SHALL BE THE SOLE SOLE RESPONSIBILITY OF THE CONTRACTOR AND HIS/HER PROFESSIONAL ENGINEER. STAGING AND SEQUENCE OF SHORING, BRACING OR OTHER CONSTRUCTION REQUIRED FOR SUCH WORK SHALL BE PREPARED IN THE FORM OF SHOP OR DETAIL DRAWINGS AND CALCULATIONS.
- 6. DO NOT FABRICATE ANY WORK WITHOUT APPROVED STRUCTURAL SHOP DRAWINGS FOR ALL STRUCTURAL WORK, AND MECHANICAL/ARCHITECTURAL SHOP DRAWINGS RELATED TO THE STRUCTURAL WORK.
- 7. CONTRACTOR TO PROTECT AT ALL TIMES EQUIPMENT, PIPES AND OTHER EXPOSED OR EMBEDDED ITEMS ON THE SITE AGAINST DAMAGE. REROUTE AS REQUIRED PER M/E/P DRAWINGS.

## STRUCTURAL STEEL NOTES:

- 1. STRUCTURAL STEEL SHALL COMPLY WITH ASTM A572 GRADE 50, UNLESS OTHERWISE NOTED.
- 2. STRUCTURAL STEEL TUBING SHALL COMPLY WITH ASTM A500, UNLESS OTHERWISE NOTED.
- 3. SUBMIT SHOP DRAWINGS FOR ALL WORK. DO NOT PROCEED WITH ANY FABRICATION UNTIL THE SHOP DRAWINGS ARE REVIEWED AND APPROVED. SHOP DRAWINGS SHALL BE BASED ON FIELD-VERIFIED CONDITIONS.
- 4. AFTER FABRICATION, CLEAN STEEL OF ALL RUST, LOOSE MILL, SCALE AND OTHER FOREIGN MATERIALS.
- 5. ALL WELDING SHALL BE DONE BY QUALIFIED WELDERS AND SHALL CONFORM TO "AWS STRUCTURAL WELDING CODE-STEEL", LATEST EDITION. WELDERS SHALL BE LICENSED BY THE BUILDING SUPERINTENDENT IN ACCORDANCE WITH ALL REQUIREMENTS OF THE CITY OF NEW YORK LOCAL BUILDING CODE, AND THE RULES AND REGULATIONS OF THE BOARD OF STANDARDS AND APPEALS.
- 6. WELDING ELECTRODES SHALL BE E70XX FOR NEW CONST. AND E60 LOW HYDROGEN FOR EXISTING.
- 7. MINIMUM FILLET WELDS SHALL COMPLY WITH AISC, BUT SHALL NOT BE LESS THAN  $\frac{1}{4}$  INCH, UNLESS OTHERWISE NOTED.
- 8. PROVIDE FIREPROOF BLANKETS AND OTHER FIRE PROTECTION MEASURES AS REQUIRED FOR FIRE SAFETY DURING WELDING.
- 9. SURFACES OF ALL STEEL THAT IS TO RECEIVE WELDS SHALL BE POWER BRUSHED AND CLEANED THOROUGHLY OF ALL FOREIGN MATTER AND PAINT FOR A DISTANCE OF 2 INCHES FROM EACH SIDE OF THE OUTSIDE LINE OF WELD.

## NOTES OF UNDERPINNING PROCEDURES:

- 1. A PRE-CONSTRUCTION SURVEY SHALL BE PERFORMED ON THE BUILDING TO BE UNDERPINNED BY AN INDEPENDENT PROFESSIONAL. IN ORDER TO DOCUMENT EXISTING CONDITION OF THE BUILDING. PAY ATTENTION TO AND DOCUMENT SIGNS OF EXISTING STRESS INCLUDING CRACKS, SAGGING, TIGHT DOORS, ETC. THE SURVEY SHALL INCLUDE PICTURES, MEASUREMENTS, ETC. LOCATE ALL ADJACENT UTILITIES BY TEST PIT AND NOTIFY ONE CALL PRIOR TO START OF UNDERPINNING.
- A SURVEY MONITORING SYSTEM SHALL BE STABLISHED PRIOR TO BEGINNING NDERPINNING. BOTH HORIZONTAL AND VERTIC OVEMENTS SHALL BE MONITORED ON BASIS AS UNDERPINNING IS PROCEEDIN NGINEER AND THE PROJECT ENGINEER SH be\notified immediately of any struct**u/**f MO**V**EMENTS.
- 3. UNDERPINNING PITS ARE CLASSIFIED BY DSHA AS CONFINED SPACES AND ALL APPLICABLE REQUIREMENTS SUCH AS AIR MONITORIN PERSONAL RETRIEVAL SYSTEMS, ACCES\$, ETC,. MUST BE IMPLEMENTED.
- 4. THE AREA ADJACENT TO ELEVATOR SHALL BE EXCAVATED TO AN ELEVATION APPROXIMATELY AT THE TTOM OF EXISTING FOOTI NOTIFY THE ENGINEER IF BOTTOM OF FOOTING ELEVATION\$ VARY FROM WHAT IS SHOWN ON THE DRAWINGS. ROOF, FOUNDATION, AND AREA DRAINS IN THE UNDERPINNING ARE SHALL BE REROUTED AS NECESSARY TO PREVENT DISCHARGE IN TO THE UNDERPINNING WORK AREA. SLOPE THE GROUND SURFACE AWAY FROM THE FOUNDATION JUST ENOUGH TO PREVENT ACCUMULATION OF SURFACE WATER ALONG THE UNDERPINNING AREA. AN APPROACH PIT APPROXIMATELY $\sqrt{5}$  DEEP AND/EQUAL TO THE 「 WIDTH SH∦LL BE EXCAVATED UNDERPINNING P AND SHORED IN TRONT OF THE EXISTING FOUNDATION
- 5. THE APPROACH PI $^{\dagger}$ SHALL BE EXTENDED UNDER THE FOOTING TO THE BACK OF THE UNDERPINNING PIT AND SHEETING CONSISTING OF UNTREATED 3" NOMINAL (MINIMUM) THICKNESS LUMBER INSTALLED. THE OUTSIDE OF THE PIT RINGS (SHEETING) SHALL BE BACKFILLED AND COMPACTED AS NECES\$ARY. VOIDS BEHIND THE PIT RINGS ARE NOT ALLOWED. LINE LOUVERS WITH FILTER FABRIC ALLOW FOR VISUAL INSPECTION AND FILLING OF ANY VOIDS. UNDERPINNING PIT SHORING AND INTERIOR LAGGING SHALL BE B" NOMINAL DIMENSION, HEM-FIR OR DOUGYAS FIR\LARCH, NO. 2 OR BETTER.
- 6. THE UNDERPINNING PIT EXCAVATION UNDER THE FOOTING SHALL PROGRESS DOWNWARD BY HAND EXCAVATION AS ADDITIONAL AT RINGS ARE INSTALLED. IN NO CASE SHALL EXCAVATION GREATER THAN 1'-0" BE PERFORMED WITHOUT INSTALLATION OF PIT RING BOARDS.
- 7. EXCAVATION AND INSTALLATION OF PIT RINGS SHALL BE EXTENDED TO THE BOTTOM OF PIT ELEVATION. DO NOT DISTURB THE BOTTOM OF PIT MATERIAL DURING EXCAVATION. BOTTOM OF PIT SHALL BE INSPECTED FOR ADEQUATE BEARING. F BEARING AT THE BOTTOM OF PIT IS NOT ADEQUATE, THE ENGINEER SHALL BE NOTIFIED! POSSIBLE ADJUSTMENTS INCLUDE BELLING THE BOTTOM OF THE PIT, EXTENDING THE PIT/DEEPER, INCREASING THE NUMBER OF UNDER INNING PIERS, ETC., AS DETERMINED BY THE ENGINEER.
- 8. BULNHEAD THE APPROACH PIT AND POUR THE PIT WITH 4,000 PSI CONCRETE LEAVING THE TOP CONCRETE APPROXIMATELY 3" BELOW THE BOTTOM OF THE FOOTING. CONCRETE MAY BE CED USING THE FREE-FALL METHOD. NOT REQUIRED.
- 9. THE NEXT WORK DAY, DRIVE STEEL WEDGES TACK WELD IN PLACE. THEN DRYPACK THE JNDERPINNING PIER BY TAMPING THE DRYPAC WITH A SHORT PIECE OF 2X4 POUNDED WITH A 8LB. HAMMER TO COMPLETELY FILL THE SPACE. DRYPACK SHALL CONSIST OF A MIXTURE OF TWO PARTS SAND AND ONE PART TYPE I CEMENT WITH JUST ENOUGH WATER TO FORM A BALL WHEN SQUEEZED IN HAND.
- 10. UPON COMPLETION OF DRYPACK, ADJACENT UNDERPINNING PITS MAY BE EXCAVATED. IF PIERS ARE CONTINUOUS, THE SIDE BOARDS SHOULD BE STRIPPED AS EXCAVATION PROCEEDS.

UPON COMPLETION OF ALL UNDERPINNING PIERS THE SITE MAY BE EXCAVATED AS IEBACKS ARE INSTALLED WHERE REQUIRED. CESSARY, FRONT AND SIDE RING BOARD WEEN PIERS SHALL BE REMOVED. 

- \$ 12. WIDTA OF UNDERPINNING PIERS, DEPX TO RING BOARDS INSTALLATION, SPACING BETWEEN RIERS, ETC, SHALL BE REQUIRED, AS warranted, if loose material, DETERIORATED FOUNDATION IS ENCOUNTERED. SEE GEO-TECH REPORT.
- 13. NO TWO UNDERPHINING PITS CLOSER THAN 12' CENTER TO CENTER, NOR TWO ADJACENT COLUMN FOOTINGS, MXX BE UNDERPINNED CONCURRENTLY.
- 14. UNDERPINNING PYÉRS SHALL BE SHEETED ON FOUR SIDES WITH CONSTRUCTION GRADE HORIZONTAL TIMBERS. CONTRACTOR SHALL DESIGN AND INSTALL SHEETING CAREFULLY TO AVOID ANY LOSS OF SOIL OR SURPORT FROM BENEATH THE NEIGHBORING BUILDI SLAB-ON-GRADE. THE HORIZONTAL TIMBER SHALL BE "LOUVERED", THAT\S THEY BE SPACED APART 1" TO 2" TO RERMIT ING AND BACKPACKING OF ANY VOIDS THAT CUR BEHIND THE HORIZONTAL SHEETING, SHEETING SHALL BE BACKPACKED WITH PERMEABLE SOIL TO PREVENT ANY BUILD-UP HYDROSTATIC PRESSURE BEHIND SHEETING.

OWNER SHALL ENGAGE AN INDEPENDENT AGENCY FOR VIBRATION, CRACKS & MOVEMENT MONITORING AND SHALL FOLLOW THE REQUIREMENTS OF TPP #

TEST PITS SHALL BE PERFORMED, WHERE REQUIRED, TO CONFIRM THE FIELDS CONDITION PRIOR TO THE COMMENCEMENT OF WORK. SEE DWG. SOE-002 OR SOE-002A FOR LOCATION.

#### SPECIAL INSPECTION NOTES


- ALL CONTROLLED INSPECTIONS SHALL BE CONDUCTED BY A SPECIAL INSPECTION AGENCY RETAINED BY THE CONTRACTOR. SUCH AGENCY SHALL BE REGISTERED WITH THE N.Y.C. DEPARTMENT OF BUILDING AS QUALIFIED TO CONDUCT SPECIFIED INSPECTIONS AND EMPLOY SPECIAL INSPECTORS.
- 2. THE CONTRACTOR MUST NOTIFY THE INSPECTIONS AT LEAST 72 HOURS BEFORE THE SPECIFIC WORK COMMENCES.
- 3. INSPECTIONS UNDER STRUCTURAL APPLICATION
- 3.1 SUB GRADE INSPECTION 3.2 DEEP FOUNDATION ELEMEN 3.3 EXCAVATIONS—SHEETING, AND BRAND - BC 1704.20.2
- 4. ANY REQUIRED INSPECTIONS A MATERIALS BY THE CONTRACTOR SHALL APPROVED AND MATERIALS BY THE CONTRACTOR BY THE BY THE CONTRACTOR BY THE CONTRACTOR BY THE CONTRACTOR BY THE CO UNDER THE DIRECT SUPERVISION ARCHITECT OR ENGINEER RETAI NETE: 10/23/2019 ON THE BEHALF OF THE CONTRACT WYCVDevelopment Hub
- BE ACCEPTABLE TO THE ARCHIVE WHO SUPERVISED THE PREPARATION OF THE PLANS.
- > 5. SEE ARCH. & STRUCTURAL DRAWINGS FOR ADDITIONAL INSPECTIONS.



Elena Tugusheva

AMENDED APPLICATION

#### CONSULTANT

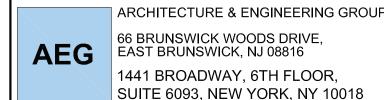

YOUSUF H. TAI, P.E. (LIC # 064032)

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#### **REVISIONS**

NO.	DATE	DESCRIPTION
05	07-05-19	REVISED PER COMMEN
04	05-03-19	REVISED PER COMMEN
03	10-10-18	REVISED SET
02	05-07-18	REVISED SET
01	10-13-17	REVISED SET

#### **SEAL & SIGNATURE**



NEW YORK CITY BUILDING DEPARTMENT NOTE THIS PLAN IS APPROVED ONLY FOR WORK INDICATED ON THE APPLICATION SPECIFICATION SHEET. ALL OTHER MATTERS SHOWN ARE NOT TO BE RELIED UPON, OR TO BE CONSIDERED AS EITHER BEING APPROVED OR IN ACCORDANCE WITH APPLICABLE CODES. THIS PLAN FILED FOR STRUCTURAL WORK ONLY.

it is a violation unlawful for any person, unless s/he is acting under the direction of a licensed professional engineer licensed in this State to alter this drawing in any way.

## LOCATION:

491 OCEAN PARKWAY BROOKLYN, NY 11218

**DRAWING TITLE:** 

**GENERAL NOTES** 

DATE: 05-04-2018 | PROJECT NO. 2017-20

DRAWN BY: AQEEL | CHECKED BY: YT

DRAWING NO: SOE-001.01

SHEET NO:

## PLAN & CRITERIA FOR BUILDING MOVEMENTS & VIBRATION MONITORING:

- 1. PROVIDE DEFORMATION MONITORING POINT AT 10'-0" O.C. AT UNDER PINNING LOCATION. ONE AT GROUND LEVEL & ONE AT ROOF LEVEL (ON PARAPET) (NOT REQ'D)
- 2. PROVIDE DEFORMATION MONITORING POINT ONE AT CENTER OF BUILDING AT BACKYARD. (TOP & BOTT.) (NOT REQ'D)
- 3. THE MAXIMUM PERMISSIBLE MOVEMENT SHALL BE 1/4" IN ANY DIRECTION (IN ACCORDANCE WITH THE REQUIREMENTS IN TPPN#10/88) (NOT REQ'D)
- 4. PROVIDE VIBRATION MONITOR AS SHOWN ON PLAN
  - (4a) THE MAXIMUM PERMISSIBLE PEAK PARTICLE VELOCITY SHALL BE 0.5 IN/SEC. WITH NO DISTANCE CRITERION.
  - (4b) THE MAXIMUM PERMISSIBLE PEAK VELOCITY SHALL BE REDUCED, IF MOVEMENTS OR CRACKING IS DETECTED.
- 5. A LICENSED SURVEYOR SHALL BE RETAINED TO MONITOR MOVEMENTS & TILTING OF THE BUILDINGS & TEMPORARY RETAINING SYSTEMS. (NOT REQ'D)
  - (5a) OPTICAL SURVEY READING SHALL BE TAKEN TO AN ACCURACY OF  $\pm$  0.01 FT. (NOT REQ'D)
- DEFORMATION MONITORING POINT (AT GROUND & ROOF (NOT REQ'D) LEVEL) @10'-0" O.C.

AUTOMATED NOTIFICATIONS FROM (FOR DRIVEN PILE OPTION ONLY) VIBRATION MONITOR SHALL BE SENT DIRECTLY TO GEI. Courtyard BRICK BLDG SOE-003 BSMT BRICK BLDG ₿ BSMT EXTENSION 7 STORY 6 STORY 30'-0"± 37'-81/2" 31'-71/4" 28'-91/2" PATCH ANY BOLT HOLE MADE AFTER REMOVING YARD THE ANGLES. INSTALL LIQUID WATER PROOFING OVER THE PATCHES. (TYP.) ----NEW FOUNDATION WALL SEE STR. DWGS. \SOE-003/ —L 6X6X₃³" FULL DEPTH - TEST PIT LOCATION, SEE NOTE 5 (TYP.) SEE NOTE 1 32'-0" 35'-6" 30'-53/4" 1-HP 12X74 @5'-0"0.C. 5-HP 12X74 (MAX.) @5'-0"0.C. EQ. Elena Tugusheva BRICK BLDG BRICK BLDG YARD 4 STORY 4 STORY Courtyard Under Directive 2 of 1975 AMENDED APPLICATION

SOE-003/

## NOTES:


1. ATTACH L  $6 \times 6 \times 8^3$ " WITH EXISTING BUILDING WALLS USING 3" DIA. HILT ANCHOR BOLTS @ 12" O.C. ATTACH | SUPPORT OF EXCAVATION 3" WOOD LAGGING WITH L6X6X3 ALONG EXCAVATION

Date: 10/23/2019

NYC Development Hub

- DEPTH. 2. FOR OTHER NOTES, SEE DWG. S-001.
- 3. ALL EARTH SUPPORTING SYSTEMS ARE DESIGNED BASED ON SOIL REPORT PREPARED BY CENTURY TESTING & CONSULTING INC.,ON 09/20/2017 4. FOR DETAILS, SEE DRAWING SOE-003.
- 5. EXCAVATE TEST PIT TO DETERMINE FOUNDATION BEARING LEVEL & CONDITION PRIOR TO THE COMMENCEMENT OF THE GENERAL EXCAVATION.

#### CONSULTANT:

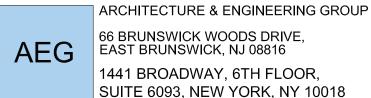

YOUSUF H. TAI, P.E.

PHONE: (732) 698 - 7271 FAX: (732) 613 - 2700 EMAIL: YTAI@AEGMAIL.NET

(LIC # 064032)

# NOT PREFERABLE

REVISIONS		
NO.	DATE	DESCRIPTION
06	07-05-19	REVISED PER COMMENTS
05	06-20-19	REVISED PER ARCH. DWG.
04	05-03-19	REVISED PER COMMENTS
03	10-10-18	REVISED SET
02	05-07-18	REVISED SET
01	10-13-17	REVISED SET

#### SEAL & SIGNATURE



**NEW YORK CITY BUILDING DEPARTMENT NOTE** THIS PLAN IS APPROVED ONLY FOR WORK INDICATED ON THE APPLICATION SPECIFICATION SHEET. ALL OTHER MATTERS SHOWN ARE NOT TO BE RELIED UPON, OR TO BE CONSIDERED AS EITHER BEING APPROVED OR IN ACCORDANCE WITH APPLICABLE CODES. THIS PLAN FILED FOR STRUCTURAL WORK ONLY.

it is a violation unlawful for any person, unless s/he is acting under the direction of a licensed professional engineer licensed in this State to alter this drawing in any way.

#### LOCATION:

491 OCEAN PARKWAY BROOKLYN, NY 11218

#### DRAWING TITLE:

PLAN

DATE: 05-04- 2018 PROJECT NO. 2017-20

DRAWN BY: AQEEL | CHECKED BY: YT

DRAWING NO:

SOE-002.01

SHEET NO:



Courtyard

Courtyard

L 6X6X8"\_\_\_ FULL DEPTH

SEE NOTE 1

1-HP 12X74 @5'-0"0.C.

(MAX)

1-HP

12X74

@5'-0"0.C.

(MAX.)

(TYP.)

CURB

LINE

\SOE-003/

—— CURB

LINE

Chain Link Fence

ARCHITECTURE & ENGINEERING GROUP

66 BRUNSWICK WOODS DRIVE, EAST BRUNSWICK, NJ 08816

1441 BROADWAY, 6TH FLOOR, SUITE 6093, NEW YORK, NY 10018

CONSULTANT:

YOUSUF H. TAI, P.E.

(LIC # 064032)

#### PLAN & CRITERIA FOR BUILDING MOVEMENTS & VIBRATION MONITORING:

- 1. PROVIDE DEFORMATION MONITORING POINT AT 10'-0" O.C. AT UNDER PINNING LOCATION. ONE AT GROUND LEVEL & ONE AT ROOF LEVEL (ON PARAPET) (NOT REQ'D)
- 2. PROVIDE DEFORMATION MONITORING POINT ONE AT CENTER OF BUILDING AT BACKYARD. (TOP & BOTT.) (NOT REQ'D)
- 3. THE MAXIMUM PERMISSIBLE MOVEMENT SHALL BE 1/4" IN ANY DIRECTION (IN ACCORDANCE WITH THE REQUIREMENTS IN TPPN#10/88) (NOT REQ'D)
- 4. PROVIDE VIBRATION MONITOR AS SHOWN ON PLAN
  - (4a) THE MAXIMUM PERMISSIBLE PEAK PARTICLE VELOCITY SHALL BE 0.5 IN/SEC. WITH NO DISTANCE CRITERION.
  - (4b) THE MAXIMUM PERMISSIBLE PEAK VELOCITY SHALL BE REDUCED, IF MOVEMENTS OR CRACKING IS DETECTED.

PHONE: (732) 698 - 7271 FAX: (732) 613 - 2700 EMAIL: YTAI@AEGMAIL.NET NO. DATE 01 06-20-19 REVISED PER ARCH. DWG.

**PREFERABLE** 

**ALTERNATE - 1** 

**REVISIONS** DESCRIPTION

02 07-05-19 REVISED PER COMMENTS

SEAL & SIGNATURE



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#### LOCATION:

491 OCEAN PARKWAY BROOKLYN, NY 11218

DRAWING TITLE:

PLAN


DATE: 05-04- 2018 PROJECT NO. 2017-20

DRAWN BY: AQEEL | CHECKED BY: YT

DRAWING NO:

SOE-002A.00

SHEET NO:

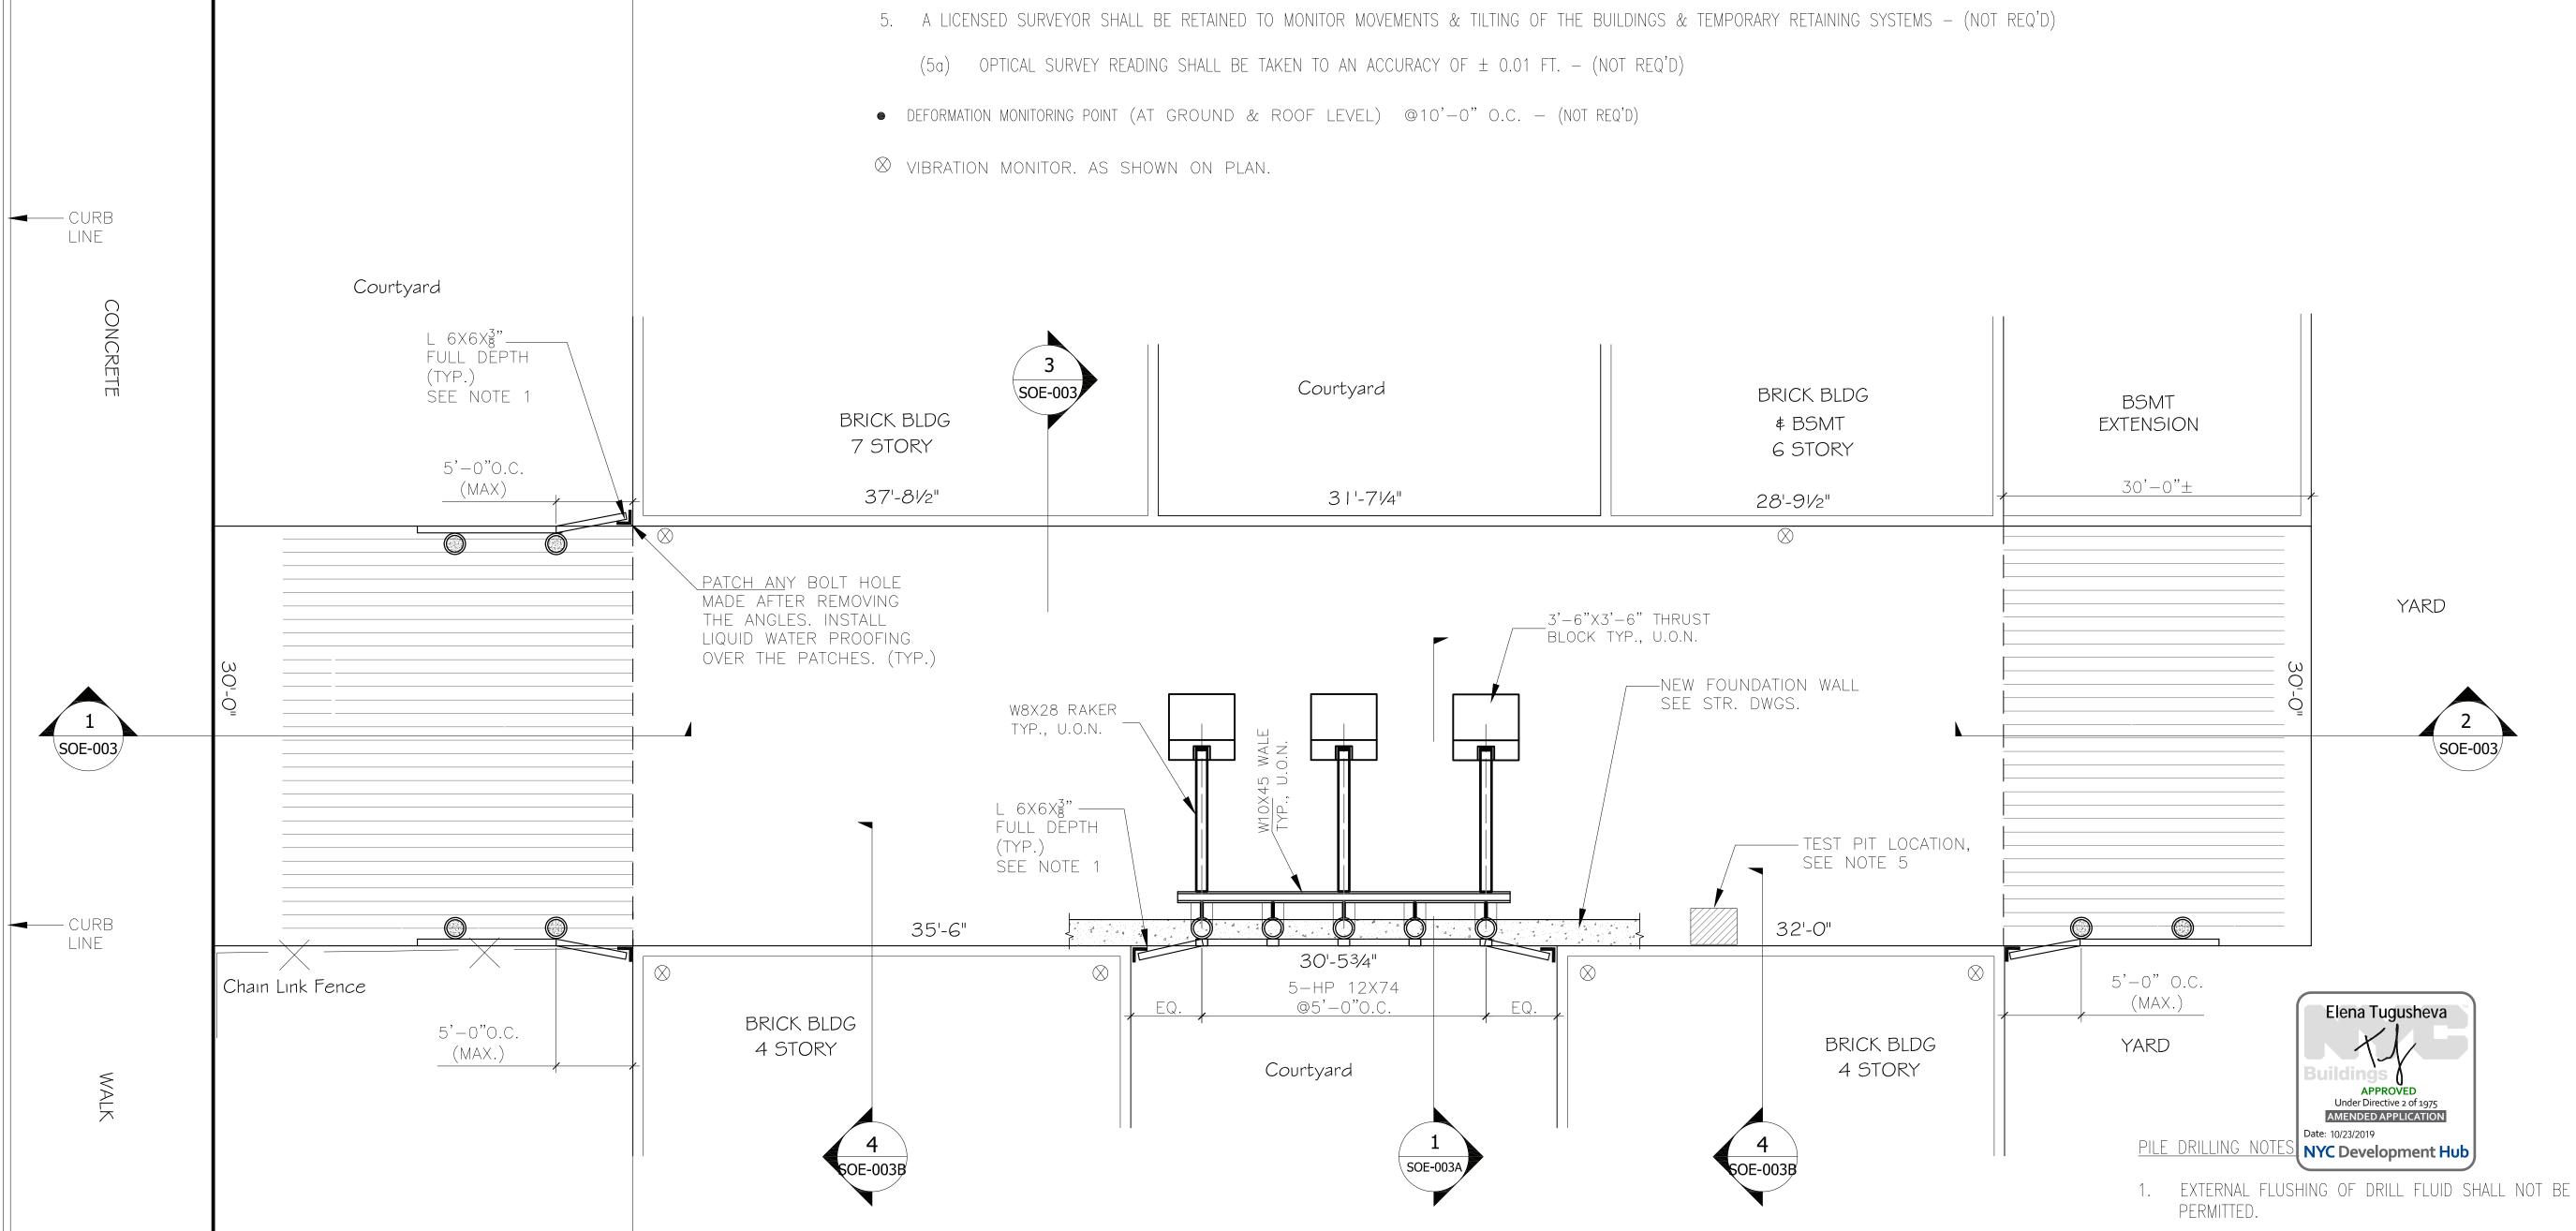

SUPPORT OF EXCAVATION PLAN SCALE: NTS

Courtyard

NOTES:

PILE.

OBSTRUCTION).

1. ATTACH L  $6 \times 6 \times \frac{3}{8}$ " WITH EXISTING BUILDING WALLS USING 3" DIA. HILT ANCHOR BOLTS @ 12" O.C. ATTACH | SUPPORT OF EXCAVATION 3" WOOD LAGGING WITH L6X6 $\chi_8^3$  ALONG EXCAVATION DEPTH.

2. FOR OTHER NOTES, SEE DWG. S-001.


2. THE DRILL HEAD SHALL NOT EXTEND BELOW THE


THE PILE (UNLESS NECESSARY TO REMOVE AN

3. AIR HAMMERS SHALL NOT BE USED TO ADVANCE THE

BOTTOM OF THE PILE CASING DURING INSTALLATION OF

- 3. ALL EARTH SUPPORTING SYSTEMS ARE DESIGNED BASED ON SOIL REPORT PREPARED BY CENTURY TESTING & CONSULTING INC.,ON 09/20/2017 4. FOR DETAILS, SEE DRAWING SOE-003.
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- ALL INDICATED SIZES ARE FULL SIZES.

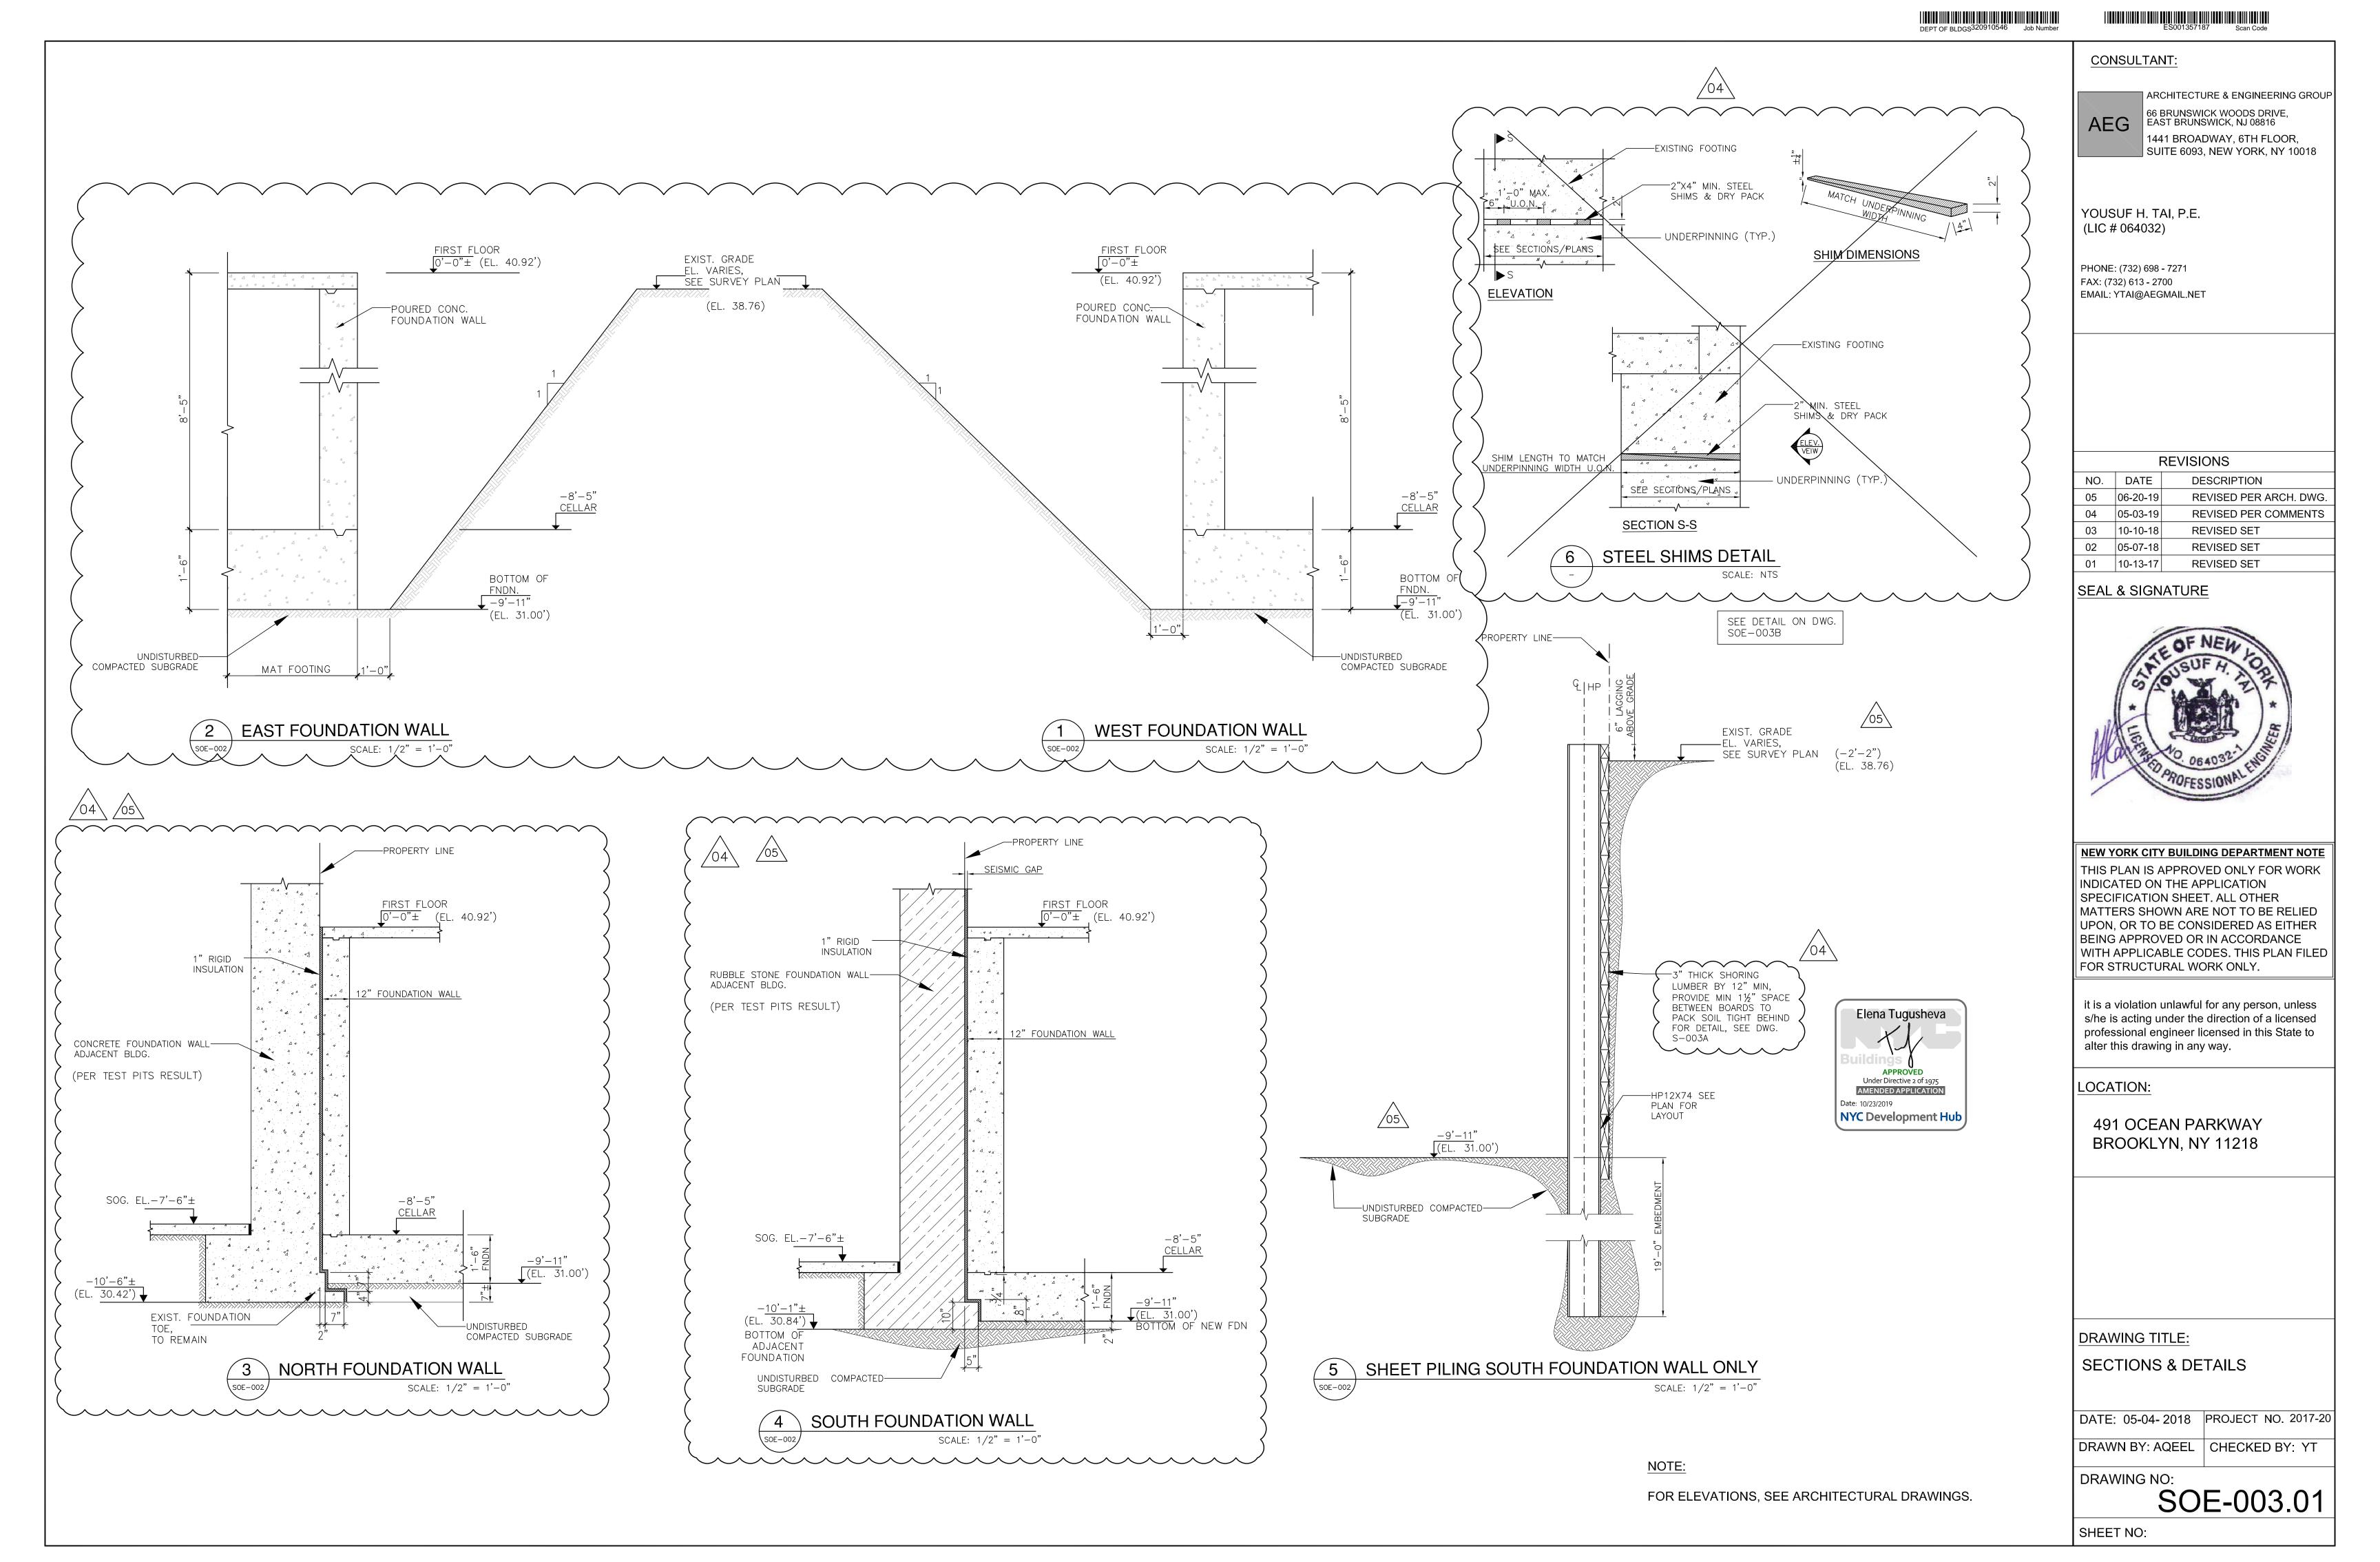- USE MIN. 3" THICK LAGGING.

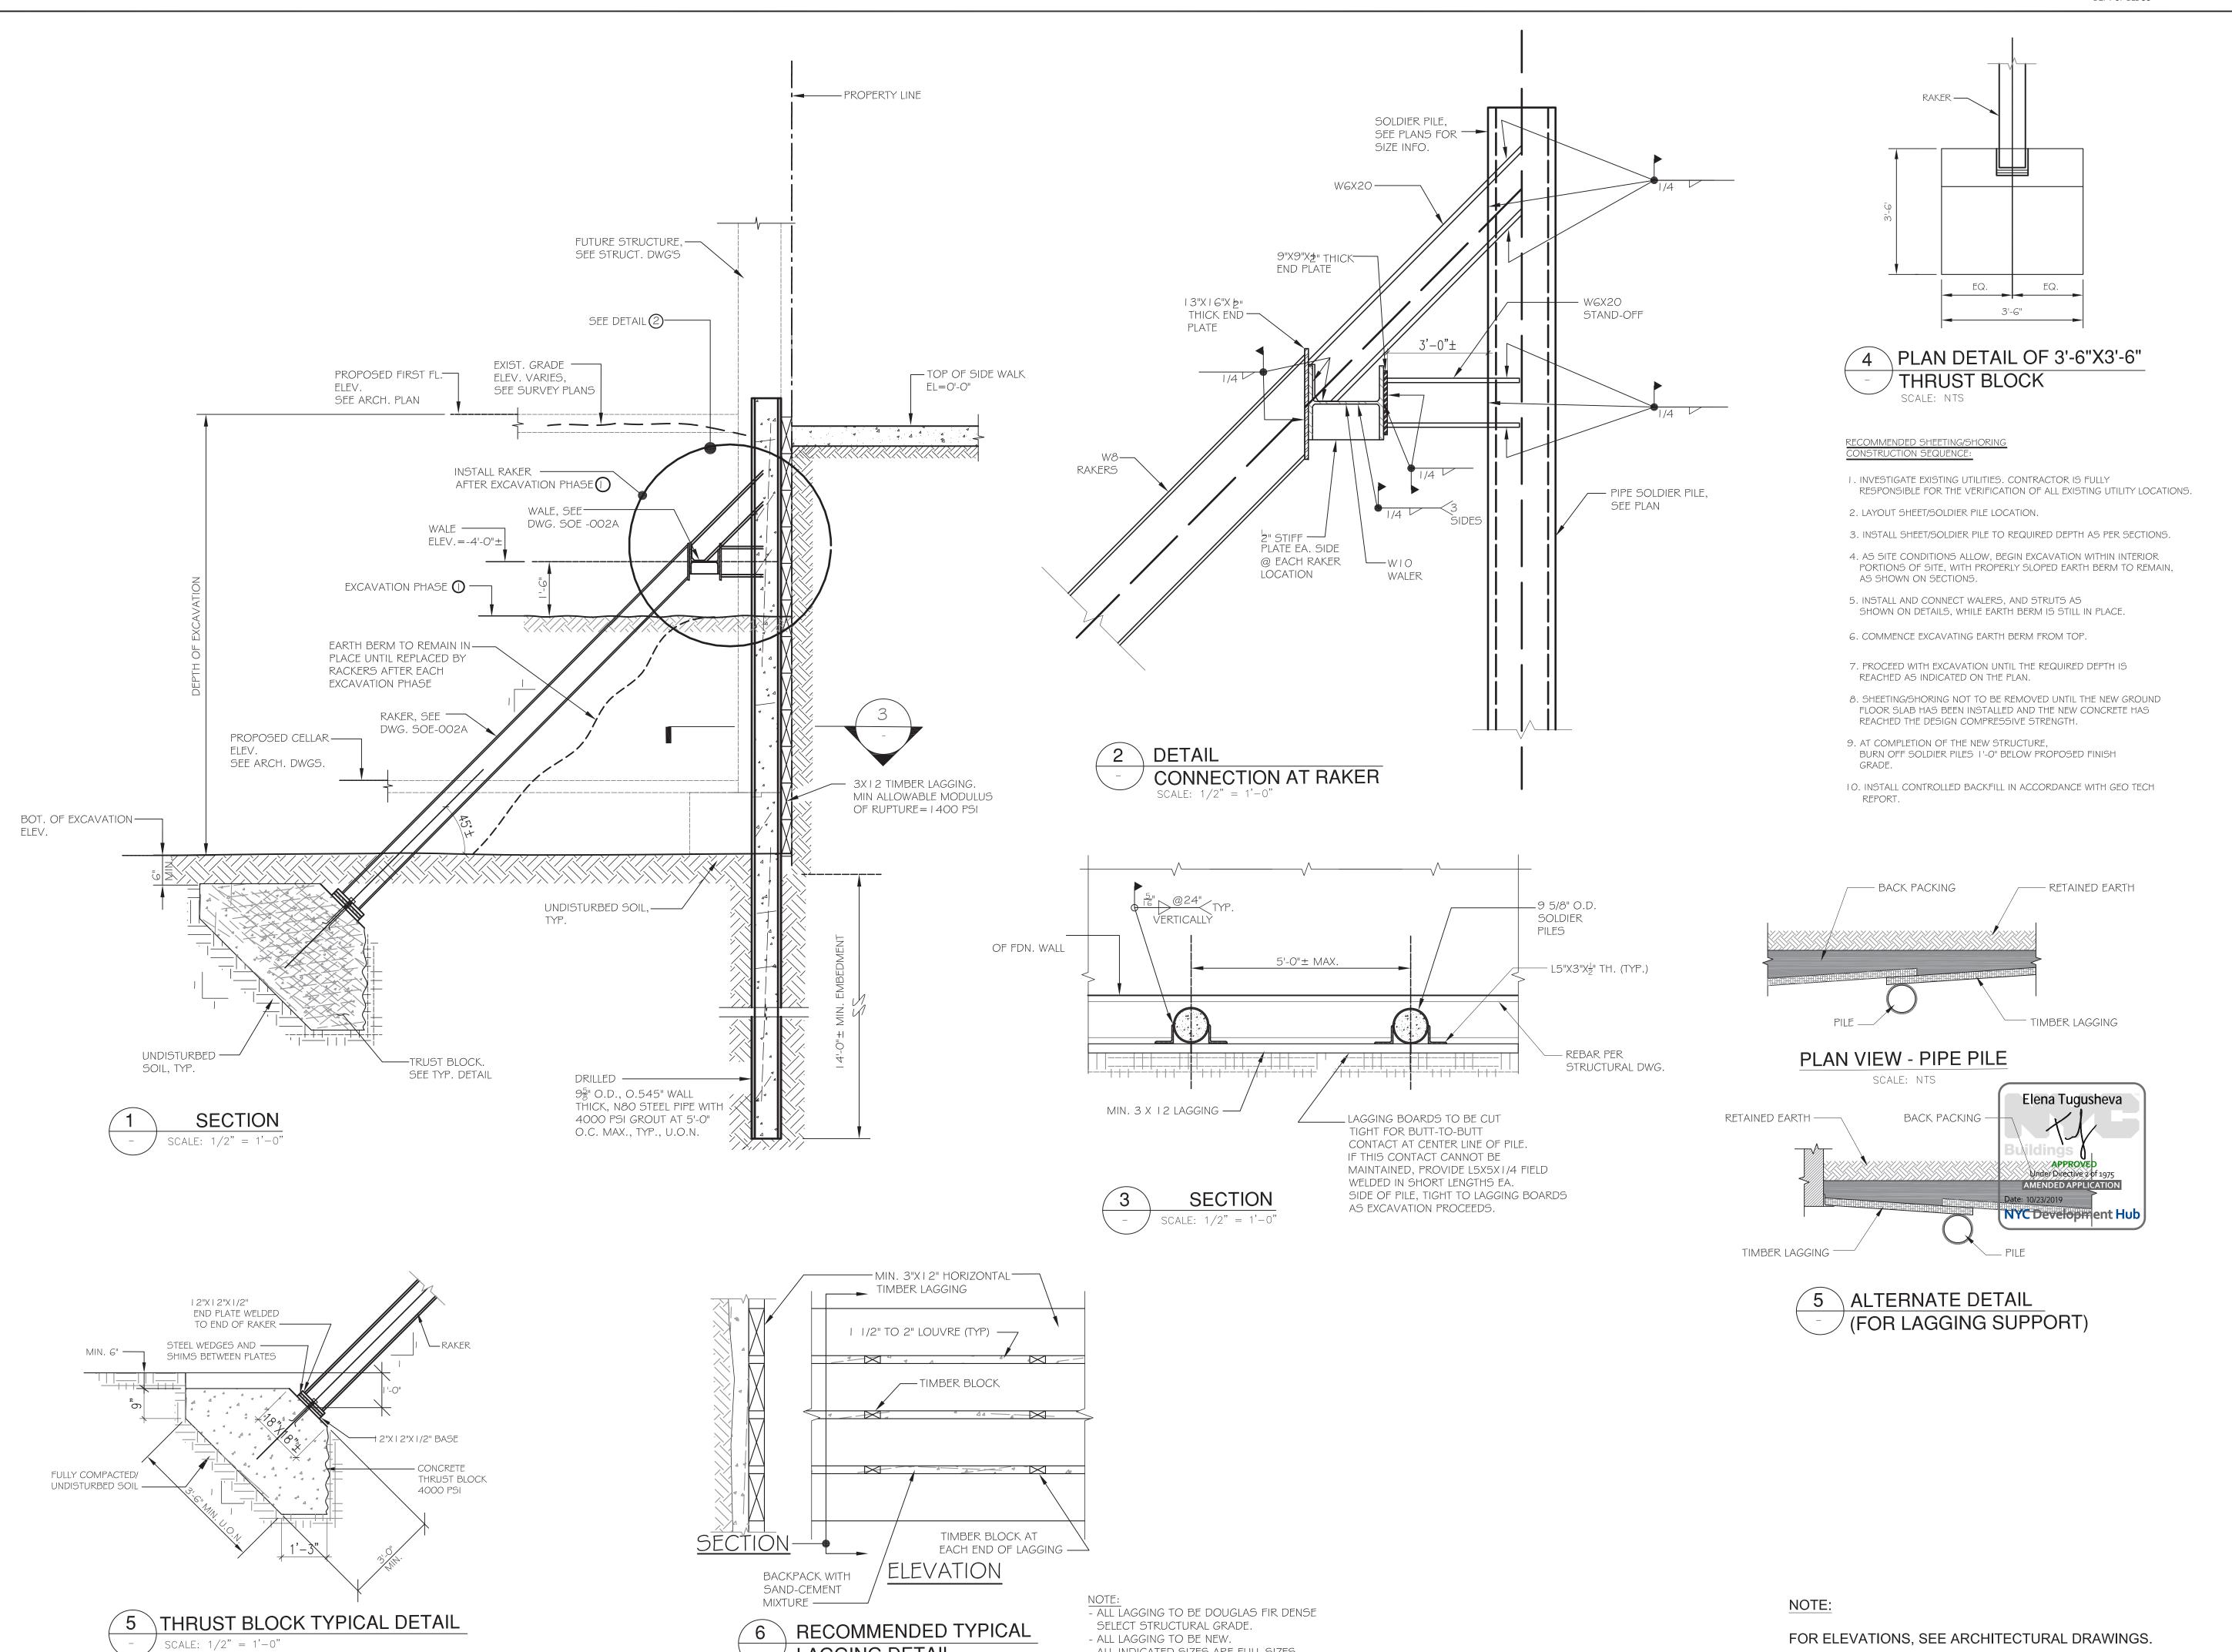LAGGING DETAIL

CONSULTANT

ARCHITECTURE & ENGINEERING GROUP 66 BRUNSWICK WOODS DRIVE, EAST BRUNSWICK, NJ 08816 1441 BROADWAY, 6TH FLOOR, SUITE 6093, NEW YORK, NY 10018

YOUSUF H. TAI, P.E. (LIC # 064032)

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# **ALTERNATE - 1**

**REVISIONS** 

DESCRIPTION NO. DATE

SEAL & SIGNATURE



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LOCATION:

491 OCEAN PARKWAY BROOKLYN, NY 11218

DRAWING TITLE:

**SECTIONS & DETAILS** 

DATE: 05-04- 2019 PROJECT NO. 2017-20

DRAWN BY: AQEEL CHECKED BY: YT

DRAWING NO:

SOE-003A.00

SHEET NO: