


Review Item Indicate the proposed opening date of the food service facility. The pre-opening inspection must be	Comment
scheduled two weeks prior to your expected opening date. Provide a menu of all food items to be prepared and served at the facility.	Summer 2021 Revised menu is attached
Provide the name, address and daytime telephone number of the contact person responsible for the Hazard Analysis Critical Control Point (HACCP) plan review. The Department of Health will schedule a HACCP plan review to evaluate and document the food processes including receiving, storing, thawing and preparing of food and the critical control points of the food service facility operation. The HACCP plan must provide steps to prevent cross contamination of raw foods from ready to eat foods.	Amanda Smith Hyatt & Weber, P.A. 200 Westgate Circle Suite 500 Annapolis, MD 21401 410.260.6589
Provide an equipment schedule showing the manufacturer name and model number of all food service equipment. Provide cut sheets including the manufacturer name, model number and item number of all food service equipment. All food service equipment must meet one or more of the following design standards: National Sanitation Foundation (NSF) or an NSF-equivalent certification from: the Etlsemko division of Intertek Group PLC (Intertek ETL SEMKO); Canadian Standards Association (CSA); Underwriters Laboratories (UL); Baking Industry Sanitation Standards Committee; National Automation Merchandizing Association; or International Association of Milk and Food Sanitarian's 3-A Sanitary Standards.  Indicate the type of thermometers that will be provided. Thermometers are required in all refrigeration, freezer and hot storage equipment used for potentially hazardous foods. Thermometers must be accurate, easily readable, in proper working condition, calibrated and graduated in plus or minus 2 degrees Fahrenheit.	The equipment schedule is provided on sheet A102. Cut sheets for all equipment have been submitted with the permi drawings in a separate binder.  Digital hanging thermometers
Indicate the type of ceiling materials that will be used throughout the food service facility. Ceiling materials in food preparation, utensil washing areas, bars and beverage stations must have a smooth, easily cleanable surface, may not contain fiberglass backing and must be non-perforated. Exposed construction, such as exposed floor and ceiling rafters, trusses or beams, utility ducts and lighting must be limited to dry food storage areas or dining areas. Provide cut sheets of the proposed ACT tiles reflecting that the stated requirements will be met.	All ceilings are existing painted gypsum board.
Describe the activity at the front counter. Indicate how food will be protected from contamination.	Drink Prep area, and carry out orders. All food prep will be limited to the back counter per the original operation.
Indicate how hand sinks will be separated from food service equipment, food preparation areas, or ware washing areas or provided with splash guards to protect food from contamination.	Existing hand sinks and new are to be fitted with integral splash guards on both sides.
Confirm that all waste lines for three compartment sinks, dishwashing machines, food prep sinks, hand sinks, food preparation tables or counters containing sinks, steam tables, condensate lines, steam kettles, ice machines, drink stations, beverage dispensers, dipper wells, and similar types of equipment in which food, utensils, or food portable equipment must be designed as an individual waste line; may not be manifold or interconnected; and may not be directly connected to the drainage system. Each waste pipe must discharge into an open floor sink (12 inch x 12 inch) that is flush with the floor; accessible for cleaning and inspection; properly trapped, vented and provided with a one-inch air gap.  THESE REQUIREMENTS ARE IN ADDITION TO THE GENERAL PLUMBING REQUIREMENTS OF THE ANNE ARUNDEL COUNTY PLUMBING CODE.	All waste lines for three compartment sinks, dishwashing machines, food prep sinks, hand sinks, food preparation tables or counters containing sinks, steam tables, condensate lines, steam kettles, ice machines, drink stations, beverage dispensers, dipper wells, and similar types of equipment in which food, utensils, or food portable equipment will be designed as an individual waste line; will not be manifold or interconnected; and will not be directly connected to the drainage system. Each waste pipe must discharge into an open floor sink (12 inch x 12 inch) that is flush with the floor; accessible for cleaning and inspection; properly trapped, vented and provided with a one-inch air gap.
Indicate the design of the three compartment sink. The three compartment sink must have two integral drain boards.	See item E13 on the equipment schedule. The existing 3 compartment sink has been in use in the existing kitchen since the original build-out.
	The three compartment sink will NOT be used for other tasks and will NOT be equipped with an automatic chemical dispenser.
Indicate that all floor sinks and waste receptacles under case work will be placed at the leading edge of the food service equipment and will be accessible for cleaning and inspection.	All floor sinks and waste receptacles under case work will be placed at the leading edge of the food service equipment, and will remain accessible for cleaning and inspection.
	All indirect waste to be extended to floor drains as indicated on sheet P003. All food service equipment that is directly connected to the potable water supply system is equipped with a backflow prevention device. Backflow prevention devices on existing hose bibs are exising to remain.
Indicate how toxic chemicals, cleaners and poisonous materials will be stored. Toxic and poisonous materials must be maintained separately from food storage, food preparation, food equipment, utensil washing and utensil storage to prevent contamination of food and food equipment or from posing a hazard to employees or customers. Toxic and poisonous materials must be prominently and distinctly marked or labeled for identification purposes.	Chemicals will be stored on wire shelving in the 2nd Floor Janitor Closet.
Show how restroom facilities will be completely enclosed, will not open directly into the kitchen or food preparation areas and equipped with ventilation fans to exhaust air to the outside at a minimum of 2cfm. Restroom doors must be equipped with self-closing devices.	Restroom facilities will be completely enclosed, will not open directly into the kitchen or food preparation areas and are equipped with ventilation fans to exhaust air to the outside at a minimum of 2cfm. Restroom doors will be equipped with self-closing devices. See Floor Plan and door schedule on Sheets A100 and G101 and sheet E003.
	Counters will be open on the business sides with shelves for storing to go boxes and bags. All counters and cabinets will be, a. elevated on 6 inch legs, b. open on the business side, c. on casters, or d. completely sealed to 1/32 inches. There will be no sewage drains beneath counters and cabinets.  Employees' belongings will be stored in lockers. See 2/A102
for the orderly storage of employees' clothing and personal belongings.  Indicate how exterior doors, windows and other openings will be constructed. Exterior doors must be tight fitting and equipped with self-closing devices to prevent the entrance of insects and rodents.  Openings into the building must be protected against the entrance of insects and rodents. Screening on windows, doors, skylights, transoms and other openings must be tight-fitting, in good repair and made of material that is of less than 16-mesh to the inch or equivalent.	Equipment Plan.  See plan and door schedule sheets A100 and G101. Exterior doors will be tight fitting and equipped with self-closing devices to prevent the entrance of insects and rodents.  Openings to the building will be protected against the entrance of insects and rodents. Screening on windows, doors, skylights, transoms and other openings will be tight fitting, in good repair and made of material that is less than 16-mesh to the inch or equivalent.
Indicate the materials that will be used in trash and grease storage areas and dumpster areas. Trash and grease storage areas used for trash containers, grease barrels and dumpsters must be located on a grease-resistant, durable surface such as sealed asphalt or a sealed concrete pad.	This is an existing restaurant that has an approved method for trash and grease disposal by the City of Annapolis and the Health Department.
Indicate how lighting will be shielded in food preparation, food storage, food service and utensil/dishwashing areas. All lighting must be shielded, rough-skin coated or shatterproof to protect food from contamination. This includes track and recess lights.	Light fixtures in food prep areas will be shatterproof and gasketed.
Indicate the amount of lighting that will be provided inside of the food service facility. A minimum of 50 foot-candles must be provided on all work surfaces, in food processing/food preparation areas; 20 foot-candles in walk-in refrigerators and freezer units, ware washing bar and storage areas at 30 inches above the floor surface and 20 foot-candles in restrooms, locker rooms and garbage storage areas.	Lighting levels will be a minimum of 50 foot-candles on all work surfaces, in food processing/food preparation areas; 20 foot -candles in walk-in refrigerators and freezer units, ware washing bar and storage areas at 30 inches above the floor surface and 20 foot-candles in restrooms.
Indicate how food will be stored. Containers are required for the storage of all food items such as bulk bins or food storage containers and made of a food contact material. Containers of food and exposed food must be elevated to a height of 18 inches or higher above floor surfaces. The bottom shelf of a shelving unit intended for storing open foods or utensils must be at least 18 inches from the floor. Metal beverage containers, cased food packaged in cans, glass or other waterproof containers are exempt from this requirement.	All food will be stored in NSF- approved containers. Food requiring refridgeration will be stored in either the walk in cooler, or in the under counter refrigerators. Food stored in the walk in cooler will be stored in NSF approved containers on NSF approved wire shelving units. Frozed foods will be stored in the freezer in NSF- approved containers.
Indicate the type of materials proposed for all food preparation and food contact surfaces. Food preparation and food contact surfaces must be non-porous, non-absorbent, non-toxic and constructed of a food contact approved material such as stainless steel.	Stainless Steel or other NSF-approved solid surface will be used for all food preperation and food contact surfaces.
of a food contact approved material such as stainless steel. Indicate the type of shelving that will be provided in the walk-in refrigeration and freezer units and in storage areas.	Stainless Steel Wire racks – see Equipment Plan, sheet A102
Indicate how stationary food equipment will be installed to allow ease of cleaning on all sides. Stationary food equipment including walk-in coolers, proofers, rack ovens, floor mixers and floor mounted equipment must have sufficient space to allow for cleaning or must be sealed with an acceptable sealant such as caulk or flashing to the wall, floor and other food service equipment surfaces to a gap no greater than 1/32 of an inch. Counter or tabletop equipment that weighs greater than 80 pounds must be sealed in place or placed on 4 inch legs to facilitate cleaning. All custom millwork must be sealed to 1/32 of an inch.	Stationary food equipment will be installed to allow ease of cleaning on all sides. Stationary food equipment including walk-in coolers, proofers, rack ovens, floor mixers and floor mounted equipment will have sufficient space to allow for cleaning or must be sealed with an acceptable sealant such as caulk or flashing to the wall, floor and other food service equipment surfaces to a gap no greater than 1/32 of an inch. Counter or tabletop equipment that weighs greater than 80 pounds will be sealed in place or placed on 4 inch legs to facilitate cleaning. All custom millwork will be sealed to 1/32

YPE 1ARK	ITEM	MIDTH	LENGTH	HEIGHT	MODEL NUMBER	MANUFACTURER	COMMENTS
1 10	Burner Stove Southbeend	60 3/4"	34"	36"	S60DD7N	Southbend	
2 COI	untertop Commercial Gas Griddle	24"	24"	15 1/2"	TMGM24	Toastmaster	
	s Floor Fryer	15 5/8"	27 1/2"	47 1/2"	SLG40	ANETS	
4 Ref	Frigerated Prep Table	67"	30 1/2"	36"	USPV-67	US Refrigeration	
5 Nat	tural Gas Pizza Oven	66"	43"	55 1/4"	451	Bakers Pride	
7 Two	o Section Reach-In Freezer	39 1/2"	29 1/2"	78 3/8"	T-35F-HC	True	
3 Rea	ach-In Refrigerator	27 1/2"	30"	75 1/4"	XS-10-HC-US	Fogel	
9 Elec	ctric Water Bath Steam Table	48"	22"	34"	MT3-208	Eagle	
10 Sar	ndwich Prep Table	48"	27"		SPE48HC	Beverage Air	
11 Han	nd Sink	12"	17"		H5-30L	Krowne	SPLASH GUARDS ARE TO BE ADDED
12 Flo	or Mixer	23"	30 1/4"	49 7/8"	Legacy HL400	Hobart	
13 3 0	Compartment Sink 72x21	59"	27 1/2"				EXISTING TO REMAIN
14 Ice	Machine 22x32	22"	32"		KM-515M_J	Hoshizaki	
15 Dir	ty Dish Table	48"	30"	36"			EXISTING TO REMAIN
6 Cle	an Dish Table	48"	30"	36"			EXISTING TO REMAIN
17 Dis	hwasher Machine	25"	25"		LT-1	Hobart	
8 Und	lercounter Refrigerator 72x24	72"	24"	36"	USRBB-24-72G	US Refrigeration	
	lercounter Refrigerator 60x24	60"	24"	36"	USRBB-24-60G	US Refrigeration	
20 Exis	sting Mop Sink	22"	26"				EXISTING TO REMAIN
21 Min	e Refrigerator	17"	20 1/2"	32 1/2"	HVMC285T	∨issani	
22 Gri	iddle Stand Mith Casters	24"	24"	24"	USES-2430-418	US Sainlessteal	
23 Flo	or Sink						
24 Han	nd Sink 15×17	17"	15"				SPLASH GUARDS ARE TO BE ADDED
25 Exis	sting Hood 7x5	84"	60"				EXISTING TO REMAIN
	sting Hood 63"x10"	120"	63"				EXISTING TO REMAIN
	sting H00d 35"x35"	30"	30"				EXISTING TO REMAIN
	ease Recovery Unit	48"	14"				EXISTING TO REMAIN
	ple 30x36	36"	30"	36"	600T5530365	Regency	
30 Mir	e Shelving 24"x54"	54"	24"	36"	460EG2454KIT	Regency	
	e Shelving 24"x60"	60"	24"	36"	460EG2460KIT	Regency	
~ \	gel Refrigerator	21"	21 1/2"		XS-10-HC-US	Fogel	
	ker's Pride Oven	26"	28"		DP-2	Baker's Pride	
	pplay Case	47 1/2"	32"		USDC-48	Admiral Craft	
<del></del>	pdgett Oven	28"	24"		1415	Blodaett	
7	ke Refrigerator	29 1/2"	26"			<b>J</b>	
	rk Table 48x14	48"	14"	36"	SG1448	KITCHENALL	

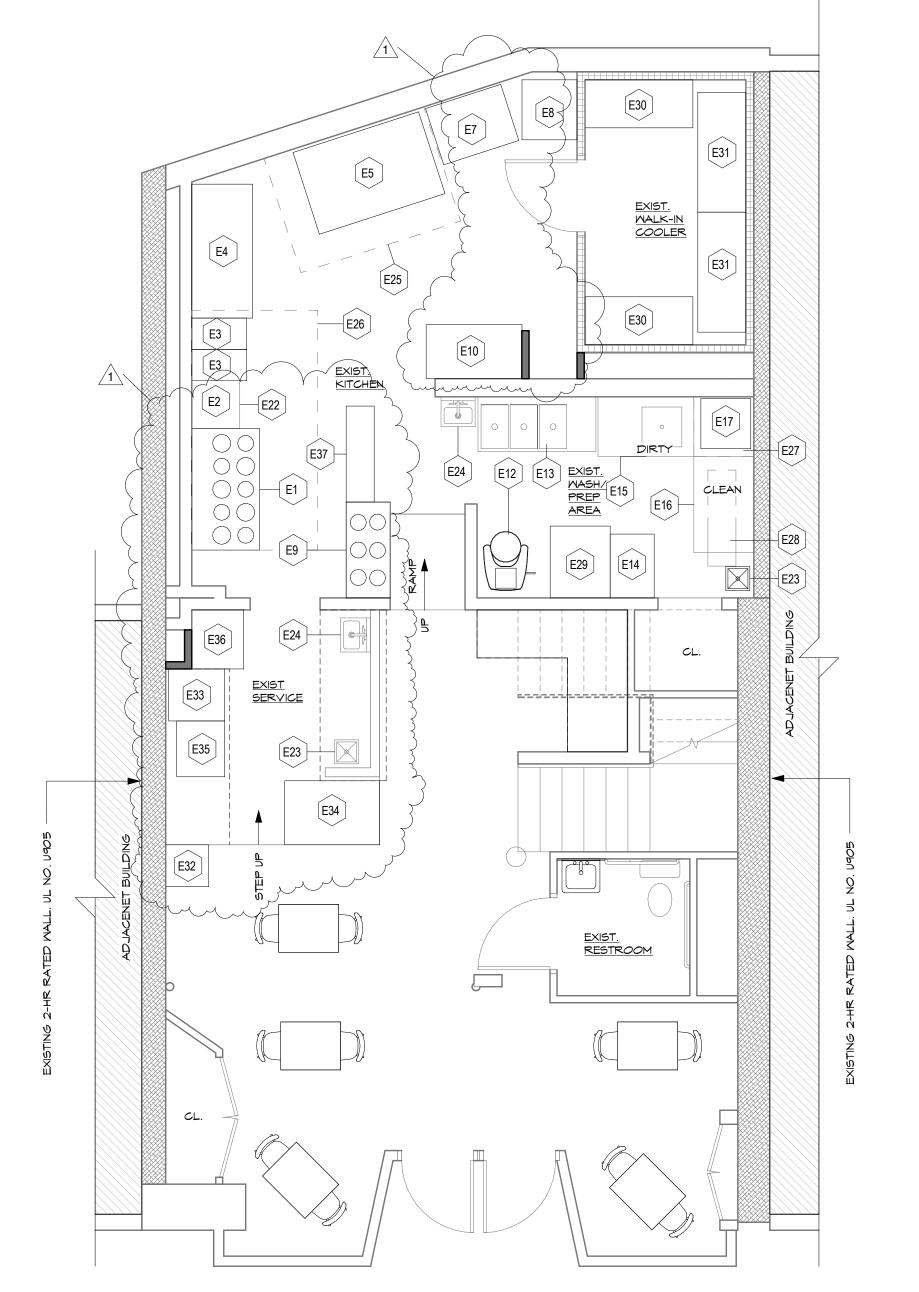

MALL KEY

NOTES: ALL NEW WALLS ARE 3 5/8" (3-5/8" MTL STUDS @ 16" O.C.) UNLESS NOTED OTHERWISE.

WALLS ARE TO BE INSTALLED PARALELL/PERPENDICULAR TO EXISTING ADJACENT COLUMNS OR WALLS U.N.O.

EXISTING 2 HOUR RATED WALL, UL NO U905

NEM MOOD STUD WALL. THICKNESS AND STUD SPACING VARIES. SEE WALL TYPES FOR DIMENSION.

EXISTING WALLS TO REMAIN

EXISTING WALK-IN COOLER WALL

THE DRAWING BOARD,
A R C H I T E C T U

Professional Certification.


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DRAWN BY: Author

REVISIONS: 1 07/02/2021

A102


that I am a duly licensed architect under the laws of the State of Maryland.
LICENSE NUMBER: 5955, expiration date: 04-29-2022

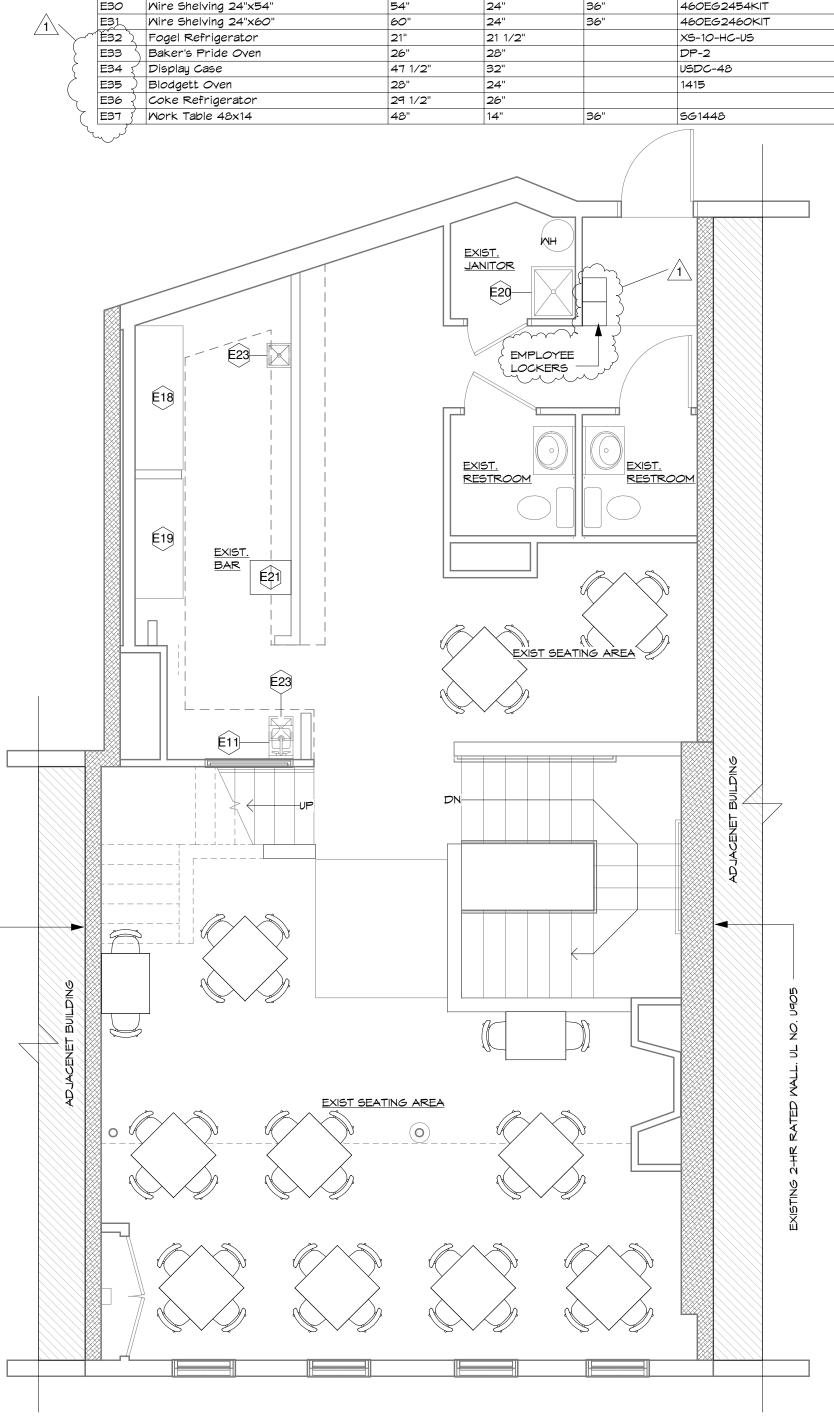


PROPOSED EQUIPMENT SECOND FLOOR EL

1/4" = 1'-0"

1) PROPOSED EQUIPMENT FIRST FLOOR PLAN
1/4" = 1'-0"

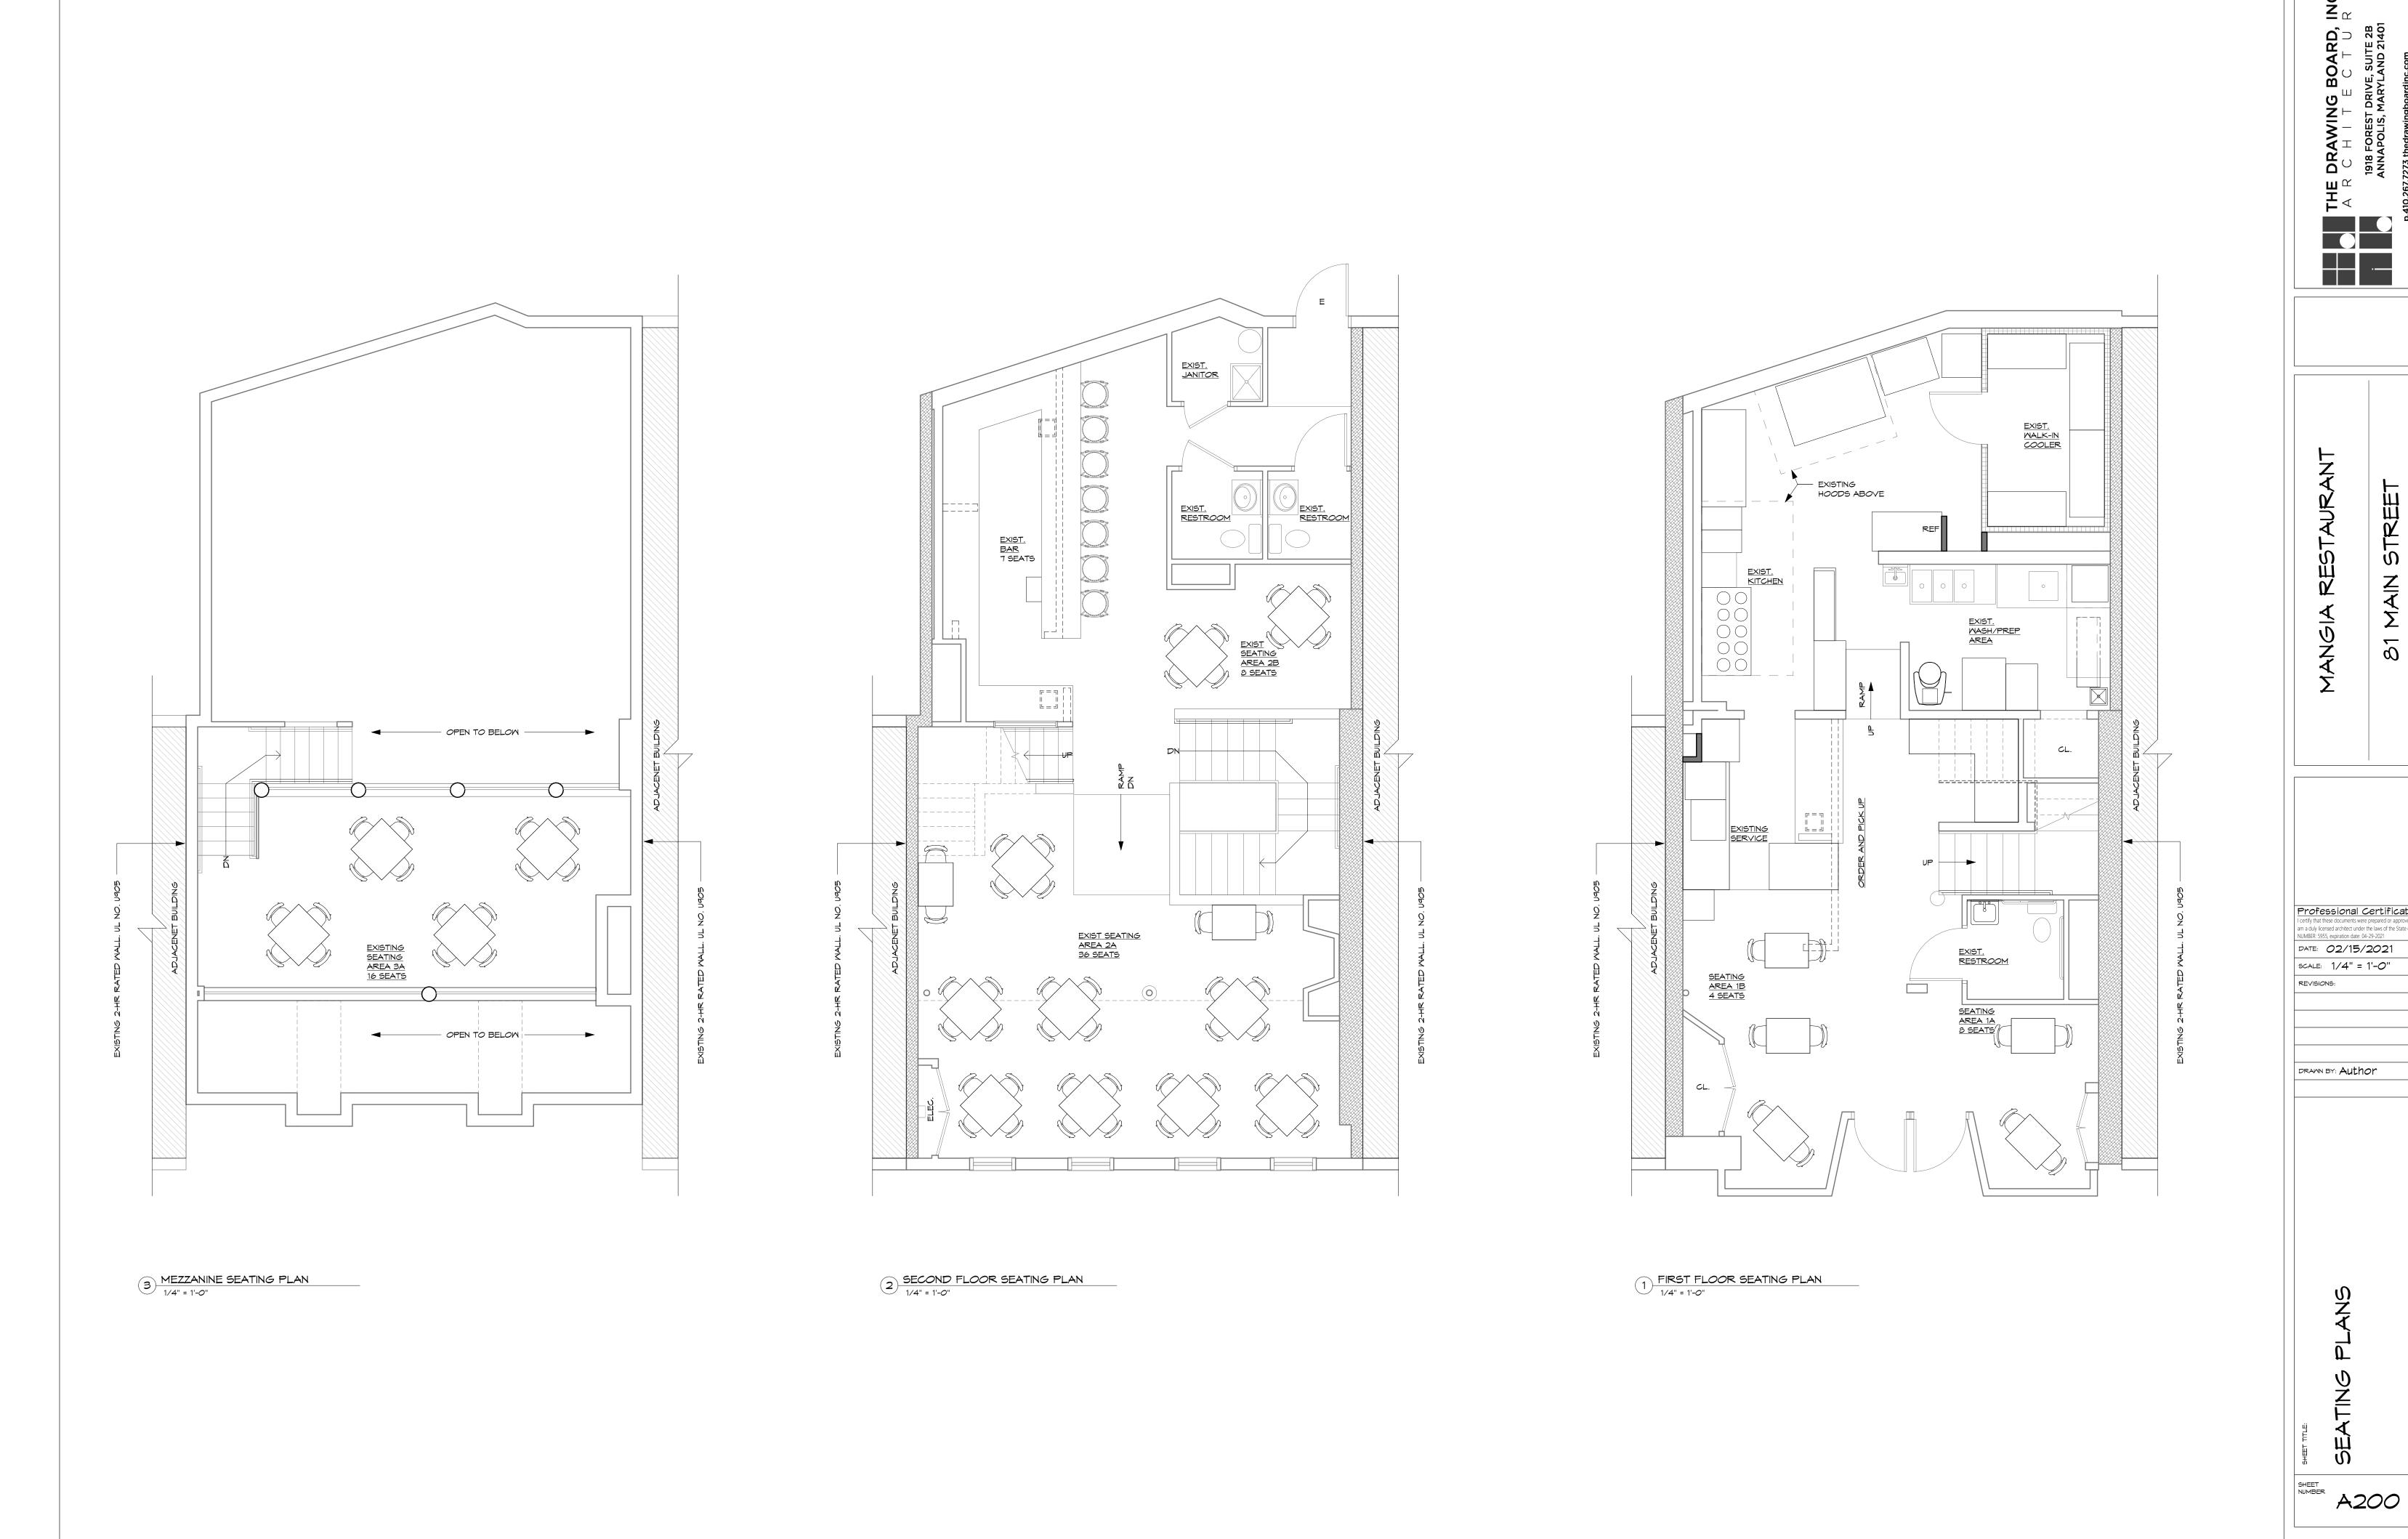

Professional Certification. am a duly licensed architect under the laws of the State of Maryland. LICENSE NUMBER: 5955, expiration date: 04-29-2021 DATE: 02/15/2021 SCALE: 1/4" = 1'-0" DRAWN BY: Author

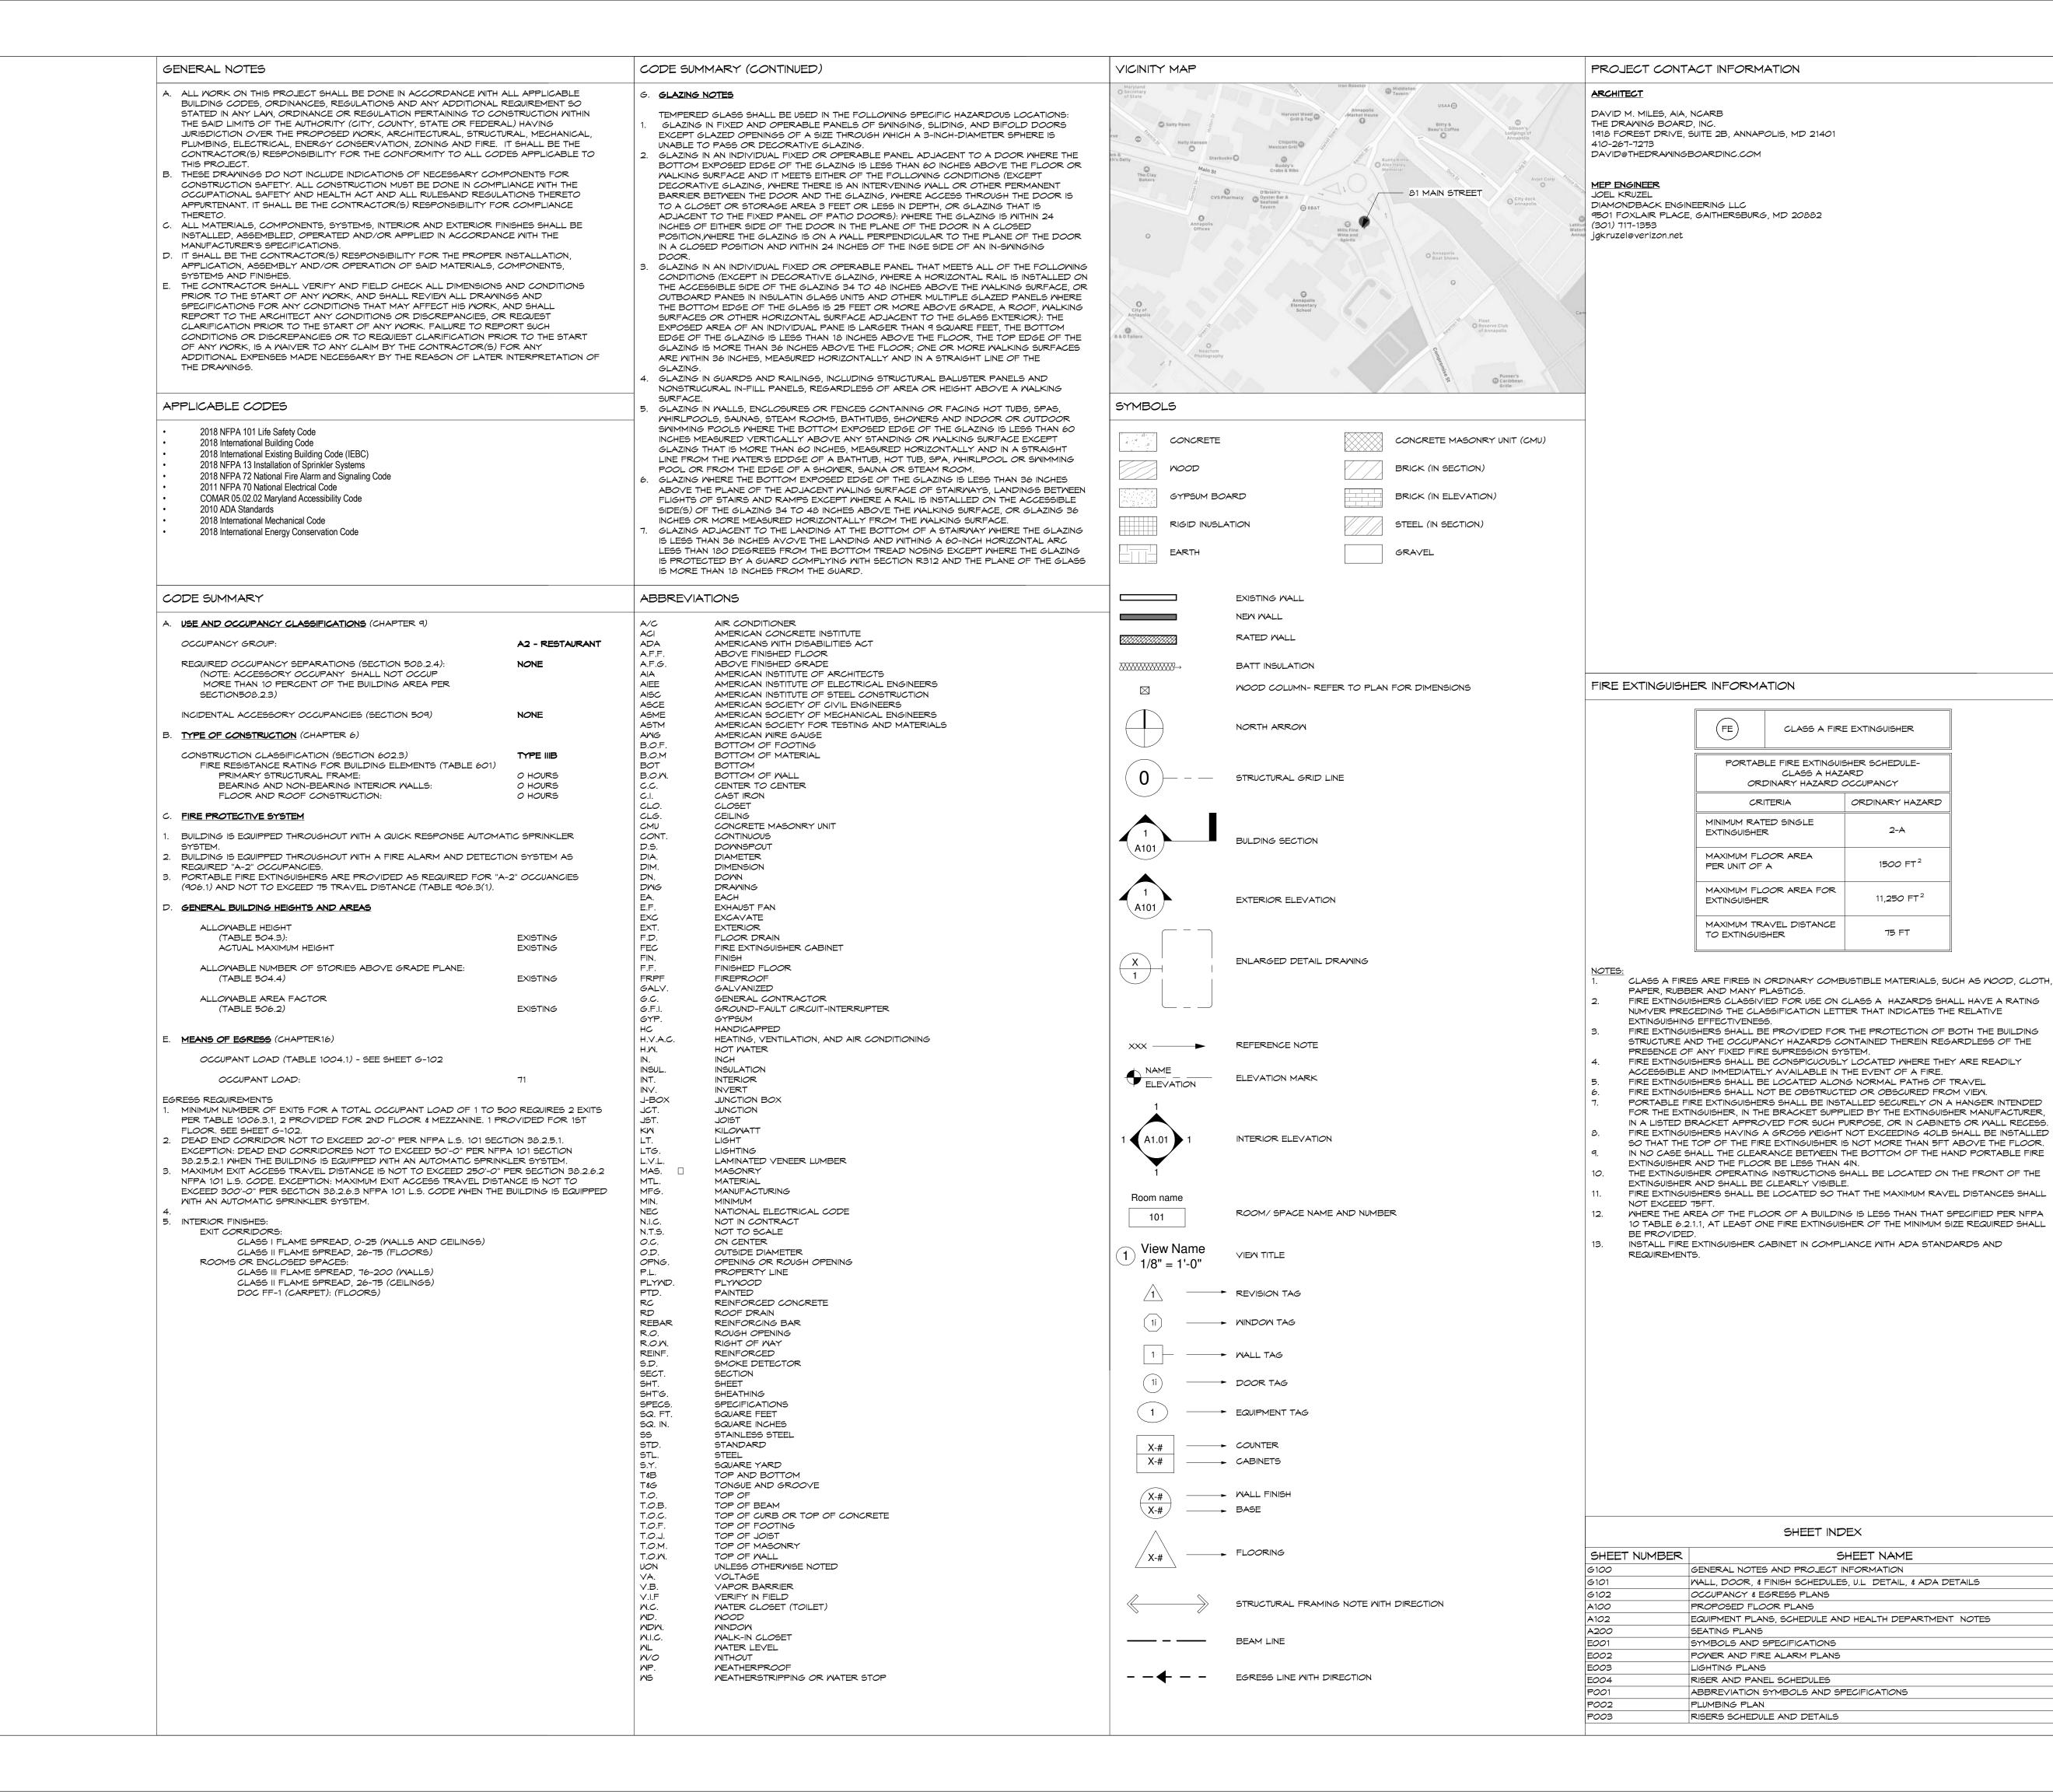

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<u>Professional Certification.</u>

ICENSE NUMBER: 5955, expiration date: 04-29-2022


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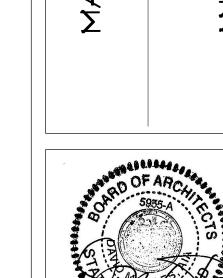
DRAWN BY: Author

G100

that I am a duly licensed architect under the laws of the State of Maryland



SKST_RESTROOM   Painted GWB, Ceramic Tile   Existing GWB   Ceramic Tile   Ceram	tory	Room Name	WALLS	CEILING	FLOOR	BASE
SKST_RESTROOM   Painted GWB, Ceramic Tile   Existing GWB   Ceramic Tile   Ceram	1st Floor	SEATING AREA 1A	Existing - Storefront, Ceramic Tile, & GWB	Existing GWB	Ceramic Tile	Ceramic Tile
Internation   MISTING SERVICE   Ceramic Tile   FRP Panels   Existing GWB   Ceramic Tile   Vinyl cove	1st Floor	SEATING AREA 1B	Existing - Storefront, Ceramic Tile, & GWB	Existing GWB	Ceramic Tile	Ceramic Tile
1st Floor   MIST. WASH/PREP RAEA   Caramic Tile (Note 6)   Existing GWB   Caramic Tile   Caram	1st Floor	EXIST. RESTROOM	Painted GWB, Ceramic Tile	Existing GWB	Ceramic Tile	Ceramic Tile
154 Floor   EXIST, KITCHEN   Caramic Tile (Note 6)   Existing GWB   Caramic Tile   Caramic Tile   MA	1st Floor	EXISTING SERVICE	Ceramic Tile, FRP Panels	Existing GWB	Ceramic Tile	Vinyl cove
List Floor   Exists WALLF-IN COLLER   N/A   Existing GWB   Ceramic Tile   N/A	1st Floor	EXIST. WASH/PREP AREA	Ceramic Tile (Note 6)	Existing GWB	Ceramic Tile	Ceramic Tile
Part	1st Floor	EXIST. KITCHEN	Ceramic Tile (Note 6)	Existing GWB	Ceramic Tile	Ceramic Tile
Zand Floor EXIST. SEATING AREA 2B Painted GWB Existing GWB Ceramic Tile (Note 6) & FRP PANELS (NOTE 1) Existing GWB Ceramic Tile (N	1st Floor	EXIST. WALK-IN COOLER	N/A	Existing GWB	Ceramic Tile	N/A
Zend Floor   EXIST. BAR   Caramic Tile   (Note 6) & FRP PANELS (NOTE 1)   Existing GWB   Ceramic Tile   Ceramic	2nd Floor	EXIST SEATING AREA 2A	Painted GWB	Existing GWB	Ceramic Tile	Wood
Caramic Tile   Existing GWB   Ceramic Tile   Vinyl cove	2nd Floor	EXIST SEATING AREA 2B	Painted GWB	Existing GWB	Ceramic Tile	Wood
2nd Floor   EXIST, RESTROOM   Ceramic Tile   Existing GWB   Ceramic Tile   Ceramic Tile   Vinyl cove    3rd Floor   EXIST, JANITOR   Ceramic Tile   Existing GWB   Ceramic Tile   Vinyl cove    3rd Floor   EXISTING SEATING AREA 3a   Existing - Painted GWB & Ceramic Tile   Existing GWB   Ceramic Tile   Wood    3rd Floor   EXISTING SEATING AREA 3a   Existing - Painted GWB & Ceramic Tile   Existing GWB   Ceramic Tile   Wood    3rd Floor   EXISTING SEATING AREA 3a   Existing - Painted GWB & Ceramic Tile   Existing GWB   Ceramic Tile   Wood    3rd Floor   EXISTING SEATING AREA 3a   Existing - Painted GWB & Ceramic Tile   Existing GWB   Ceramic Tile   Wood    3rd Floor   EXISTING SEATING AREA 3a   Existing - Painted GWB & Ceramic Tile   Existing GWB    3rd Floor   Existing GWB   Ceramic Tile   Wood    4rd Floor RWST, STAND AREA 3a   Existing - Painted GWB & Ceramic Tile   Wood    4rd Floor RWST, STAND AREA 3a   Existing - Painted GWB & Ceramic Tile   Wood    4rd Floor RWST, STAND AREA 3a   Existing - Painted GWB & Ceramic Tile   Wood    4rd Floor RWST, STAND AREA 3a   Existing Floor RWST, STAND AREA 3a   Existing GWB    5rd Floor RWST, STAND AREA 3a   Existing Floor RWST, STAND AREA 3	2nd Floor	EXIST. BAR	Ceramic Tile (Note 6) & FRP PANELS (NOTE 1)	Existing GWB	Ceramic Tile	Vinyl cove
2nd Floor   Existing SEATING AREA 3A   Existing - Painted GWB & Ceramic Tile   Existing GWB   Ceramic Tile   Wood    8dBREVIATIONS:  **RP = FIBERGLASS REINFORCED PLASTIC   GWB = GYPSUM WALL BOARD   GWB = GW	2nd Floor	EXIST. RESTROOM	Ceramic Tile	Existing GWB	Ceramic Tile	Ceramic Tile
Ard Floor EXISTING SEATING AREA 3A Existing - Painted GWB & Ceramic Tile Existing GWB Ceramic Tile Wood  ABBREVIATIONS:  IRP = FIBERGLASS REINFORCED PLASTIC GWB = GYPSUM WALL BOARD  IL FRP PANELS ARE TO BE PLACED IN MITCHEN WORK AREAS AND BEHIND ALL SINKS, INCLUDING MOP SINK AND WORK TABLES. FRP PANELS ARE TO BE INSTALLED AT FOOD PREP SIDE WALLS, UNDERBAR, AND COUNTER. *SPEC: MARLITE, S'  FRP, SMOOTH SURFACE, S 490N LIGHT GREY  THE FLOOR AND WALL JUNCTURE IN THE KITCHEN AND RESTROOMS IS TO BE COVED.  AND THE FLOOR AND WALL JUNCTURE IN THE KITCHEN AND RESTROOMS IS TO BE COVED.  AND THE FLOOR AND WALL JUNCTURE OF THE FOOD PREP, UTENSIL WASHING, AND STORAGE AREAS ARE TO BE SHATTERPROOF.  AND WALK-IN COOLERS ARE TO BE SEALED TO WALLS TO 1/32".  THE IS TO BE COMMERCIAL-GRADE, NSF APPROVED SMOOTH FINISH PORCELAIN. VERIFY COLOR WITH OWNER.  EXIT CORRIDORS:  CLASS B FLAME SPREAD, 26-75 (WALLS & CEILINGS)  ROOMS OR ENCLOSED SPACES:	2nd Floor	EXIST. RESTROOM	Ceramic Tile	Existing GWB	Ceramic Tile	Ceramic Tile
ABBREVIATIONS:  RRP = FIBERGLASS REINFORCED PLASTIC  GWB = GYPSUM WALL BOARD  NOTES:  L. FRP PANELS ARE TO BE PLACED IN KITCHEN WORK AREAS AND BEHIND ALL SINKS, INCLUDING MOP SINK AND WORK TABLES. FRP PANELS ARE TO BE INSTALLED AT FOOD PREP SIDE WALLS, UNDERBAR, AND COUNTER. *SPEC: MARLITE, S' FRP, SMOOTH SURFACE, S 490N LIGHT GREY  2. THE FLOOR AND WALL JUNCTURE IN THE KITCHEN AND RESTROOMS IS TO BE COVED.  3. Not Used.  4. LIGHT FIXTURES OVER THE FOOD PREP, UTENSIL WASHING, AND STORAGE AREAS ARE TO BE SHATTERPROOF.  5. WALK-IN COOLERS ARE TO BE SEALED TO WALLS TO 1/32".  5. TILE IS TO BE COMMERCIAL-GRADE, NSF APPROVED SMOOTH FINISH PORCELAIN. VERIFY COLOR WITH OWNER.  EXIT CORRIDORS:  CLASS B FLAME SPREAD, 26-75 (WALLS & CEILINGS)  CLASS B FLAME SPREAD, 0-25 (WALLS & CEILINGS)  CLASS B FLAME SPREAD, 26-75 (WALLS & CEILINGS)  ROOMS OR ENCLOSED SPACES:	2nd Floor	EXIST. JANITOR	Ceramic Tile	Existing GWB	Ceramic Tile	Vinyl cove
RP = FIBERGLASS REINFORCED PLASTIC			Existing - Painted GWB & Ceramic Tile	Existing GWB	Ceramic Tile	Wood
NOTES:  L. FRP PANELS ARE TO BE PLACED IN KITCHEN WORK AREAS AND BEHIND ALL SINKS, INCLUDING MOP SINK AND WORK TABLES. FRP PANELS ARE TO BE INSTALLED AT FOOD PREP SIDE WALLS, UNDERBAR, AND COUNTER. *SPEC: MARLITE, S' FRP, SMOOTH SURFACE, S 490N LIGHT GREY  2. THE FLOOR AND WALL JUNCTURE IN THE KITCHEN AND RESTROOMS IS TO BE COVED.  3. Not Used.  1. LIGHT FIXTURES OVER THE FOOD PREP, UTENSIL WASHING, AND STORAGE AREAS ARE TO BE SHATTERPROOF.  5. WALK-IN COOLERS ARE TO BE SEALED TO WALLS TO 1/32".  6. TILE IS TO BE COMMERCIAL-GRADE, NSF APPROVED SMOOTH FINISH PORCELAIN. VERIFY COLOR WITH OWNER.    EXIT CORRIDORS:			1	GWB - GVBSLIM WALL BOARD		
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L. FRP PANELS ARE TO BE PLACED IN KITCHEN WORK AREAS AND BEHIND ALL SINKS, INCLUDING MOP SINK AND WORK TABLES. FRP PANELS ARE TO BE INSTALLED AT FOOD PREP SIDE WALLS, UNDERBAR, AND COUNTER. *SPEC: MARLITE, S'-RP, SMOOTH SURFACE, S 490N LIGHT GREY  2. THE FLOOR AND WALL JUNCTURE IN THE KITCHEN AND RESTROOMS IS TO BE COVED.  3. Not Used.  4. LIGHT FIXTURES OVER THE FOOD PREP, UTENSIL WASHING, AND STORAGE AREAS ARE TO BE SHATTERPROOF.  5. WALK-IN COOLERS ARE TO BE SEALED TO WALLS TO 1/32".  5. TILE IS TO BE COMMERCIAL-GRADE, NSF APPROVED SMOOTH FINISH PORCELAIN. VERIFY COLOR WITH OWNER.  EXIT CORRIDORS:  CLASS B FLAME SPREAD, 26-75 (WALLS & CEILINGS)  CLASS B FLAME SPREAD, 0-25 (WALLS & CEILINGS)  CLASS B FLAME SPREAD, 0-25 (WALLS & CEILINGS)  ROOMS OR ENCLOSED SPACES:	IOTES:					
4. LIGHT FIXTURES OVER THE FOOD PREP, UTENSIL WASHING, AND STORAGE AREAS ARE TO BE SHATTERPROOF.  5. WALK-IN COOLERS ARE TO BE SEALED TO WALLS TO 1/32".  6. TILE IS TO BE COMMERCIAL-GRADE, NSF APPROVED SMOOTH FINISH PORCELAIN. VERIFY COLOR WITH OWNER.  EXIT CORRIDORS:  CLASS B FLAME SPREAD, 26-75 (WALLS & CEILINGS)  CLASS B FLAME SPREAD, 0-25 (WALLS & CEILINGS)  CLASS A FLAME SPREAD, 0-25 (WALLS & CEILINGS)  CLASS B FLAME SPREAD, 26-75 (WALLS & CEILINGS)  ROOMS OR ENCLOSED SPACES:		NELS ARE TO BE DIACED IN KITO	CHEN MODE ABEAS AND BEHIND ALL SINKS INCLLIE	NING MOD SINK AND WORK TARIES ERD DANELS AS	RE TO BE INSTALLED AT FOOD DRED SIG	DE WALLS LINDERRAR AND COLINTER *SDEC: MARLITE STANDA
5. WALK-IN COOLERS ARE TO BE SEALED TO WALLS TO 1/32".  5. TILE IS TO BE COMMERCIAL-GRADE, NSF APPROVED SMOOTH FINISH PORCELAIN. VERIFY COLOR WITH OWNER.  EXIT CORRIDORS:  CLASS B FLAME SPREAD, 26-75 (WALLS & CEILINGS)  CLASS B FLAME SPREAD, 26-75 (FLOORS)  CLASS A FLAME SPREAD, 0-25 (WALLS & CEILINGS)  CLASS B FLAME SPREAD, 26-75 (WALLS & CEILINGS)  CLASS B FLAME SPREAD, 26-75 (WALLS & CEILINGS)  ROOMS OR ENCLOSED SPACES:	FRP PAN RP, SMO	OTH SURFACE, S 490N LIGHT G	REY	 DING MOP SINK AND WORK TABLES. FRP PANELS AF	RE TO BE INSTALLED AT FOOD PREP SIE	E WALLS, UNDERBAR, AND COUNTER. *SPEC: MARLITE, STANDAI
5. TILE IS TO BE COMMERCIAL-GRADE, NSF APPROVED SMOOTH FINISH PORCELAIN. VERIFY COLOR WITH OWNER.  EXIT CORRIDORS:  CLASS B FLAME SPREAD, 26-75 (WALLS & CEILINGS)  CLASS B FLAME SPREAD, 26-75 (FLOORS)  CLASS A FLAME SPREAD, 0-25 (WALLS & CEILINGS)  CLASS B FLAME SPREAD, 26-75 (WALLS & CEILINGS)  CLASS B FLAME SPREAD, 26-75 (WALLS & CEILINGS)  ROOMS OR ENCLOSED SPACES:	FRP PAN RP, SMO THE FLC Not Use	OTH SURFACE, S 490N LIGHT G DOR AND WALL JUNCTURE IN T ed.	REY HE KITCHEN AND RESTROOMS IS TO BE COVED.		RE TO BE INSTALLED AT FOOD PREP SIE	E WALLS, UNDERBAR, AND COUNTER. *SPEC: MARLITE, STANDAI
EXIT CORRIDORS:  CLASS B FLAME SPREAD, 26-75 (WALLS & CEILINGS)  CLASS B FLAME SPREAD, 26-75 (FLOORS)  CLASS A FLAME SPREAD, 0-25 (WALLS & CEILINGS)  CLASS A FLAME SPREAD, 26-75 (WALLS & CEILINGS)  CLASS B FLAME SPREAD, 26-75 (WALLS & CEILINGS)  ROOMS OR ENCLOSED SPACES:	FRP PAN RP, SMOO THE FLC Not Use LIGHT F	OTH SURFACE, S 490N LIGHT G DOR AND WALL JUNCTURE IN T ed.  IXTURES OVER THE FOOD PREP	REY HE KITCHEN AND RESTROOMS IS TO BE COVED. P, UTENSIL WASHING, AND STORAGE AREAS ARE TO		RE TO BE INSTALLED AT FOOD PREP SIE	E WALLS, UNDERBAR, AND COUNTER. *SPEC: MARLITE, STANDAI
CLASS B FLAME SPREAD, 26-75 (WALLS & CEILINGS)  CLASS B FLAME SPREAD, 26-75 (FLOORS)  CLASS A FLAME SPREAD, 0-25 (WALLS & CEILINGS)  CLASS B FLAME SPREAD, 26-75 (WALLS & CEILINGS)  CLASS B FLAME SPREAD, 26-75 (WALLS & CEILINGS)  ROOMS OR ENCLOSED SPACES:	FRP PAN RP, SMO THE FLC Not Use LIGHT F	OTH SURFACE, S 490N LIGHT G  OOR AND WALL JUNCTURE IN T  ed.  EIXTURES OVER THE FOOD PREP N COOLERS ARE TO BE SEALED	REY HE KITCHEN AND RESTROOMS IS TO BE COVED.  P, UTENSIL WASHING, AND STORAGE AREAS ARE TO TO WALLS TO 1/32".	BE SHATTERPROOF.	RE TO BE INSTALLED AT FOOD PREP SIE	E WALLS, UNDERBAR, AND COUNTER. *SPEC: MARLITE, STANDAI
CLASS B FLAME SPREAD, 26-75 (FLOORS)  CLASS A FLAME SPREAD, 0-25 (WALLS & CEILINGS)  CLASS B FLAME SPREAD, 26-75 (WALLS & CEILINGS)  ROOMS OR ENCLOSED SPACES:	FRP PAN RP, SMO THE FLC Not Use LIGHT F	OTH SURFACE, S 490N LIGHT G  OOR AND WALL JUNCTURE IN T  ed.  EIXTURES OVER THE FOOD PREP N COOLERS ARE TO BE SEALED	REY HE KITCHEN AND RESTROOMS IS TO BE COVED.  P, UTENSIL WASHING, AND STORAGE AREAS ARE TO TO WALLS TO 1/32".  SF APPROVED SMOOTH FINISH PORCELAIN. VERIFY	BE SHATTERPROOF.	RE TO BE INSTALLED AT FOOD PREP SIE	DE WALLS, UNDERBAR, AND COUNTER. *SPEC: MARLITE, STANDAI
CLASS A FLAME SPREAD, 0-25 (WALLS & CEILINGS)  CLASS B FLAME SPREAD, 26-75 (WALLS & CEILINGS)  ROOMS OR ENCLOSED SPACES:	FRP PAN RP, SMO THE FLC Not Use LIGHT F	OTH SURFACE, S 490N LIGHT G  OOR AND WALL JUNCTURE IN T  ed.  EIXTURES OVER THE FOOD PREP N COOLERS ARE TO BE SEALED	REY HE KITCHEN AND RESTROOMS IS TO BE COVED.  P, UTENSIL WASHING, AND STORAGE AREAS ARE TO TO WALLS TO 1/32".  SF APPROVED SMOOTH FINISH PORCELAIN. VERIFY	BE SHATTERPROOF.  COLOR WITH OWNER.		DE WALLS, UNDERBAR, AND COUNTER. *SPEC: MARLITE, STANDAI
CLASS B FLAME SPREAD, 26-75 (WALLS & CEILINGS)  ROOMS OR ENCLOSED SPACES:	FRP PAN RP, SMO THE FLC Not Use LIGHT F	OTH SURFACE, S 490N LIGHT G  OOR AND WALL JUNCTURE IN T  ed.  EIXTURES OVER THE FOOD PREP N COOLERS ARE TO BE SEALED	REY HE KITCHEN AND RESTROOMS IS TO BE COVED.  P, UTENSIL WASHING, AND STORAGE AREAS ARE TO TO WALLS TO 1/32".  SF APPROVED SMOOTH FINISH PORCELAIN. VERIFY	DE SHATTERPROOF.  COLOR WITH OWNER.  CLASS B FLAME SPREAD, 26-75 (WALLS & CEILIN		DE WALLS, UNDERBAR, AND COUNTER. *SPEC: MARLITE, STANDAI
ROOMS OR ENCLOSED SPACES:	FRP PAN RP, SMO THE FLC Not Use LIGHT F	OTH SURFACE, S 490N LIGHT G  OOR AND WALL JUNCTURE IN T  ed.  EIXTURES OVER THE FOOD PREP N COOLERS ARE TO BE SEALED	REY HE KITCHEN AND RESTROOMS IS TO BE COVED.  P, UTENSIL WASHING, AND STORAGE AREAS ARE TO TO WALLS TO 1/32".  SF APPROVED SMOOTH FINISH PORCELAIN. VERIFY	BE SHATTERPROOF.  COLOR WITH OWNER.  CLASS B FLAME SPREAD, 26-75 (WALLS & CEILING CLASS B FLAME SPREAD).	NGS)	DE WALLS, UNDERBAR, AND COUNTER. *SPEC: MARLITE, STANDAI
	FRP PAN RP, SMO THE FLC Not Use LIGHT F	OTH SURFACE, S 490N LIGHT G  OOR AND WALL JUNCTURE IN T  ed.  EIXTURES OVER THE FOOD PREP N COOLERS ARE TO BE SEALED	REY HE KITCHEN AND RESTROOMS IS TO BE COVED.  P, UTENSIL WASHING, AND STORAGE AREAS ARE TO TO WALLS TO 1/32".  SF APPROVED SMOOTH FINISH PORCELAIN. VERIFY	COLOR WITH OWNER.  CLASS B FLAME SPREAD, 26-75 (WALLS & CEILIN CLASS B FLAME SPREAD, 26-75 (FLOORS)  CLASS A FLAME SPREAD, 0-25 (WALLS & CEILIN)	NGS)	DE WALLS, UNDERBAR, AND COUNTER. *SPEC: MARLITE, STANDAI
	FRP PAN RP, SMO THE FLC Not Use LIGHT F	OTH SURFACE, S 490N LIGHT G  OOR AND WALL JUNCTURE IN T  ed.  EIXTURES OVER THE FOOD PREP N COOLERS ARE TO BE SEALED	REY HE KITCHEN AND RESTROOMS IS TO BE COVED.  P, UTENSIL WASHING, AND STORAGE AREAS ARE TO TO WALLS TO 1/32".  SF APPROVED SMOOTH FINISH PORCELAIN. VERIFY	COLOR WITH OWNER.  CLASS B FLAME SPREAD, 26-75 (WALLS & CEILIN CLASS B FLAME SPREAD, 26-75 (FLOORS)  CLASS A FLAME SPREAD, 0-25 (WALLS & CEILIN)	NGS)	DE WALLS, UNDERBAR, AND COUNTER. *SPEC: MARLITE, STANDAR
$I \cup I \cup$	FRP PAN RP, SMO THE FLC Not Use LIGHT F	OTH SURFACE, S 490N LIGHT G  OOR AND WALL JUNCTURE IN T  ed.  EIXTURES OVER THE FOOD PREP N COOLERS ARE TO BE SEALED	REY HE KITCHEN AND RESTROOMS IS TO BE COVED. P, UTENSIL WASHING, AND STORAGE AREAS ARE TO TO WALLS TO 1/32". SF APPROVED SMOOTH FINISH PORCELAIN. VERIFY EXIT CORRIDORS:	COLOR WITH OWNER.  CLASS B FLAME SPREAD, 26-75 (WALLS & CEILIN CLASS B FLAME SPREAD, 26-75 (FLOORS)  CLASS A FLAME SPREAD, 0-25 (WALLS & CEILIN)	NGS)	DE WALLS, UNDERBAR, AND COUNTER. *SPEC: MARLITE, STANDAI
	FRP PAN RP, SMO THE FLC Not Use LIGHT F	OTH SURFACE, S 490N LIGHT G  OOR AND WALL JUNCTURE IN T  ed.  EIXTURES OVER THE FOOD PREP N COOLERS ARE TO BE SEALED	REY HE KITCHEN AND RESTROOMS IS TO BE COVED. P, UTENSIL WASHING, AND STORAGE AREAS ARE TO TO WALLS TO 1/32". SF APPROVED SMOOTH FINISH PORCELAIN. VERIFY EXIT CORRIDORS:	DES SHATTERPROOF.  COLOR WITH OWNER.  CLASS B FLAME SPREAD, 26-75 (WALLS & CEILING CLASS B FLAME SPREAD, 26-75 (FLOORS)  CLASS A FLAME SPREAD, 0-25 (WALLS & CEILING CLASS B FLAME SPREAD, 26-75 (WALLS & CEILING CLASS B FLAME SPREAD)	NGS)	DE WALLS, UNDERBAR, AND COUNTER. *SPEC: MARLITE, STANDAR
DOG EF 4 (CARDET) (FLOORS)	. FRP PAN RP, SMOO . THE FLC . Not Use . LIGHT F . WALK-II	OTH SURFACE, S 490N LIGHT G  OOR AND WALL JUNCTURE IN T  ed.  EIXTURES OVER THE FOOD PREP N COOLERS ARE TO BE SEALED	REY HE KITCHEN AND RESTROOMS IS TO BE COVED. P, UTENSIL WASHING, AND STORAGE AREAS ARE TO TO WALLS TO 1/32". SF APPROVED SMOOTH FINISH PORCELAIN. VERIFY EXIT CORRIDORS:	COLOR WITH OWNER.  CLASS B FLAME SPREAD, 26-75 (WALLS & CEILIN CLASS B FLAME SPREAD, 26-75 (FLOORS)  CLASS A FLAME SPREAD, 0-25 (WALLS & CEILIN)	NGS)	DE WALLS, UNDERBAR, AND COUNTER. *SPEC: MARLITE, STANE

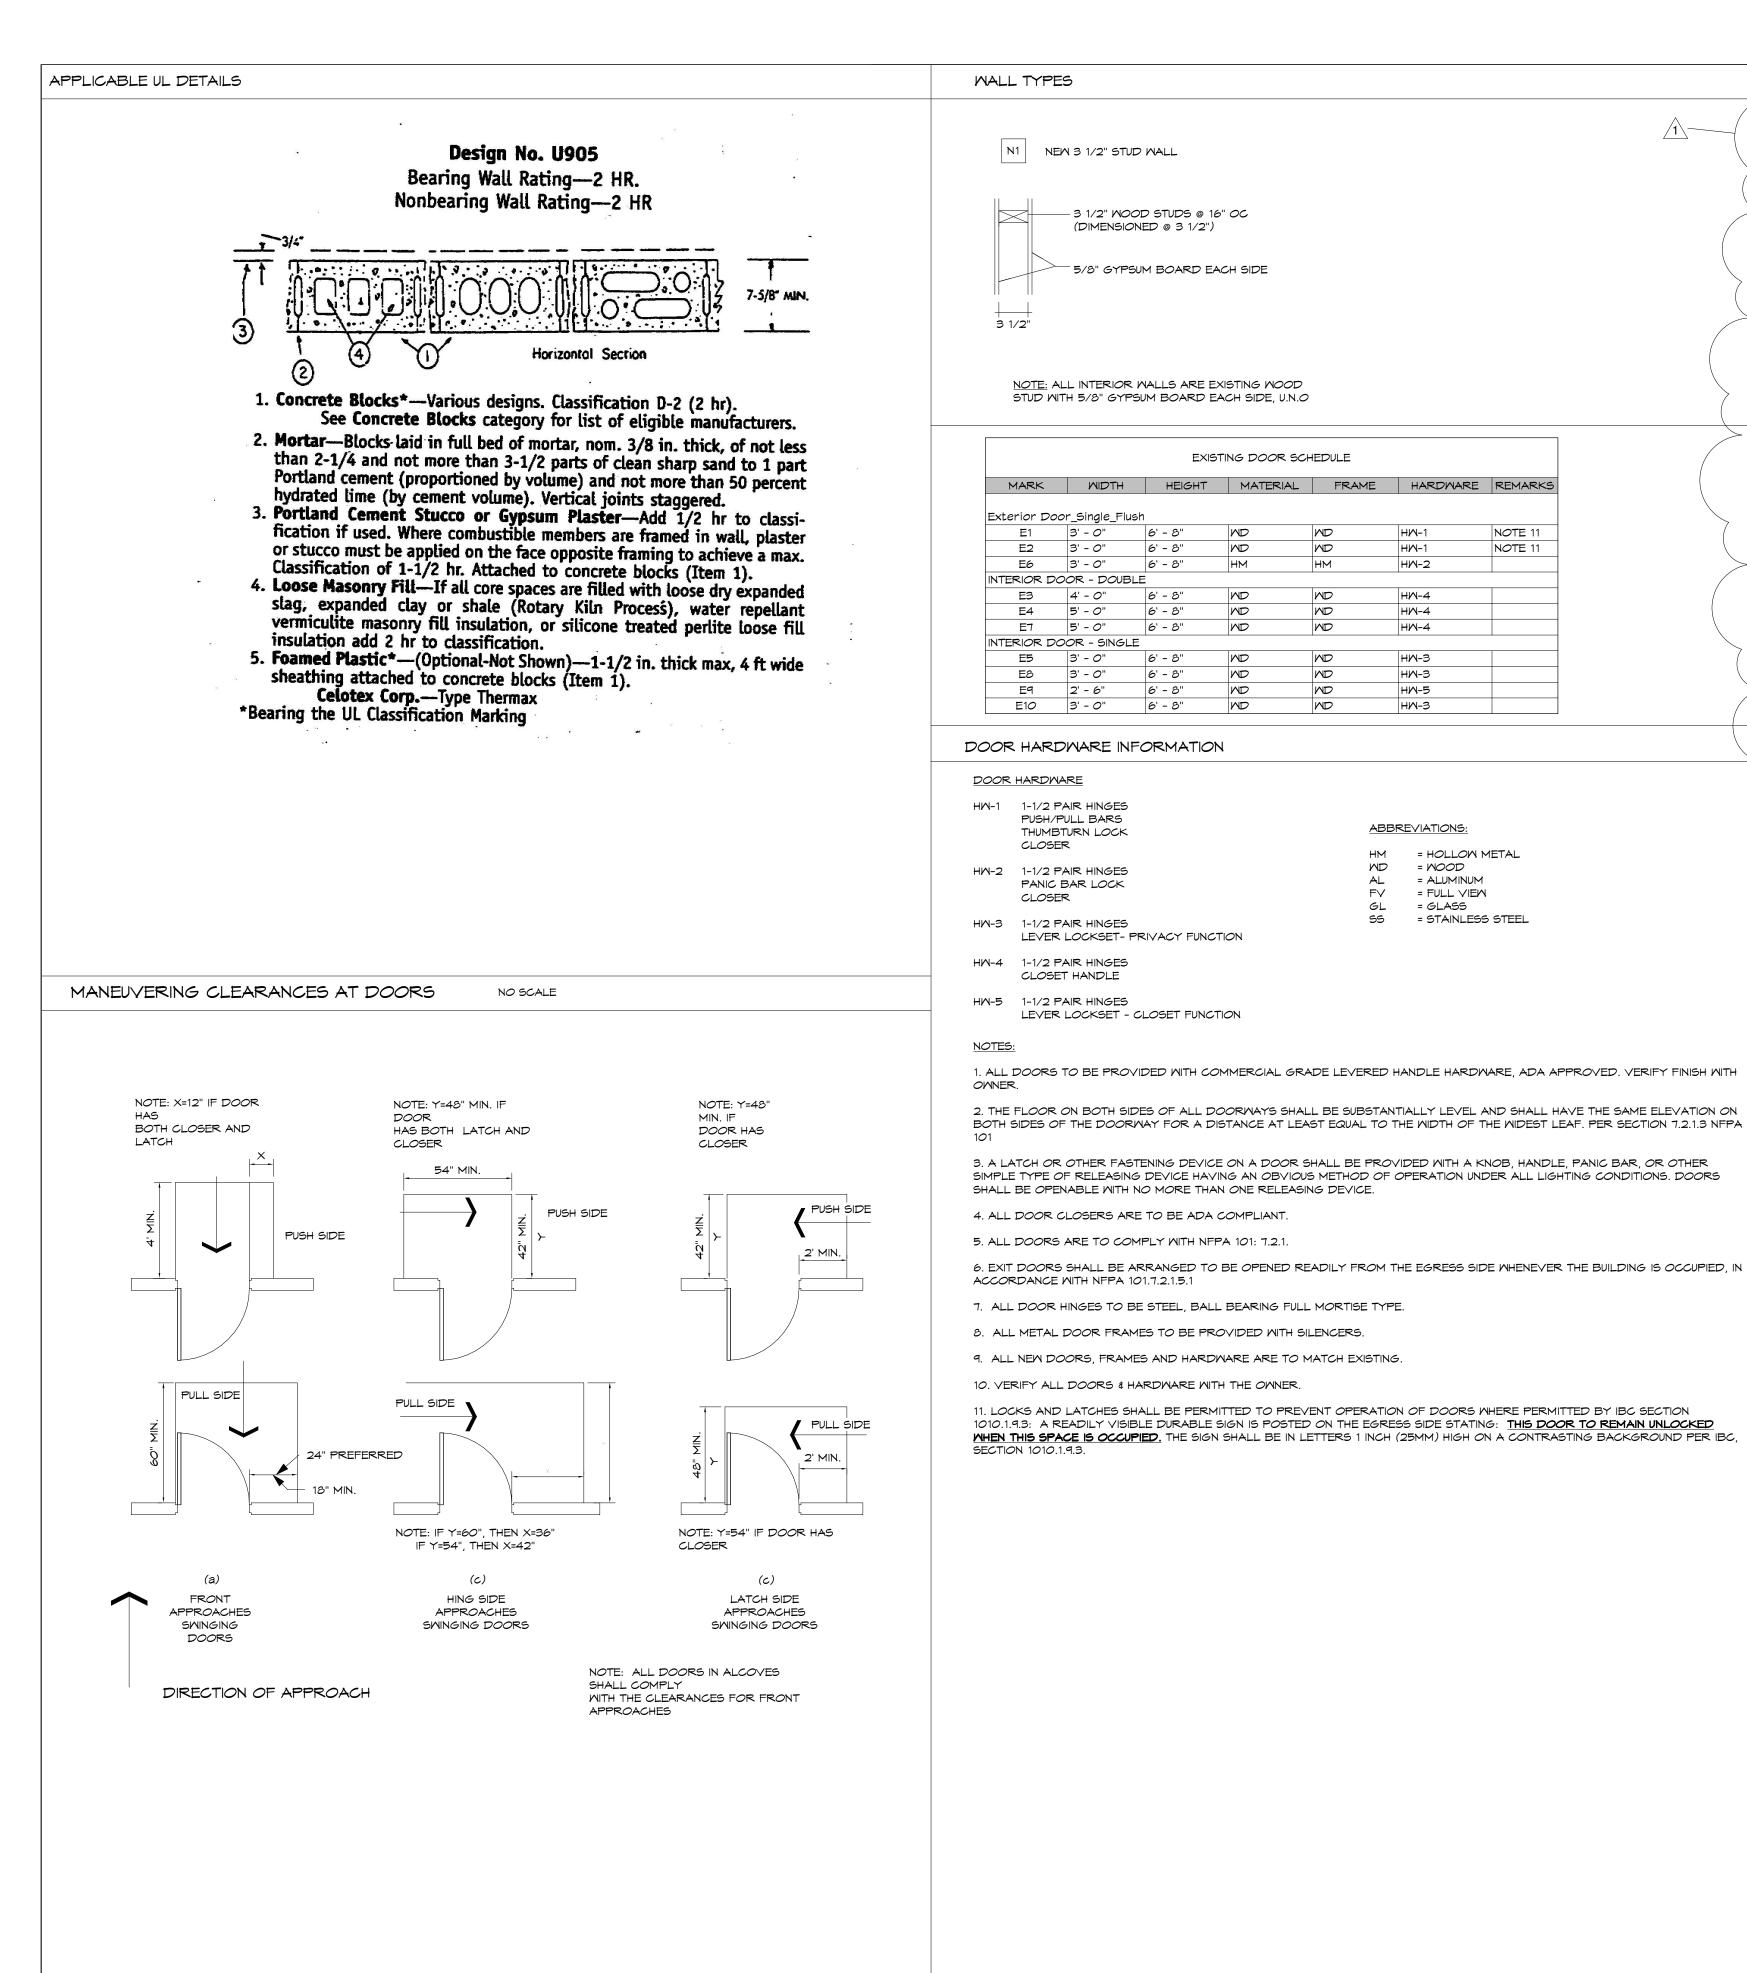

BOARD,


DRAWING I

Professional Certification. that I am a duly licensed architect under the laws of the State of Maryland LICENSE NUMBER: 5955, expiration date: 04-29-2022 DATE: 02/15/2021 SCALE: 1/4" = 1'-0"

REVISIONS: 1 07/02/2021

DRAWN BY: Author

G101

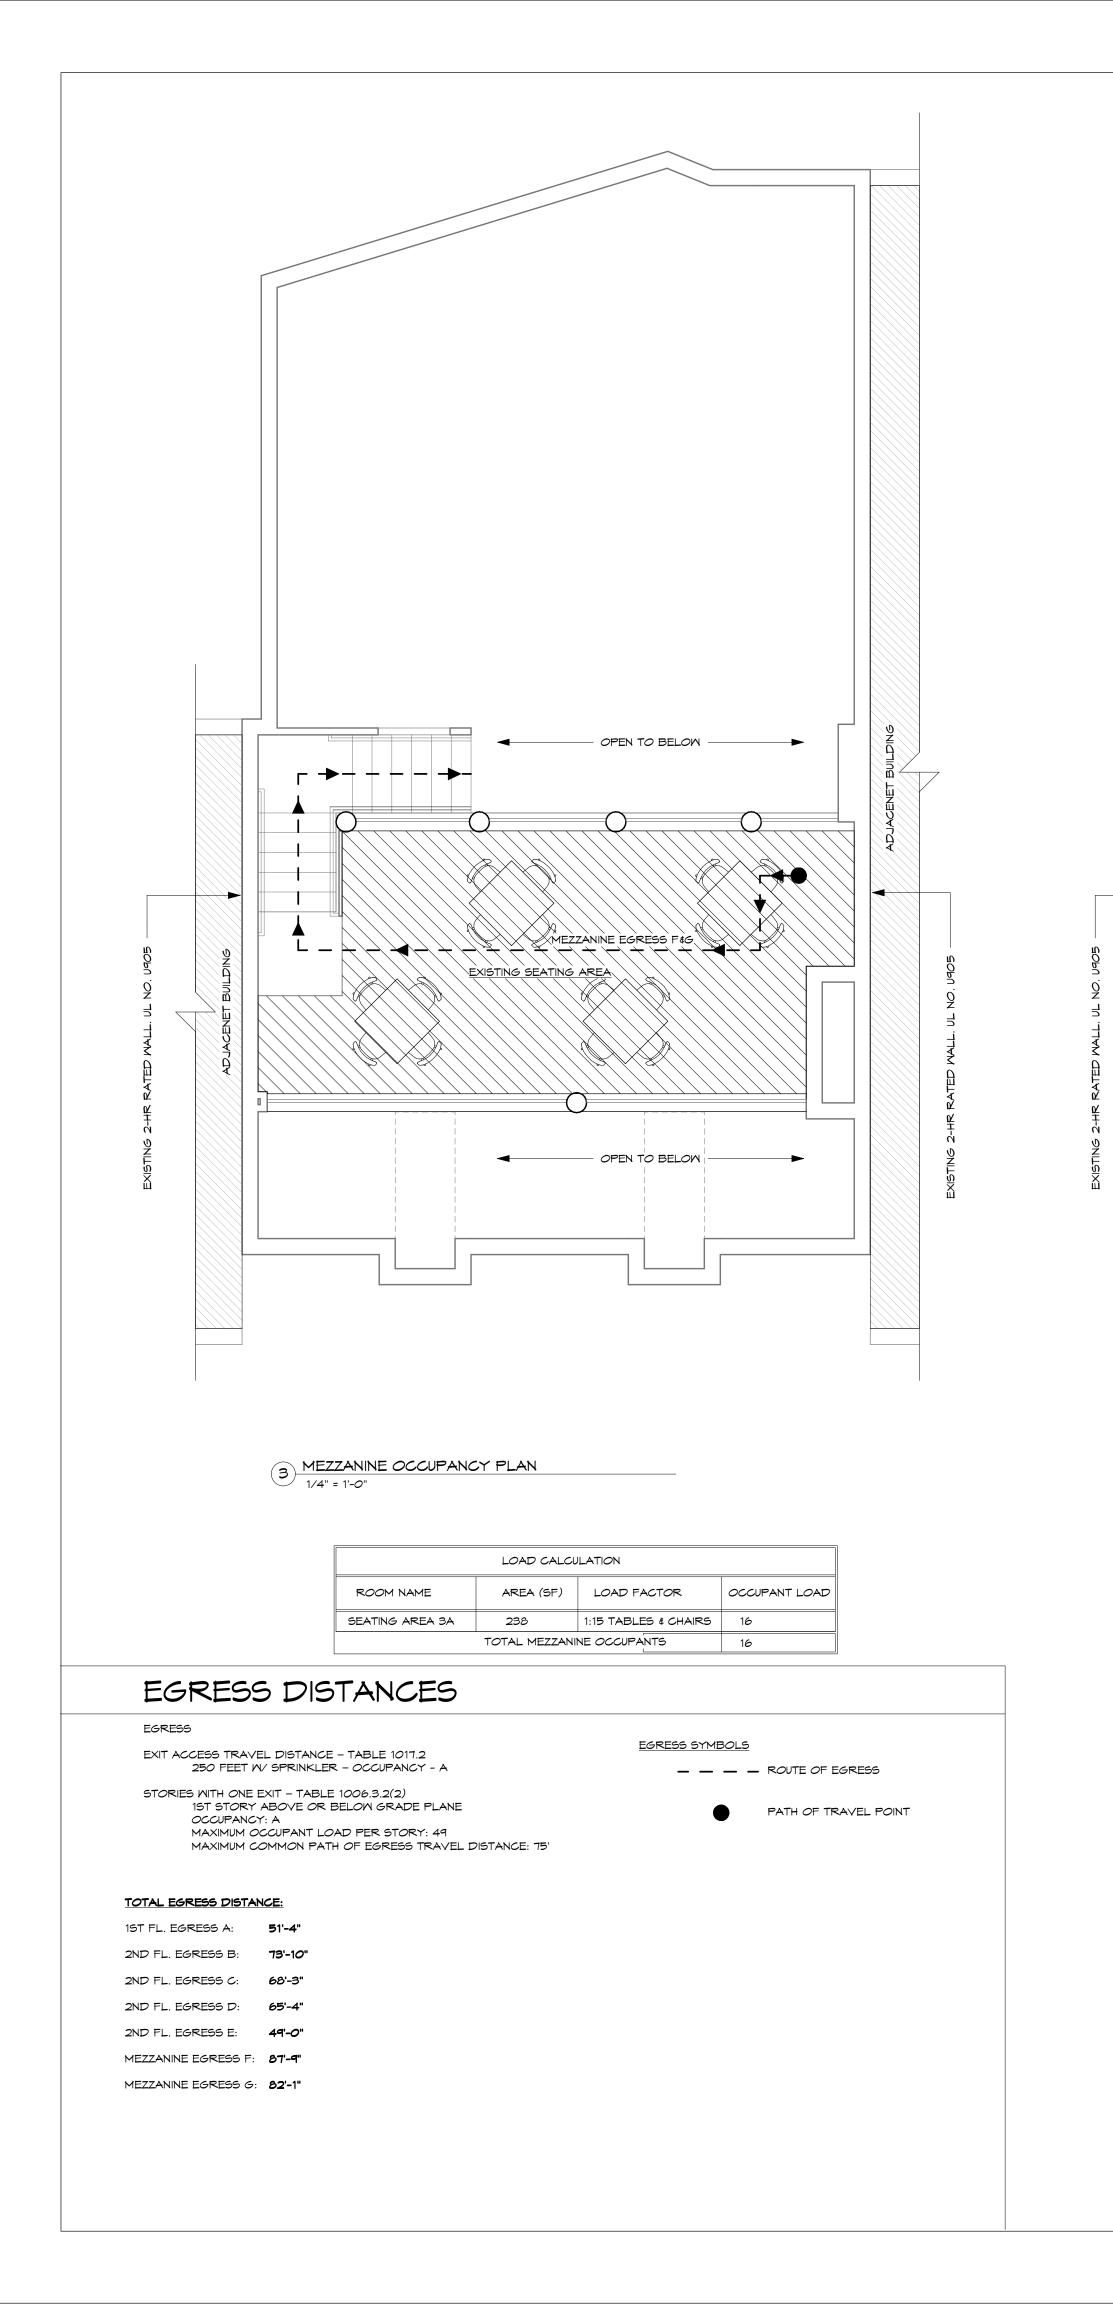

2 SECOND FLOOR OCCUPANCY PLAN

1/4" = 1'-0"

	LOAD CALCULATION						
ROOM NAME	AREA (SF)	LOAD FACTOR	OCCUPANT LOAI				
SEATING AREA 2A	374	1:15 TABLES & CHAIRS	25				
SEATING AREA 2B	82	1:15 TABLES & CHAIRS	6				
BAR SEATS		ACTUAL	7				
EXISTING BAR SERVICE	60	1:200	1				
	39						


EXIST. JANITOR

EXIST. RESTROOM

EXIST. RESTROOM

1) FIRST FLOOR OCCUPANCY PLAN 1/4" = 1'-0"

ROOM NAME	AREA (SF)	LOAD FACTOR	OCCUPANT LOAD
SEATING AREA 1A	70	1:15 TABLES & CHAIRS	5
SEATING AREA 1B	95	1:15 TABLES & CHAIRS	6
EXISTING SERVICE	27	1:200	1
ORDER & PICK UP	20	1:5 STANDING	4
EXISTING KITCHEN	362	1:200	2
TO	TAL 1ST FLOOR	OCCUPANTS	18

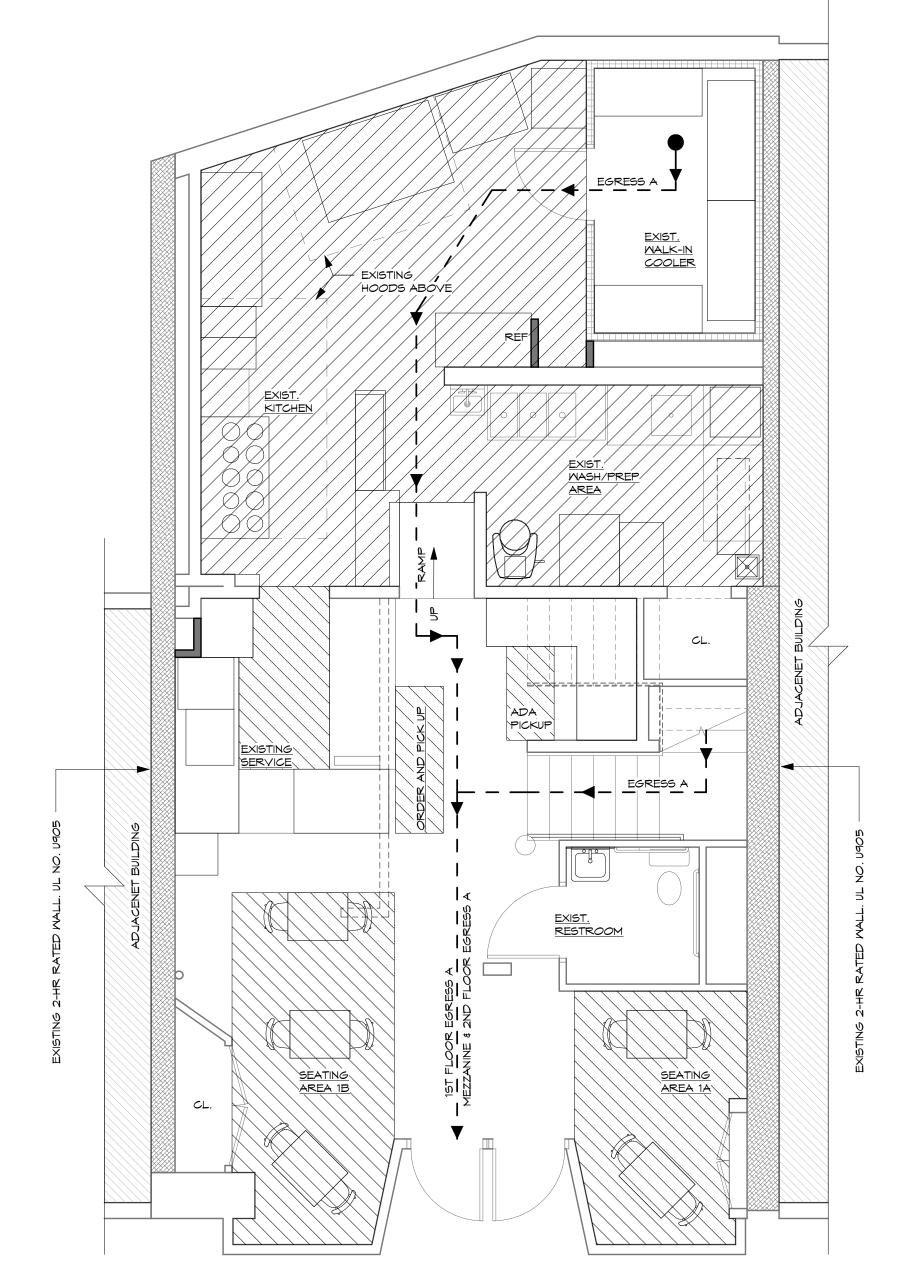

G102

Professional Certification.

DATE: 02/15/2021 SCALE: 1/4" = 1'-0"

DRAWN BY: Author

REVISIONS:

am a duly licensed architect under the laws of the State of Maryland. LICEN! NUMBER: 5955, expiration date: 04-29-2021

THE DRAWING BOARD,
A R C H I T E C T U