## STATE OF CALIFORNIA DEPARTMENT OF TRANSPORTATION


# PROJECT PLANS FOR CONSTRUCTION ON STATE HIGHWAY 16

YOLO COUNTY, CALIFORNIA

SEE ON-SITE IMPROVEMENT PLANS BY MVE. INC

**LEGEND** 



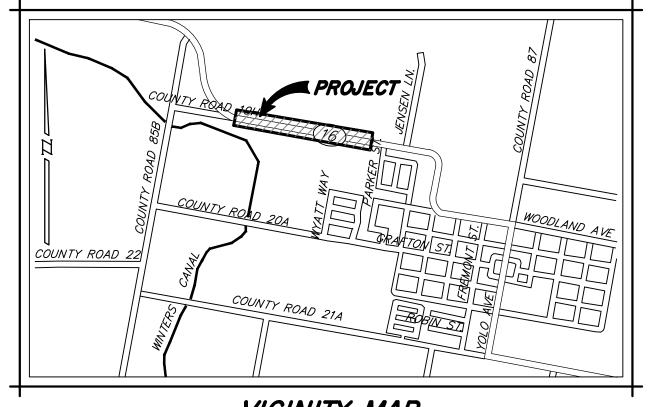

VICINITY MAP

SCALE: 1" = 100'

### LOCATION MAP

#### **BENCHMARK**

DESCRIPTION: 2" ALUMINUM DISK STAMED "BRIDGE 1999" LOCATED NORTHEASTERLY FROM THE BRIDGE OVER CACHE CREEK ALONG COUNTY ROAD 85.

ELEVATION: 210.6 NAVD 88

#### OWNER


CASTLE HORIZONS, LLC 12885 ALCOSTA BOULEVARD, SUITE A SAN RAMON, CA 94583 PH: (925) 328-1000 CONTACT: DAN BOATWRIGHT

#### CIVIL ENGINEER

MVE, INC. 1117 "L" ST. MODESTO, CA 95354 PH: (866) 526-4214 CONTACT: ROBERTO GUZMAN, E.I.T. DEREK A. MARTIS, P.E. QSD/QSP

### GEOTECHNICAL ENGINEER

WALLACE-KUHL & ASSOCIATES, INC. 3251 BEACON BLVD., SUITE 300 WEST SACRAMENTO, CA 95691 PH: (916) 372-1434

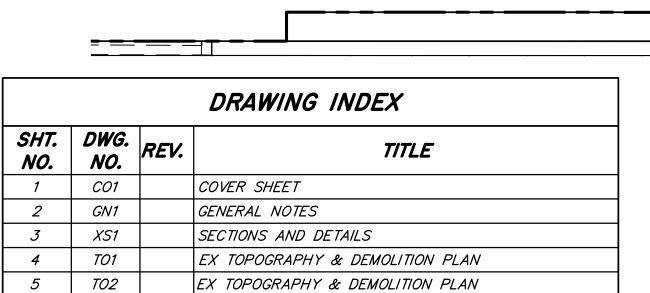

PLAN AND PROFILE - HWY. STATE ROUTE 16

PLAN AND PROFILE - HWY. STATE ROUTE 16

PAVEMENT DELINEATION, SIGN AND STREET LIGHT PLAN

- BEGIN PAVEMENT CONSTRUCTION

STA: 41+03.10

PP1

PP2

PD1

### UTILITY COMPANIES

56+00

*57+00* 

ASPHALTIC CONCRETE

AIR RELEASE VALVE

BACK OF SIDEWALK

BACK TOP OF CURB

BROKEN WHITE LINE

BROKEN YELLOW LINE

CALIFORNIA BUILDING CODE

CONDITIONS OF APPROVAL

ESPARTO COMMUNITY SERVICE

END POINT OF TRANSITION

BEGIN VERTICAL CURVE

BUTTERFLY VALVE

BOTTOM OF WALL

CITY OF ESPARTO

CONCRETE

CATCH BASIN

CENTERLINE

**DECORATIVE** 

END OF CURVE

FACE OF CURB

FINISH GRADE

FIRE HYDRANT

FLOW LINE

FORCE MAIN

GRADE BREAK

GATE VALVE

**HORIZONTAL** 

HIGH POINT

LINEAR FEET

LAMPHOLE

GUTTER LIP

LOW POINT

LOT LINE

*INVERT* 

**LENGTH** 

FACE OF SIDEWALK

HIGH WATER LINE

EDGE OF PAVEMENT

END VERTICAL CURVE

DRAWING

DISTRICT

ELE VA TION

EX, EXIST EXISTING

BLOWOFF VALVE

AUTOMATIC METER READING

BEGIN POINT OF TRANSITION

**ADJACENT** 

BTC

C.O.A.

C.O.E.

DEC

*ECSD* 

**ELEV** 

ANGLE POINT

STATE HIGHWAY 16

*52+00 53+00 54+00 55+00* 

SANITARY SEWER: ESPARTO COMMUNITY SERVICES DISTRICT PH: (530) 787-4502 CONTACT: MANUEL QUINTANA WATER: ESPARTO COMMUNITY SERVICES DISTRICT PH: (530) 787-4502

> CONTACT: MANUEL QUINTANA GAS/ELECTRIC: PACIFIC GAS AND ELECTRIC CONTACT: TBD

CABLE TELEVISION: ESPARTO BROADBAND CONTACT: TBD

**-**¤

	EXISTING	E	XISTING_
100.0	GROUND ELEVATION	⊗ PIV	POST INDICATOR VALVE
P 100.00	PAVEMENT ELEVATION	$\triangleleft$	REDUCER
EP 100.00	EDGE OF PAVEMENT ELEVATION	$\bowtie$	VAL VE
C 100.00	CONCRETE ELEVATION		WELL
BSW 100.00	BACK OF SIDEWALK ELEVATION	$\boxtimes$	DOUBLE CHECK VALVE
BC 100.00	BACK OF CURB ELEVATION	— <i>CATV</i> — —	CABLE TV LINE
TC 100.00	TOP OF CURB ELEVATION	——E— —	ELECTRICAL LINE
FL 100.00	FLOWLINE ELEVATION		GAS LINE
• LIP 100.00	GUTTER LIP ELEVATION	<i>─</i> Ø <i>T</i> — —	TELEPHONE LINE
• R 100.00	RIM ELEVATION	—Рон— —	OVERHEAD UTILITY LINES
- <i>IR</i>	IRRIGATION LINE	ГЈ	UTILITY BOX (LABEL TYPE)
O SP	STAND PIPE	$\sim$	UTILITY MANHOLE (LABEL TYPE)
$\cup$	GATE VALVE	Ø JP	JOINT POLE
X	ELECTROLIER	ø SP	SERVICE POLE
- <i>ss-</i>	SEWER LINE	TP	TELEPHONE POLE
——SSFM————	SS FORCE MAIN	PP	POWER POLE
0 00	CLEAN OUT	— <b></b> Ø	UTILITY POLE WITH GUY WIRE
SSMH	MANHOLE	——TOE — —	TOE OF SLOPE
– <i>——SD</i> — —	STORM DRAIN LINE	—— <i>TOP</i> ——	TOP OF SLOPE
——SDFM———	SD FORCE MAIN	FP	EDGE OF PAVEMENT
⊕ CB	CATCH BASIN	= = = =	CURB AND GUTTER
	DRY WELL	• <i>GP</i>	GUARD POST
SDMH	MANHOLE		SIGN
W	WATER LINE	• <i>TS</i>	TRAFFIC SIGNAL
FW	FIRE SERVICE LINE	<u> </u>	MAILBOX
NPW	NON POTABLE WATER		MAILDON
⊠ BFP	BACK FLOW PREVENTER	/ /	
	0,0,,0,,0,	,	

# **PROPOSED**

PH: (530) 787-4656

——TOE — TOE OF SLOPE

ELECTROLIER PULL BOX DECORATIVE ELECTROLIER SINGLE MAST ELECTROLIER

STORM DRAIN LINE STORM DRAIN OUTFALL STRUCTURE

DRAINAGE ARROW <u>100.0 </u> <u></u> HGL LABEL SINGLE POST SIGN DOUBLE POST SIGN STREET NAME SIGN MONUMENT WELL RIGHT OF WAY SYMBOL CENTERLINE SYMBOL PROPERTY LINE SYMBOL

GRADING TRANSITION

CURB, GUTTER, & SIDEWALK

DITCH FLOW LINE

REVISION DELTA SYMBOL

### **ABBREVIATIONS**

END PAVEMENT CONSTRUCTION

STA: 62+59.38

LPVC LOW POINT VERTICAL CURVE TOP *LANDSCAPE* MAXIMUM **MERCSA** MADISON ESPARTO REGIONAL UPCCOUNTY SERVICE AREA MINIMUM BEGIN CURVE / BACK OF CURB MJR W/TB MECHANICAL JOINT RESTRAINT WCR WITH THRUST BLOCK MID POINT OF VERTICAL CURVE MID POINT OF VERTICAL CURVE WE MAXIMUM RELATIVE DRY DENSITY NOTICE OF INTENT NOT NOTICE OF TERMINATION NTS NOT TO SCALE ON CENTER **PAVEMENT** PORTLAND CEMENT CONCRETE PERFORATED PROPERTY LINE POINT OF REVERSE CURVE PRESSURE REDUCING STATION POINT OF VERTICAL INTERSECTION POINT OF VERTICAL INTERSECTION STATION POINT OF VERTICAL INTERSECTION ELEVATION P.U.E. PUBLIC UTILITY EASEMENT RIGHT-OF-WAY EMERGENCY VEHICULAR ACCESS RD RELATIVE DENSITY RETURN POINT STORM DRAIN EASEMENT STORM DRAIN MANHOLE

SQUARE FEET

SEWER SERVICE LATERAL

SANITARY SEWER EASEMENT

SANITARY SEWER MANHOLE

STREET NAME SIGN

SUB GRADE

STA TION

STANDARD

SIDEWALK

STREET LIGHT

TOP OF CURB

TOP OF AC DIKE

TRAFFIC INDEX

TOE OF SLOPE

YOLO COUNTY

SOLID WHITE LINE

TOP BACK OF CURB

TOP FACE OF CURB

SNS

SSE

STA

STD

STL

SW

SWL

TOE

WATER SERVICE YOLO COUNTY YCFCWCD YOLO COUNTY FLOOD CONTROL & WATER CONSERVATION DISTRICT **NORTH** SOUTH EAST WEST

TYPICAL

**VERTICAL** 

UNIFORM BUILDING CODE

UNIFORM PLUMBING CODE

IDENTIFICATION NUMBER

WHEELCHAIR RAMP WASTE DISCHARGE

WATER EASEMENT

UNDERGROUND SERVICE ALERT

Know what's below.

Call before you dig.

PRIOR TO CONSTRUCTION THE CONTRACTOR SHALL CALL UNDERGROUND SERVICE ALERT FOR UNDERGROUND CLEARANCE. USA WILL PROVIDE INFORMATION ABOUT OR LOCATE AND MARK UNDERGROUND FACILITIES.

### UNAUTHORIZED CHANGES & USES

□ BO

∢ FDC

BLOW OFF

HOSE BIB

FIRE HYDRANT

FIRE DEPARTMENT CONNECTION (FDC)

THE ENGINEER PREPARING THESE PLANS WILL NOT BE RESPONSIBLE FOR, OR LIABLE FOR, UNAUTHORIZED CHANGES TO OR USES OF THESE PLANS. ALL CHANGES TO THE PLANS MUST BE IN WRITING AND MUST BE APPROVED BY THE PREPARER OF THESE PLANS.

	Drawn By: RG/J:	5L		REVISI	ONS		
5	Drawn By. KG/J	NO.	DATE	i		BY	
	Issue Date: 9/15/	22	<i>D</i> , . , 2				
	Job No.: NCO7254	1E					REG(
	Checked: DA	М					*
	Design By: RG/JS	5H					
							161

TREE (SPREAD DRAWN TO SCALE)



MVE Inc.

1117 L Street, Modesto, CA 95354 | 866.526.4214 | www.mve.net Northern California | Southern California | Nevada

STATE HIGHWAY 16 IMPROVEMENTS

COVER SHEET

STATE OF CALIFORNIA DEPARTMENT OF TRANSPORTATION

CO1 SHEET

CALIFORNIA OF\_

DWG.

- ". SOILS REPORT: THE GEOTECHNICAL ENGINEERING INVESTIGATION ENTITLED GEOTECHNICAL ENGINEERING REPORT ORCIUOLI PROPERTY IS HEREBY MADE A PART OF THESE PLANS AND SPECIFICATIONS. THE CONTRACTOR SHALL OBTAIN A COPY OF THIS REPORT AND SHALL PERFORM ALL GRADING, EXCAVATING, COMPACTION, AND SUBGRADE PREPARATION AS PER DIRECTION GIVEN IN THESE PLANS AND THE SOILS REPORT.
- APPROVAL OF THE USE OF NON-APPROVED MATERIALS OR CONSTRUCTION TECHNIQUES MUST BE OBTAINED FROM THE CITY ENGINEER IN ADVANCE OF CONSTRUCTION.
- 4. THE CONTRACTOR SHALL BE HELD RESPONSIBLE FOR ANY FIELD CHANGES MADE WITHOUT PRIOR WRITTEN AUTHORIZATION FROM THE OWNER AND/OR ENGINEER.
- 5. PRIOR TO STARTING ANY WORK, THE CONTRACTOR SHALL INVITE THE APPROPRIATE REGULATORY AGENCIES TO A PRE-CONSTRUCTION CONFERENCE.
- 6. THE CONTRACTOR SHALL COMPLY WITH ALL LOCAL, STATE AND FEDERAL SAFETY REGULATIONS PERTAINING TO HIS OPERATIONS. THE CONTRACTOR SHALL PROVIDE ALL LIGHTS, SIGNS, BARRICADES, FLAGMEN OR OTHER DEVICES NECESSARY FOR PUBLIC SAFETY. THE CONTRACTOR'S ATTENTION IS CALLED TO THE REQUIREMENTS OF TITLE 8, CALIFORNIA ADMINISTRATION CODE, SUBCHAPTER 4, ARTICLE 6, "EXCAVATIONS, TRENCHES AND
- THE CONTRACTOR SHALL ASSUME SOLE AND COMPLETE RESPONSIBILITY FOR JOBSITE CONDITIONS DURING THE COURSE OF CONSTRUCTION OF THIS PROJECT. INCLUDING SAFETY OF ALL PERSONS AND PROPERTY. THIS REQUIREMENT SHALL APPLY CONTINUOUSLY AND NOT BE LIMITED TO NORMAL WORKING HOURS.
- 8. THE CONTRACTOR SHALL DEFEND. INDEMNIFY AND HOLD THE OWNER AND ENGINEER HARMLESS FROM ANY AND ALL LIABILITY. REAL OR ALLEGED. IN CONNECTION WITH THE CONSTRUCTION WORK ON THIS PROJECT, EXCEPTING FOR LIABILITY ARISING FROM THE SOLE NEGLIGENCE OF THE OWNER OR THE ENGINEER.
- . APPROPRIATE DUST CONTROL SHALL BE PROVIDED AT ALL TIMES, AT THE CONTRACTOR'S EXPENSE, AND SHALL BE IN ACCORDANCE WITH SECTION 10 OF CALTRANS STANDARD SPECIFICATIONS AND WITH LOCAL
- 10. THE CONTRACTOR SHALL BE RESPONSIBLE FOR MAINTAINING A SET OF "AS—BUILT" RED—LINED PLANS THAT SHOWS ANY CHANGES WHICH OCCUR DURING CONSTRUCTION. PRIOR TO FINAL ACCEPTANCE OF IMPROVEMENTS, THE CONTRACTOR SHALL SUBMIT THE AS-BUILT PLANS TO MVE.
- 11. THE ENGINEER ASSUMES NO RESPONSIBILITY FOR ANY WORK PERFORMED BY THE CONTRACTOR AND/OR OWNER BASED ON DRAWINGS WHICH HAVE NOT BEEN SIGNED AND SEALED BY THE ENGINEER.
- 12. THE CONTRACTOR SHALL EXERCISE DUE CAUTION AND SHALL CAREFULLY PRESERVE BENCHMARKS, CONTROL POINTS, REFERENCE POINTS AND ALL SURVEY STAKES AND SHALL BEAR ALL EXPENSES FOR REPLACEMENT AND/OR ERRORS CAUSED BY THEIR UNNECESSARY LOSS OR DISTURBANCE.
- 13. EACH CONTRACTOR OR SUBCONTRACTOR SHALL BE RESPONSIBLE TO CLEAN THE JOB SITE AT THE END OF EACH PHASE OF WORK AND TO REMOVE AND DISPOSE OF ALL TRASH, SCRAP, AND UNUSED MATERIAL AT THEIR OWN EXPENSE IN A TIMELY MANNER.
- 14. WORK IN EASEMENTS AND/OR RIGHTS-OF-WAY IS SUBJECT TO THE APPROVAL AND ACCEPTANCE OF THE REGULATORY AGENCY RESPONSIBLE FOR OPERATION AND/OR MAINTENANCE OF SAID EASEMENT AND/OR RIGHT-OF-WAY. FOR ALL WORK WITHIN PUBLIC RIGHTS-OF-WAY OR EASEMENTS. THE CONTRACTOR SHALL PRESERVE THE INTEGRITY AND LOCATION OF ANY AND ALL PUBLIC UTILITIES AND PROVIDE THE NECESSARY CONSTRUCTION TRAFFIC CONTROL. CONTRACTOR SHALL, THROUGH THE ENCROACHMENT PERMIT PROCESS, VERIFY WITH THE NECESSARY REGULATORY AGENCIES, THE NEED FOR ANY TRAFFIC ROUTING PLANS. IF A PLAN IS REQUIRED, CONTRACTOR SHALL PROVIDE PLAN AND RECEIVE PROPER APPROVALS PRIOR TO
- 15. THE CONTRACTOR SHALL BE RESPONSIBLE FOR ADEQUATELY SCHEDULING INSPECTION AND TESTING OF ALL FACILITIES CONSTRUCTED UNDER THIS CONTRACT. ALL TESTING SHALL CONFORM TO THE REGULATORY AGENCY'S STANDARD SPECIFICATIONS. ALL TESTING AND INSPECTION SHALL BE PAID FOR BY THE OWNER; ALL RE-TESTING AND/OR RE-INSPECTION SHALL BE PAID FOR BY THE CONTRACTOR. THE CONTRACTOR SHALL GIVE THE REVIEWING AGENCY 48 HOURS NOTICE PRIOR TO REQUIRING INSPECTION FOR ALL UNDERGROUND PIPELINES AND STREET CONSTRUCTION. BACKFILL SHALL NOT BE AUTHORIZED OVER UTILITY LINES UNTIL AFTER INSPECTION AND APPROVAL.
- 16. IF EXISTING IMPROVEMENTS NEED TO BE DISTURBED AND/OR REMOVED FOR THE PROPER PLACEMENT OF IMPROVEMENTS TO BE CONSTRUCTED BY THESE PLANS. THE CONTRACTOR SHALL BE RESPONSIBLE FOR PROTECTING REMAINING IMPROVEMENTS FROM DAMAGE. COSTS SHALL BE INCLUDED IN THE UNIT PRICE BID FOR REMOVAL AND/OR REPLACEMENT OF EXISTING IMPROVEMENTS. IF PLANS DO NOT DICTATE THAT RELOCATION OR RÉMOVAL MUST OCCUR, THEN A DESIGN CHANGE AND CHANGE ORDER SHALL BE
- 17. THE CONTRACTOR SHALL MAINTAIN A SET OF FULL—SIZE AS—BUILT RECORD DRAWINGS SHOWING THE FINAL LOCATION AND LAYOUT OF ALL MECHANICAL; ELECTRICAL AND INSTRUMENTATION EQUIPMENT; PIPING AND CONDUITS: STRUCTURES: AND OTHER FACILITIES. THE AS-BUILTS OF THE ELECTRICAL SYSTEM SHALL INCLUDE THE STREET LIGHT LAYOUT PLAN SHOWING LOCATION OF LIGHTS, CONDUITS, CONDUCTORS, POINTS OF CONNECTIONS TO SERVICES, PULL BOXES, AND WIRE SIZES. AS-BUILT RECORD DRAWINGS SHALL REFLECT CHANGE ORDERS. ACCOMMODATIONS. AND ADJUSTMENTS TO ALL IMPROVEMENTS CONSTRUCTED. WHERE NECESSARY, SUPPLEMENTAL DRAWINGS SHALL BE PREPARED AND SUBMITTED BY THE CONTRACTOR.
- 18. PRIOR TO ACCEPTANCE OF THE PROJECT AND FINAL PROGRESS PAYMENT APPROVAL, THE CONTRACTOR SHALL DELIVER TO THE ENGINEER (MVE, INC.) ONE SET OF CURRENT AS-BUILT RECORD DRAWINGS SHOWING THE INFORMATION REQUIRED ABOVE.
- 19. HISTORIC PRESERVATION: THE CONTRACTOR SHALL IMMEDIATELY STOP WORK AND NOTIFY THE PLANNING DEPARTMENT IN THE EVENT THAT HISTORIC OR PREHISTORIC ARCHAEOLOGICAL FEATURES ARE DISCOVERED DURING EXCAVATION. THE PLANNING DEPARTMENT SHALL NOTIFY THE STATE HISTORIC PRESERVATION OFFICE. REMEDIAL ACTION SHALL BE PREPARED AND IMPLEMENTED BY THE DEVELOPER IN ACCORDANCE WITH IMPLEMENTATION MEASURES OF THE GENERAL PLAN.
- 20. THE CONTRACTOR SHALL BE RESPONSIBLE TO PREPARE AND IMPLEMENT A TRAFFIC CONTROL PLAN AND SUBMIT TO THE CITY OF ESPARTO FOR APPROVAL A MINIMUM OF 3 DAYS PRIOR TO CONSTRUCTION. THE CONTRACTOR SHALL MAINTAIN TRAFFIC & ACCESS TO DRIVEWAYS AT ALL TIMES.
- 21. THE CONTRACTOR SHALL ADHERE TO ALL REQUIREMENTS OF THE LATEST EDITION OF THE STATE OF CALIFORNIA, MANUAL OF TRAFFIC CONTROLS FOR CONSTRUCTION AND MAINTENANCE ZONES. ANY PROPOSED DEVIATION OR MODIFICATIONS TO THESE TRAFFIC CONTROL REQUIREMENTS SHALL BE SUBMITTED TO THE CITY, COUNTY, OR STATE, WHICHEVER IS APPROPRIATE, FOR APPROVAL.

#### GRADING & EARTHWORK:

- EARTHWORK SHALL BE PERFORMED IN ACCORDANCE WITH CALTRANS STANDARDS AND THE PROJECT'S GEOTECHNICAL REPORT.
- 2. APPROPRIATE DUST CONTROL SHALL BE PROVIDED TO MINIMIZE ANY DUST NUISANCE AND SHALL BE IN ACCORDANCE WITH SECTION 10 OF CALTRANS STANDARD SPECIFICATIONS AND THE REQUIREMENTS OF THE
- GRADES SHOWN HEREON ARE INTENDED TO PROVIDE A BALANCED EARTH WORK OPERATION, ANY CHANGES IN PROPOSED GRADES REQUIRED IN ORDER TO ACHIEVE A BALANCE, MUST BE COORDINATED WITH THE ENGINEER, THERE WILL BE NO EXTRA COSTS DUE TO THE CONTRACTOR BECAUSE OF THESE CHANGES.
- THE CONTRACTOR SHALL BE RESPONSIBLE TO GRADE, MAINTAIN, AND PROVIDE PROPER DRAINAGE WITHOUT CAUSING SOIL EROSION OR DRAINING ONTO ADJACENT PROPERTIES.
- EARTHWORK CALCULATIONS ARE BASED ON THE CLEARED GROUND ELEVATIONS BEING COMPARED TO THE DESIGN SURFACE SUBGRADE. PER THE GEOTECHNICAL REPORT DATED DECEMBER 28, 2007 PREPARED BY WALLACE-KUHL, MATERIAL RESULTING FROM CLEARING AND STRIPPING SHOULD NOT BE USED FOR GENERAL FILL, BUT MAY BE USED IN LANDSCAPE AREAS. THE QUANTITIES SHOWN BELOW DO NOT TAKE INTO ACCOUNT ANY EXISTING STRUCTURAL PAVEMENT THICKNESSES. THEREFORE, THESE QUANTITIES ARE ONLY ESTIMATES TO HELP AID THE CONTRACTOR.

- 7. THE INTENT OF THIS PLAN IS TO AID THE CONTRACTOR IN DETERMINING THE QUANTITIES OF DIRT TO BE MOVED. THE CUT AND FILL QUANTITIES SHOWN HEREON INDICATE A THEORETICAL YARDAGE FIGURE AND ARE GIVEN ONLY AS A CONVENIENCE TO THE CONTRACTOR.
- TOTAL CUT EXPORT TO IN-TRACTS 1,306 CU. YDS.
- 8. THE CONTRACTOR SHALL VERIFY EARTHWORK QUANTITIES PRIOR TO SUBMITTING BIDS. ANY DISCREPANCY SHALL BE BROUGHT TO THE ATTENTION OF THE ENGINEER PRIOR TO SUBMITTING BIDS. NO EXTRA PAYMENT WILL BE PROVIDED FOR GRADING REQUIRED TO ACHIEVE BALANCE. STOCKPILING OF EXCESS FOR FUTURE PHASES SHALL BE COORDINATED WITH THE DEVELOPER AND THE ENGINEER.
- 9. THE GENERAL CONTRACTOR SHALL COORDINATE WORK BY GRADING CONTRACTOR AND LANDSCAPE CONTRACTOR WITH RESPECT TO FINISH GRADING IN PLANTING AREAS. GRADING CONTRACTOR SHALL STOCKPILE APPROPRIATE YARDAGE FROM SITE PREPARATION FOR THIS USE. EXACT AMOUNT SHALL BE DETERMINED BY LANDSCAPE CONTRACTOR. THE DIRT STOCKPILED SHALL BE FREE FROM GRASS, WEEDS AND OTHER DEBRIS. THE LANDSCAPE CONTRACTOR SHALL BE RESPONSIBLE FOR THE FINAL PLACEMENT AND GRADING IN MOUNDED AREAS. IF THE SITE IS STRIPPED, THE STRIPPED MATERIAL SHALL BE STOCKPILED FOR USE IN THE LANDSCAPED AREAS.
- 10. PRIOR TO GENERAL SITE GRADING, SURFACE VEGETATION, ORGANIC TOPSOIL, AND ANY DEBRIS SHOULD BE REMOVED AND DISPOSED OF. DEEP STRIPPING WILL BE REQUIRED WHERE CONCENTRATIONS OF ORGANIC SOILS OR TREE ROOTS ARE ENCOUNTERED DURING SITE GRADING. THE DEPTH OF STRIPPING AND/OR DISCING SHOULD BE DETERMINED IN THE FIELD BY A REPRESENTATIVE OF TECHNICON ENGINEERING SERVICES PRIOR TO EARTHWORK. THIS MATERIAL, HOWEVER, SHOULD NOT BE INCORPORATED INTO ANY ENGINEERED FILL.

#### CONSTRUCTION MATERIALS:

- 1. UNLESS SPECIFICALLY NOTED HEREIN, ALL CONSTRUCTION MATERIALS, INSTALLATION REQUIREMENTS, TESTING, AND INSPECTION REQUIREMENTS SHALL CONFORM TO YOLO COUNTY AND CAL-TRANS SPECIFICATIONS AND
- 2. ASPHALT PAVING: ALL SUB-GRADE PREPARATION. BASE COURSE AND PAVING SHALL CONFORM TO YOLO COUNTY'S STANDARD SPECIFICATIONS, AND THE REQUIREMENTS OF THE PROJECT'S SOILS REPORT. STRUCTURAL THICKNESSES ARE AS INDICATED IN THE PLANS. TESTS SHALL BE PERFORMED BY CONTRACTOR AS PER THE REQUIREMENTS OF THE COUNTY:
- A. AGGREGATE BASE (A.B.) SHALL BE INSTALLED AND CONFORM WITH YOLO COUNTY'S STANDARD SPECIFICATIONS PER SECTION 2, TABLE 1 "CONSTRUCTION QUALITY ASSURANCE TESTING"
- B. ASPHALT CONCRETE (A.C.) SHALL BE INSTALLED AND CONFORM WITH YOLO COUNTY'S STANDARD SPECIFICATIONS PER SECTION 2, TABLE 1 "CONSTRUCTION QUALITY ASSURANCE TESTING"
- C. SUBGRADE PREPARATION SHALL CONFORM TO YOLO COUNTY'S STANDARD SPECIFICATIONS PER SECTION 2, TABLE 1 "CONSTRUCTION QUALITY ASSURANCE TESTING", AND THE REQUIREMENTS OF THE PROJECT'S GEOTECHNICAL REPORT UNLESS SPECIFICALLY NOTED OTHERWISE.
- D. ALL OFF-SITE NON-DECORATIVE AC PAVEMENTS SHALL RECEIVE A FOG SEAL IN ACCORDANCE WITH SECTION 37 OF THE CALTRANS STANDARD SPECIFICATIONS PRIOR TO STRIPING. DECORATIVE PAVEMENTS AND P.C.C. AREAS SHALL BE ADEQUATELY PROTECTED FROM OVERSPRAY, AND CONTRACTOR SHALL BE RESPONSIBLE FOR CLEANUP OF OVER-APPLIED FOG SEAL.
- 3. THE PAVING CONTRACTOR SHALL ADJUST ALL MANHOLE, LAMPHOLE AND WATER VALVE CASTINGS AND COVERS TO FINISH GRADE AFTER PAVEMENT IMPROVEMENTS ARE COMPLETE.

#### STRIPING AND SIGNAGE NOTES:

- 1. ALL SIGNING AND STRIPING WORK SHALL CONFORM TO STATE OF CALIFORNIA DEPARTMENT OF TRANSPORTATION STANDARD SPECIFICATIONS AND STANDARD PLANS, THE LATEST EDITION OF THE CITY STANDARDS, THE LATEST EDITION OF THE STATE OF CALIFORNIA MANUAL ON UNIFORM TRAFFIC CONTROL DEVICES, UNIFORM SIGN CHART, THE CALIFORNIA DEPARTMENT OF TRANSPORTATION HIGHWAY DESIGN MANUAL AND THESE NOTES.
- 2. THE DETAILS REFERRED HEREIN ARE THOSE AS SHOWN IN THE CALIFORNIA MANUAL ON UNIFORM TRAFFIC CONTROL DEVICES (NOVEMBER 7, 2014).
- 3. THE CONTRACTOR SHALL REMOVE ALL EXISTING PAVEMENT MARKINGS AND APPURTENANCES, AS REQUIRED, TO INSTALL THE NEW STRIPING SHOWN ON THIS PLAN. USE OF WATER BLASTING FOR ALL EXISTING STRIPE REMOVAL THAT WILL NOT BE PAVED OVER PRIOR TO THE PROJECT COMPLETION IS A REQUIREMENT. METHOD OF APPROVAL TO BE APPROVED BY CALTRANS.
- 4. THE LIMITS AND LAYOUT OF THE STRIPING. INCLUDING "NO PARKING" ZONES. SHALL BE PRELINED BY THE CONTRACTOR WITH SUPERVISION OF CALTRANS...
- THE CONTRACTOR SHALL WORK WITH YOLO COUNTY'S ENGINEERING DIVISION AND CALTRANS TO ENSURE PROPER LAYOUT OF TRAFFIC STRIPING PRIOR TO INSTALLATION. CONTRACTOR SHALL "CAT-TRACK" ALL TRAFFIC STRIPES AND LANE LINES AND OBTAIN APPROVAL FROM THE TRAFFIC AND COUNTY ENGINEER BEFORE APPLYING THERMOPLASTIC OR PAVEMENT MARKERS.
- 6. ALL MARKINGS WITHIN THE PUBLIC RIGHT—OF—WAY TO BE INSTALLED WITH THERMOPLASTIC AND / OR RAISED PAVEMENT MARKERS EXCEPT AS NOTED ON THE PLAN.
- 7. WHITE THERMOPLASTIC TO BE USED EXCEPT WHERE YELLOW THERMOPLASTIC IS CALLED FOR ON THE PLANS. ENHANCED WET NIGHT VISIBILITY THERMOPLASTIC MUST BE USED IN ACCORDANCE WITH THE CALTRANS STANDARDS AND SPECIFICATIONS.
- 8. SIGN POSTS SHALL CONFORM TO THE YOLO COUNTY STANDARD DRAWINGS NO. 4-28, SHEETS 1-3.

#### STORM DRAIN NPDES PERMIT:

TO COMPLY WITH THE STATE OF CALIFORNIA'S STATEWIDE GENERAL NPDES PERMIT. REGULATING DISCHARGES OF STORM WATER ASSOCIATED WITH CONSTRUCTION ACTIVITY FROM SOIL DISTURBANCES OF 1 ACRE OR MORE. A NOTICE OF INTENT (N.O.I.) TO COMPLY WITH THE TERMS OF THE GENERAL PERMIT TO DISCHARGE STORM WATER ASSOCIATED WITH CONSTRUCTION ACTIVITY MUST BE FILED AND APPROPRIATE FEE PAID PRIOR TO COMMENCEMENT OF CONSTRUCTION. THE N.O.I. CAN BE OBTAINED BY ENTERING THE PROJECT INFORMATION AND UPLOADING THE PROJECT SWPPP ONTO THE SMARTS WEBSITE. IN ADDITION, AT THE CONCLUSION OF THE PROJECT, A NOTICE OF TERMINATION (N.O.T.) MUST ALSO BE FILED. SUBMIT THE FEE, N.O.I., AND N.O.T. TO THE STATE WATER RESOURCES CONTROL BOARD VIA THE SMARTS WEBSITE.

STATE WATER RESOURCES CONTROL BOARD SMARTS WEBSITE ADDRESS: HTTPS: //SMARTS.WATERBOARDS.CA.GOV/SMARTS/FACES/SWSMARTSLOGIN.XHTML

NOI FILE L	)A	
WDID NO:		

#### MVE - TRAFFIC CONTROL

- 1. THE CONTRACTOR SHALL REMOVE AND REPLACE ALL EXISTING PAVEMENT MARKINGS THAT WOULD CONFLICT WITH EXISTING TRAFFIC PATTERNS. THE CONTRACTOR WILL BE RESPONSIBLE FOR ANY TEMPORARY STRIPING REQUIRED. ALL PROPOSED STRIPING SHALL BE PAINTED ONLY.
- THE CONTRACTOR SHALL PROVIDE AND MAINTAIN A SAFE AND ADEQUATE MEANS OF CHANNELIZING PEDESTRIAN TRAFFIC AROUND ALL WORK AREAS THROUGHOUT THE PERIOD OF CONSTRUCTION. ALL SUCH CHANNELIZATION SHALL BE ARRANGED TO PREVENT PEDESTRIANS FROM HAVING TO ENTER THE ROADWAY IN ORDER TO PASS AROUND THE WORK AREA.
- MAINTENANCE OF TRAFFIC: THE CONTRACTOR SHALL CONDUCT HIS WORK TO INTERFERE AS LITTLE AS POSSIBLE WITH PUBLIC TRAVEL, WHETHER VEHICULAR OR PEDESTRIAN. WHENEVER IT IS NECESSARY TO CROSS, OBSTRUCT, OR CLOSE ROADS, DRIVEWAYS AND WALKS, WHETHER PUBLIC OR PRIVATE, THE CONTRACTOR SHALL PROVIDE AND MAINTAIN SUITABLE AND SAFE DETOURS, OR TEMPORARY EXPEDIENTS FOR THE ACCOMMODATION OF PUBLIC AND PRIVATE TRAVEL AND SHALL GIVE REASONABLE NOTICE TO OWNERS OF PRIVATE DRIVES BEFORE INTERFERING WITH THEM. SUCH MAINTENANCE OF TRAFFIC WILL NOT BE REQUIRED WHEN THE CONTRACTOR HAS OBTAINED PERMISSION FROM THE OWNER AND TENANT OF PRIVATE PROPERTY, OR FROM AUTHORITY HAVING JURISDICTION OVER PUBLIC PROPERTY INVOLVED, TO OBSTRUCT TRAFFIC AT THE DESIGNATED POINT.
- 4. THE CONTRACTOR SHALL ADHERE TO ALL REQUIREMENTS OF THE LATEST EDITION OF THE STATE OF CALIFORNIA, MANUAL OF TRAFFIC CONTROLS FOR CONSTRUCTION AND MAINTENANCE ZONES. ANY PROPOSED DEVIATION OR MODIFICATIONS TO THESE TRAFFIC CONTROL REQUIREMENTS SHALL BE SUBMITTED TO THE COUNTY FOR APPROVAL.
- 5. THE CONTRACTOR SHALL COMPLY WITH ALL LOCAL, STATE, AND FEDERAL SAFETY REGULATIONS PERTAINING TO HIS OPERATIONS. HE SHALL PROVIDE ALL LIGHTS, SIGNS, BARRICADES, FLAG MEN OR OTHER DEVICES NECESSARY FOR PUBLIC SAFETY. THE CONTRACTOR'S ATTENTION IS CALLED TO THE REQUIREMENTS OF TITLE 8, CALIFORNIA ADMINISTRATIVE CODE, SUBCHAPTER 4, ARTICLE 6, "EXCAVATIONS, TRENCHES, EARTHWORK."
- 6. BARRICADES AND LIGHTS: ALL STREETS, ROADS, HIGHWAYS, AND OTHER PUBLIC THOROUGHFARES WHICH ARE CLOSED TO TRAFFIC SHALL BE PROTECTED BY EFFECTIVE BARRICADES ON WHICH SHALL BE PLACED ACCEPTABLE WARNING SIGNS. BARRICADES SHALL BE LOCATED AT THE NEAREST INTERSECTING STREET ON EACH SIDE OF THE BLOCKED SECTION AS INDICATED ON THE PLAN OR AS REQUIRED BY AUTHORITY HAVING
- 7. ALL BARRICADES AND OBSTRUCTIONS SHALL BE ILLUMINATED WITH WARNING LIGHTS FROM SUNSET TO SUNRISE. MATERIAL STORAGE AND CONDUCT OF THE WORK ON OR ALONGSIDE PUBLIC STREETS AND HIGHWAYS SHALL CAUSE THE MINIMUM OBSTRUCTION AND INCONVENIENCE TO THE TRAVELING PUBLIC.
- ALL BARRICADES, SIGNS, LIGHTS AND OTHER PROTECTIVE DEVICES SHALL BE INSTALLED AND MAINTAINED IN CONFORMITY WITH APPLICABLE STATUTORY REQUIREMENTS AND, WHERE WITHIN HIGHWAY RIGHT-OF-WAY, AS REQUIRED BY THE AUTHORITY HAVING JURISDICTION THEREOVER.
- 9. NOTICES TO OWNERS AND AUTHORITIES: THE CONTRACTOR SHALL NOTIFY OWNERS OF ADJACENT PROPERTIES AND UTILITIES WHEN PROSECUTION OF THE WORK MAY AFFECT THEM. WHEN IT IS NECESSARY TO TEMPORARILY DENY ACCESS TO PROPERTY, OR WHEN ANY UTILITY SERVICE CONNECTION MUST BE INTERRUPTED, THE CONTRACTOR SHALL GIVE NOTICES NOT LESS THAN 48 HOURS IN ADVANCE TO ENABLE THE AFFECTED PERSONS TO PROVIDE FOR THEIR NEEDS. NOTICES WILL CONFORM TO ANY APPLICABLE LOCAL ORDINANCE AND, WHETHER DELIVERED ORALLY OR IN WRITING, WILL INCLUDE APPROPRIATE INFORMATION CONCERNING THE INTERRUPTION AND INSTRUCTIONS ON HOW TO LIMIT THEIR INCONVENIENCE.
- 10. UTILITIES AND OTHER CONCERNED AGENCIES SHALL BE CONTACTED AT LEAST 48 HOURS PRIOR TO CUTTING OR CLOSING A STREET OR OTHER TRAFFIC AREA. EXCAVATING NEAR UNDERGROUND UTILITIES OR POLE LINES. OR PERFORMING WORK WHICH AFFECT THEIR OPERATIONS. THE CONTRACTOR SHALL CONTACT UNDERGROUND SERVICE ALERT AT ( 800 ) 642-2444 TO LOCATE ALL UNDERGROUND UTILITIES PRIOR TO CONSTRUCTION.
- 11. SITE ADMINISTRATION: THE CONTRACTOR SHALL BE RESPONSIBLE FOR ALL AREAS OF THE SITE USED BY THEM AND ALL SUBCONTRACTORS IN THE PERFORMANCE OF THE WORK. THE CONTRACTOR WILL EXERT FULL CONTROL OVER ALL THE ACTIONS OF ALL EMPLOYEES AND OTHER PERSONS WITH RESPECT TO THE USE AND PRESERVATION OF PROPERTY AND FACILITIES, EXCEPT SUCH CONTROLS AS MAY BE SPECIFICALLY RESERVED TO THE OWNER OR OTHERS. THE CONTRACTOR HAS THE RIGHT TO EXCLUDE FROM THE SITE ALL PERSONS WHO HAVE NO PURPOSE RELATED TO THE WORK OR ITS INSPECTION, AND MAY REQUIRE ALL PERSONS ON THE SITE ( EXCEPT OWNERS EMPLOYEES ) TO OBSERVE THE SAME REGULATIONS AS THEY REQUIRE OF THEIR EMPLOYEES.
- 12. THE CONTRACTOR SHALL PREPARE A TRAFFIC CONTROL PLAN AND SUBMIT TO THE COUNTY FOR APPROVAL PRIOR TO CONSTRUCTION. THE CONTRACTOR SHALL MAINTAIN TRAFFIC & ACCESS TO DRIVEWAYS AT ALL TIMES.
- 13. ALL CONSTRUCTION VEHICLES (E.G. CEMENT TRUCKS, GRADERS, TRACTORS, ETC.) SHALL USE A DESIGNATED TRAVEL ROUTE TO THE CONSTRUCTION SITE. THE DESIGNATED ROUTE SHALL BY-PASS THE TOWN OF ESPARTO. THE DESIGNATED TRAVEL ROUTE SHALL BE LIMITED TO STATE ROUTE 16 WEST TO COUNTY ROAD 21A; THENCE NORTH ON COUNTY ROAD 85B; THENCE EAST ON STATE ROUTE 16. ANY DEVIATION IN TRAFFIC ROUTES SHALL BE SUBJECT TO THE APPROVAL OF THE PLANNING AND PUBLIC WORKS DIRECTOR.
- 14. THE CONTRACTOR SHALL INSTALL FENCING ALONG SOUTHERN BOUNDARY OF THE PROJECT TO PROHIBIT VEHICULAR AND PEDESTRIAN TRAFFIC TO/FROM THE SOUTH.

DIST	COUNTY	ROUTE	POST MILE	SHEET NO.	TOTAL SHEETS
3	YOL	16	27.00/34.25	2	8

Know what's below.


Call before you dig.

PRIOR TO CONSTRUCTION THE CONTRACTOR SHALL CALL UNDERGROUND SERVICE ALERT FOR UNDERGROUND CLEARANCE. USA WILL PROVIDE INFORMATION ABOUT OR LOCATE AND MARK UNDERGROUND FACILITIES.

### UNAUTHORIZED CHANGES & USE

THE ENGINEER PREPARING THESE PLANS WILL NOT BE RESPONSIBLE FOR, OR LIABLE FOR, UNAUTHORIZED CHANGES TO OR USES OF THESE PLANS. ALL CHANGES TO THE PLANS MUST BE IN WRITING AND MUST BE APPROVED BY THE PREPARER OF THESE PLANS.

	Drawn By:	RG/JSH			REVISI	0 N S		
ES	Issue Date:	0 /15 /22	NO.	DATE	ISSUED	FOR	BY	
	issue Date:	9/13/22						
	Job No.: No	C07254E						RFC
	Checked:	DAM						1
)	Design By:	RG/JSH						"
<b>'</b>		,						(

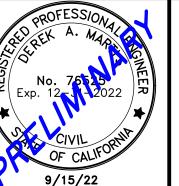

1117 L Street, Modesto, CA 95354 | 866.526.4214 | www.mve.net Northern California | Southern California | Nevada

STATE OF CALIFORNIA DEPARTMENT OF TRANSPORTATION STATE HIGHWAY 16 IMPROVEMENTS

GENERAL NOTES


AND SPECIFICATIONS


SHEET

DWG.

GN1

CALIFORNIA | OF\_ YOLO COUNTY

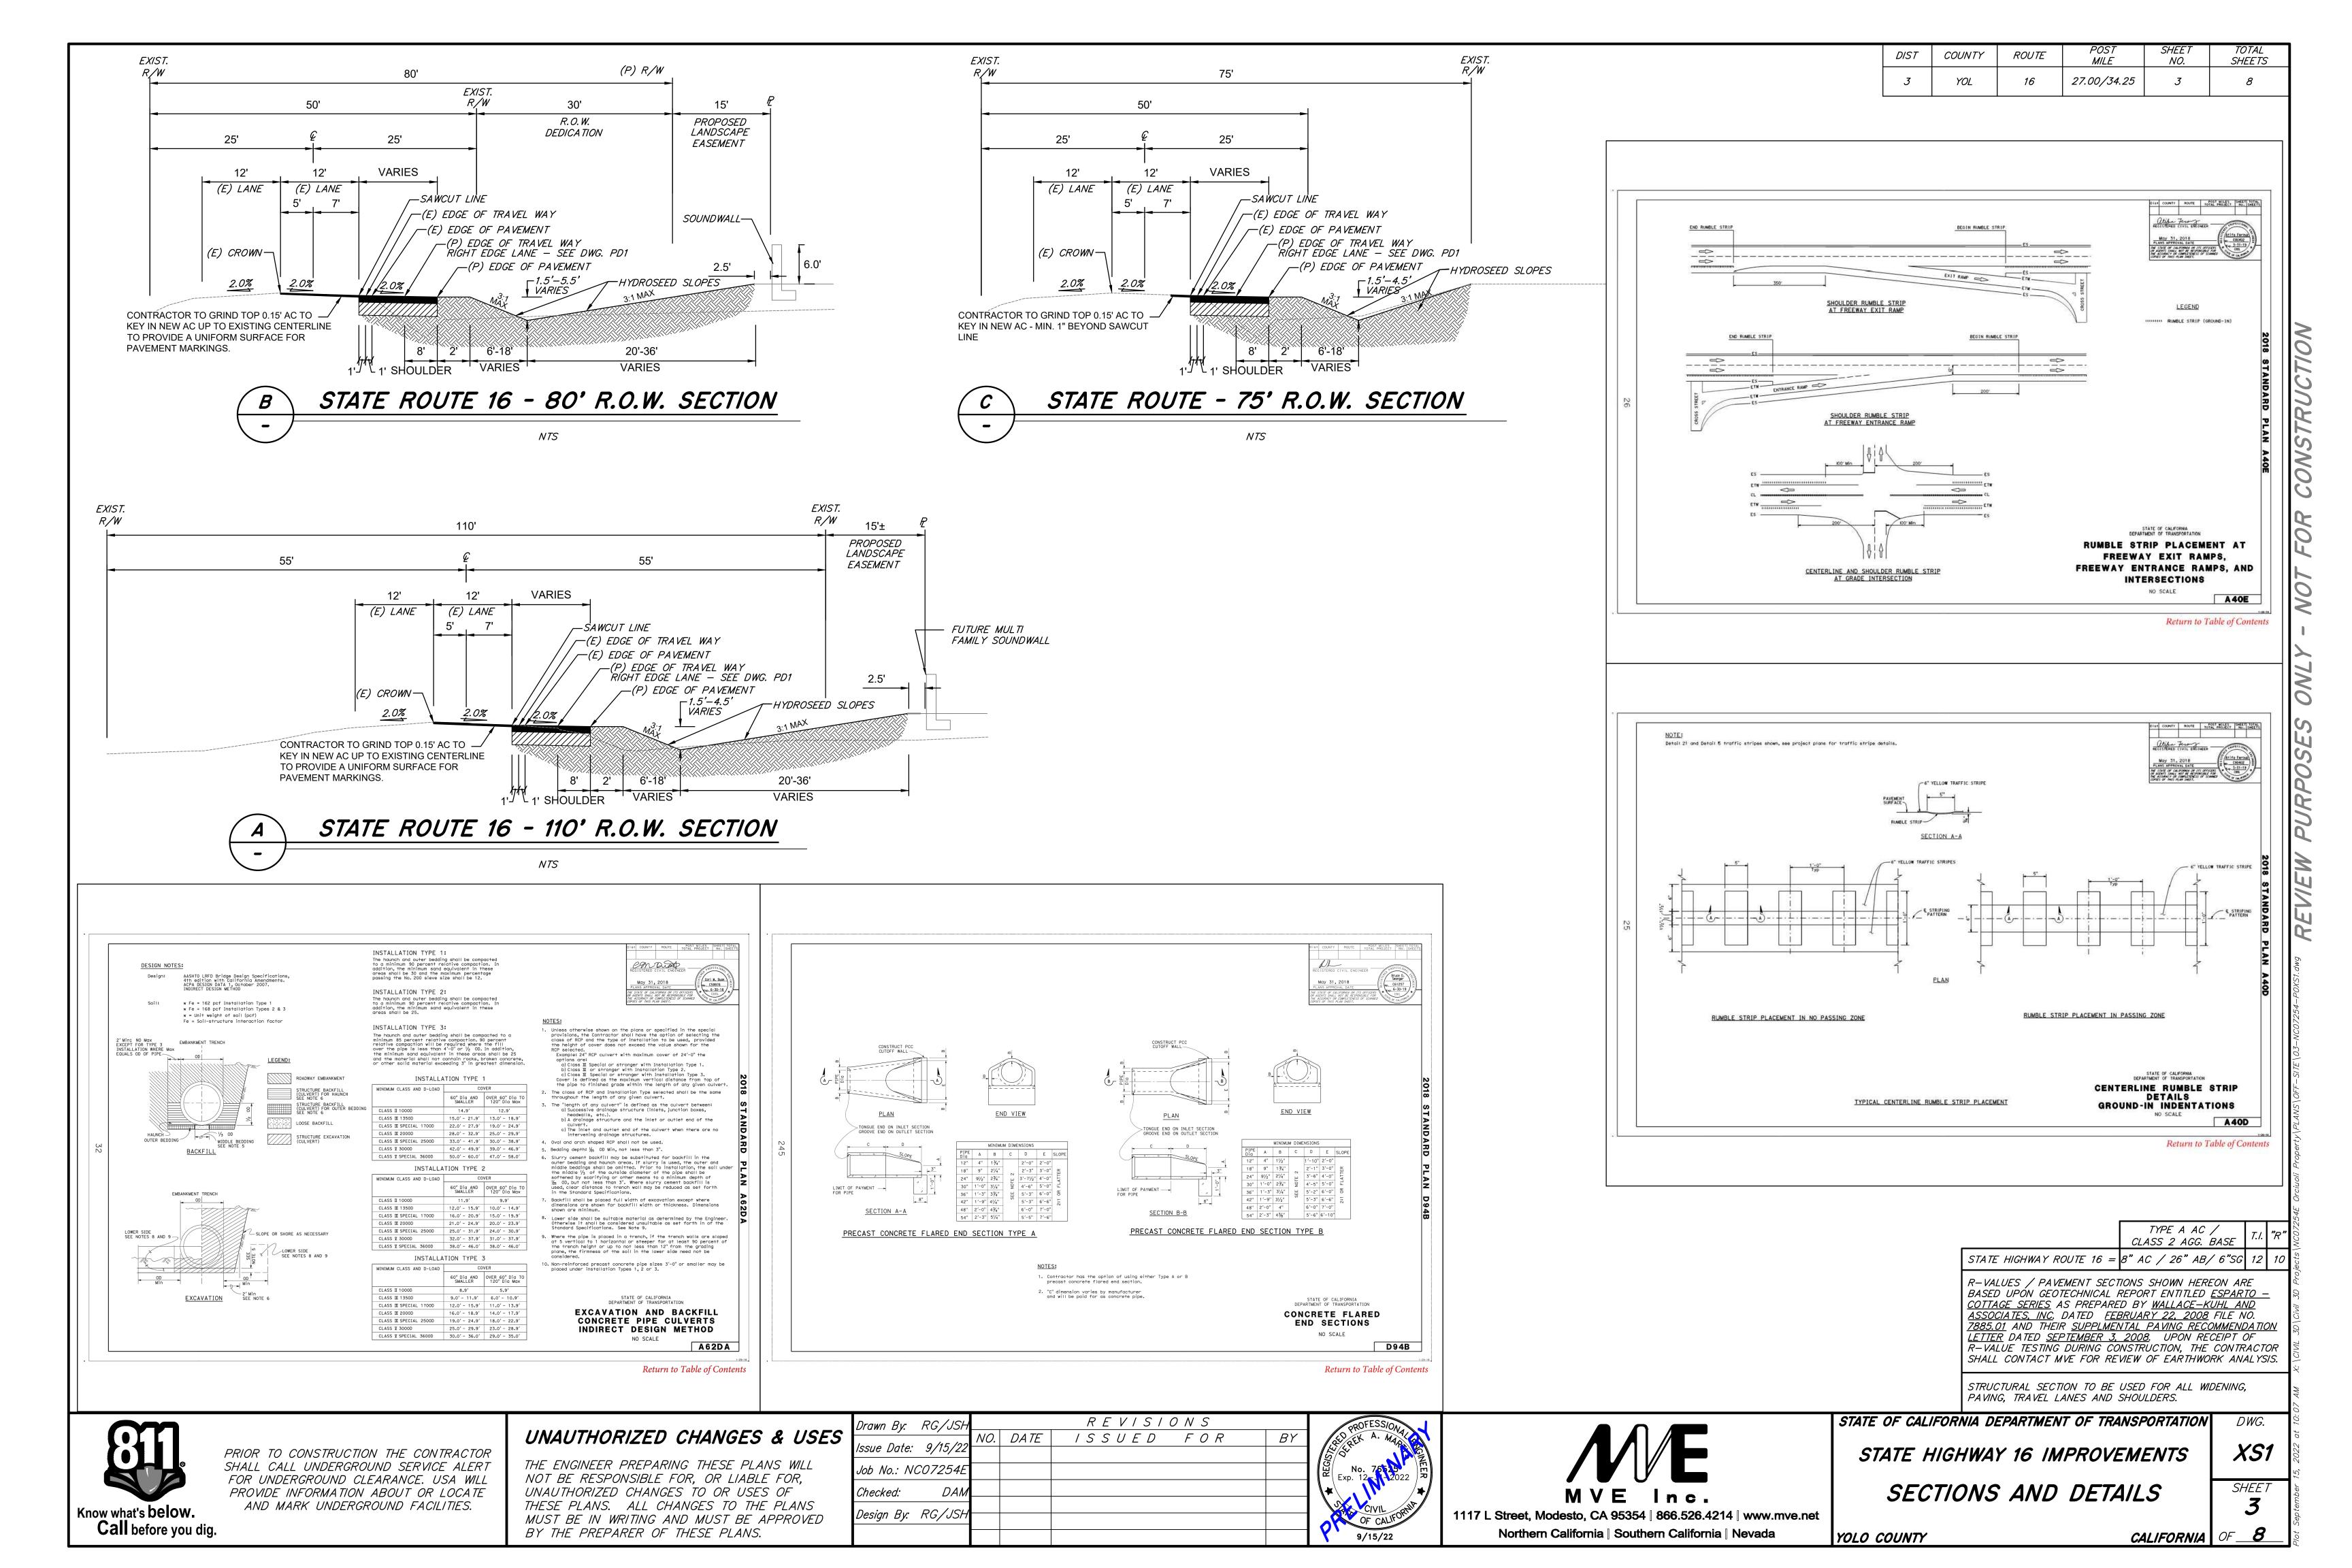

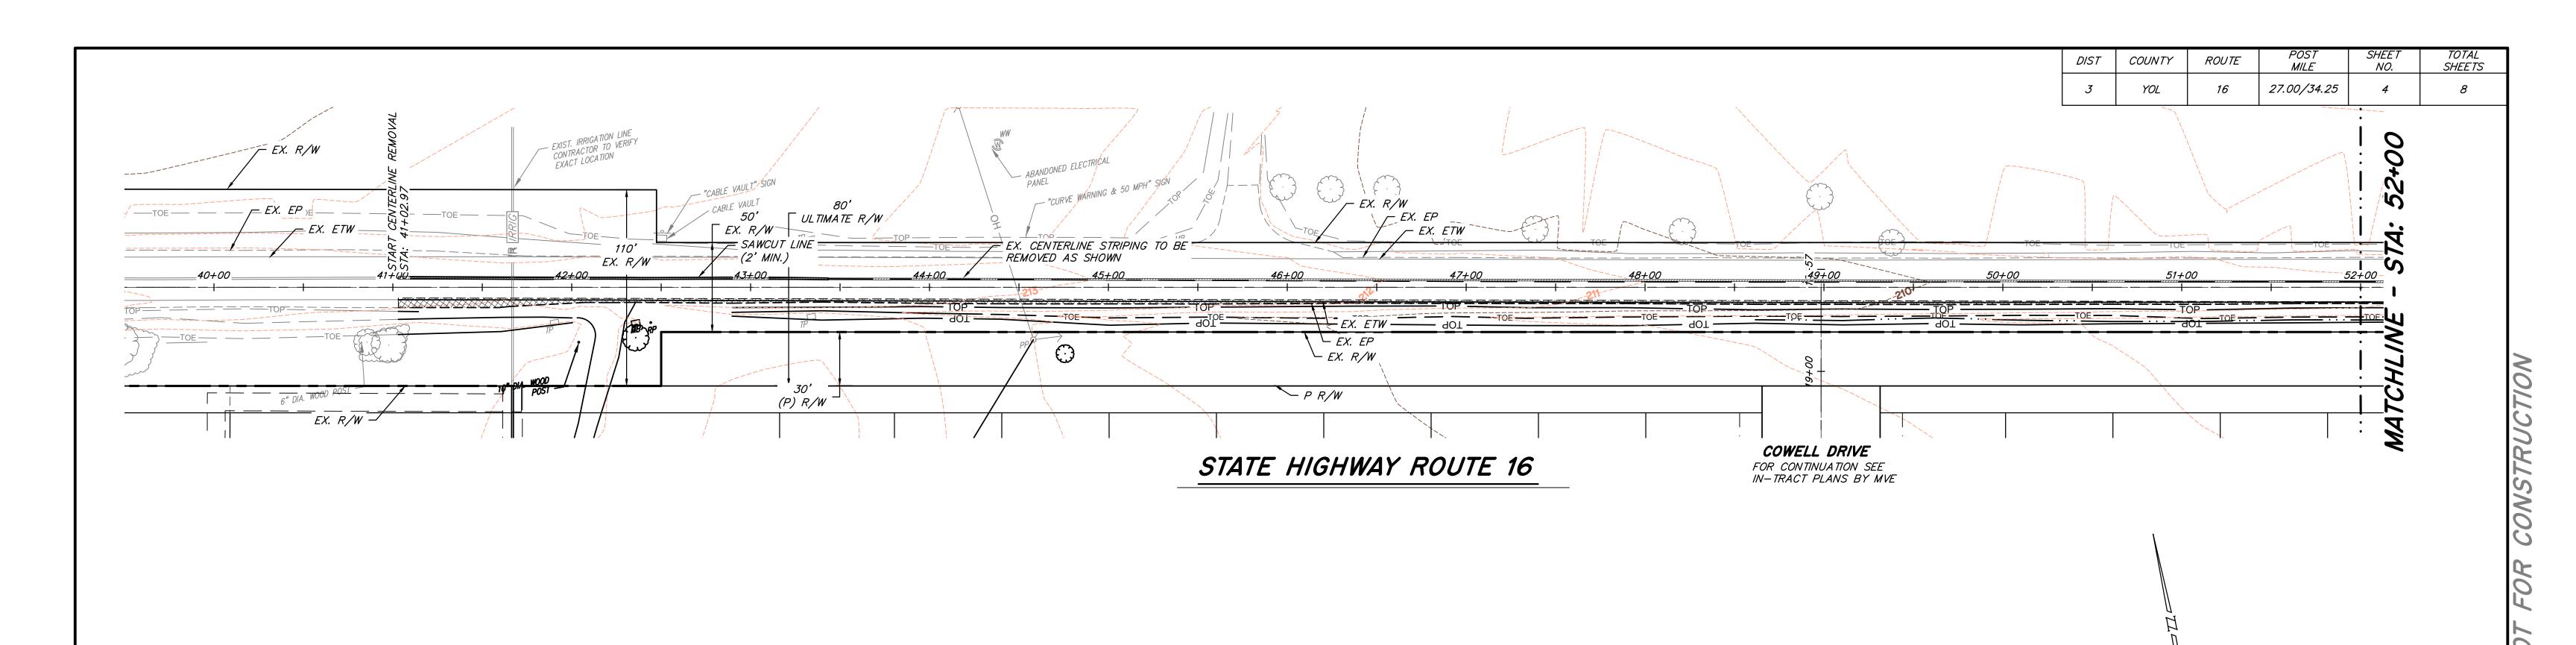

### NOTES

- 1. CONTRACTOR TO REMOVE AND DISPOSE OF ALL SEPTIC SYSTEM APPURTENANCES, INCLUDING, BUT NOT LIMITED TO, SEPTIC TANKS, LEACH FIELDS. CONTRACTOR IS RESPONSIBLE TO OBTAIN ALL APPROPRIATE PERMITS AND INSPECTIONS THAT MAY BE REQUIRED IN ACCORDANCE WITH CITY / COUNTY DEPARTMENT OF ENVIRONMENTAL HEALTH REQUIREMENTS
- 2. CONTRACTOR IS RESPONSIBLE TO PROPERLY ABANDON ALL WELLS ON THE SITE.
  CONTRACTOR IS RESPONSIBLE TO OBTAIN ALL APPROPRIATE PERMITS AND INSPECTIONS
  THAT MAY BE REQUIRED IN ACCORDANCE WITH CITY / COUNTY DEPARTMENT OF
  ENVIRONMENTAL HEALTH REQUIREMENTS.
- 3. CONTRACTOR SHALL COORDINATE ALL OVERHEAD UTILITY RELOCATION AND REMOVAL WITH THE RESPECTIVE UTILITY COMPANIES.
- 4. CONTRACTOR SHALL BE RESPONSIBLE TO COORDINATE BETWEEN ADJACENT PROPERTY OWNERS REGARDING FENCE REMOVALS AND RELOCATIONS ALONG SHARED PROPERTY LINES. WRITTEN PERMISSION FROM, OR FORMAL AGREEMENTS WITH, ADJACENT PROPERTY OWNERS SHALL BE PROCESSED TO THE SATISFACTION OF THE CITY / COUNTY PRIOR TO DEMOLITION OF FENCES.
- 5. CONTRACTOR SHALL CAP ALL IRRIGATION LINES WITH A WATER TIGHT SEAL AT THE PROPERTY LINE AND REMOVE ALL PIPING AND STRUCTURES FROM THE SITE. CONTRACTOR SHALL COORDINATE ALL WORK WITH THE IRRIGATION DISTRICT.
- 6. THE CONTRACTOR SHALL REMOVE THE EXISTING HOUSE, SHEDS, GARAGE AND ALL OTHER BUILDINGS AND APPURTENANCES.
- 7. THE CONTRACTOR SHALL OBTAIN A DEMOLITION PERMIT FROM BUILDING DEPARTMENT, IF REQUIRED, PRIOR TO BEGINNING WORK.
- 8. ALL CONCRETE SHALL BE SAWCUT IN NEAT STRAIGHT LINES AT THE NEAREST CRACK CONTROL JOINT.
- 9. ALL TREES ARE TO BE REMOVED WITHIN THIS PROJECT'S LIMITS PRIOR TO CONSTRUCTION.
- 10. THE CONTRACTOR SHALL REMOVE ALL VEGETATION AND DELETERIOUS MATERIALS FROM THE SITE UNLESS NOTED OTHERWISE, ALL EXISTING WELLS AND SEPTIC TANKS SHALL BE REMOVED AND/OR ABANDONED PER THE REQUIREMENTS OF ALL LOCAL, STATE AND FEDERAL REGULATIONS. THE COST TO PERFORM THIS WORK SHALL BE INCLUDED IN THE LUMP SUM CLEARING COST.
- 11. USE OF WATER BLASTING FOR ALL EXISTING STRIPE REMOVAL THAT WILL NOT BE PAVED OVER PRIOR TO PRIJECT COMPLETION IS A REQUIREMENT.

### UTILITY NOTES

EXISTING UNDERGROUND UTILITIES SHOWN ARE TAKEN FROM RECORD INFORMATION TO AID THE CONTRACTOR. CONTRACTOR SHALL VERIFY LOCATION ( BOTH VERTICAL AND HORIZONTAL ) OF ALL EXISTING UNDERGROUND LINES AND NOTIFY ENGINEER OF ANY DISCREPANCIES OR CONFLICTS PRIOR TO WORK.

A) EXISTING UTILITIES ARE SHOWN AS THEY ARE BELIEVED TO EXIST FROM RECORDS BY OTHERS. THE OWNER AND ENGINEER DO NOT ACCEPT RESPONSIBILITY FOR THEIR ACCURACY. PRIOR TO COMMENCING WORK, THE CONTRACTOR SHALL HAVE EACH UTILITY COMPANY ACCURATELY LOCATE IN THE FIELD THEIR MAINS AND SERVICE LINES. IT SHALL BE THE CONTRACTOR'S RESPONSIBILITY TO PROTECT ALL EXISTING UTILITIES, SO THAT NO DAMAGE RESULTS TO THEM DURING THE PERFORMANCE OF THIS CONTRACT. CONTACT U.S.A. AT PHONE NO. 800–227–2600.

NOTE: SECTION 1540 (A) (1) OF THE CONSTRUCTION SAFETY ORDERS (TITLE 8 CALIFORNIA ADMINISTRATION CODE SECTION 1540) ISSUED BY THE OCCUPATIONAL SAFETY AND HEALTH STANDARDS BOARD PURSUANT TO THE CALIFORNIA OCCUPATIONAL SAFETY AND HEALTH ACT OF 1973 AS AMENDED, WHICH STATES:

"PRIOR TO OPENING AN EXCAVATION, EFFORT SHALL BE MADE TO DETERMINE WHETHER UNDERGROUND INSTALLATION I.E., SEWER, WATER, FUEL, ELECTRIC LINES, ETC. WILL BE ENCOUNTERED AND IF SO, WHERE SUCH UNDERGROUND INSTALLATIONS ARE LOCATED. WHEN EXCAVATION APPROACHES THE APPROXIMATE LOCATION OF SUCH AN INSTALLATION, THE EXACT LOCATION SHALL BE DETERMINED BY CAREFUL PROBING OR HAND DIGGING AND WHEN IT IS UNCOVERED, ADEQUATE PROTECTION SHALL BE PROVIDED FOR THE INSTALLATION. ALL KNOWN OWNERS OF UNDERGROUND FACILITIES IN THE AREA CONCERNED SHALL BE ADVISED OF PROPOSED WORK AT LEAST 48 HOURS PRIOR TO THE START OF ACTUAL EXCAVATION."

### LEGEND

SAWCUT AND REMOVE PAVEMENT

.....

GRIND EX. PAVEMENT MARKING AND CHIP SEAL AND OVERLAY WITH DENSE GRADE OR OPEN GRADE A.C.

SCALE: 1" = 40'

Know what's below.

Call before you dig.

PRIOR TO CONSTRUCTION THE CONTRACTOR
SHALL CALL UNDERGROUND SERVICE ALERT
FOR UNDERGROUND CLEARANCE. USA WILL
PROVIDE INFORMATION ABOUT OR LOCATE
AND MARK UNDERGROUND FACILITIES.

#### UNAUTHORIZED CHANGES & USES

THE ENGINEER PREPARING THESE PLANS WILL NOT BE RESPONSIBLE FOR, OR LIABLE FOR, UNAUTHORIZED CHANGES TO OR USES OF THESE PLANS. ALL CHANGES TO THE PLANS MUST BE APPROVED BY THE PREPARER OF THESE PLANS.

Drawn By: RG/JSH			REVISI	0 N S		
Issue Date: 9/15/22	NO.	DATE	ISSUED	FOR	BY	
155ue Dute. 9/15/22						
Job No.: NC07254E						REGISTES
Checked: DAM						<b>   </b> *
Design By: RG/JSH						
						<b>  </b>



MVE Inc.

1117 L Street, Modesto, CA 95354 | 866.526.4214 | www.mve.net

Northern California | Southern California | Nevada

STATE OF CALIFORNIA DEPARTMENT OF TRANSPORTATION

STATE HIGHWAY 16 IMPROVEMENTS

YOLO COUNTY


TOPOGRAPHY SURVEY AND DEMOLITION PLAN

CALIFORNIA OF 8

SHEET **4**A OF **8** 

DWG.

**TO1** 

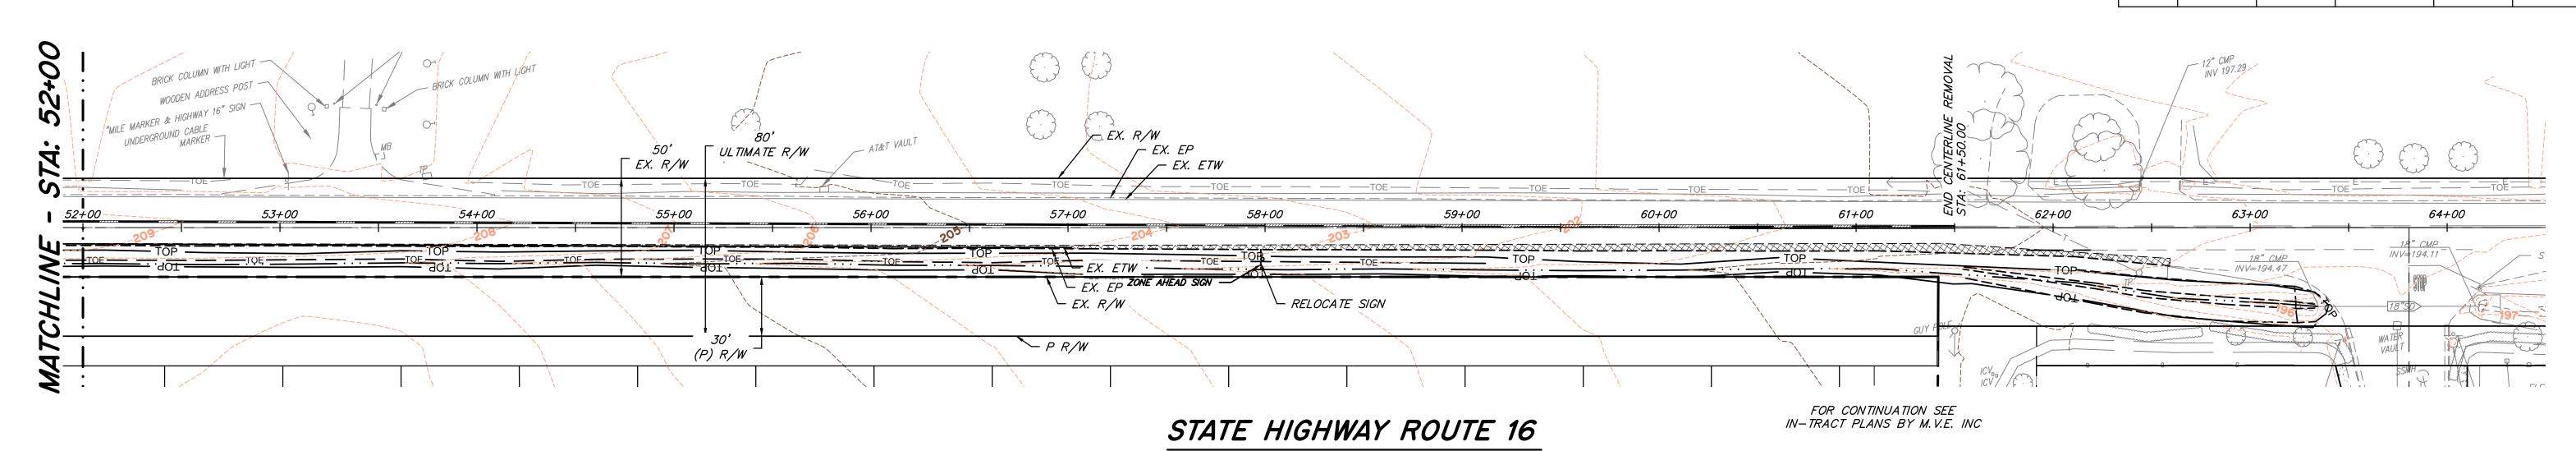

#### **NOTES**

- CONTRACTOR TO REMOVE AND DISPOSE OF ALL SEPTIC SYSTEM APPURTENANCES, INCLUDING, BUT NOT LIMITED TO, SEPTIC TANKS, LEACH FIELDS. CONTRACTOR IS RESPONSIBLE TO OBTAIN ALL APPROPRIATE PERMITS AND INSPECTIONS THAT MAY BE REQUIRED IN ACCORDANCE WITH CITY / COUNTY DEPARTMENT OF ENVIRONMENTAL HEALTH
- 2. CONTRACTOR IS RESPONSIBLE TO PROPERLY ABANDON ALL WELLS ON THE SITE. CONTRACTOR IS RESPONSIBLE TO OBTAIN ALL APPROPRIATE PERMITS AND INSPECTIONS THAT MAY BE REQUIRED IN ACCORDANCE WITH CITY / COUNTY DEPARTMENT OF ENVIRONMENTAL HEALTH REQUIREMENTS.
- 3. CONTRACTOR SHALL COORDINATE ALL OVERHEAD UTILITY RELOCATION AND REMOVAL WITH THE RESPECTIVE UTILITY COMPANIES.
- 4. CONTRACTOR SHALL BE RESPONSIBLE TO COORDINATE BETWEEN ADJACENT PROPERTY OWNERS REGARDING FENCE REMOVALS AND RELOCATIONS ALONG SHARED PROPERTY LINES. WRITTEN PERMISSION FROM, OR FORMAL AGREEMENTS WITH, ADJACENT PROPERTY OWNERS SHALL BE PROCESSED TO THE SATISFACTION OF THE CITY / COUNTY PRIOR TO DEMOLITION OF FENCES.
- 5. CONTRACTOR SHALL CAP ALL IRRIGATION LINES WITH A WATER TIGHT SEAL AT THE PROPERTY LINE AND REMOVE ALL PIPING AND STRUCTURES FROM THE SITE. CONTRACTOR SHALL COORDINATE ALL WORK WITH THE IRRIGATION DISTRICT.
- 6. THE CONTRACTOR SHALL REMOVE THE EXISTING HOUSE, SHEDS, GARAGE AND ALL OTHER BUILDINGS AND APPURTENANCES.
- 7. THE CONTRACTOR SHALL OBTAIN A DEMOLITION PERMIT FROM BUILDING DEPARTMENT, IF REQUIRED, PRIOR TO BEGINNING WORK. 8. ALL CONCRETE SHALL BE SAWCUT IN NEAT STRAIGHT LINES AT THE NEAREST CRACK
- CONTROL JOINT.

9. ALL TREES ARE TO BE REMOVED WITHIN THIS PROJECT'S LIMITS PRIOR TO CONSTRUCTION.

- 10. THE CONTRACTOR SHALL REMOVE ALL VEGETATION AND DELETERIOUS MATERIALS FROM THE SITE UNLESS NOTED OTHERWISE, ALL EXISTING WELLS AND SEPTIC TANKS SHALL BE REMOVED AND/OR ABANDONED PER THE REQUIREMENTS OF ALL LOCAL, STATE AND FEDERAL REGULATIONS. THE COST TO PERFORM THIS WORK SHALL BE INCLUDED IN THE LUMP SUM CLEARING COST.
- 11. USE OF WATER BLASTING FOR ALL EXISTING STRIPE REMOVAL THAT WILL NOT BE PAVED OVER PRIOR TO PROJECT COMPETITION IS A REQUIREMENT

AND MARK UNDERGROUND FACILITIES.


### UTILITY NOTES

EXISTING UNDERGROUND UTILITIES SHOWN ARE TAKEN FROM RECORD INFORMATION TO AID THE CONTRACTOR. CONTRACTOR SHALL VERIFY LOCATION ( BOTH VERTICAL AND HORIZONTAL ) OF ALL EXISTING UNDERGROUND LINES AND NOTIFY ENGINEER OF ANY DISCREPANCIÉS OR CONFLICTS PRIOR TO WORK.

A ) EXISTING UTILITIES ARE SHOWN AS THEY ARE BELIEVED TO EXIST FROM RECORDS BY OTHERS. THE OWNER AND ENGINEER DO NOT ACCEPT RESPONSIBILITY FOR THEIR ACCURACY. PRIOR TO COMMENCING WORK, THE CONTRACTOR SHALL HAVE EACH UTILITY COMPANY ACCURATELY LOCATE IN THE FIELD THEIR MAINS AND SERVICE LINES. IT SHALL BE THE CONTRACTOR'S RESPONSIBILITY TO PROTECT ALL EXISTING UTILITIES, SO THAT NO DAMAGE RESULTS TO THEM DURING THE PERFORMANCE OF THIS CONTRACT. CONTACT U.S.A. AT PHONE NO. 800-227-2600.

NOTE: SECTION 1540 (A) (1) OF THE CONSTRUCTION SAFETY ORDERS (TITLE 8 CALIFORNIA ADMINISTRATION CODE SECTION 1540 ) ISSUED BY THE OCCUPATIONAL SAFETY AND HEALTH STANDARDS BOARD PURSUANT TO THE CALIFORNIA OCCUPATIONAL SAFETY AND HEALTH ACT OF 1973 AS AMENDED, WHICH STATES:

" PRIOR TO OPENING AN EXCAVATION , EFFORT SHALL BE MADE TO DETERMINE WHETHER UNDERGROUND INSTALLATION I.E., SEWER, WATER, FUEL, ELECTRIC LINES, ETC. WILL BE ENCOUNTERED AND IF SO , WHERE SUCH UNDERGROUND INSTALLATIONS ARE LOCATED. WHEN EXCAVATION APPROACHES THE APPROXIMATE LOCATION OF SUCH AN INSTALLATION , THE EXACT LOCATION SHALL BE DETERMINED BY CAREFUL PROBING OR HAND DIGGING AND WHEN IT IS UNCOVERED, ADEQUATE PROTECTION SHALL BE PROVIDED FOR THE INSTALLATION. ALL KNOWN OWNERS OF UNDERGROUND FACILITIES IN THE AREA CONCERNED SHALL BE ADVISED OF PROPOSED WORK AT LEAST 48 HOURS PRIOR TO THE START OF ACTUAL EXCAVATION. "

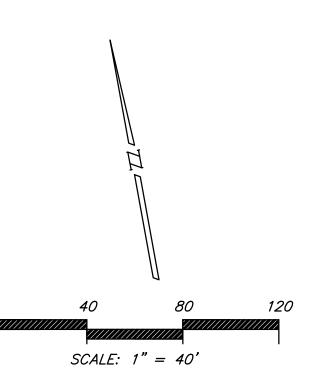

## **LEGEND**



SAWCUT AND REMOVE PAVEMENT

GRIND EX. PAVEMENT MARKING AND CHIP SEAL AND OVERLAY WITH DENSE GRADE OR OPEN GRADE A.C.




PRIOR TO CONSTRUCTION THE CONTRACTOR SHALL CALL UNDERGROUND SERVICE ALERT FOR UNDERGROUND CLEARANCE. USA WILL PROVIDE INFORMATION ABOUT OR LOCATE

### UNAUTHORIZED CHANGES & USES

THE ENGINEER PREPARING THESE PLANS WILL NOT BE RESPONSIBLE FOR, OR LIABLE FOR, UNAUTHORIZED CHANGES TO OR USES OF THESE PLANS. ALL CHANGES TO THE PLANS MUST BE IN WRITING AND MUST BE APPROVED BY THE PREPARER OF THESE PLANS.

Drawn By: RG/JSH			REVISI	0 N S		
Issue Date: 9/15/22	NO.	DATE	ISSUED	FOR	BY	
Issue Date: 9/10/22						
Job No.: NCO7254E						REGISTER.
Checked: DAM						*
Design By: RG/JSH						
						61
						•

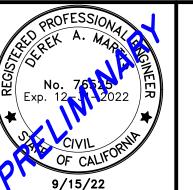



1117 L Street, Modesto, CA 95354 | 866.526.4214 | www.mve.net Northern California | Southern California | Nevada

STATE OF CALIFORNIA DEPARTMENT OF TRANSPORTATION


STATE HIGHWAY 16 IMPROVEMENTS

TOPOGRAPHY SURVEY AND DEMOLITION PLAN YOLO COUNTY

T02 SHEET

DWG.

CALIFORNIA OF 8

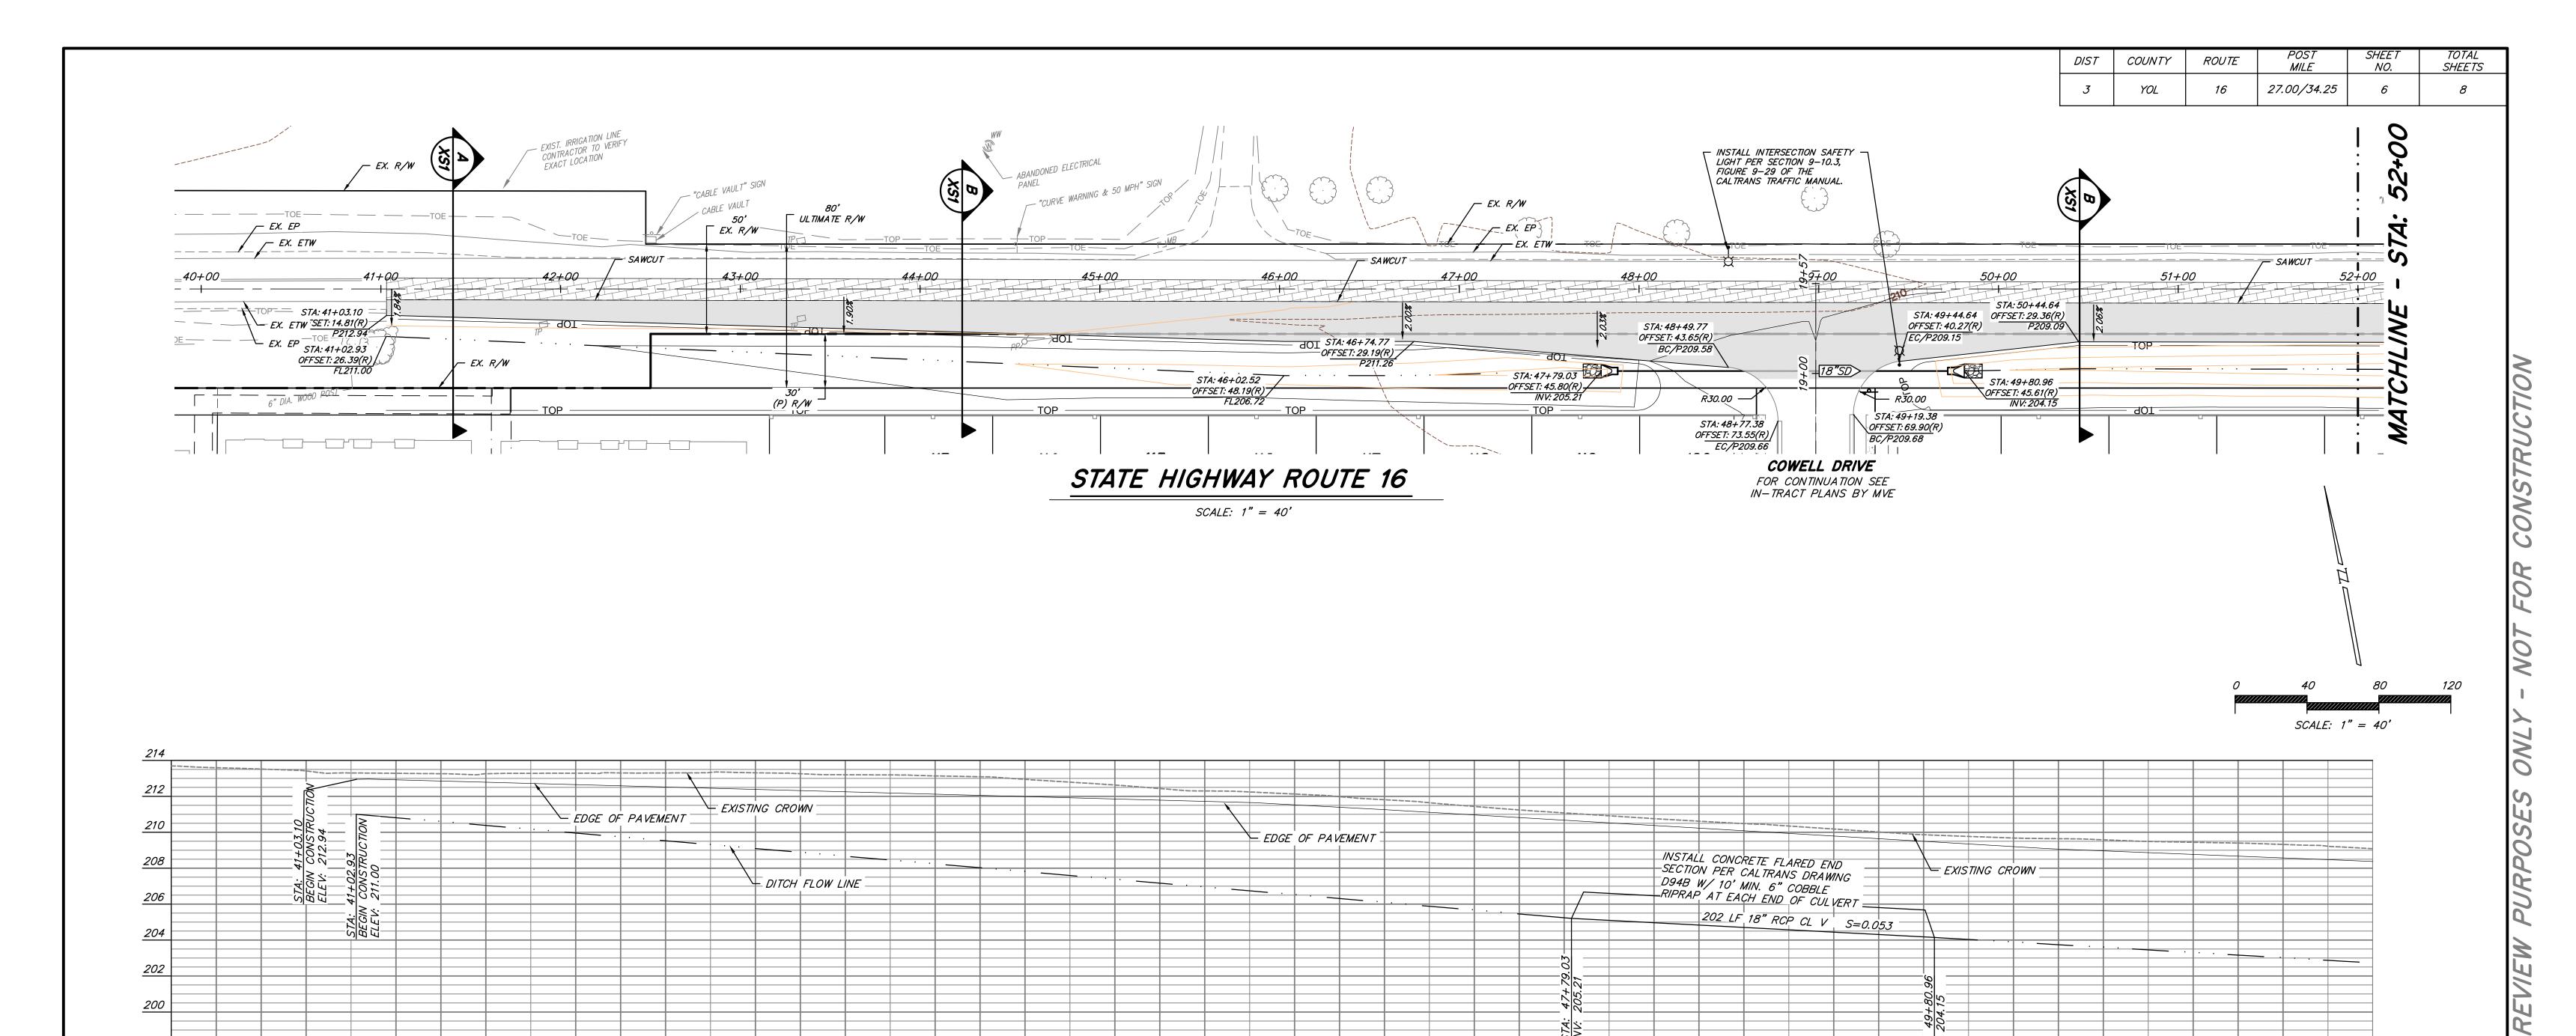

### GENERAL NOTES

*40+00* 

1. THE PROPOSED STRIPING IS NOT SHOWN ON THESE SHEETS FOR CLARITY PURPOSES -SEE STRIPING SHEETS FOR PROPOSED

2. CULVERT SHALL BE 18 INCH RCP CLASS III

### LEGEND

NEW PAVEMENY — SEE SHEET XS1 FOR STRUCTURAL SECTION

PAVEMENT GRIND AND OVERLAY - 0.15' TO PROVIDE UNIFORM PAVEMENT FOR PAVEMENT



PRIOR TO CONSTRUCTION THE CONTRACTOR SHALL CALL UNDERGROUND SERVICE ALERT FOR UNDERGROUND CLEARANCE. USA WILL PROVIDE INFORMATION ABOUT OR LOCATE AND MARK UNDERGROUND FACILITIES.

41+00

*42+00* 

### UNAUTHORIZED CHANGES & USES

THE ENGINEER PREPARING THESE PLANS WILL NOT BE RESPONSIBLE FOR, OR LIABLE FOR, UNAUTHORIZED CHANGES TO OR USES OF THESE PLANS. ALL CHANGES TO THE PLANS MUST BE IN WRITING AND MUST BE APPROVED BY THE PREPARER OF THESE PLANS.

*43+00* 

Drawn By: RG/JSH			R E V / S /	0 N S		PROFES
Issue Date: 9/15/22	NO.	DA TE	ISSUED	FOR	BY	QU REX A
ISSUE Date: 9/15/22						150
Job No.: NCO7254E						No. 7 Exp. 12
Checked: DAM						*
Design By: RG/JSH						OF (
						9/15

*46+00* 

STATE HIGHWAY ROUTE 16 PROFILE

SCALE: 1" = 40' H1" = 4' V

*47+00* 

*48+00* 

49+00

STATE HIGHWAY 16 IMPROVEMENTS

STATE OF CALIFORNIA DEPARTMENT OF TRANSPORTATION

STA 40+00.00 TO STA 52+00.00 YOLO COUNTY

SHEET

DWG.

1117 L Street, Modesto, CA 95354 | 866.526.4214 | www.mve.net Northern California | Southern California | Nevada

*50+00* 

PLAN AND PROFILE


*51+00* 

CALIFORNIA OF 8

*52+00* 

44+00

*45+00* 

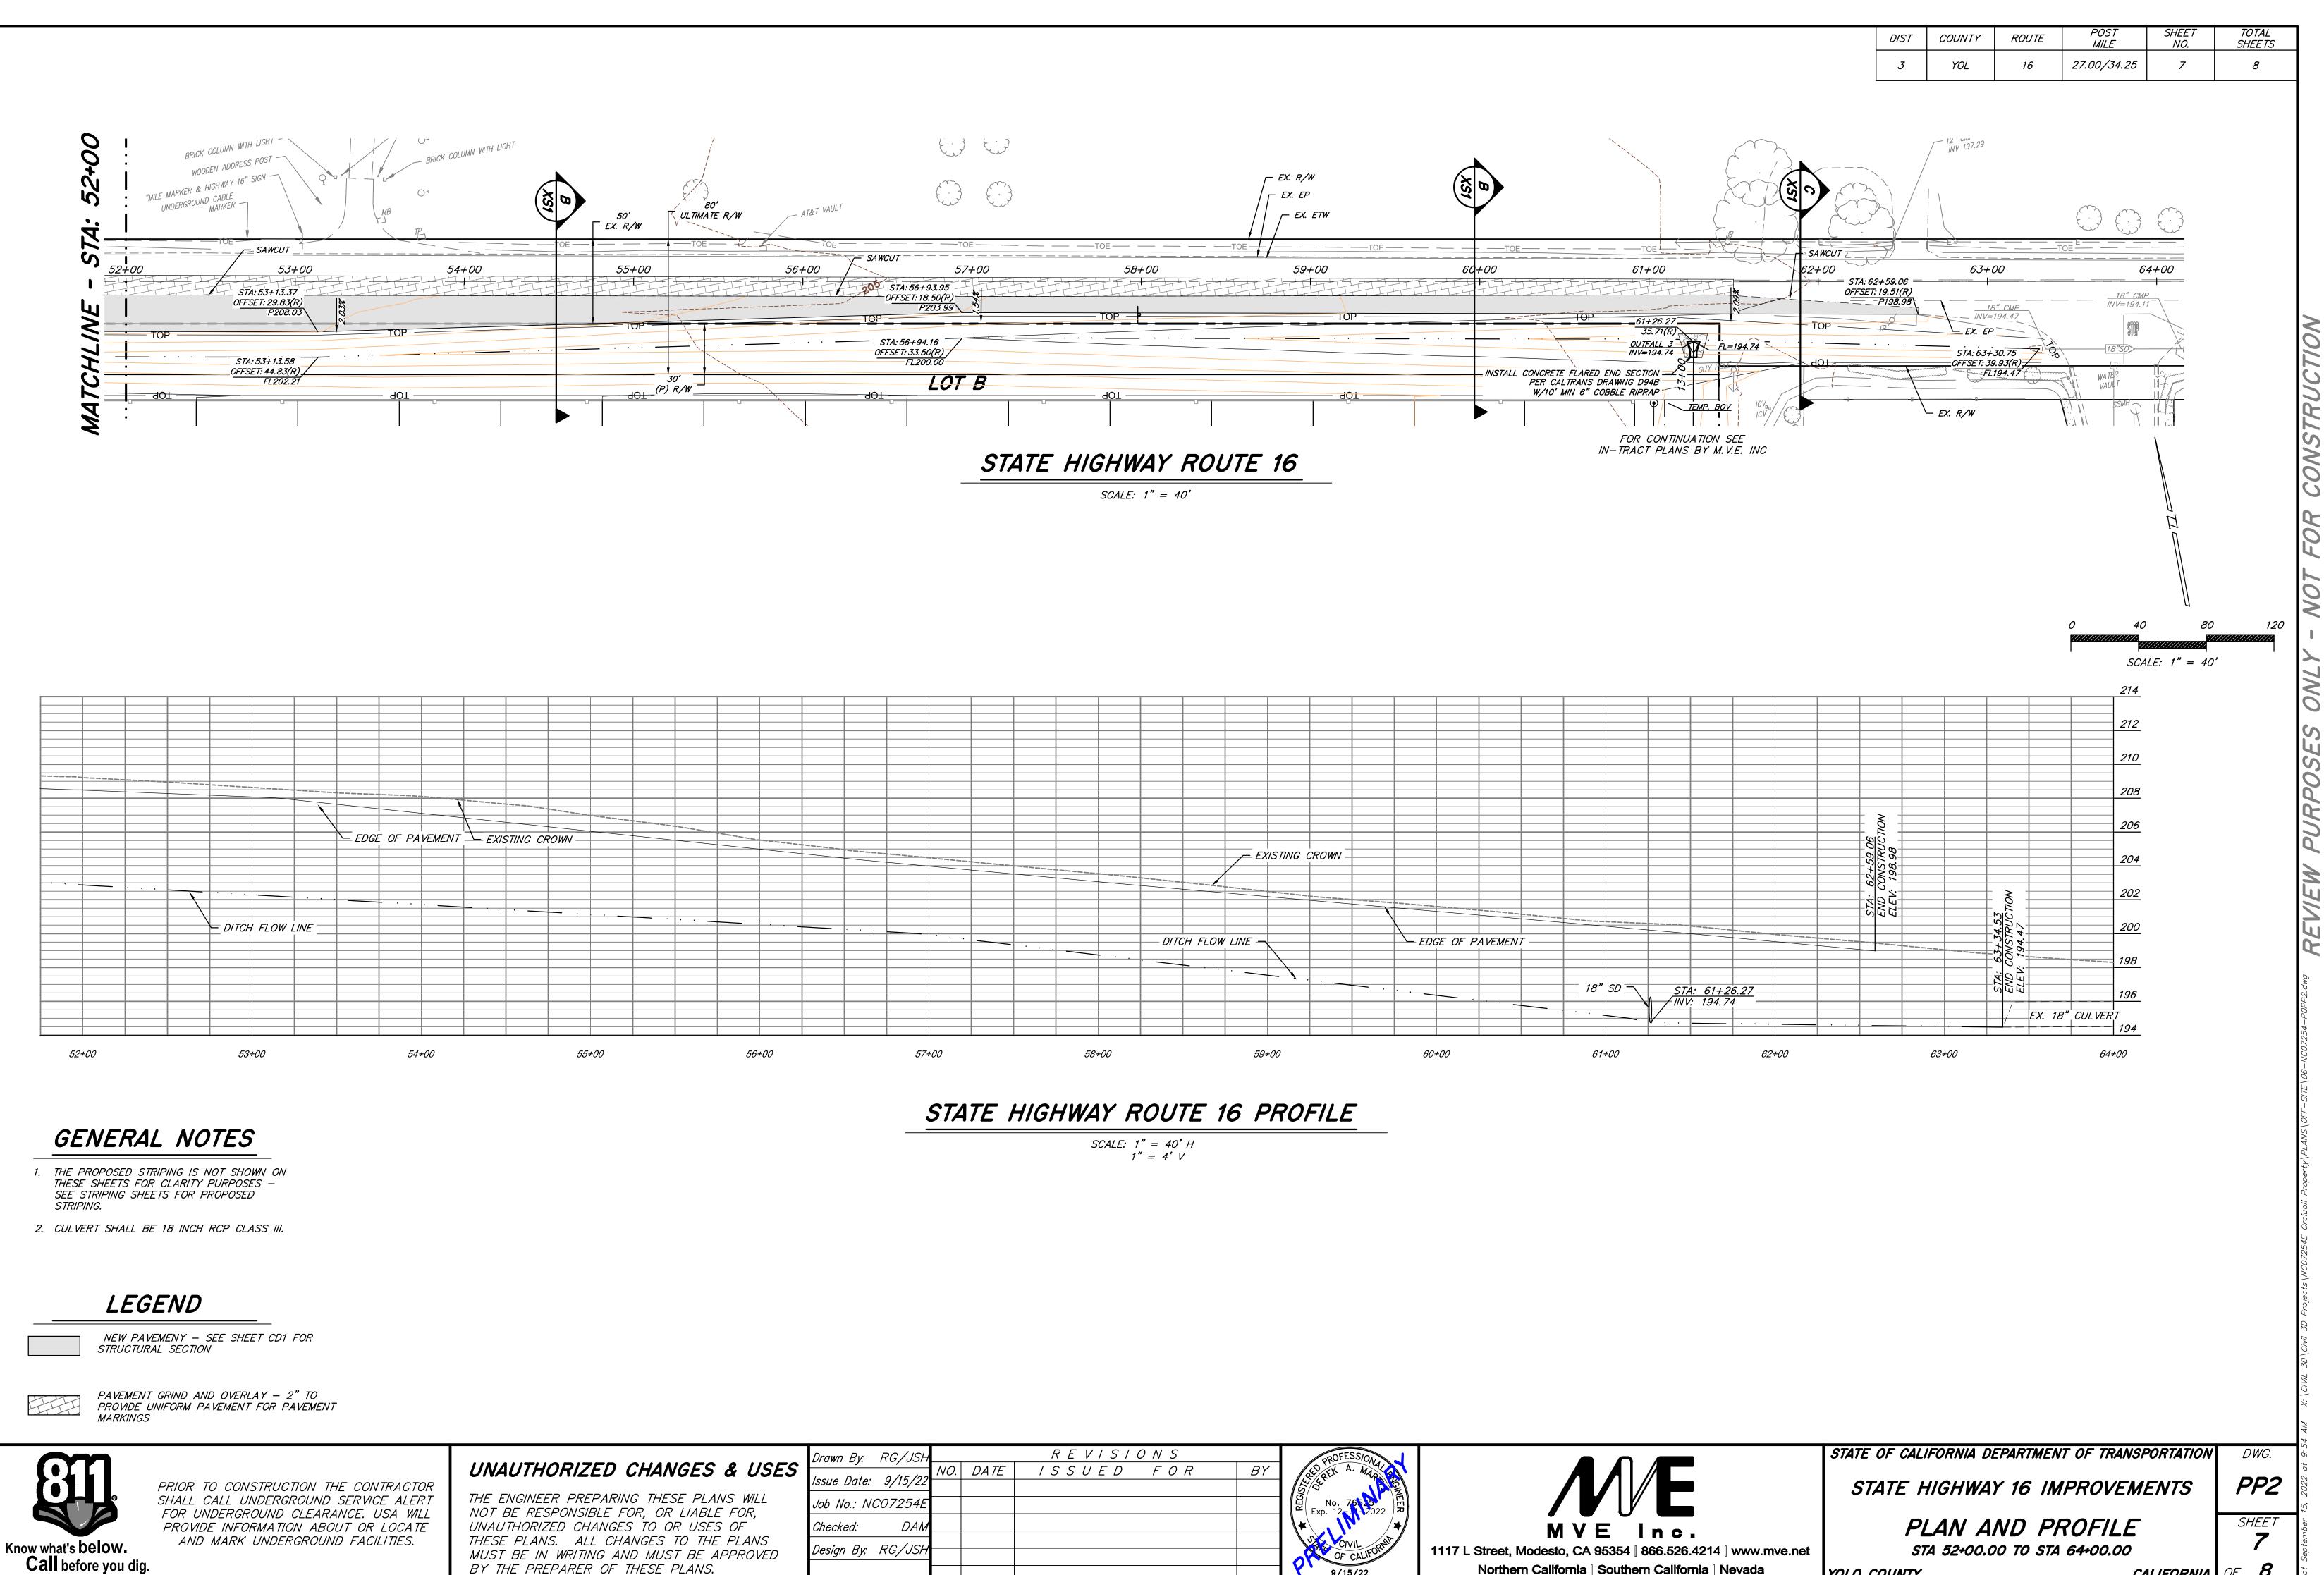

Northern California | Southern California | Nevada

9/15/22

YOLO COUNTY

BY THE PREPARER OF THESE PLANS.

CALIFORNIA OF 8

