


# DRAWING NOTATIONS

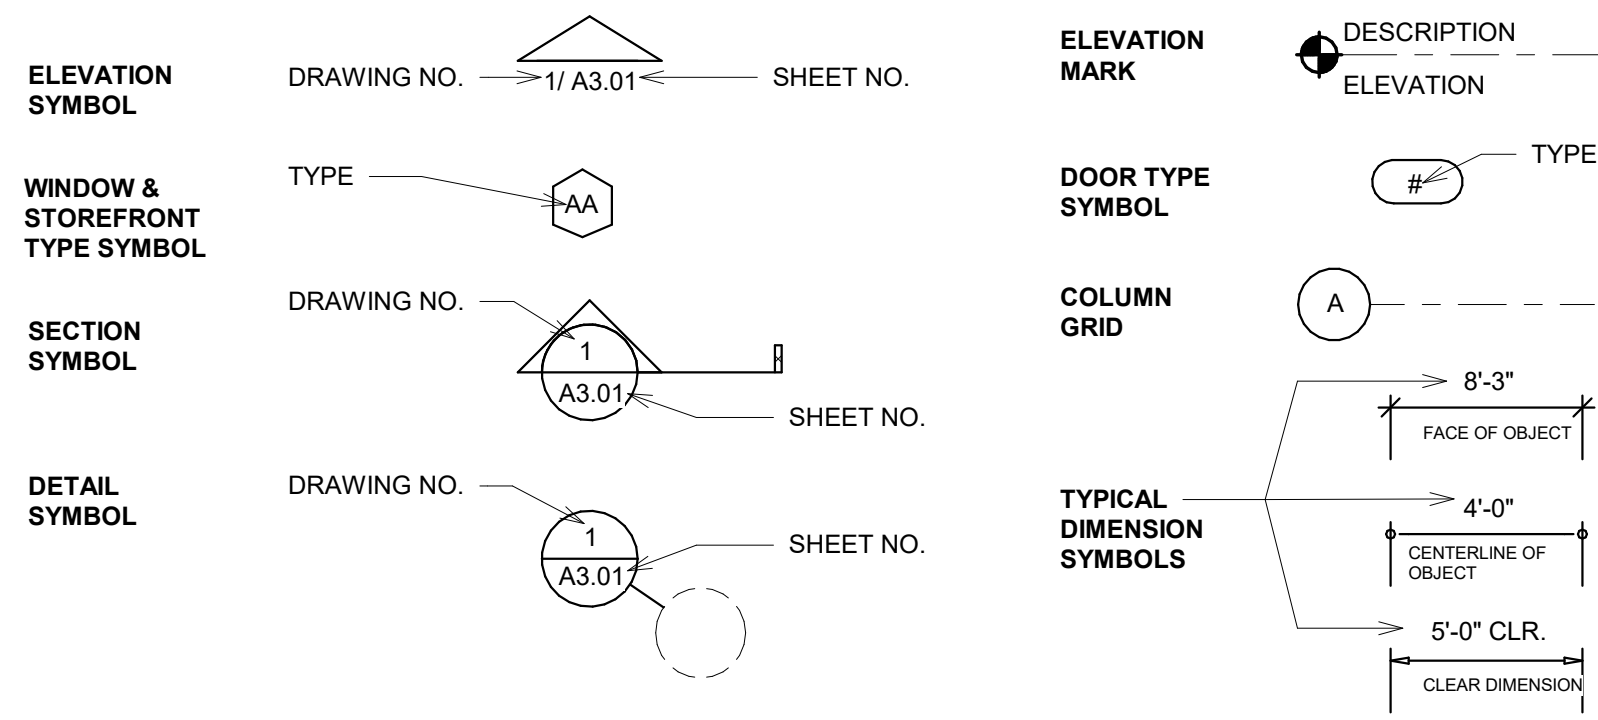

# ABBREVIATIONS

<p>AFF ABOVE FINISHED FLOOR</p> <p>APC ACOUSTICAL PANEL CEILING</p> <p>AWC ACOUSTICAL WALL COVERING</p> <p>AHU AIR HANDLING UNIT</p> <p>ALT ALTERNATE</p> <p>AL ALUMINUM</p> <p>BL BASELINE</p> <p>BR BRICK</p> <p>BRP BRICK PAVERS</p> <p>BRG BEARING</p> <p>BFF BELOW FINISHED FLOOR</p> <p>BOS BOTTOM OF STEEL</p> <p>BUR BUILT-UP ROOFING</p> <p>CPT CARPET TILE</p> <p>CLG CEILING</p> <p>CTR CENTER</p> <p>CL CENTERLINE</p> <p>CT CERAMIC TILE</p> <p>CTB CERAMIC TILE BASE</p> <p>COL COLUMN</p> <p>CONC CONCRETE</p> <p>CMU CONCRETE MASONRY UNIT</p> <p>CJ CONSTRUCTION/CONTROL JOINT</p> <p>DEG DEGREE</p> <p>DEMO DEMOLITION</p> <p>DIA DIAMETER</p> <p>DIM DIMENSION</p> <p>DLDS DOWN LEADER/DOWNSPOUT</p> <p>EXP EXPOSED</p> <p>ELEC ELECTRICAL</p> <p>EL ELEVATION</p> <p>EXIST EXISTING</p> <p>ETR EXISTING TO REMAIN</p> <p>EJ EXPANSION JOINT</p> <p>EIFS EXTERIOR INSULATION FINISH SYSTEM</p> <p>EXT EXTERIOR</p> <p>FO FACE OF</p> <p>FIN FLR FINISH FLOOR</p> <p>FIN GR FINISH GRADE</p> <p>FDC FIRE DEPARTMENT CONNECTION</p> <p>FEB FIRE EXTINGUISHER ON BRACKET</p> <p>FEC FIRE EXTINGUISHER IN CABINET</p> <p>FD FLOOR DRAIN</p> <p>FLR FLOOR</p> <p>FT FULLY TEMPERED (GLASS)</p> <p>GAGE GAGE</p> <p>GALV GALVANIZED</p> <p>GL GLASS</p> <p>MATL MATERIAL</p> <p>MAX MAXIMUM</p> <p>MSL MEAN SEA LEVEL</p> <p>MTL METAL</p> <p>MIN MINIMUM</p> <p>MISC MISCELLANEOUS</p> <p>MR MOISTURE RESISTANT</p> <p>MRGB MOISTURE RESISTANT GYPSUM BOARD</p> <p>MTD MOUNTED</p> <p>NIC NOT IN CONTRACT</p> <p>NTS NOT TO SCALE</p> <p>NA NOT APPLICABLE</p> <p>OC ON CENTER</p> <p>OPNG OPENING</p> <p>OPP OPPOSITE</p> <p>OH OPPOSITE HAND</p> <p>PT PAINT</p> <p>PLAS PLASTER</p>	<p>PLAM PLASTIC LAMINATE</p> <p>PLYWD PLYWOOD</p> <p>PL PROPERTY LINE</p> <p>QT QUARRY TILE</p> <p>R RADIUS</p> <p>REF REFERENCE</p> <p>RCP REFLECTED CEILING PLAN</p> <p>REINF REINFORCED</p> <p>REBAR REINFORCING STEEL BARS</p> <p>REQD REQUIRED</p> <p>RB RESILIENT BASE</p> <p>RF RESILIENT FLOORING</p> <p>REV REVISION</p> <p>RD ROOF DRAIN</p> <p>RO ROUGH OPENING</p> <p>SM SHEET METAL</p> <p>SV SHEET VINYL</p> <p>SIM SIMILAR</p> <p>SGL SINGLE</p> <p>SC SOLID CORE</p> <p>SPKR SPEAKER</p> <p>SF SQUARE FOOT</p> <p>SST STAINLESS STEEL</p> <p>STD STANDARD</p> <p>STL STEEL</p> <p>STRUCT STRUCTURAL</p> <p>GFRG GLASS FIBER REINFORCED CONCRETE</p> <p>GWT GLAZED WALL TILE</p> <p>GYP BD GYPSUM BOARD</p> <p>GSB GYPSUM SHEATHING BOARD</p> <p>HCP HANDICAPPED</p> <p>HDW HARDWARE</p> <p>HDWD HARDWOOD</p> <p>HAZ HAZARDOUS</p> <p>HVAC HIGH VELOCITY AIR CONDITION</p> <p>HM HOLLOW METAL</p> <p>HB HOSE BIBB</p> <p>INSUL INSULATION</p> <p>INT INTERIOR</p> <p>LAM GL LAMINATED GLASS</p> <p>LAV LAVATORY</p> <p>LWC LIGHTWEIGHT CONCRETE</p> <p>LF LINEAR FEET</p> <p>MFR MANUFACTURER</p> <p>MO MASONRY OPENING</p> <p>SIM SIMILAR</p> <p>TEMP TEMPORARY</p> <p>T&amp;G TONGUE AND GROOVE</p> <p>TO TOP OF</p> <p>TOB/TOS TOP OF BEAM/TOP OF STEEL</p> <p>TS TUBE STEEL</p> <p>TYP TYPICAL</p> <p>UC UNDERCUT</p> <p>UNO UNLESS NOTED OTHERWISE</p> <p>VTR VENT THROUGH ROOF</p> <p>VAR VARIES</p> <p>VB VINYL BASE</p> <p>VCT VINYL COMPOSITION TILE</p> <p>VWC VINYL WALL COVERING</p> <p>W/ WITH</p> <p>W/O WITHOUT</p> <p>WD WOOD</p> <p>WB WOOD BASE</p> <p>WP WORKING POINT</p>
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# GENERAL NOTES

THE DRAWINGS INDICATE THE GENERAL SCOPE OF THE PROJECT IN TERM OF AN ARCHITECTURAL DESIGN CONCEPT. THE DIMENSIONS OF THE BUILDING, THE MAJOR ARCHITECTURAL ELEMENTS AND THE TYPE OF STRUCTURAL SYSTEM, AS SCOPE DOCUMENTS, THE DRAWINGS DO NOT NECESSARILY INDICATE OR DESCRIBE OF THE WORK REQUIRED FOR FULL PERFORMANCE AND COMPLETION OF THE REQUIREMENTS OF THE CONTRACT DOCUMENTS. ON THE BASIS OF THE GENERAL SCOPE INDICATED OR DESCRIBED, THE TRADE CONTRACTORS SHALL FURNISH ALL ITEMS REQUIRED FOR THE PROPER EXECUTION AND COMPLETION OF THE WORK.

- THE CONTRACTOR SHALL VISIT THE JOB SITE AND BE KNOWLEDGEABLE OF ALL CONDITIONS THEREOF. THE CONTRACTOR SHALL INVESTIGATE, VERIFY AND BE RESPONSIBLE FOR ALL CONDITIONS OF THE PROJECT AND NOTIFY THE ARCHITECT OF ANY CONDITIONS REQUIRING MODIFICATION BEFORE PROCEEDING WITH THE WORK.
- ALL WORK SHALL COMPLY WITH FEDERAL, STATE AND LOCAL CODES OR ORDINANCES.
- DO NOT SCALE DRAWINGS. WRITTEN DIMENSIONS HAVE PRECEDENCE.
- LARGER SCALE DRAWINGS HAVE PRECEDENCE OVER SMALLER SCALE DRAWINGS.
- WHERE ONE DETAIL IS SHOWN FOR ONE CONDITION IT SHALL APPLY TO ALL LIKE OR SIMILAR CONDITIONS THOUGH NOT SPECIFICALLY MARKED.
- IF AT ANY TIME AN ERROR IS FOUND WITHIN THESE DOCUMENTS PRIOR TO OR DURING CONSTRUCTION THAT MAY BE CRITICAL TO THE INTEGRITY OF THIS PROJECT, THE CONTRACTOR SHALL CONTACT THE ARCHITECT IMMEDIATELY TO RESOLVE THE ERROR PRIOR TO PROCEEDING WITH THE AFFECTED WORK.
- THE COORDINATION OF ALL MATERIALS, LABOR AND THE SUB CONTRACTORS WORKMANSHIP IS THE SOLE RESPONSIBILITY OF THE GENERAL CONTRACTOR.
- THE CONTRACTOR IS RESPONSIBLE FOR CONTACTING LOCAL BUILDING OFFICIALS AND INSPECTORS FOR PERMITS AND INSPECTIONS.
- THE CONTRACTOR SHALL BE RESPONSIBLE FOR ALL BRACING ALL WORK DURING CONSTRUCTION AND IMPLEMENTATION OF ALL SAFETY PROCEDURES IN ACCORDANCE WITH APPLICABLE CODES.
- ALL FIXTURES, EQUIPMENT AND MATERIALS SHALL BE INSTALLED PER THE MANUFACTURER'S SPECIFICATIONS, RECOMMENDATIONS AND SUGGESTED INSTRUCTIONS.
- ALL WORK SHALL BE IN ACCORDANCE WITH THE QUALITY STANDARDS OF THE TRADE AND SHALL BE INSTALLED IN ACCORDANCE TO ALL APPLICABLE LOCAL, STATE AND FEDERAL CODES AND MANUFACTURER'S RECOMMENDATIONS.
- ITEMS NOTED AS "N.I.C" (NOT IN CONTRACT), "BY OWNER" OR "EXISTING" SHALL NOT BE INCLUDED IN THE CONTRACT. HOWEVER, PROVISIONS SHALL BE MADE BY RESPECTIVE TRADES TO ALLOW THE INSTALLATION OF ITEMS NOTED. ALL FINISHES OF FLOORS, BASES, WAINSCOTS, WALLS AND CEILINGS BEHIND, UNDER AND/OR OVER THESE ITEMS SHALL BE INCLUDED IN THE GENERAL CONTRACT UNLESS NOTED OTHERWISE (U.N.O.)
- THE JOB SITE SHALL BE KEPT "BROOM CLEAN" AND FREE OF EXCESSIVE DEBRIS. ALL REFUSE CREATED IN THE EXECUTION OF THE CONTRACT FOR CONSTRUCTION IS THE RESPONSIBILITY OF THE GENERAL CONTRACTOR. TRANSPORT TRASH, RUBBISH AND DEBRIS FROM THE SITE AND DISPOSE OF LEGALLY. THE MANNER OF THE REMOVAL SHALL BE CONFIRMED WITH AN OWNERS REPRESENTATIVE AND SHALL MEET CITY, COUNTY AND STATE REGULATIONS.
- CONTRACTOR TO CONDUCT FINAL SITE CLEANING AND INTERIOR CLEANING AT COMPLETION.
- DIMENSIONS ARE NOMINAL AND ARE TAKEN FROM FACE OF BLOCK WALL, CENTERLINE OF COLUMN AND FACE OF STUD U.N.O.
- CONTRACTOR TO VERIFY ALL AREAS AND QUANTITIES.
- VERIFY WITH OWNER ALL FINISH AND PRODUCT SELECTIONS


# CURRENT BUILDING CODE

LOUISIANA UNIFORM CONSTRUCTION CODES USED:

- 2015 INTERNATIONAL BUILDING CODE
- 2015 INTERNATIONAL MECHANICAL CODE
- 2015 INTERNATIONAL PLUMBING CODE
- 2014 NATIONAL ELECTRIC CODE

# BIDDING NOTES




- ALL TRADES ARE STRONGLY ENCOURAGED TO VISIT THE SITE PRIOR TO BIDDING. THIS PROJECT CANNOT BE ACCURATELY BE BID WITHOUT SITE VERIFICATION OF THE EXISTING CONDITIONS.
- ALL SUPPLIERS AND SUB CONTRACTORS ARE ENCOURAGED TO REVIEW ALL PLAN SHEETS AS THE PLANS CONTAIN WORK BY MANY DIFFERENT TRADES.

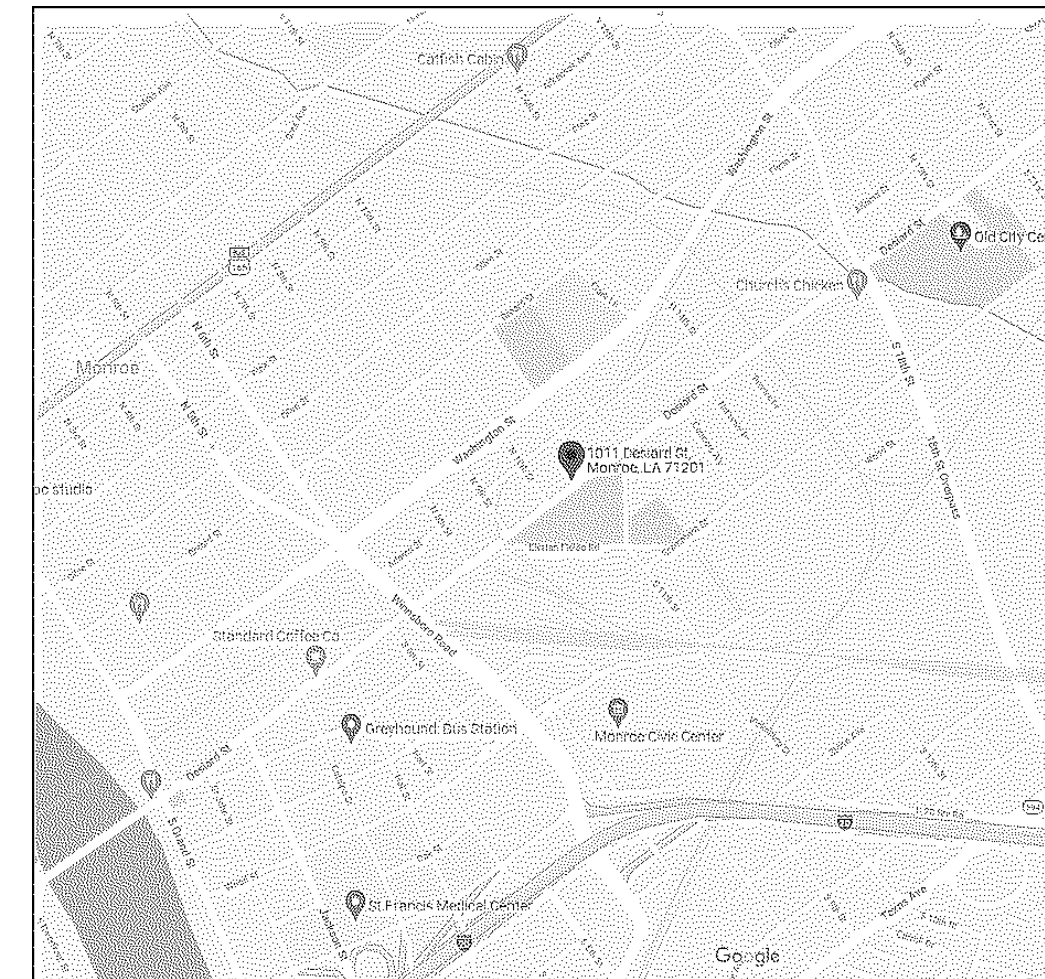

**PROJECT LOCATION MAP**  
NORTH NOT TO SCALE




**CURRENT SITE CONDITION**  
NORTH NOT TO SCALE

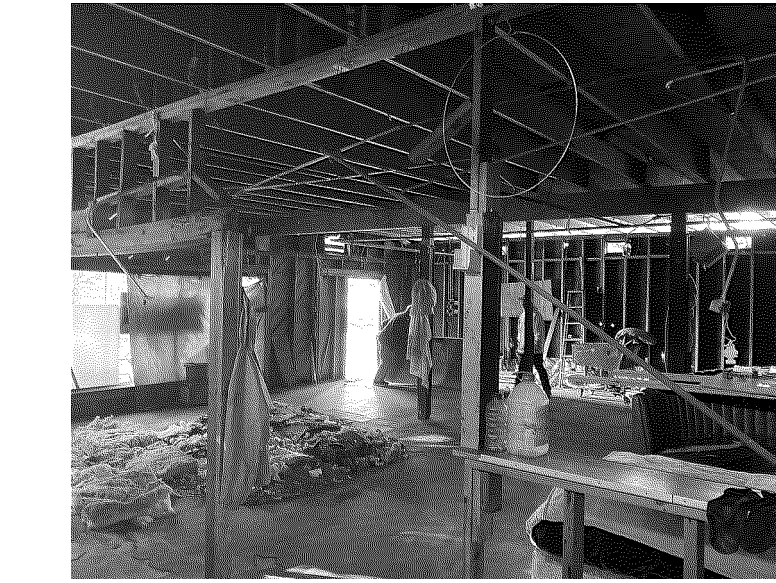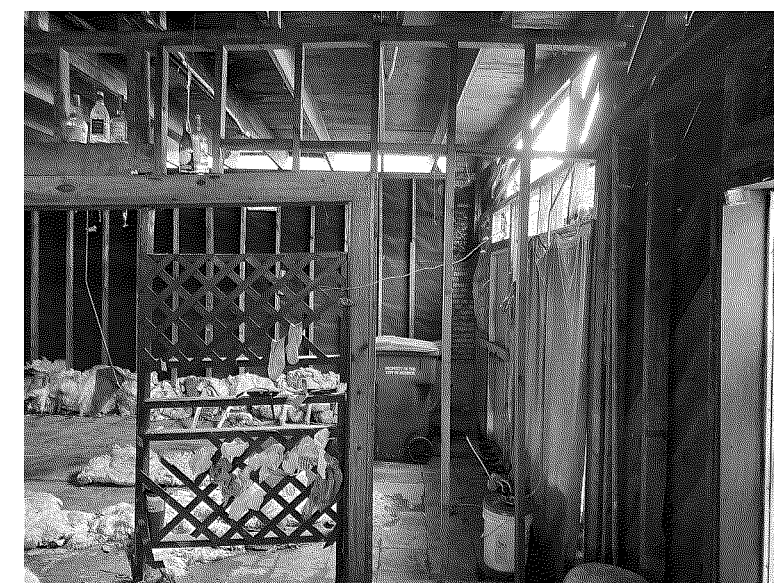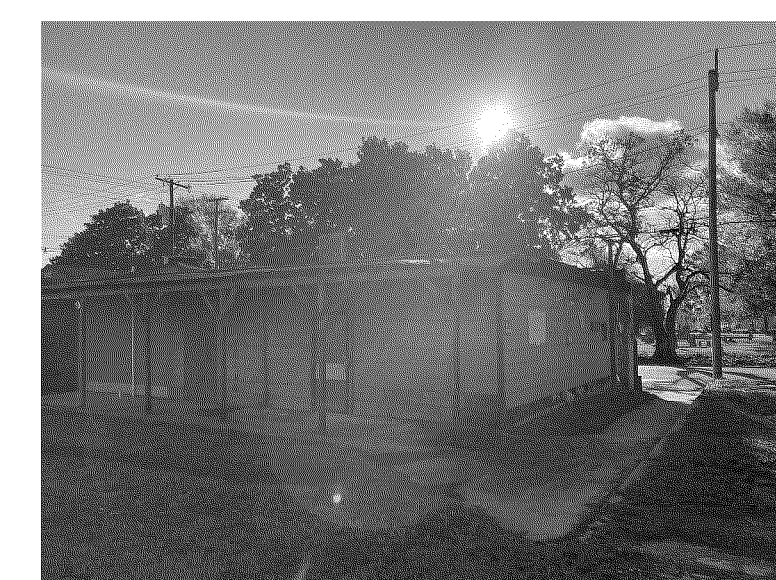


# DRAWING INDEX

SHEET NO.	PAGE NO.	SHEET NAME
A-1	1	COVER SHEET
A-2	2	FLOOR PLAN, EXTERIOR ELEVATIONS
A-3	3	TYPES, SCHEDULES, AND ELEVATIONS
<b>Grand total: 3</b>		

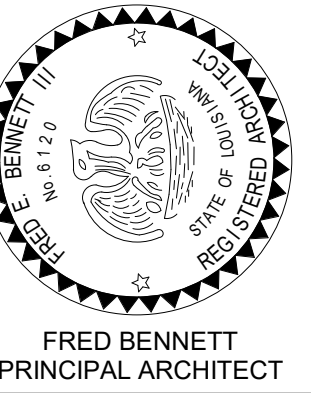

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INTERIOR / EXTERIOR BUILDING RENOVATIONS  
LOCATED AT:  
**1011 DESIARD STREET  
MONROE, LA 71201**  
LUDELING PROPERTIES, LLC
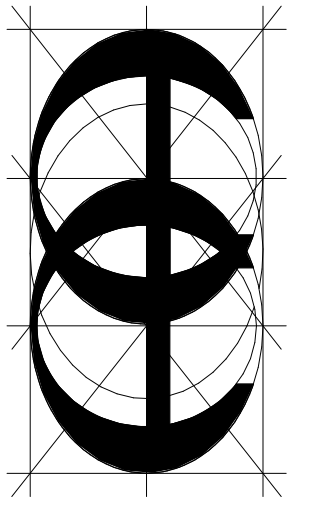
### DRAWING REVISIONS

NO.	DESCRIPTION	DATE


DATE: JANUARY 19, 2022

SHEET No.


**A-1**

PROJECT No.  
21-220


COVER SHEET

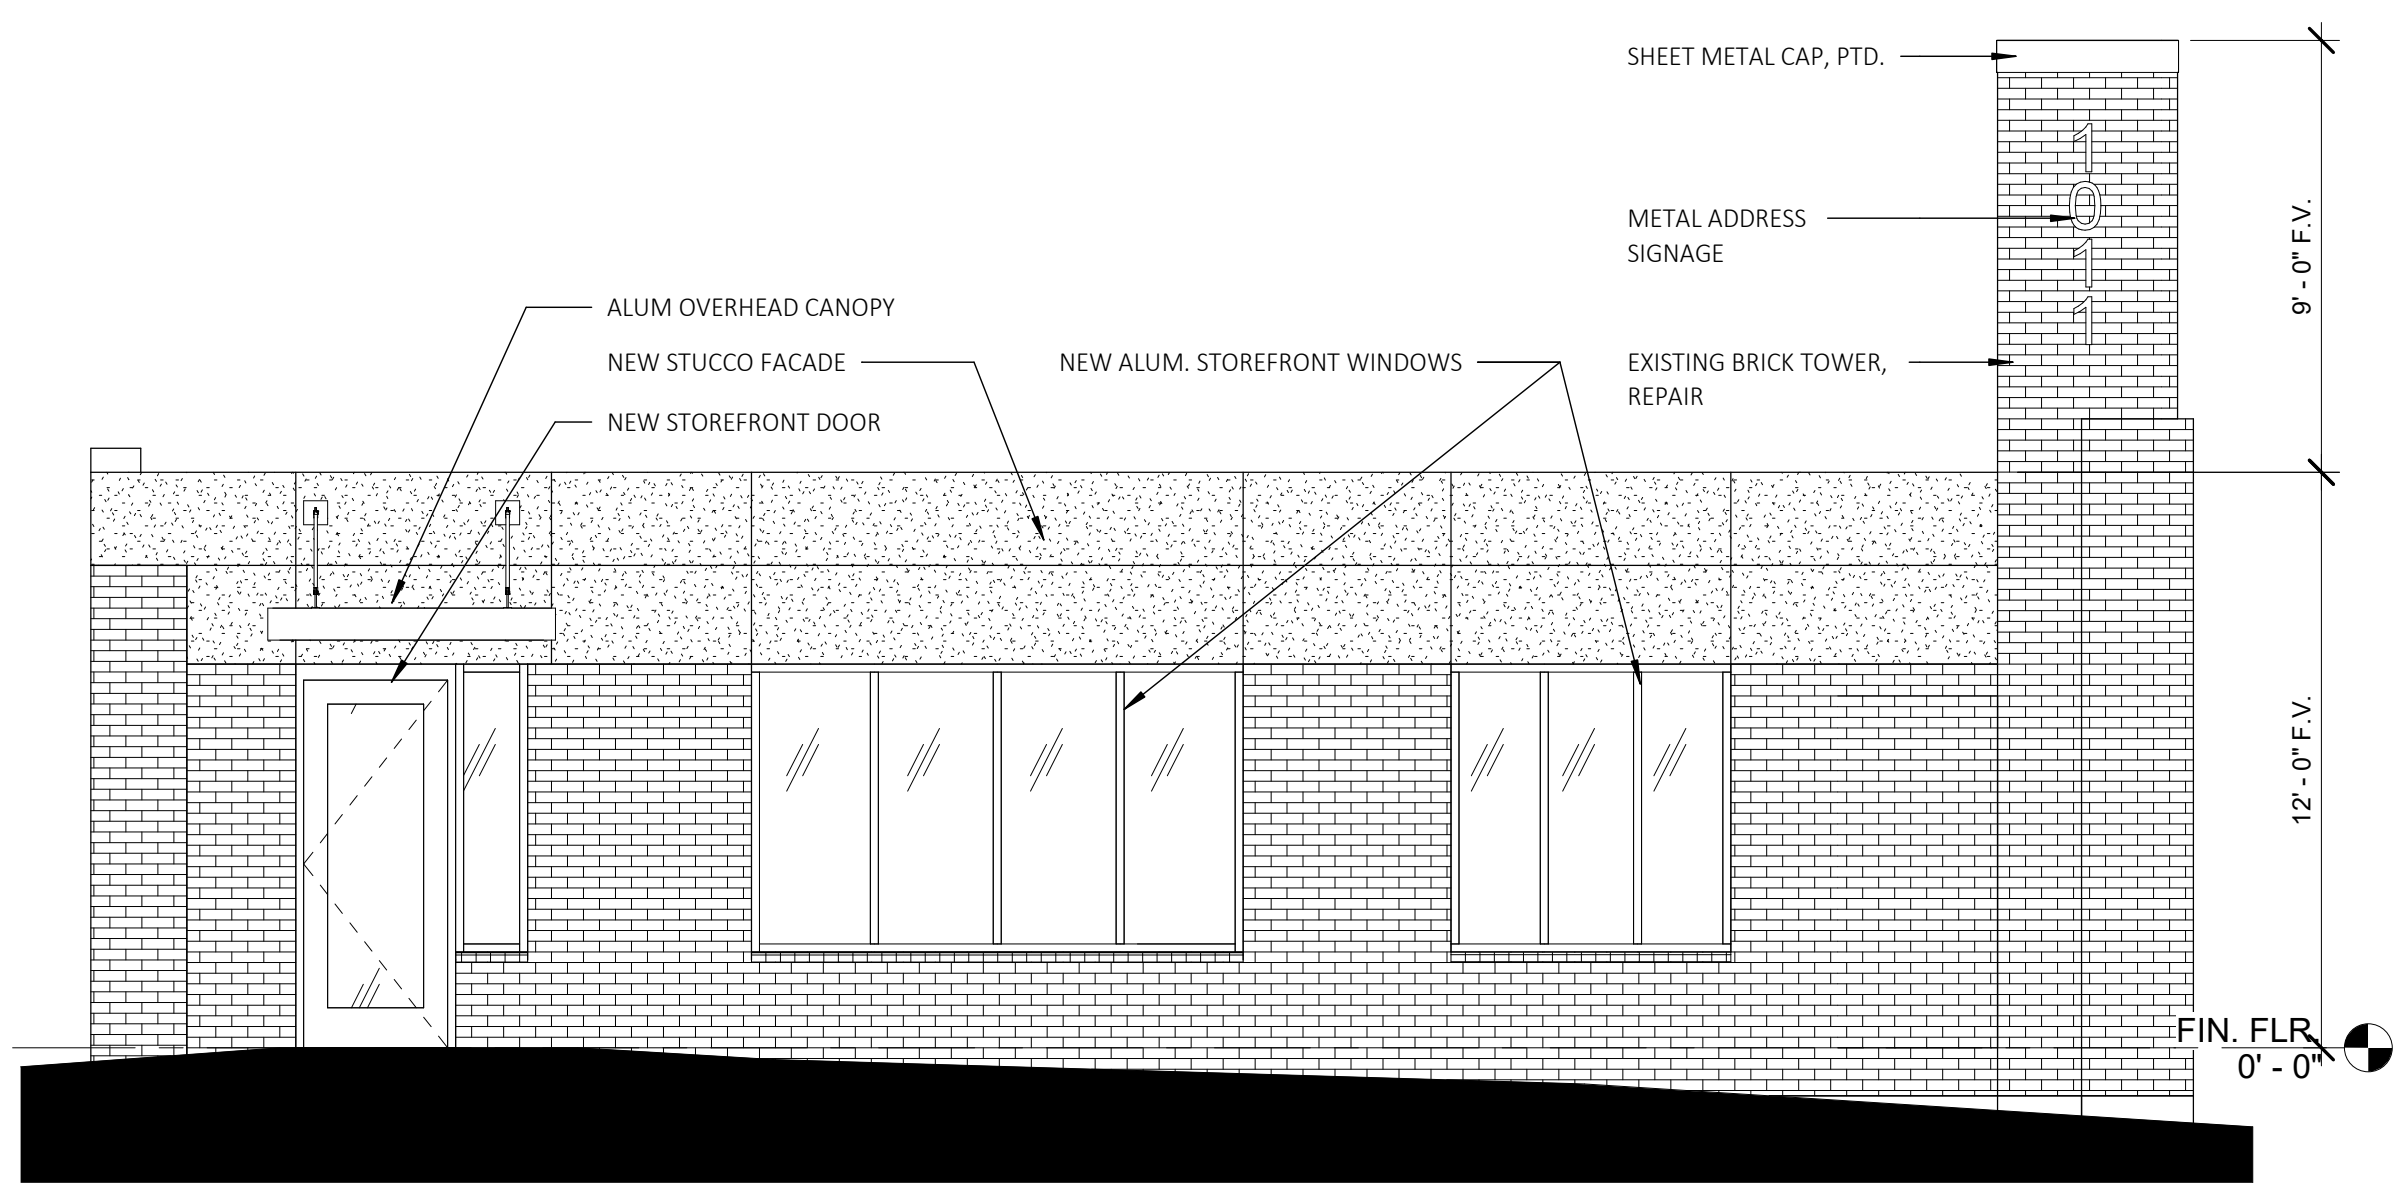


2 PROPOSED FRONT FACADE (SOUTHEAST ELEVATION)  
1/4" = 1'-0"

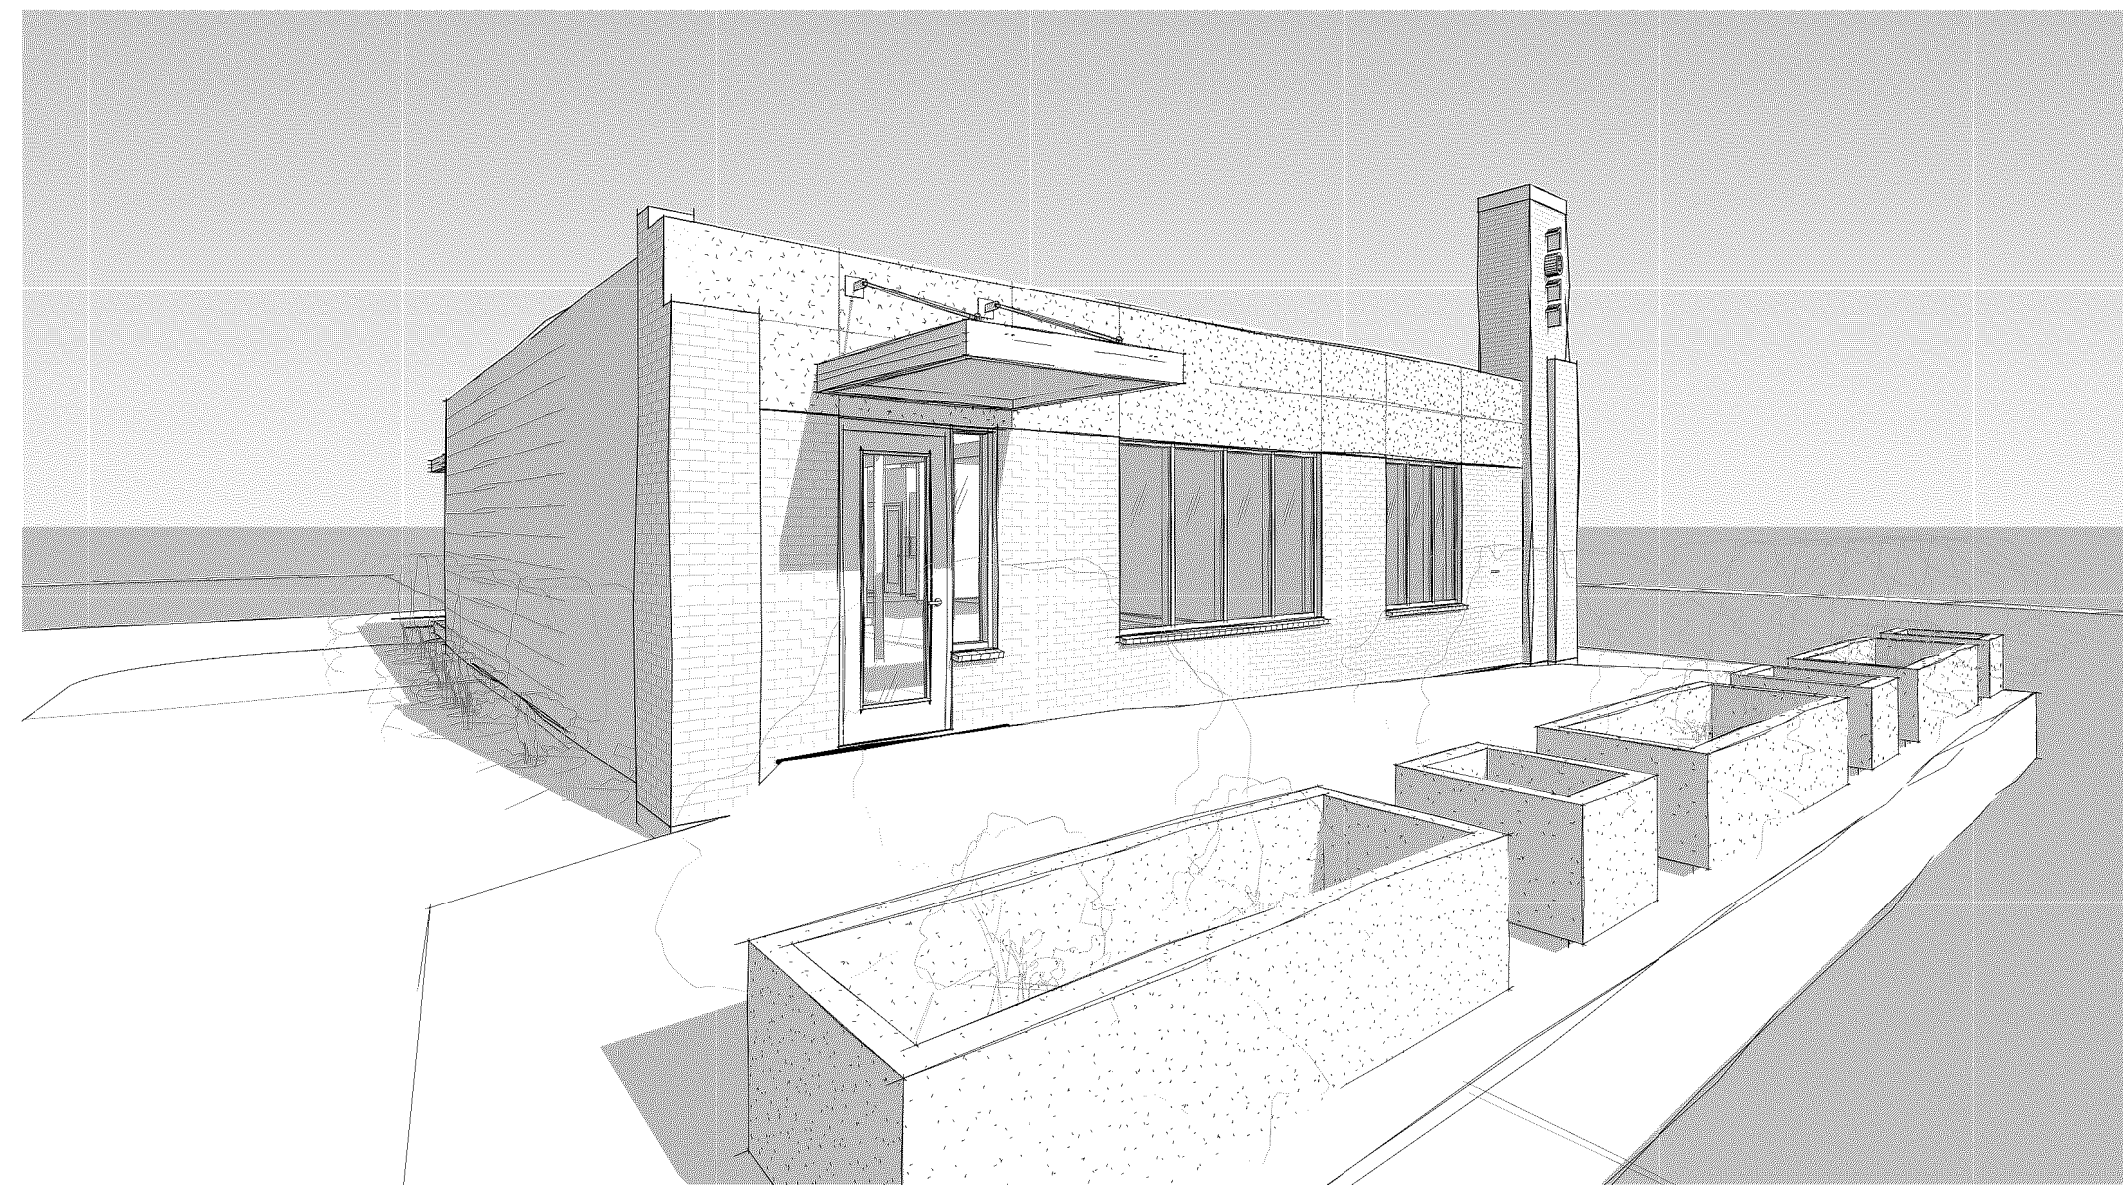

9 FRONT ENTRY VIEW LOOKING TOWARDS NORTHEAST

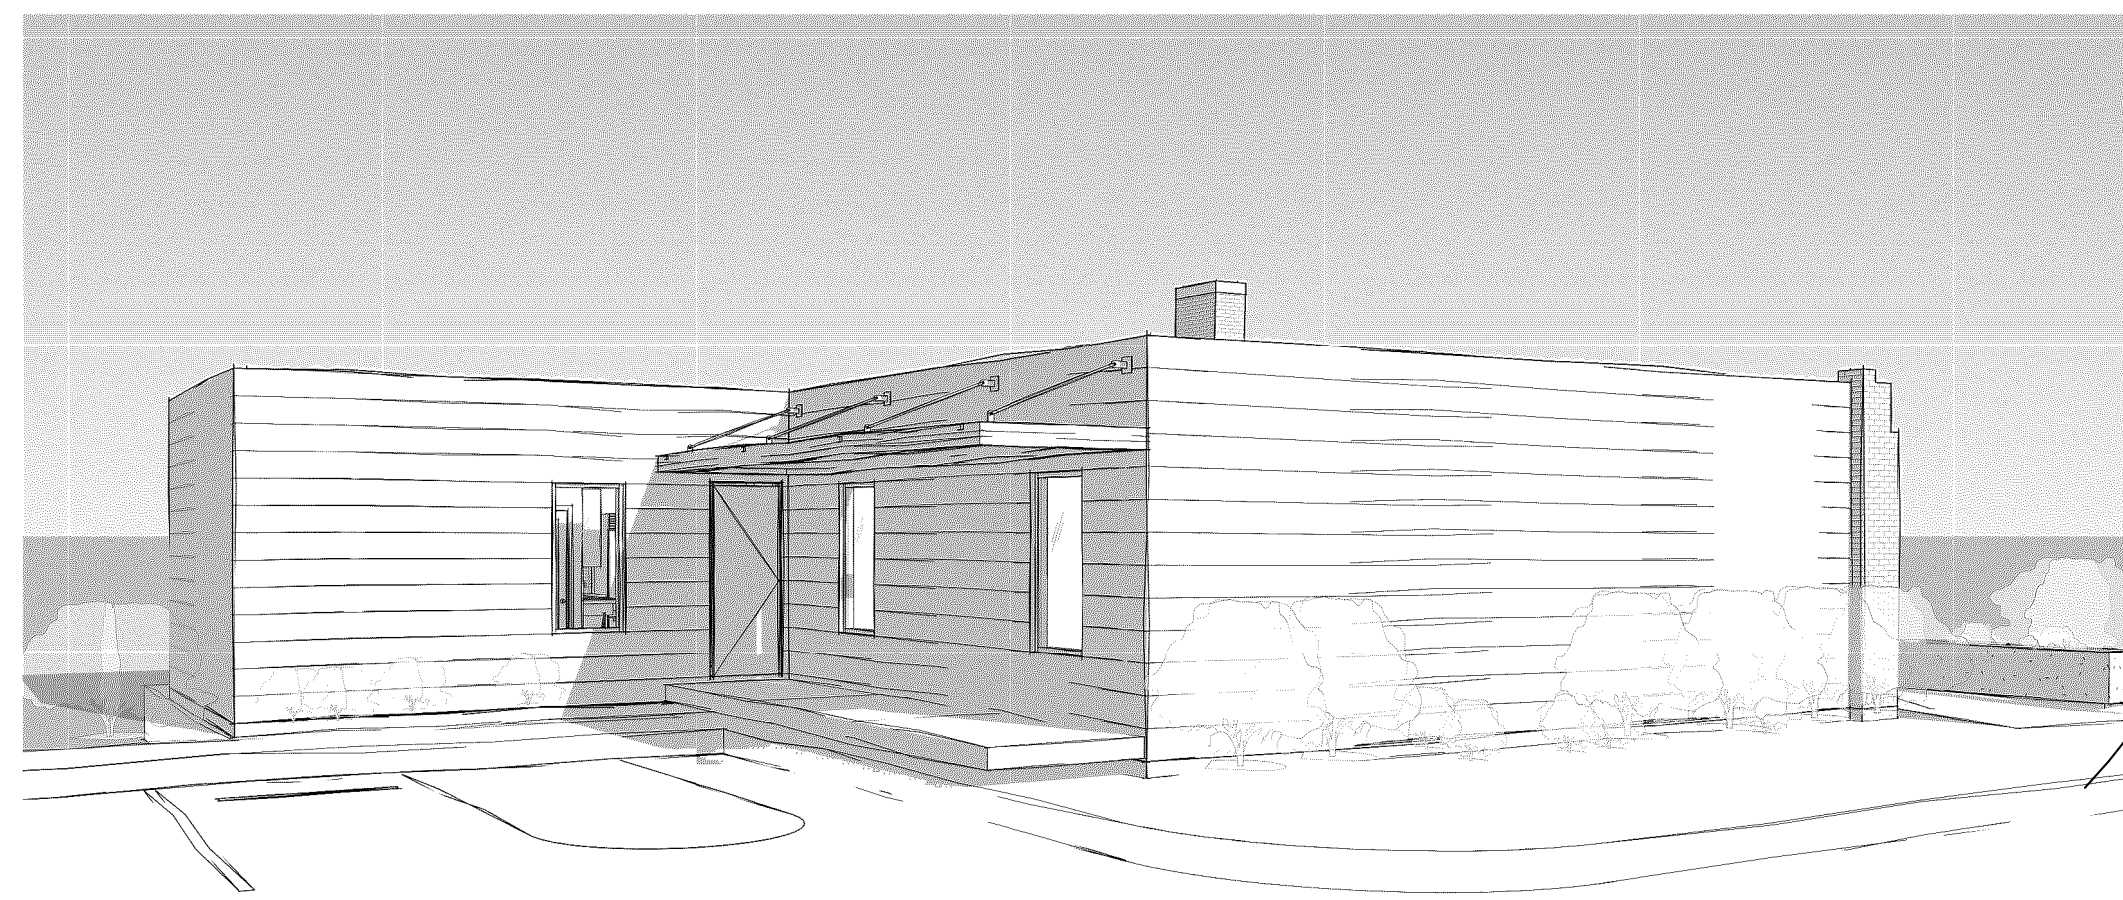



10 REAR ENTRY VIEW LOOKING TOWARDS SOUTHEAST

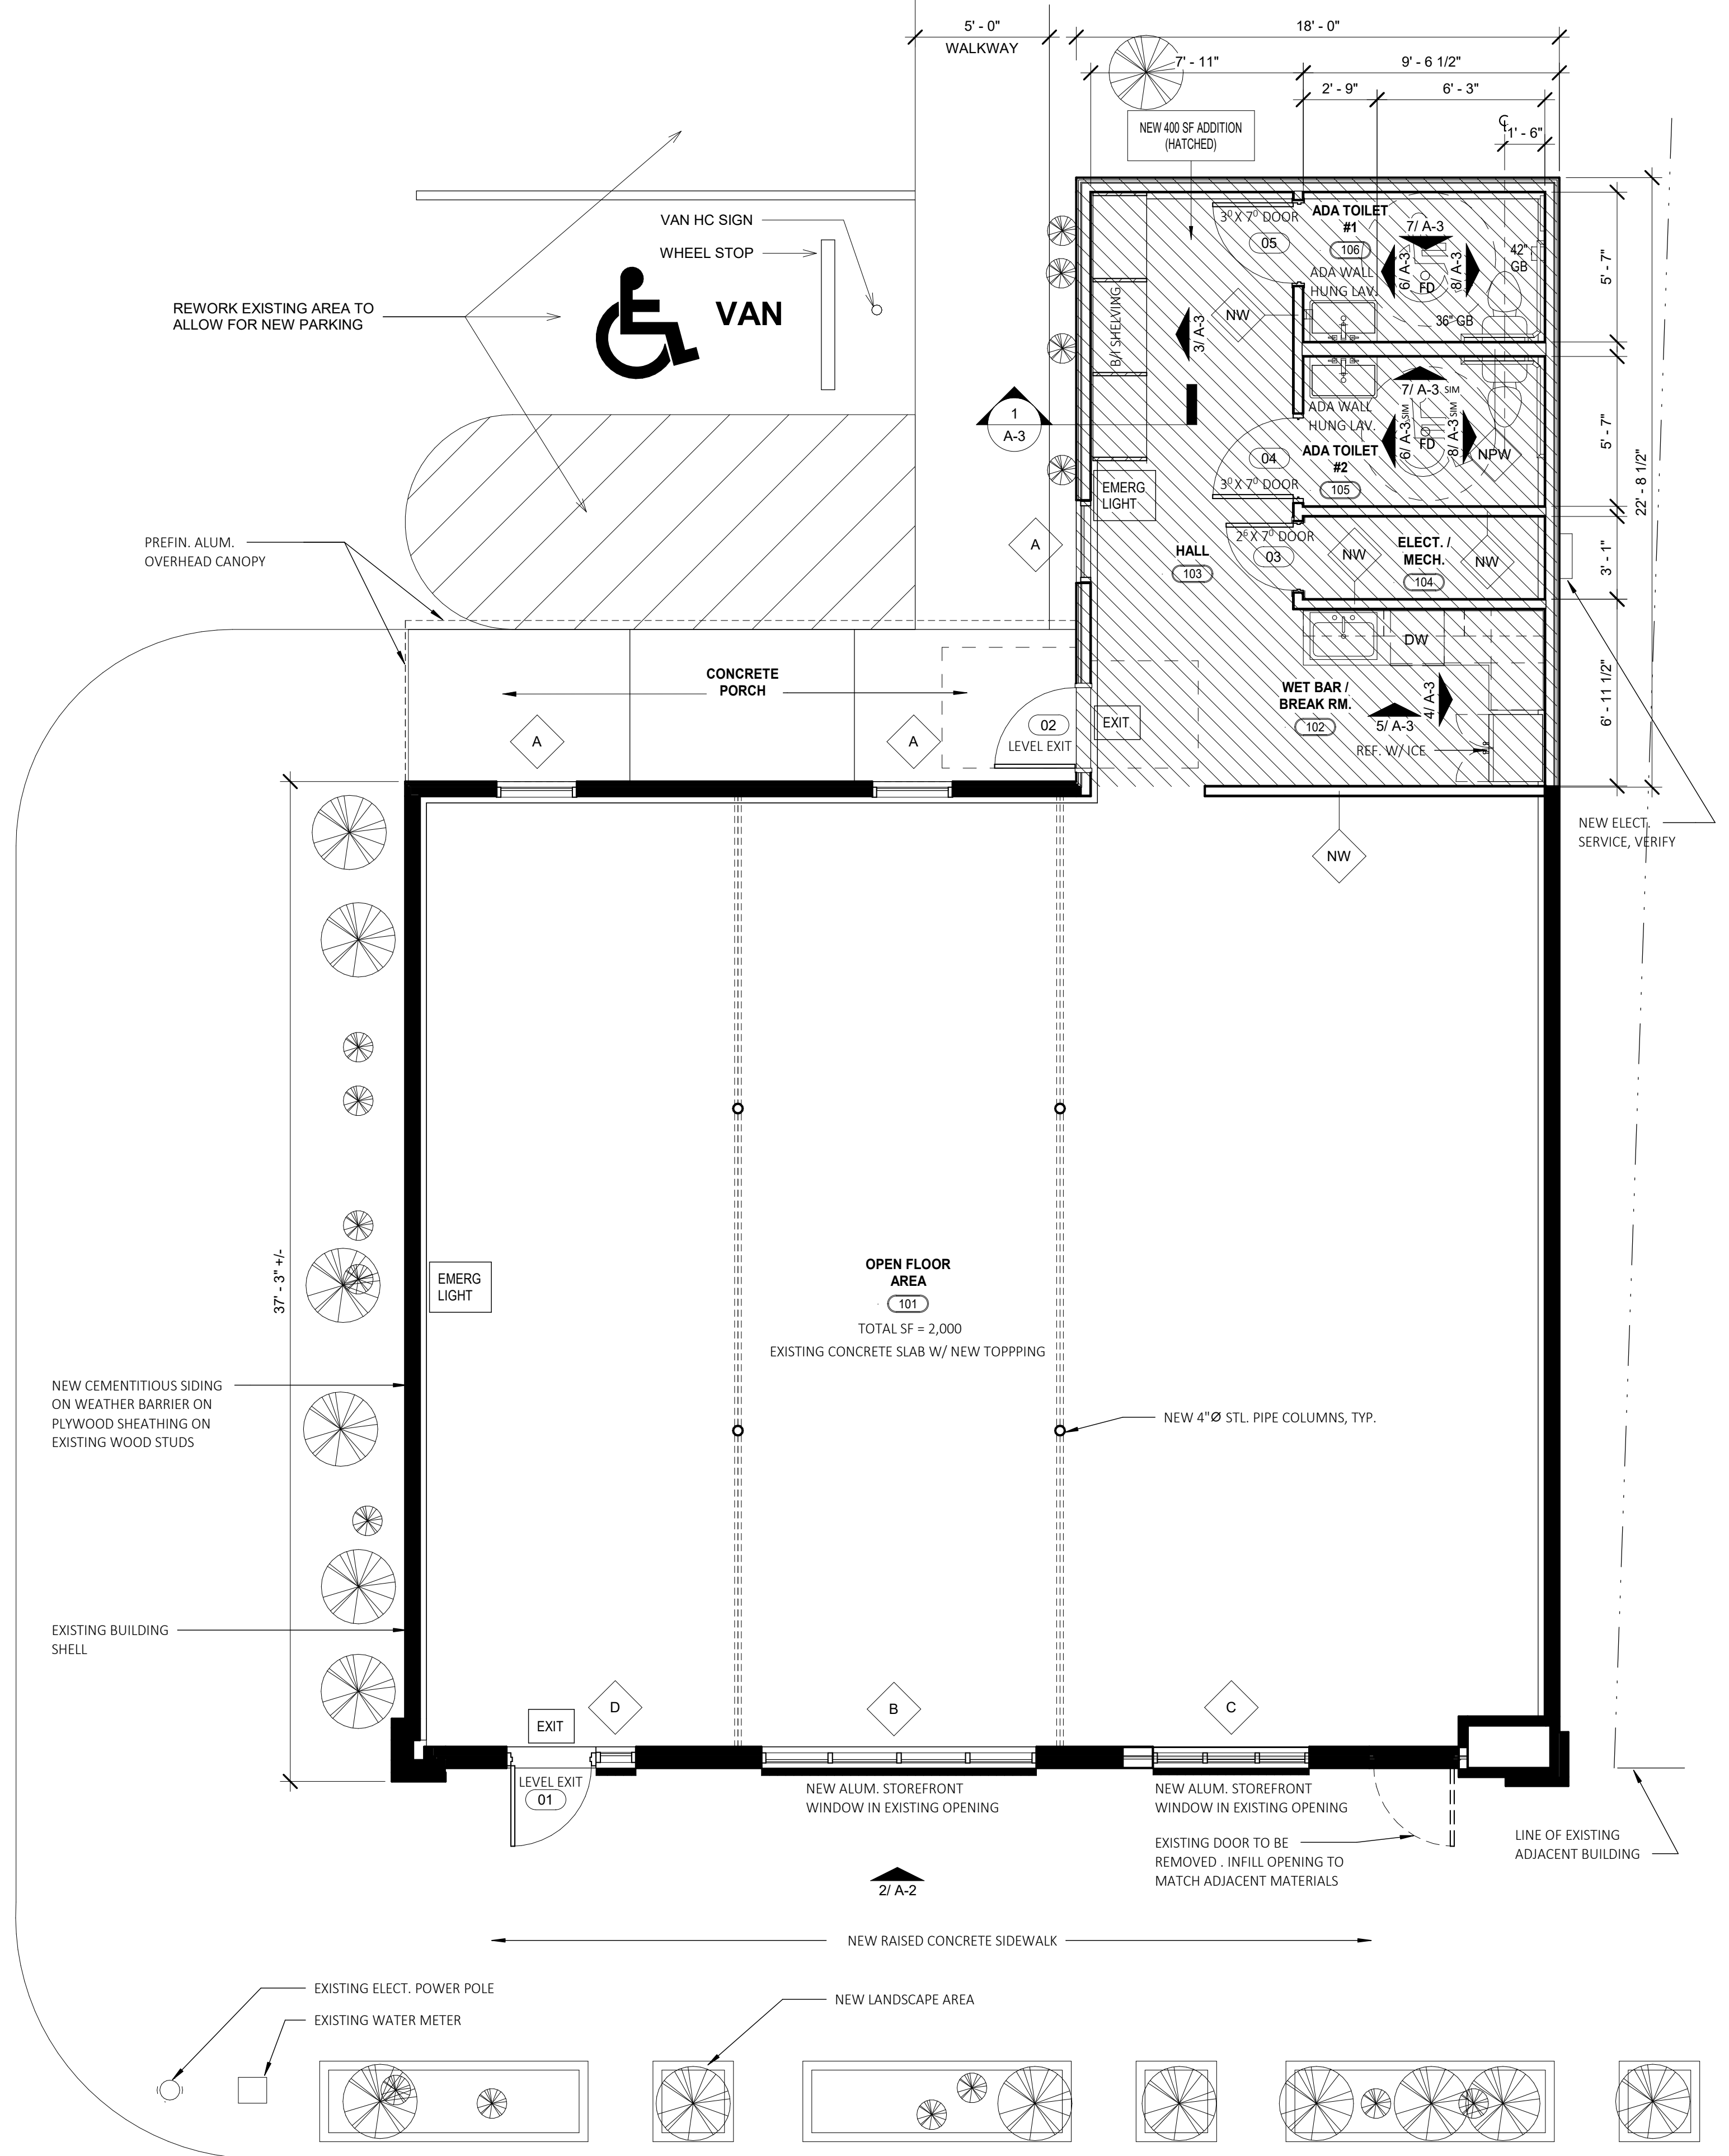

**FLOOR PLAN NOTES**


1. EXISTING CONCRETE SLAB AND FRAMING TO BE REUSED
2. EXISTING UTILITY SERVICES SERVING BUILDING ARE EXISTING TO REMAIN.
3. EXISTING WOOD STUD WALLS AND CEILING JOISTS TO REMAIN
4. NEW GYP BOARD WALLS AND CEILING
5. NEW PLANTING AREAS
6. NEW INSULATION
7. NEW WINDOWS
8. NEW DOORS
9. NEW CABINETS

1 FLOOR PLAN  
1/4" = 1'-0"

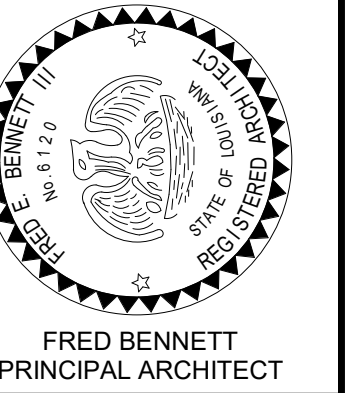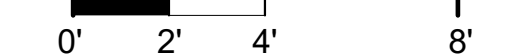

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INTERIOR / EXTERIOR BUILDING RENOVATIONS  
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MONROE, LA 71201**  
LUDELING PROPERTIES, LLC

DRAWING REVISIONS  
NO. DESCRIPTION DATE  
1 PERMIT SET 01-19-2022

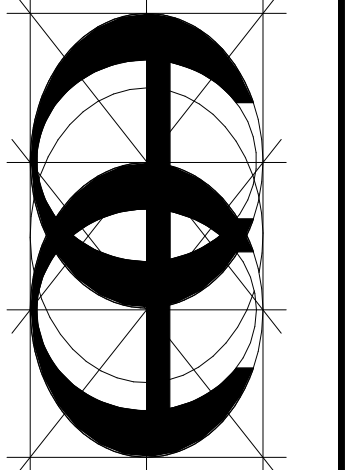DATE: JANUARY 19, 2022

SHEET No.

**A-2**

PROJECT No.  
21-220


FLOOR PLAN, EXTERIOR ELEVATIONS

1/19/2022 11:30:56 AM  
C:\Users\brett\_50gmp\Documents\1011 DESIARD ST\_V21\_batch\monr\YBKH.rvt  
© ARCHITECTURE ASSOCIATES, A PROFESSIONAL CORPORATION


**window notes:**

1. ALL EXTERIOR GLAZING SHALL BE 1" THK W/ LOW-E COATING. AT INTERIOR STOREFRONTS, PROVIDE 3/8" THK., CLEAR GLAZING.
2. PROVIDE TEMPERED GLAZING AS REQUIRED PER THE 2015 INTERNATIONAL BUILDING CODE AND / OR PER LOCAL BUILDING ORDINANCES.
3. INTERIOR / EXTERIOR STOREFRONT SYSTEM : 1 3/4" X 4 1/2" ANODIZED ALUM. (THERMALLY BROKEN AT EXTERIORS)
4. VERIFY ALL OPENING LOCATIONS WITH ARCHITECT PRIOR TO FRAMING ROUGH OPENING


**window types:**

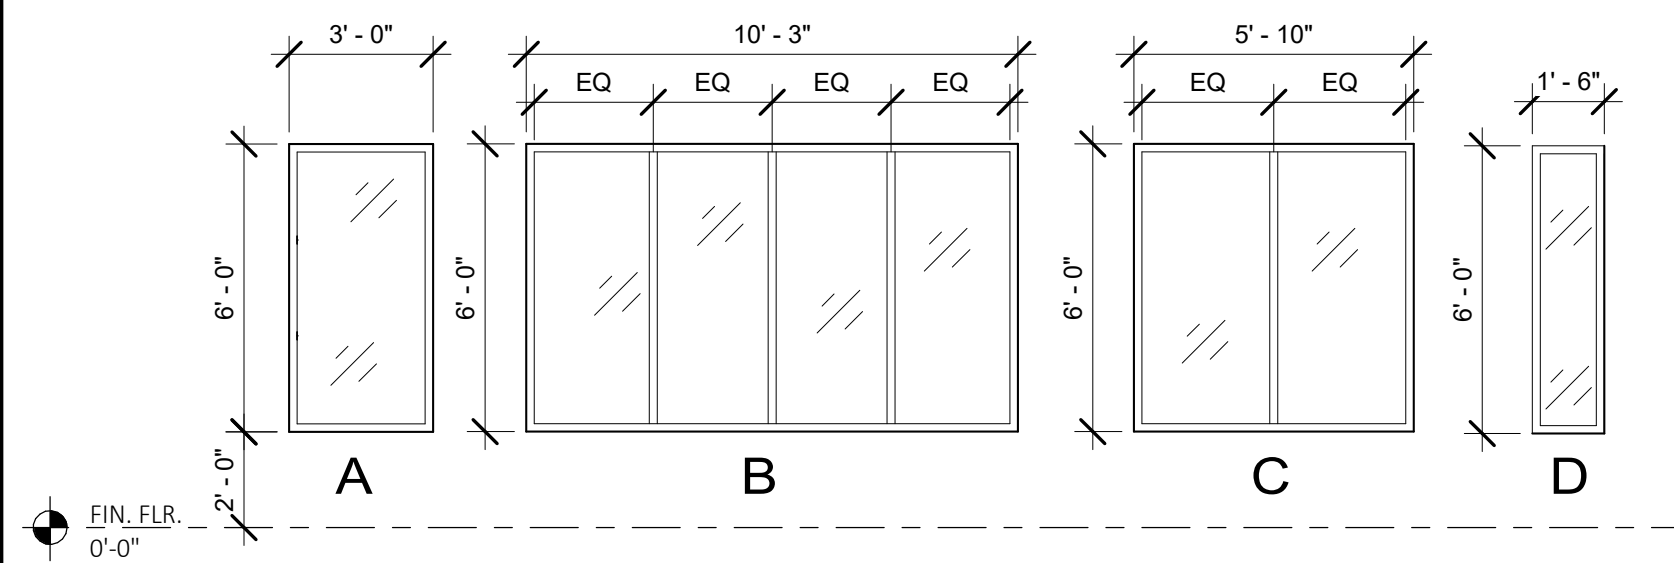

**door frame types:**

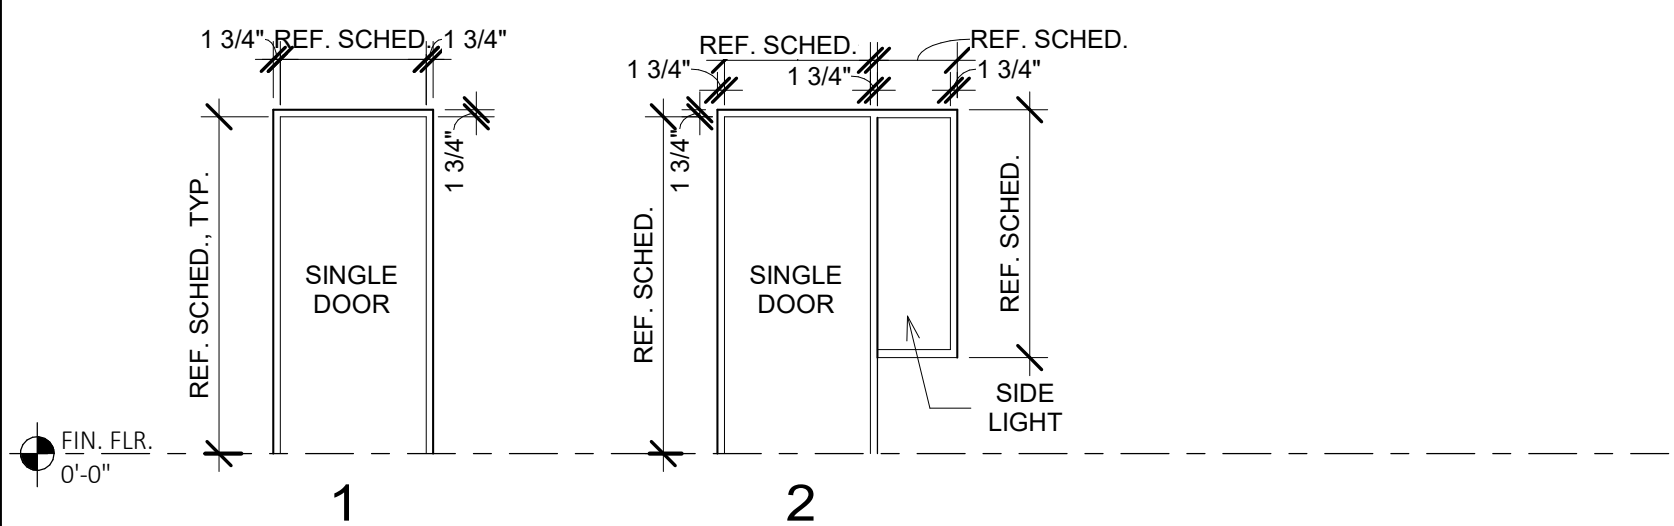

**door types:**

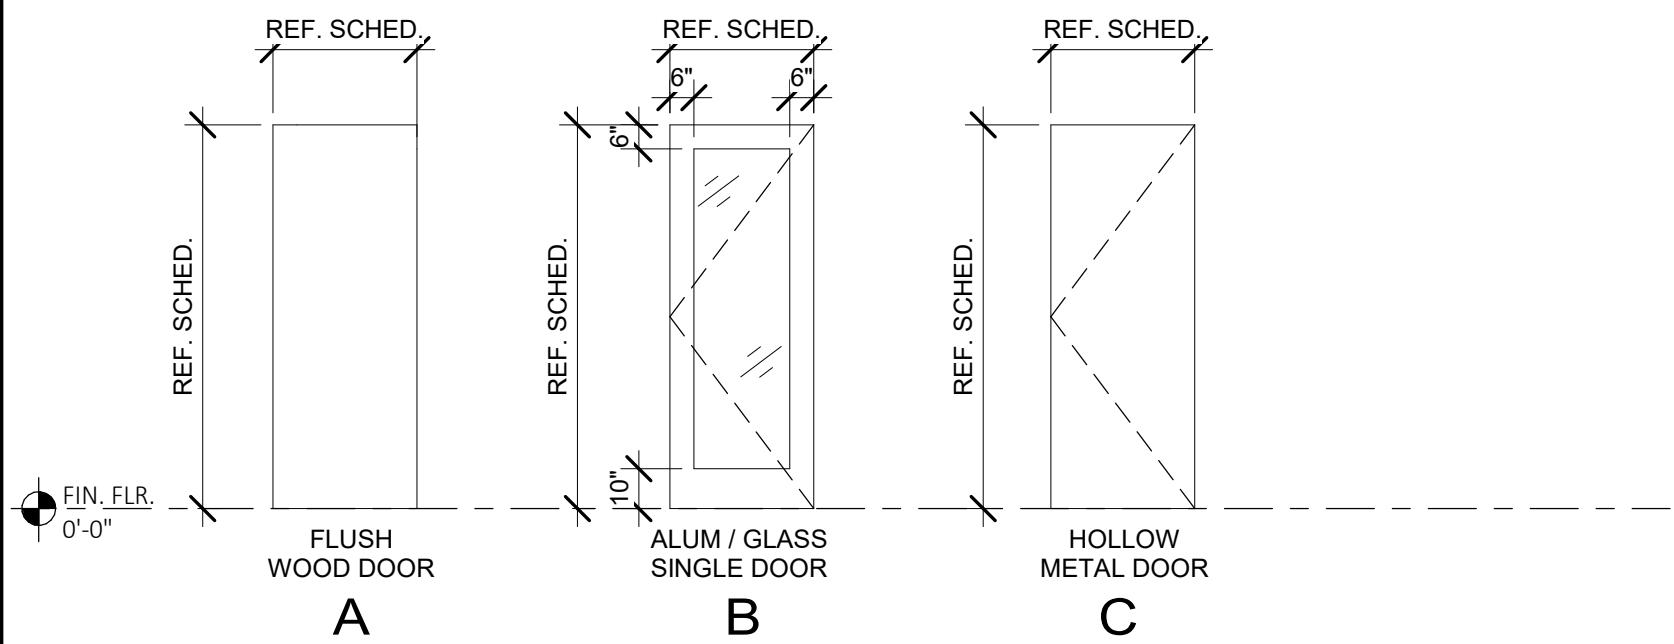

**door notes:**

1. ALL DOORS SHALL BE OPENABLE FROM THE INSIDE WITHOUT THE USE OF A KEY OR SPECIAL KNOWLEDGE OR EFFORT.
2. ALL DOOR HARDWARE SHALL BE LEVER TYPE, PUSH PULL ACTIVATING BARS OR PANIC HARDWARE PER CODE. SEE DOOR TYPES ABOVE.
3. ALL DOORS SHALL HAVE A 10" HIGH SMOOTH, UNINTERRUPTED SURFACE AT THE BOTTOM.
4. HAND ACTIVATED DOOR OPENING HARDWARE SHALL BE CENTERED BETWEEN 30" AND 44" ABOVE THE FLOOR. (U.O.N.)
5. THE WIDTH OF THE LEVEL AREA ON THE SIDE TO WHICH THE DOOR SWINGS SHALL EXTEND A MIN. OF 24" PAST THE STRIKE EDGE OF THE DOOR FOR EXTERIOR DOORS AND A MIN. OF 18" PAST THE STRIKE SIDE EDGE FOR INTERIOR DOORS. 12" CLEAR FLOOR SPACE IS REQUIRED AT THE PUSH SIDE OF INTERIOR DOORS, IF THE DOOR IS EQUIPPED WITH A CLOSER.
6. MAX EFFORT TO OPERATE DOORS SHALL NOT EXCEED 5 LBS, SUCH PULL OR PUSH EFFORT BEING APPLIED AT RIGHT ANGLES TO HINGED DOORS AND AT THE CENTER PLANE OF SLIDING OR FOLDING DOORS. COMPENSATING DEVICES OR AUTOMATIC DOOR OPERATORS MAY BE UTILIZED TO MEET THE ABOVE STANDARDS WHEN FIRE DOORS ARE REQUIRED THE MAX EFFORT TO OPERATE THE DOOR MAY BE INCREASED TO THE MAX ALLOWABLE BY THE APPROPRIATE ADMINISTRATIVE AUTHORITY, NOT TO EXCEED 15 LBS.
7. EXIT DOORS SHALL HAVE A DURABLE SIGN OF 1" HIGH LETTERS ON CONTRASTING BACKGROUND MOUNTED ON FIXED HEAD RAIL STATING: "THIS DOOR SHALL REMAIN UNLOCKED DURING BUSINESS HOURS" THE LOCKING DEVICE MUST BE A TYPE THAT WILL BE READILY DISTINGUISHABLE AS BEING LOCKED.
8. EXTERIOR DOORS TO BE KEYPED ALIKE BUT SEPARATELY FROM INTERIOR DOORS. INTERIOR DOORS TO BE KEYPED SEPARATELY WITH "MASTER KEY". PROVIDE (2) MASTER KEYS TO TENANT.
9. PROVIDE WEATHER STRIPPING AT HEAD JAMB AND SILL OF ALL EXTERIOR DOORS.
10. DOOR HARDWARE SHALL COMPLY WITH ADA REQUIREMENTS.
11. SEE FLOOR PLAN FOR ACCESS CONTROL AT ENTRY DOORS. SUPPLIER TO SUBMIT TO FIRE MARSHAL FOR REVIEW.

**door specifications:**

**NEW INTERIOR DOORS:**

NOTE: REUSE EXISTING DOORS, FRAMES & HARDWARE WHERE POSSIBLE


**TYPE A: TYPICAL INTERIOR DOOR - NON-RATED**

**DOOR:**  
 SIZE: 3'-0"x7'-0"  
 MFR: MARSHFIELD ACCENT SERIES or BLDG. STD.  
 TYPE: SOLID CORE / NON-RATED  
 VENEER: PLAIN SLICED WHITE BIRCH - or BLDG. STD.  
 FINISH: ON SITE FINISH

**FRAME:**  
 MFR: WOOD  
 TYPE: WOOD W/ 2"x5/8" WOOD CASING  
 FINISH: PAINT FRAMES IN FIELD. SEE SHEET A3.0 FOR PAINT COLOR & SPECIFICATIONS.

**LEVERSET:**  
 MFR: SCHLAGE or BUILDING STANDARD  
 TYPE: LEVER ACTIVATED LOCKSET  
 QUALITY: SPARTA or BLDG. STD.  
 FINISH: #626 SATIN CHROME

**HARDWARE:**  
 BUTTS: (2) PAIR EACH DOOR / #626  
 DOOR STOP: FLOOR MOUNTED / SATIN CHROME w/ GREY VINYL STOP  
 CLOSER: PER SCHEDULE / CONCEALED HINGE CLOSER WHERE OCCURS.

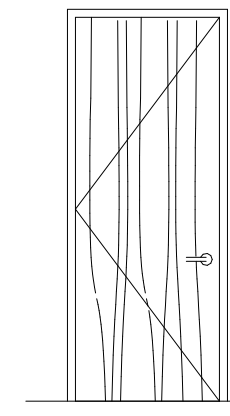

**door schedule**

DOOR NO	DOOR TYPE	DOOR SIZE		DOOR THICKNESS	DOOR FINISH	DOOR CORE MATL	FRAME TYPE	FRAME MATL	FIRE RATING	HARDWARE	REMARKS
		WIDTH	HEIGHT								
01	B	3'-0"	7'-8"	1 3/4"	GL/AL	GL	2	AL	---	---	
02	72	3'-0"	8'-0"		H.M.	INSUL. HM	1	HM	-	---	
03	A	2'-6"	7'-0"	1 3/4"	WD.	PC CORE	1	AL	---	---	
04	A	3'-0"	7'-0"	1 3/4"	WD.	PC CORE	1	AL	---	---	
05	A	3'-0"	7'-0"	1 3/4"	WD.	PC CORE	1	AL	---	---	

**window schedule**




TYPE MARK	APPROX. WIDTH	APPROX. HEIGHT	COMMENTS
A	3'-0"	6'-0"	
B	10'-3"	6'-0"	
C	5'-10"	6'-0"	
D	1'-6"	6'-0"	

**partition plan notes:**


1. WRITTEN DIMENSIONS ON THESE PLANS SHALL TAKE PRECEDENCE OVER SCALED DIMENSIONS. GENERAL CONTRACTOR TO VERIFY ALL DIMENSIONS AND NOTIFY PROJECT MANAGER OF ANY DISCREPANCIES PRIOR TO PROCEEDING WITH CONSTRUCTION. ALL DIMENSIONS ARE TO FINISHED SURFACE.
2. ALL DRYWALL SURFACES TO MATCH EXISTING BUILDING STANDARDS. G.C. TO VERIFY WITH THE BUILDING OWNER PRIOR TO CONSTRUCTION.
3. G.C. TO TEST FOR MOISTURE PROBLEMS @ FLOOR SLAB. SUBMIT RESULTS AND RECOMMENDED SOLUTIONS TO BUILDING OWNER/DESIGNER FOR REVIEW PRIOR TO START OF CONSTRUCTION.
4. G.C. TO REVIEW ALL SITE ACCESSIBILITY ISSUES W/ CITY OFFICIAL AT FIRST JOB SITE INSPECTION. NOTIFY PROJECT MANAGER IMMEDIATELY OF ANY UNFORESEEN IMPROVEMENT ISSUES.
5. PROVIDE WOOD BACKING BEHIND DRYWALL FOR ALL WALL MOUNTED CABINETS/EQUIPMENT. SEE ELEVATIONS FOR EXACT LOCATIONS.
6. FIRE EXTINGUISHER LOCATIONS AND QUANTITIES TO BE VERIFIED BY FIRE MARSHALL. G.C. TO REVIEW LOCATIONS WITH PROJECT MANAGER PRIOR TO INSTALLATION.
7. SMOKE & FIRE DAMPERS SHALL BE INSTALLED PER CODE AT ALL DUCTED & UNDUCTED AIR OPENINGS AT PENETRATIONS OF FIRE RESISTIVE CONSTRUCTION & ELEVATOR LOBBIES. CEILING
8. OF FIRE-RESISTIVE FLOOR-CEILING ASSEMBLIES AS REQUIRED. "FIRE AND/OR SMOKE DAMPER(S)" ASSEMBLIES, INCLUDING SLEEVES & INSTALLATION PROCEDURES SHALL BE APPROVED BY THE BUILDING INSPECTOR PRIOR TO INSTALLATION.
9. PLANS FOR ALL FIXED FIRE PROTECTION EQUIPMENT SUCH AS FIRE EXTINGUISHERS, SMOKE DETECTORS AND FIRE ALARM SYSTEMS MUST BE SUBMITTED TO AND APPROVED BY THE FIRE MARSHALL BEFORE THIS EQUIPMENT IS INSTALLED.
10. PENETRATIONS OF FIRE RESISTIVE WALLS, FLOORS-CEILING & ROOF CEILING SHALL BE PROTECTED AS REQUIRED BY CURRENT CODE.
11. ALL NEW VERTICAL FIRE RESISTANT / RATED ASSEMBLIES SHALL BE IDENTIFIED BY SIGNAGE LOCATED ON THE ASSEMBLY ABOVE THE CEILING. THE SIGNAGE IS TO HAVE LETTERS NO SMALLER THAN 1" IN HEIGHT THAT STATES, "FIRE RATED ASSEMBLY", AND GIVING THE HOURLY RATING OF THE ASSEMBLY. SIGNAGE IS TO BE PLACED AT 8'-0" INTERVALS AND SHALL BE PLACED ON BOTH SIDES OF THE WALL.
12. REFER TO FINISH PLAN, FOR FINISH SPECIFICATIONS AND LOCATIONS.

**keynotes:**

1. PROVIDE 4'x8' SHEET OF 3/4" THICK PLYWOOD MOUNTED TO WALL FOR PHONE BACKBOARD, ETC. PAINT PLYWOOD WITH FIRE RESISTANT PAINT. PAINT COLOR TO MATCH ADJACENT WALL.
2. PROVIDE SOUND BATT INSULATION INSIDE WALL PARTITIONS & ABOVE THE CEILING 24" EACH SIDE OF PARTITION THIS ROOM(S) ONLY.

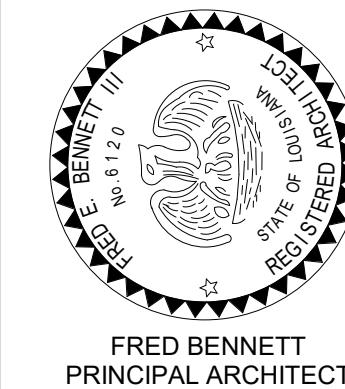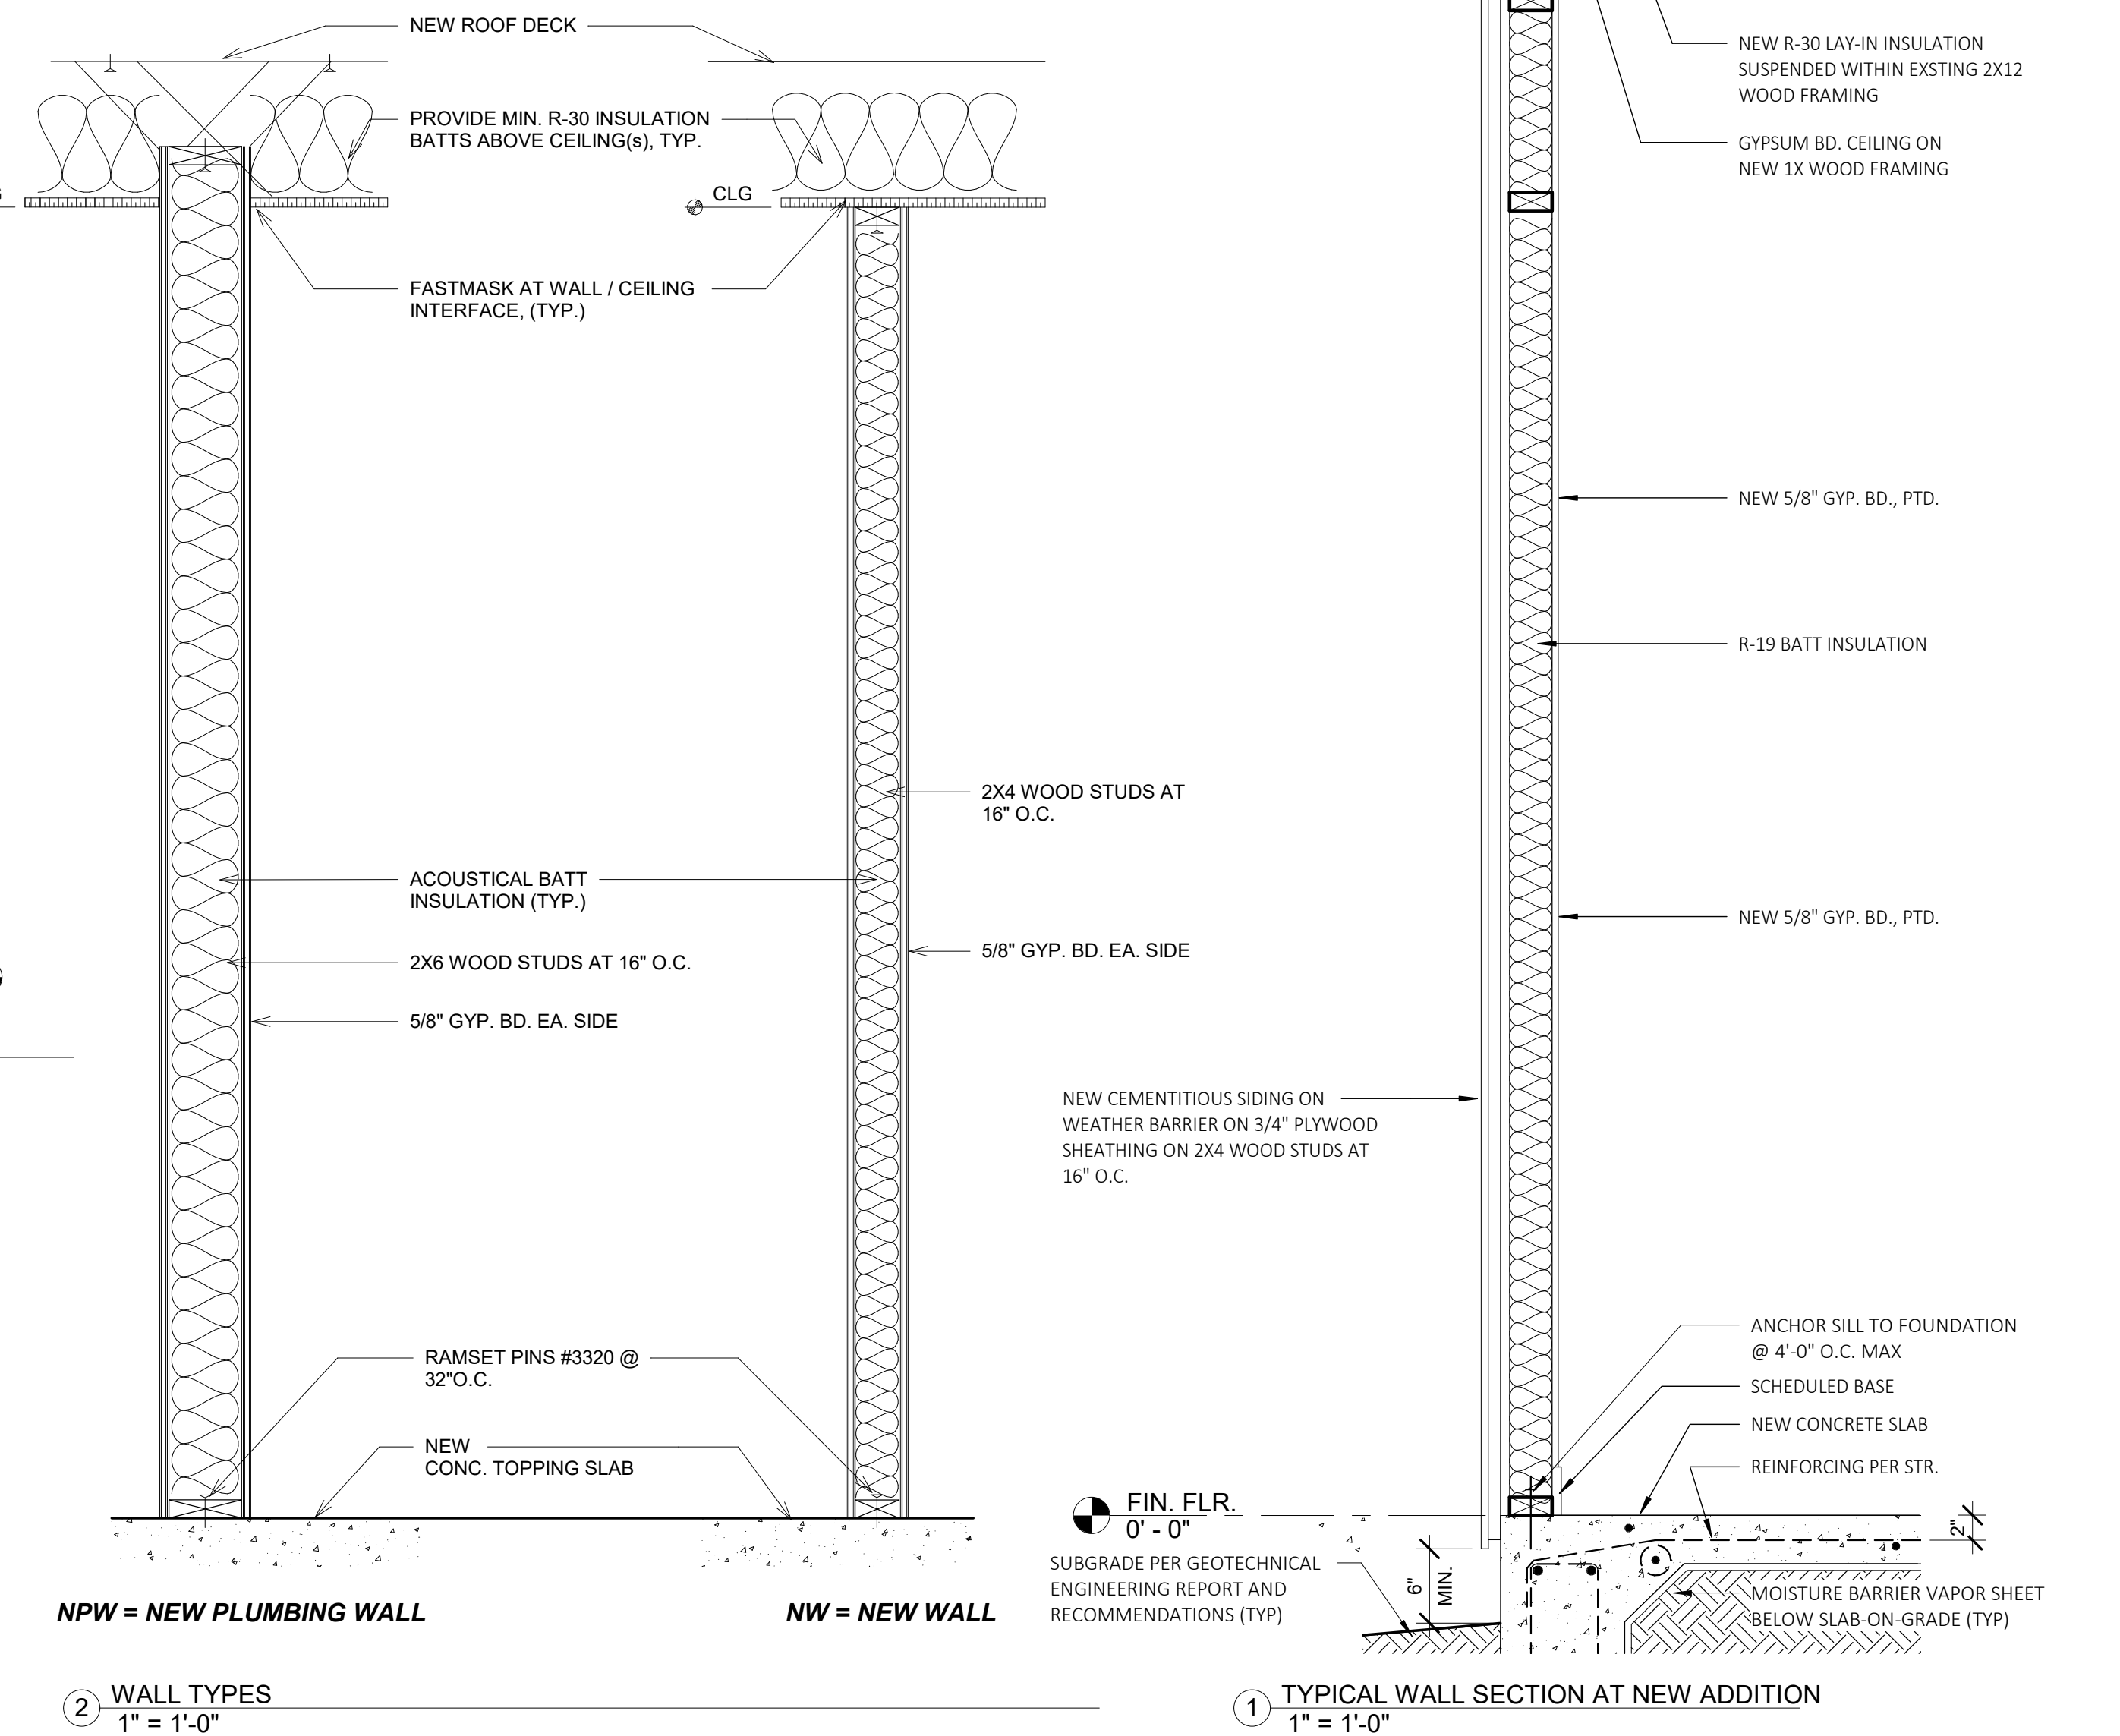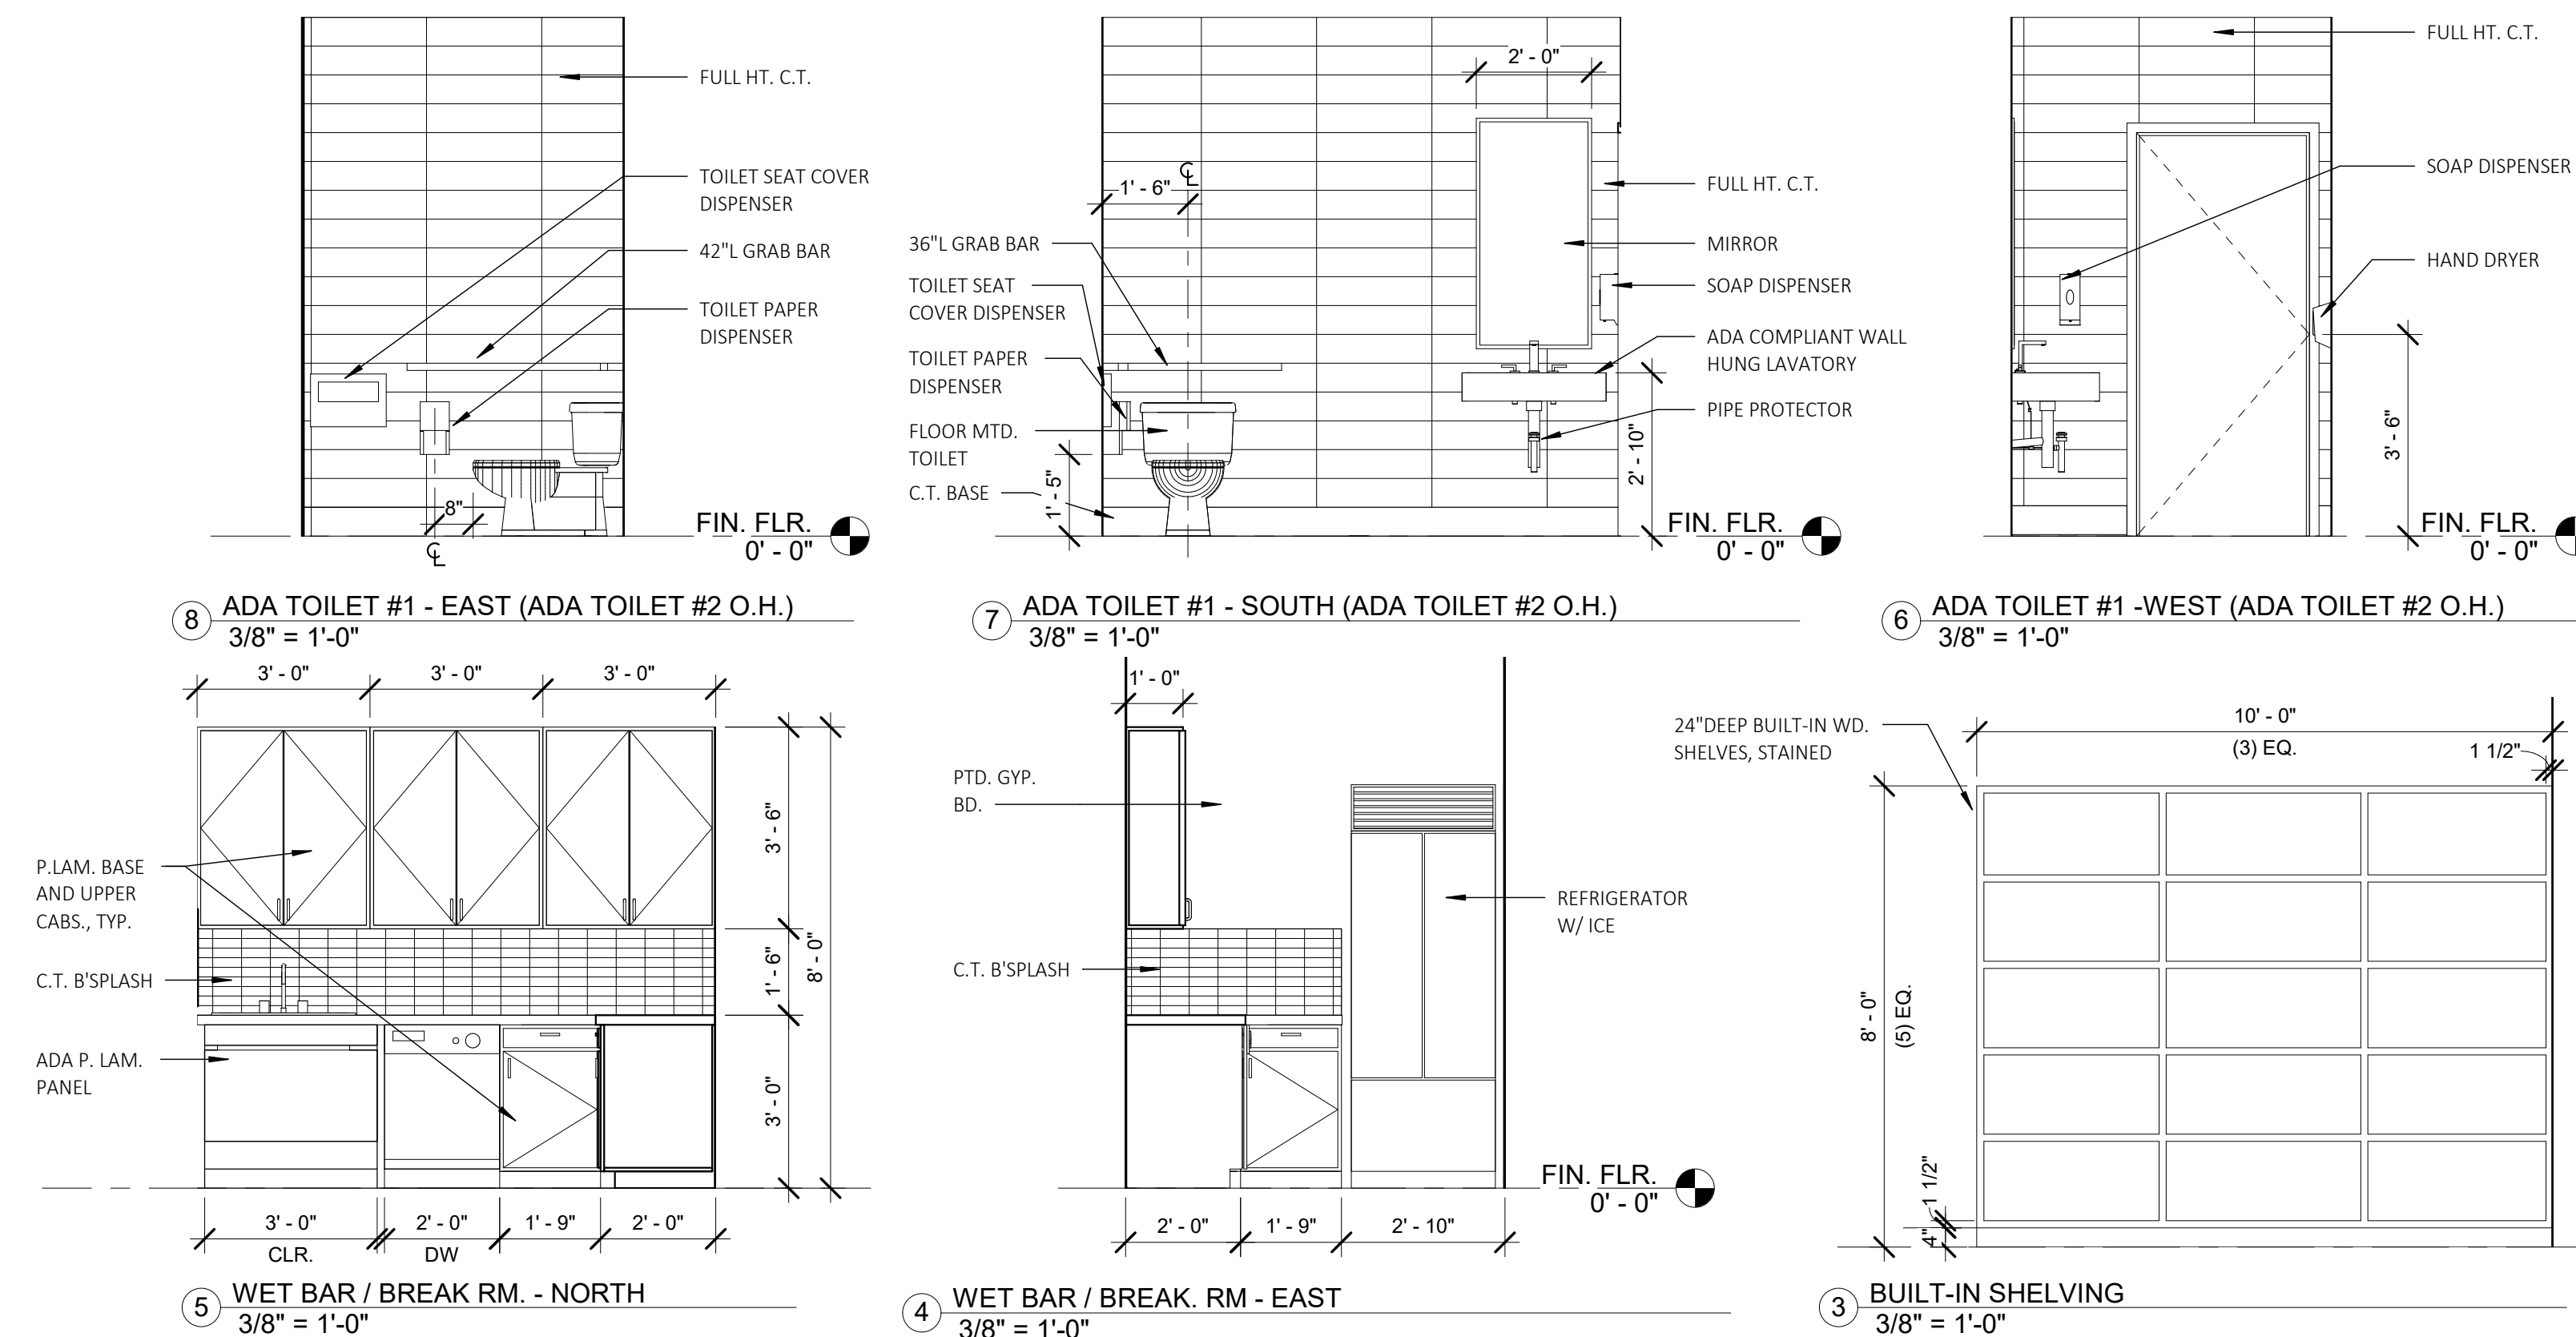

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DATE: JANUARY 19, 2022

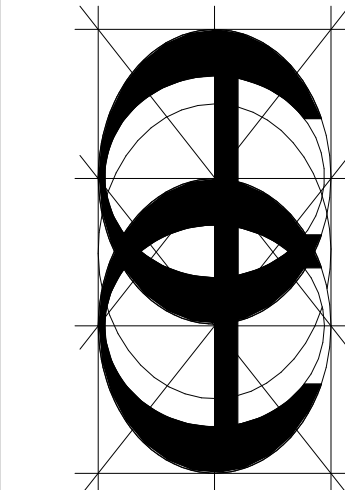SHEET No.  
**A-3**

PROJECT No.  
 21-220

TYPES, SCHEDULES, AND ELEVATIONS