Oklahoma City

420 W Main St., 8th Floor Oklahoma City, OK 73102



Final Report - Approved

Application No. BLDC-2022-07209

Description: Internal remodel of office space into orthopedic medical clinic where office hours are 10 am to 7 p.m. Patients do not stay overnight and this is not

considered a true emergency medical clinic. (see attached letter from medical director)

Address: 2220 164TH ST N/A, OKLAHOMA CITY, OK, 73013

Record Type: Building - Commercial

Document Filename: BLDC-2022-07209 DOC-Edmond Rev2 Drawings 9.28.22.pdf

Comment Author Contact Information:

Author Name	Author Email	Author Phone No.:
Tonya Marti	tonya.marti@okc.gov	405-297-2722

General Comments

Comment ID	Author : Department	Status	General Comments	Applicant Response Comments
2	Tonya Marti : Development Services	Open	2015 IBC 505.2.3 A MEXXANINE SHALL BE OPEN AND UNIBSTRUCTED TO THE ROOM IN WHICH SUCH MEZZANINE IS LOCATED EXCEPT FOR WALLS NOT MORE THAN 42 INCHES IN HIEGHT, COLUMNS AND POSTS.	
6	Tonya Marti : Development Services	Open	any equipment attached to the slab will require a separate permit	
11	Tonya Marti : Development Services	Open	1 hr rated corridor with 20 min doors and closers	
15	Tonya Marti : Development Services	Open	Code Review: 2015 IEBC, 2015 IBC Scope of Work: CAHNGE OF USE REMODEL Type of Construction: VB Use Group: B/A-3/S-1 Sprinkler: NO Occupancy Load: 88 Zoning: PUD-923 Last CO: BLDC-2015-00348 This Review Covers Building Code Compliance Only: All Other Work, i.e., Mechanical, Electrical, Plumbing, etc., Shall Comply with Their Respective Codes.	

Comment ID	Author : Department	Status	General Comments	Applicant Response Comments
			The Owner Must Independently Achieve Compliance with The Americans With Disabilities Act. All work shall comply with all local ordinances and codes, including all applicable sections of the International Building Code as adopted by The City of Oklahoma City. An approved set of building plans, along with the review worksheet(s), must be on the site at all times. Remodel as per approved plans	
16	Tonya Marti : Development Services	Open	Emergency egress lighting & illuminated exit signs including Tactile Exit Signs at req'd doors. Code Reference: IBC 2015 SECTION 1008 MEANS OF EGRESS ILLUMINATION	
17	Tonya Marti : Development Services	Open	Restroom (s) to comply with ICC/ANSI Standard. 36" rear, 42" side and 18" vertical grab bars required in accessible stall. – Code Reference: ICC/ANSI A117.1 Sections 604.5.1 Fixed Side Wall Grab Bars & 604.5.2 Rear Wall Grab Bars 16" min. and 18" max. req'd from wall to C.L. of WC Code Reference: ICC/ANSI A117.1 Sections 604 Water Closets and Toilet Compartments (604.2 Location) 60" clear required from WC wall to sink/ cabinet edge. Code Reference: ICC/ANSI A117.1 Sections 604 Water Closets and Toilet Compartments (604.3 Clearance) Maximum 34" height req'd for accessible sink(s) including breakroom sink. Code Reference: ICC/ANSI A117.1 Sections 606 Lavatories and Sinks (606.3 Height) Maintain a clear path/aisle to exits. Code Reference: IBC 2015 SECTION 1018 AISLES Mounting heights of all accessible elements must comply with ICC/ANSI A117.1.	
18	Tonya Marti : Development Services	Open	An accessible route at least 36" wide must be provided at all accessible elements. Code Reference: ICC/ANSI A117.1 Section 403.5 Clear Width	
19	Tonya Marti : Development Services	Open	Interior exit stairways, ramps, and exit passageways must have a Class A: = Flame spread index = 0-25 and smoke developed index = 0-450. Corridors and enclosures for exit access stairways and ramps must have a Class B: = Flame spread index = 26-75 and smoke developed index = 0-450. Rooms and enclosed spaces must have a Class C: = Flame spread index = 76-200 and smoke developed index = 0-450. Code Reference: IBC 2015 Table 803.11 Interior Wall And Ceiling Finish Requirements By Occupancy	
20	Tonya Marti : Development Services	Open	THIS REVIEW COVERS BUILDING CODE COMPLIANCE ONLY: ALL OTHER WORK, ie., MECHANICAL, ELECTRICAL, PLUMBING, ETC., SHALL COMPLY WITH THEIR RESPECTIVE CODES	
21	Tonya Marti : Development Services	Open	Accessible service counter req'd- Max. 36" high/ Min 36" wide Code Reference: ICC/ANSI A117.1 904.3 Sales and Service Counters	

Corrections in the following table need to be applied before a permit can be issued

Comment ID	Page Reference	Annotation Type	Author : Department	Status	Page	Review Comments	Applicant Response Comments
	A-Cover Sheet	Callout	Tonya Marti : Development Services	Open	1	2017 NEC	

DIRECTOR OR THE PROVISIONS OF THE OKLAHOMA CITY BUILDING FODE CIT

2220 NW 164TH STREET

EDMOND, OKLAHOMA 73013

INTERIOR IMPROVEMENTS

THIS SHEET IS PART O THE APPROVED PLAN\$ CITY OF OKLAHOMA CITY DEVELOPMENT CENTER

VICINITY PLAN
SCALE: NOT TO SCALE

= 5,321 SQ. FT.

= 345 SQ. FT.

CODE INFORMATION

TOTAL CALCULATED OCCUPANT LOAD (DIRECT ORTHO. CARE)= 87 OCCUPANTS 12

B- BUSINESS. A-2 AND A-3 ASSEMBLY USES PER 2015 INTERNATIONAL BUILDING CODE.

B- BUSINESS. A-2 AND A-3 ASSEMBLY USES PER 2015 INTERNATIONAL FIRE CODE.

CONSULTANT:



PCD BUILDING CORP.

1503 CRISTY AVE. ORLANDO, FLORIDA 32803 PHONE: (407) 782-5262

CONTACT: PAUL DOUGHERTY, PRESIDENT EMAIL: PAUL@PCDBUILDINGCORP.COM

ARCHITECT:



C4 ARCHITECTURE, LLC

135 W. CENTRAL BLVD. SUITE 400 ORLANDO, FLORIDA 32801 PHONE: (407) 363-6136 EXT. 207

CONTACT: MICHAEL J. ALBANESE, RA, NCARB EMAIL: MALBANESE@C4ARCHITECTURE.COM

MECHANICAL ENGINEER:

EIERMANN ENGINEERING

1015 WEBSTER AVENUE ORLANDO, FLORIDA 32804 PHONE: (407) 296-6991

CONTACT: ERIC EIERMANN, PE **EMAIL: EEIENG@AOL.COM**

PLUMBING ENGINEER:

EIERMANN ENGINEERING

1015 WEBSTER AVENUE ORLANDO, FLORIDA 32804 PHONE: (407) 296-6991

CONTACT: ERIC EIERMANN, PE EMAIL: EEIENG@AOL.COM


ELECTRICAL:



ECLEAR CLEAR ENGINEERING

13651 CRYSTAL RIVER DRIVE ORLANDO, FLORIDA 32828 PHONE: (407) 277-3431

CONTACT: SERGIO ROIG, PE **EMAIL: SERGIO@CLEAR-ENGR.COM** ENGINEER OF RECORD: ERIC EIERMANN, PE

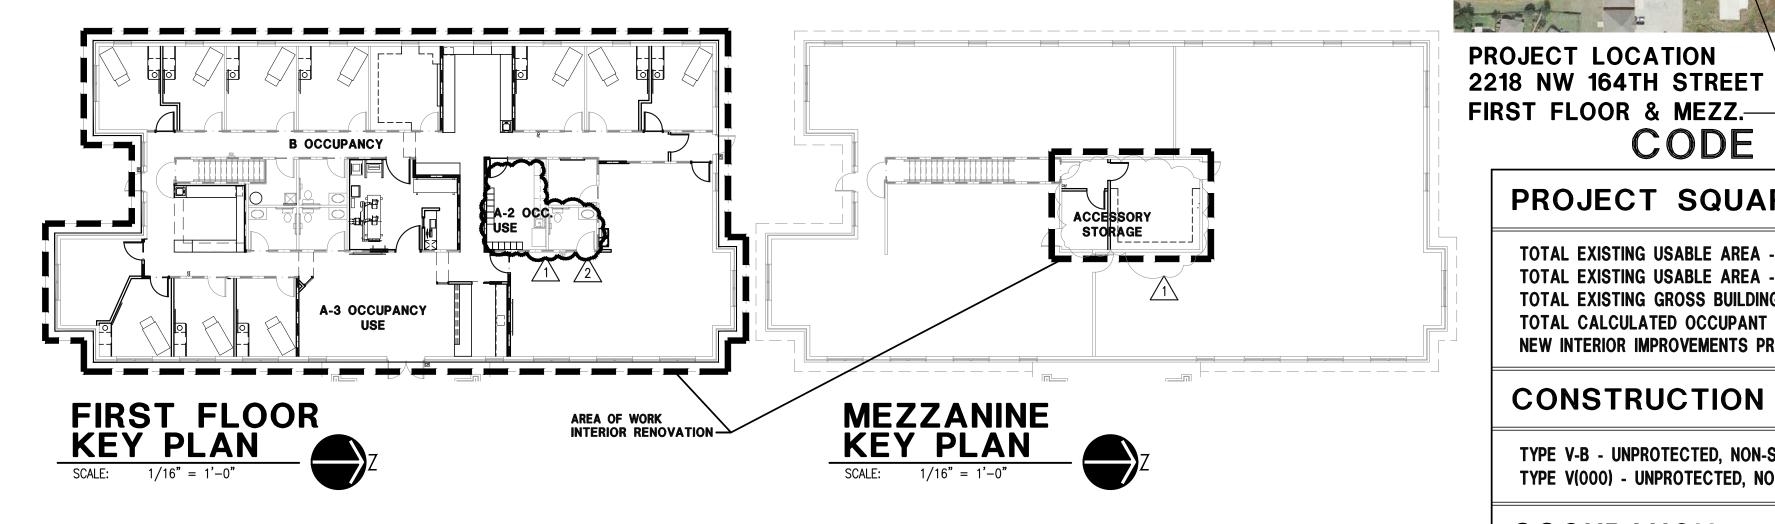

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MECHANICAL

	•		6/22 6/22 6/22 6/22	2/22 2/22 2/22 2/22	M100 M101 M200 M201	MECHANICAL MAIN FLOOR PLAN MECHANICAL MEZZANINE LEVEL PLAN MECHANICAL NOTES, DETAILS & SCHEDULES MECHANICAL NOTES, DETAILS & SCHEDULES
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PLUMBING

 6/22/2 6/22/2 6/22/2 	P100 P200 P300	FIRST LEVEL SANITARY FLOOR PLAN FIRST LEVEL DOMESTIC WATER PLAN SECOND LEVEL PLUMBING PLAN
6/22/26/22/2	P400 P500	PLUMBING SCHEDULES, NOTES & DETAILS PLUMBING ISOMETRICS

ELECTRICAL

Building plans must remain

ELECTRICAL NOTES, SYMBOLS & DIAGRAM

on construction site during construction.

2017 NEC

• 2015 INTERNATIONAL BUILDING CODE

OCCUPANCY:

- 2014 NATIONAL ELECTRICAL CODE
- 2015 INTERNATIONAL PLUMBING CODE
- 2015 INTERNATIONAL MECHANICAL CODE
- 2015 INTERNATIONAL FIRE CODE
- 2009 AMERICAN NATIONAL STANDARDS INSTITUTE A117.1
- 2010 ADAAG ADA ACCESSIBILITY GUIDELINES

APPLICABLE BUILDING CODES:

• 2009 INTERNATIONAL ENERGY CONSERVATION CODE

NW 164TH ST

PROJECT SQUARE FOOTAGE:

TOTAL EXISTING USABLE AREA - FIRST FLOOR SUITE

TOTAL EXISTING GROSS BUILDING AREA SQUARE FEET

TOTAL EXISTING USABLE AREA - MEZZANINE

CONSTRUCTION TYPE:

MUNICIPALITY:

OKLAHOMA COUNTY, OKLAHOMA

PROPERTY ID # R211851010

PROPERTY DESCRIPTION:

PENN POINTE OFFICE PARK BLK 2 002 000 LOTS 2 & 3


NOTES:

PROPER OPERATION OF ALL SPECIFIED SYSTEMS, REGARDLESS OF WHETHER THOSE COMPONENTS ARE SHOWN ON THE DRAWINGS OR NOT. CONTRACTOR SHALL ALSO VERIFY THAT SPECIFIED COMPONENTS ARE COMPATIBLE WITH OTHERS WITHIN THE SAME SYSTEM AND WITH THE SYSTEM ITSELF.

PROJECT NO. 22199

/1\ CITY COMMENTS 9.23.22 DATE: /1\ CITY COMMENTS 9.28.22 JUNE 22, 2022



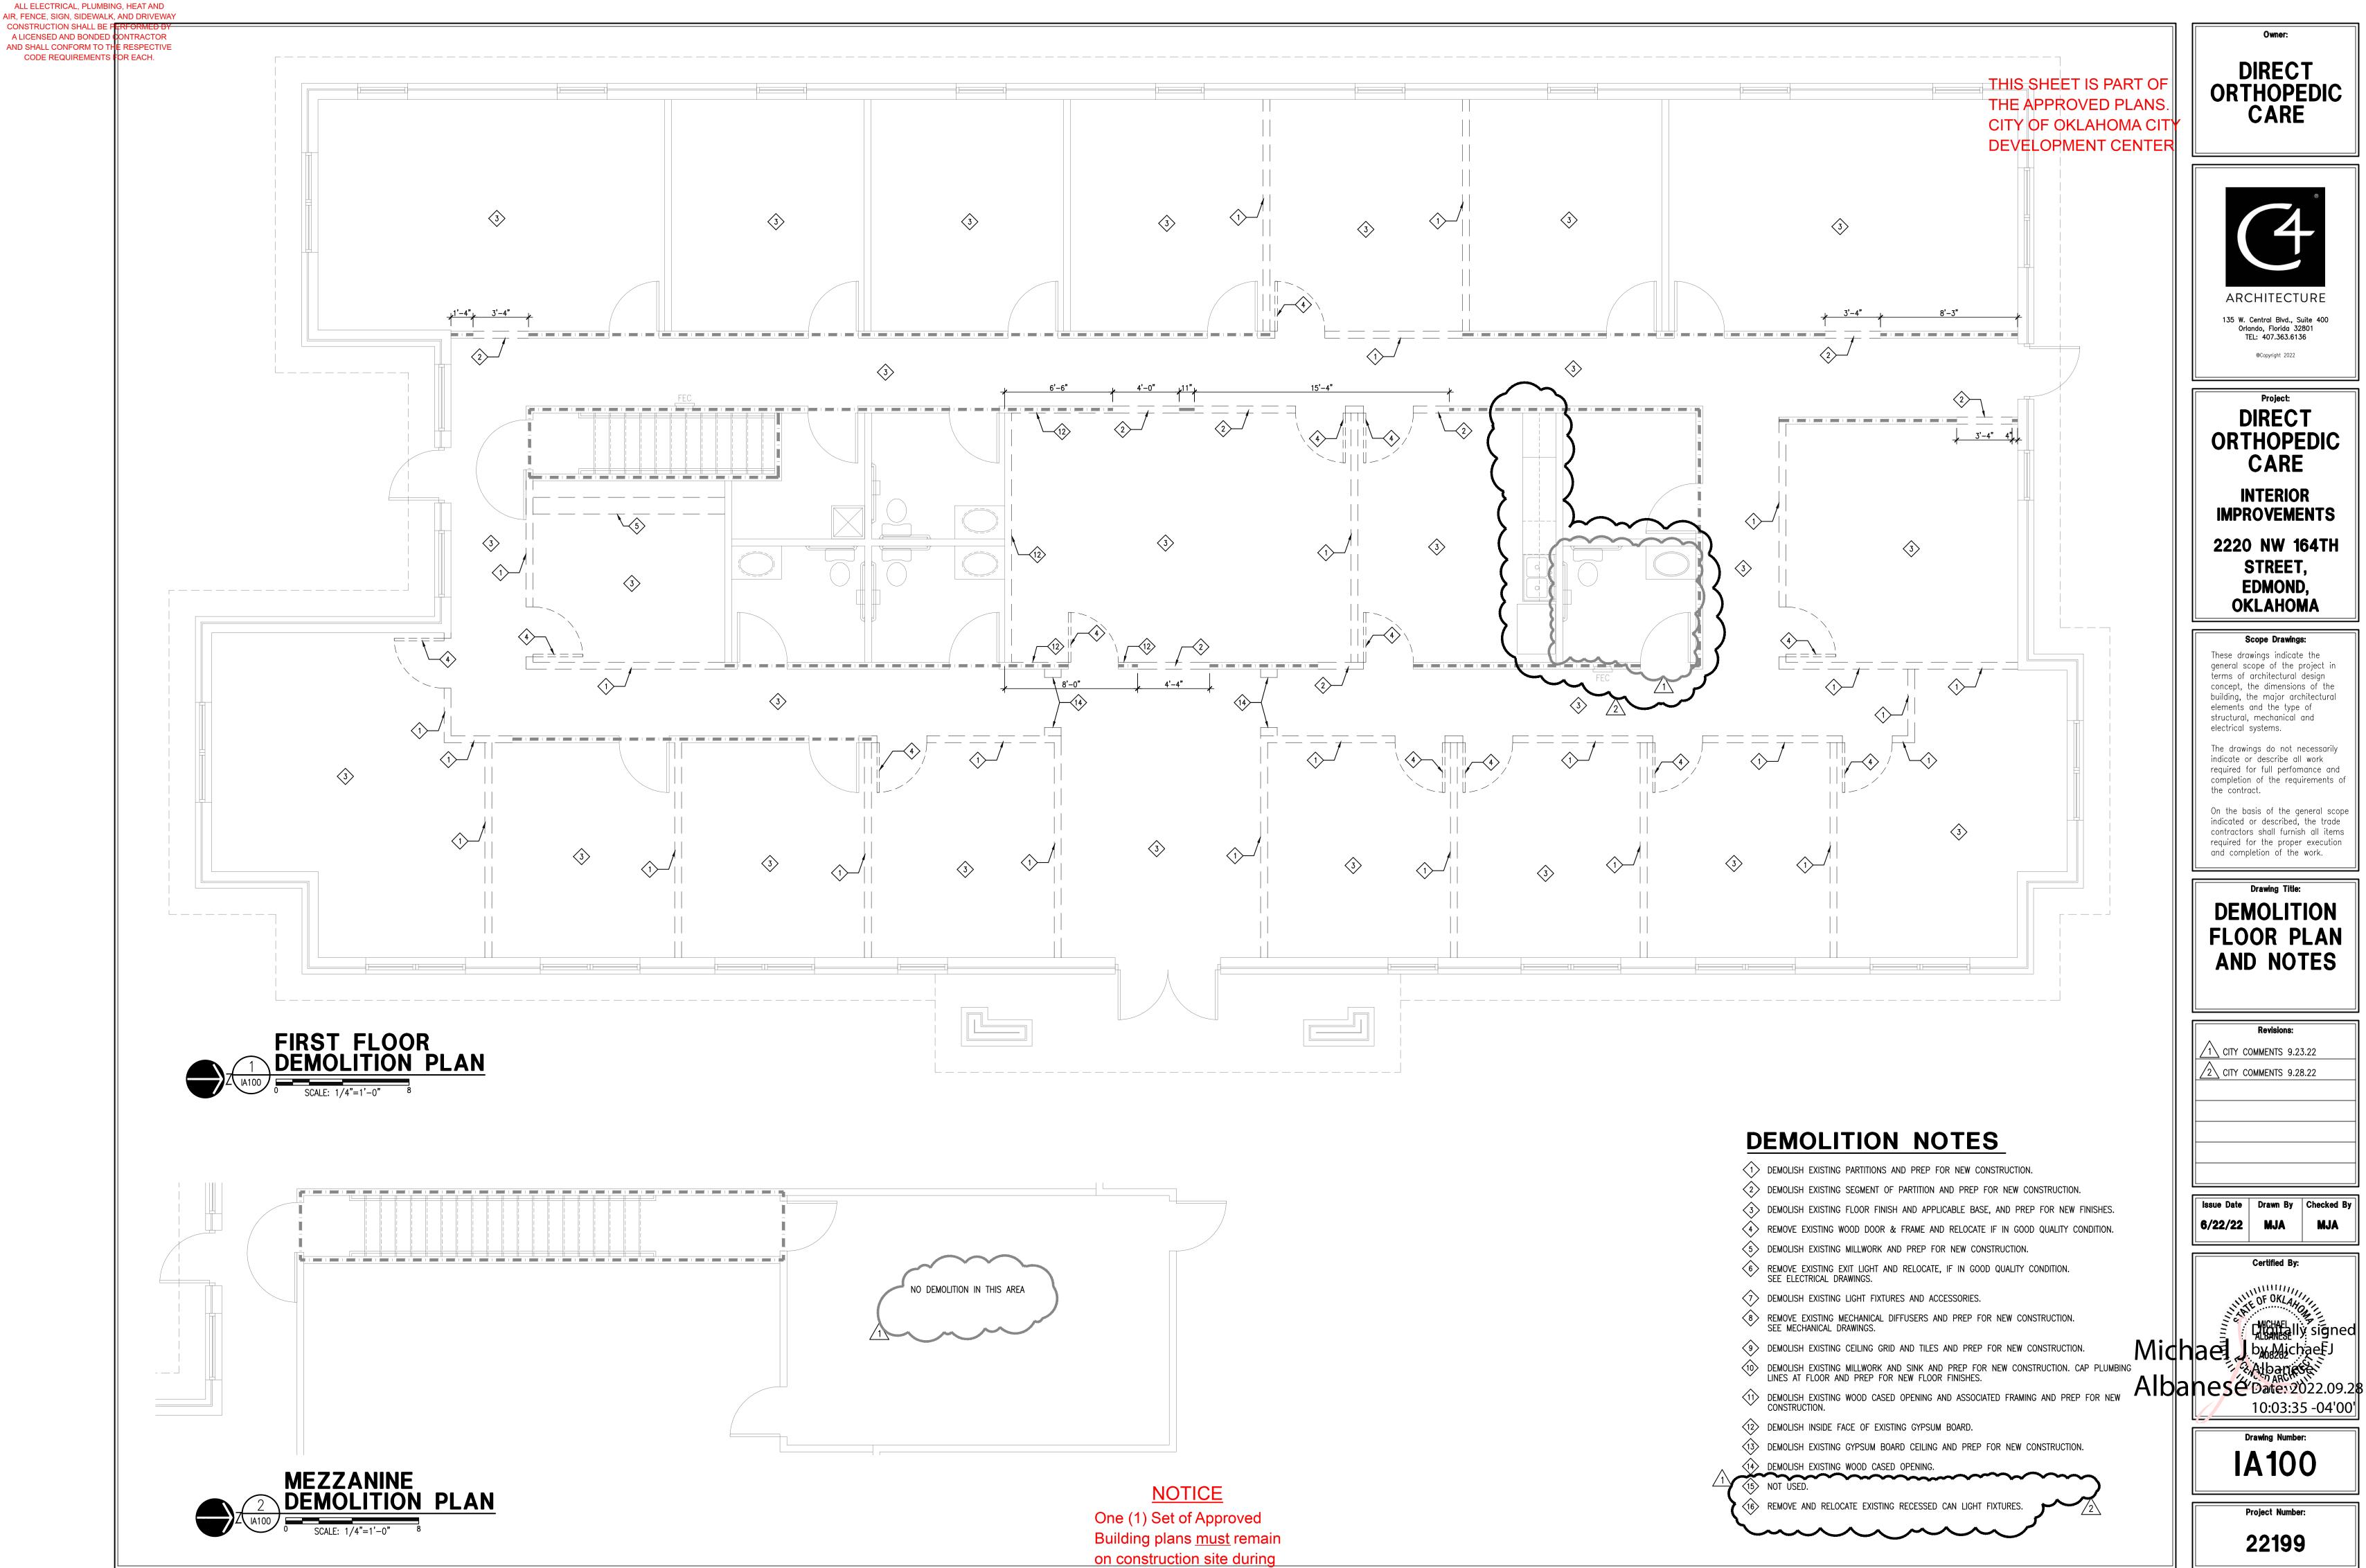

construction.

DIRECT ORTHOPEDIC CARE



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DIRECT ORTHOPEDIC CARE

INTERIOR IMPROVEMENTS

2220 NW 164TH STREET, EDMOND, **OKLAHOMA**

These drawings indicate the general scope of the project in terms of architectural design concept, the dimensions of the building, the major architectural elements and the type of structural, mechanical and

The drawings do not necessarily indicate or describe all work required for full perfomance and completion of the requirements of

On the basis of the general scope required for the proper execution and completion of the work.

Drawing Title: **DEMOLITION** FLOOR PLAN AND NOTES

1 CITY COMMENTS 9.23.22

2 CITY COMMENTS 9.28.22

Issue Date | Drawn By | Checked By

6/22/22 MJA


Certified By:

10:03:35 -04'00

Drawing Number:

IA100

Project Number: 22199

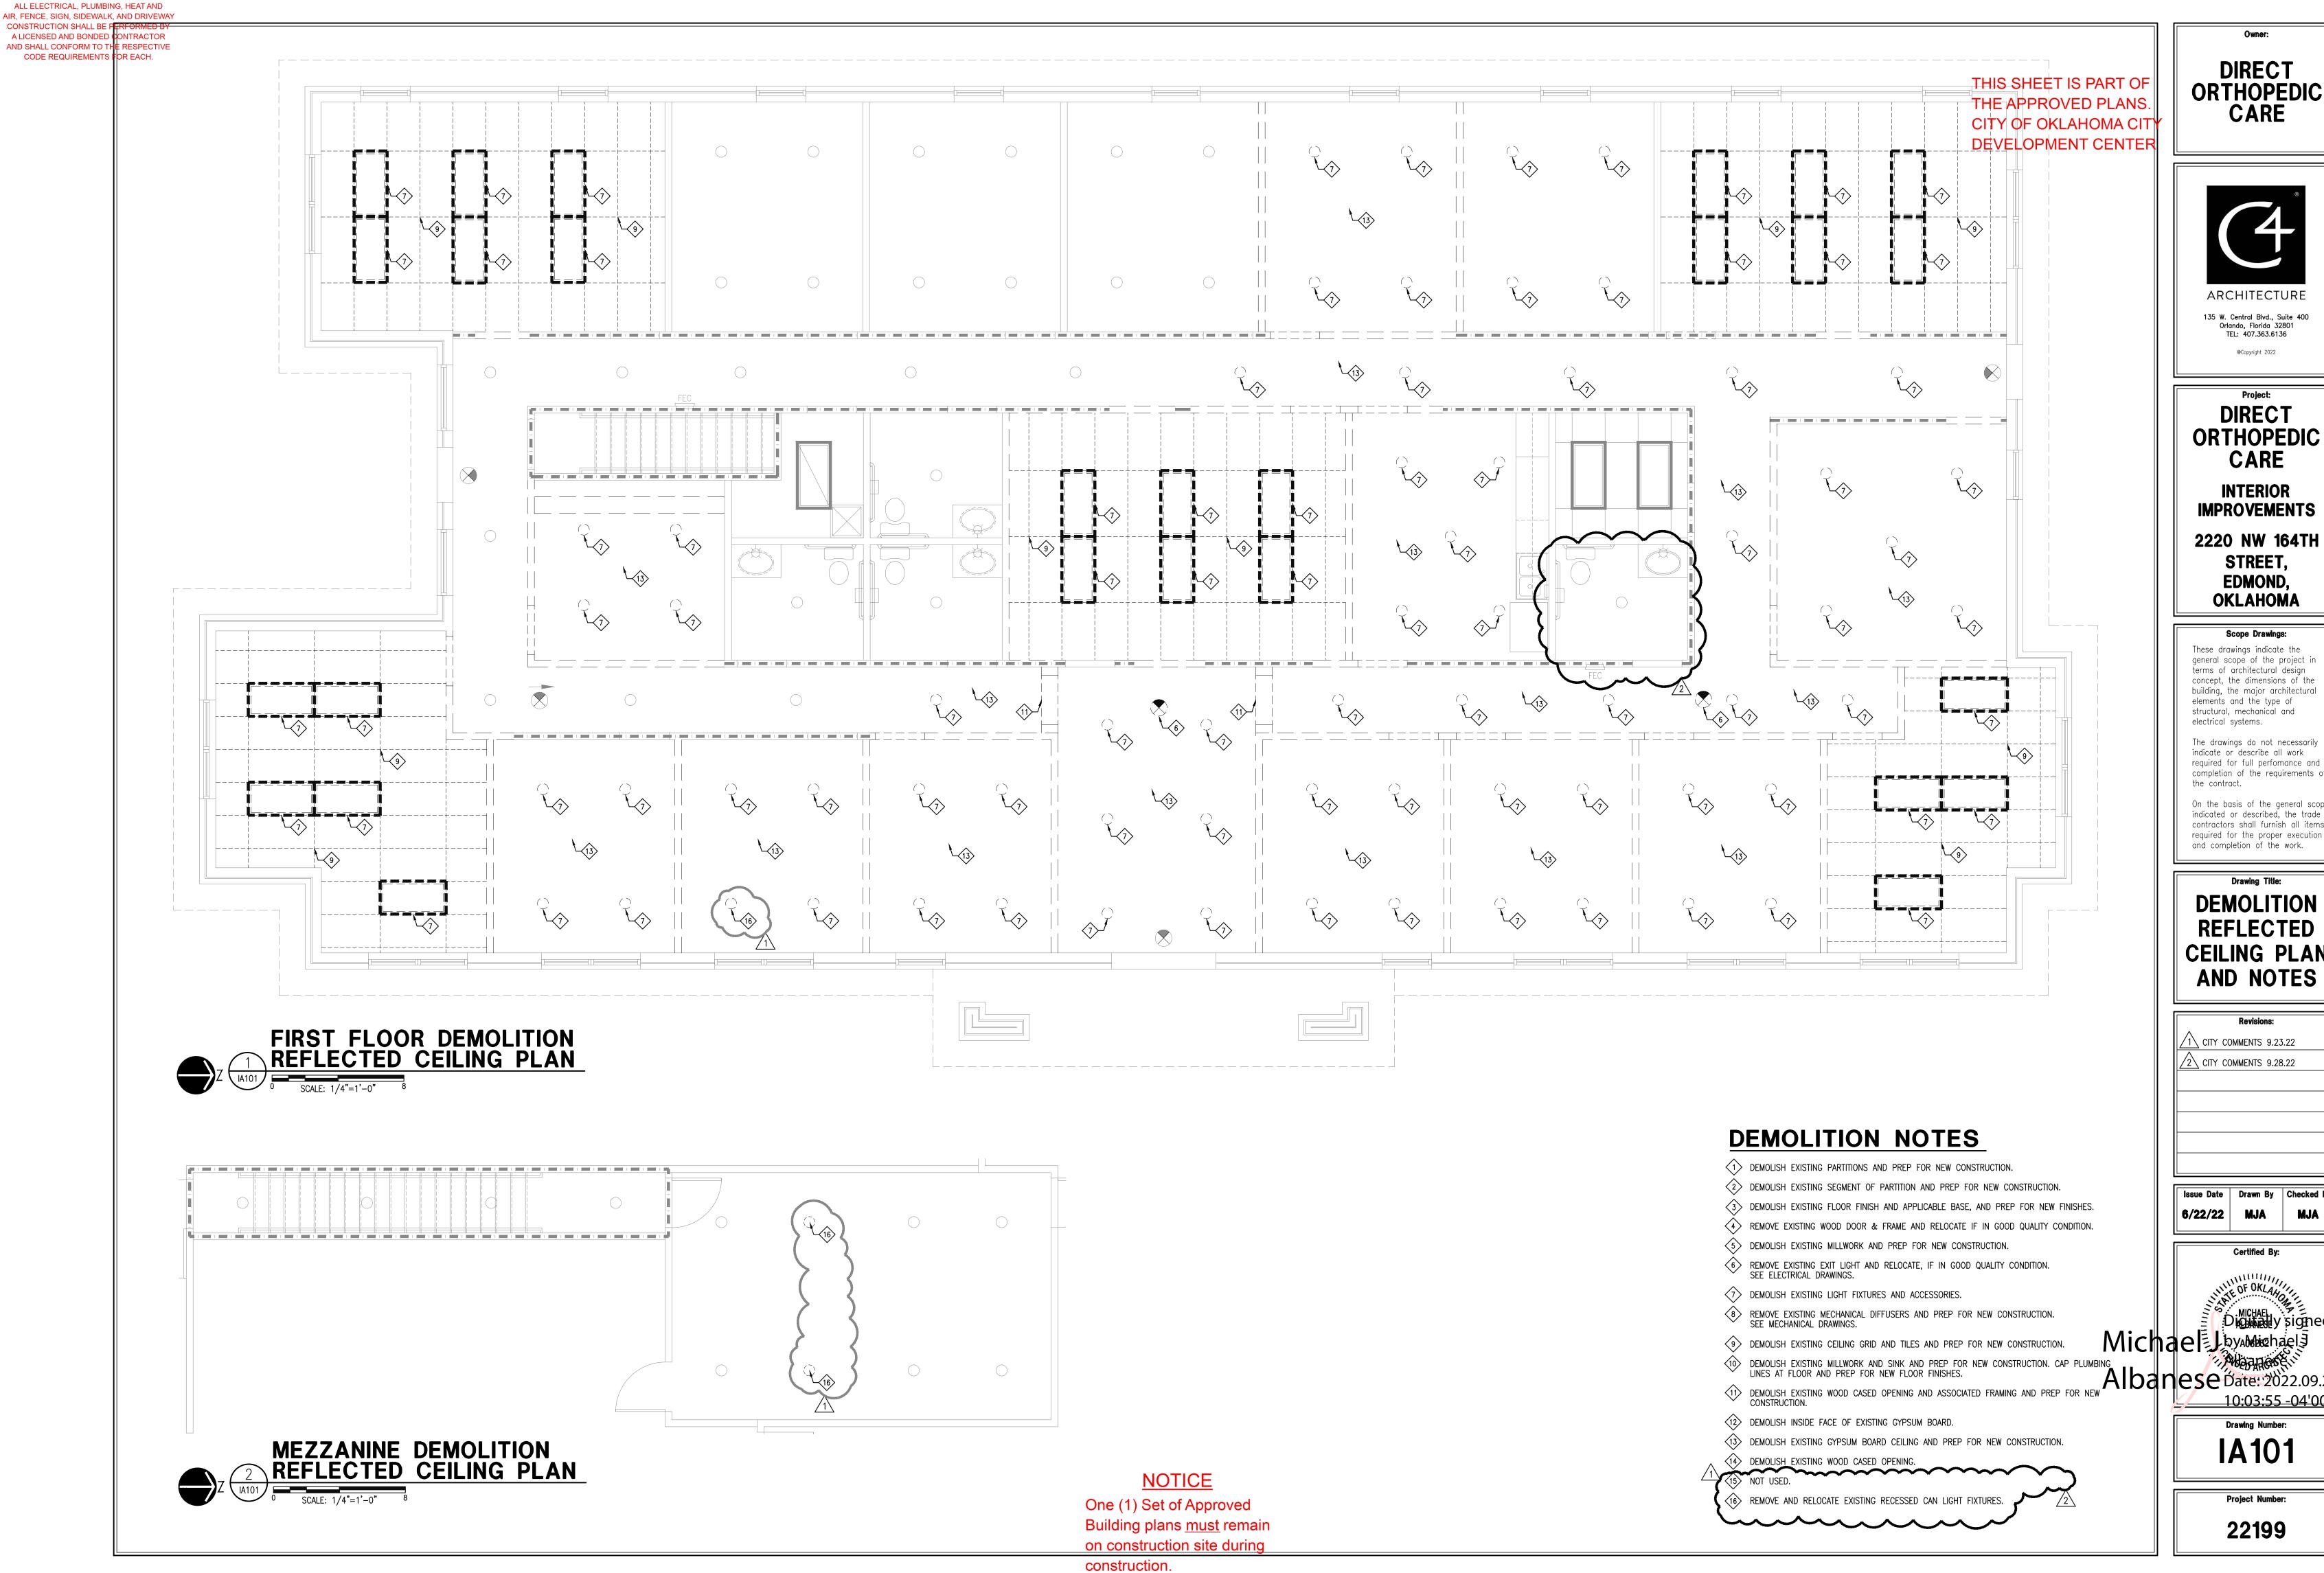

DIRECT ORTHOPEDIC CARE



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DIRECT ORTHOPEDIC CARE

INTERIOR IMPROVEMENTS

2220 NW 164TH STREET, EDMOND, **OKLAHOMA**

These drawings indicate the general scope of the project in terms of architectural design concept, the dimensions of the building, the major architectural elements and the type of

The drawings do not necessarily indicate or describe all work required for full perfomance and completion of the requirements of the contract.

On the basis of the general scope required for the proper execution and completion of the work.

Drawing Title: **DEMOLITION** REFLECTED **CEILING PLAN**

2 CITY COMMENTS 9.28.22

Issue Date | Drawn By | Checked By 6/22/22 MJA


Certified By:


Albanese Date: 2022.09.28 10:03:55 -04'00'

> **Drawing Number:** IA101

> > **Project Number:**

22199

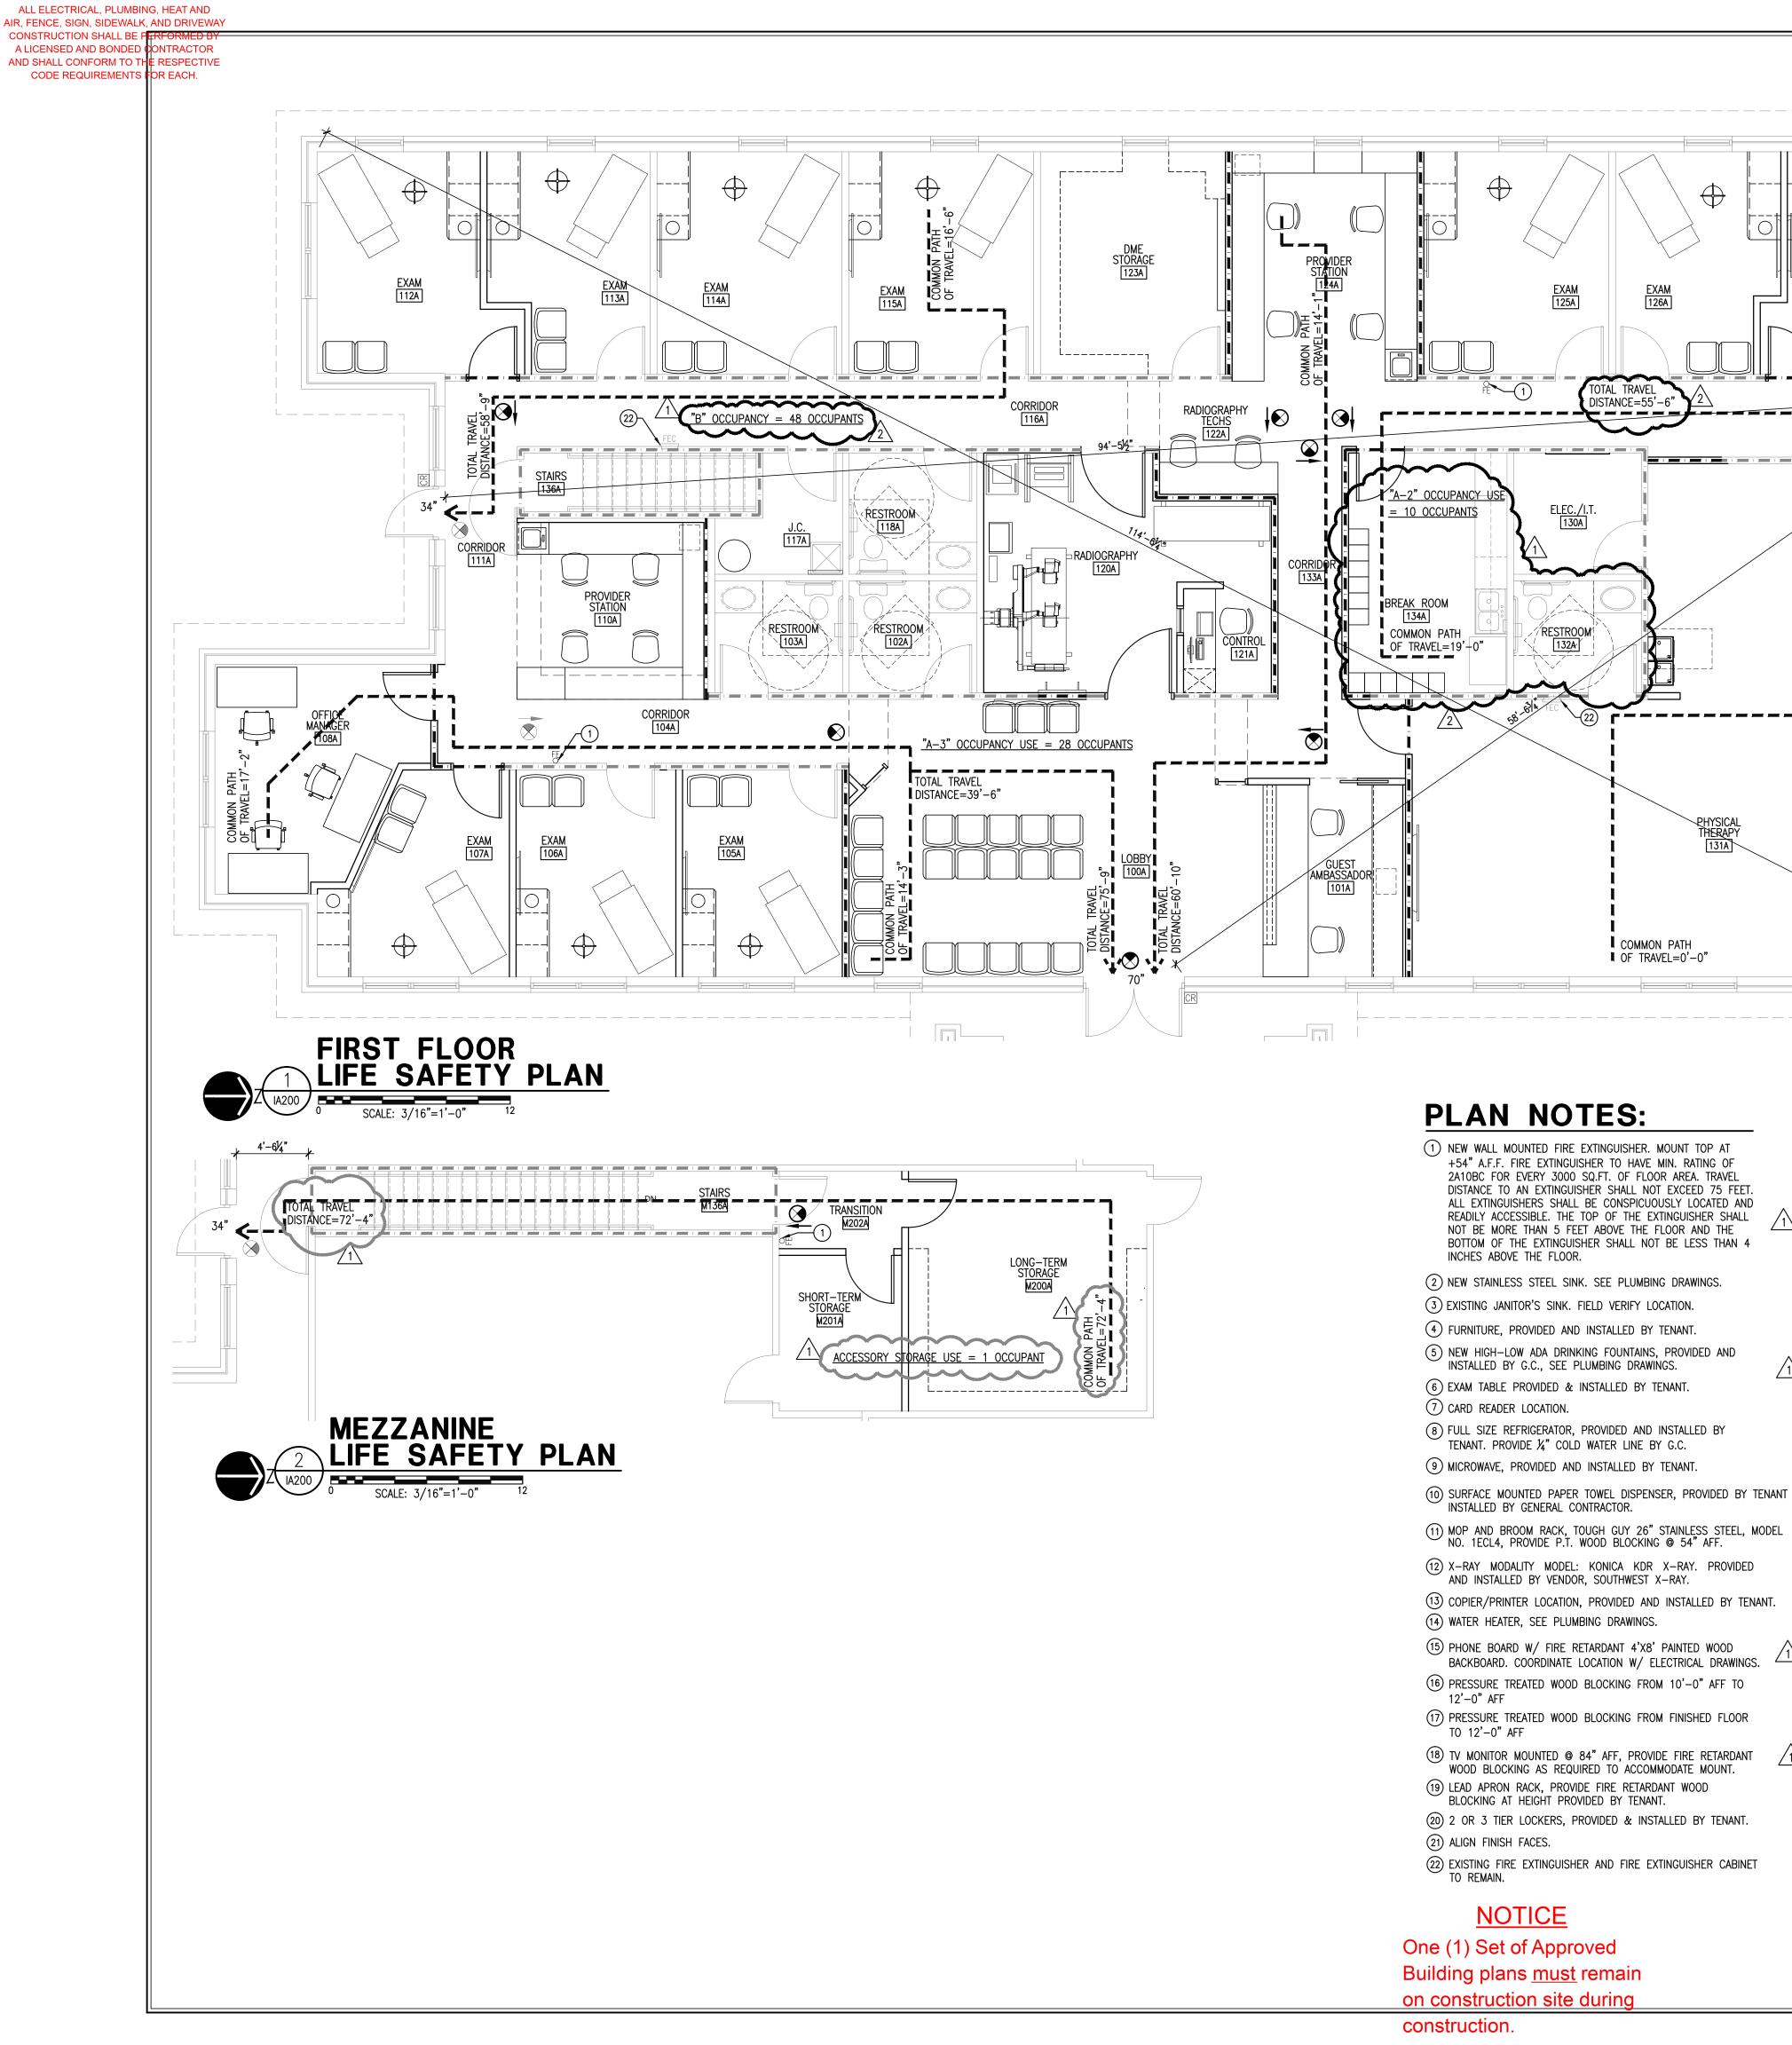

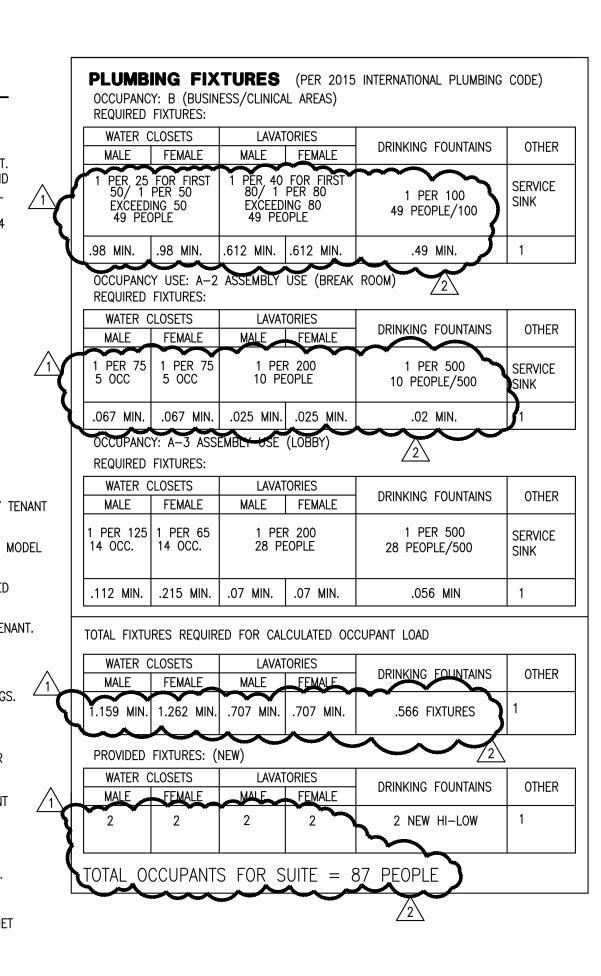

DISTANCE=55'-6

COMMON PATH ■ OF TRAVEL=0'-0"

BUSINESS (GROUP 'B' OCCUPANCY) MAXIMUM ALLOWABLE TRAVEL DISTANCE = 200 FT. (NON-SPRINKLERED) MAXIMUM PROVIDED TRAVEL DISTANCE = 75'-9" MAXIMUM ALLOWABLE DEAD END CORRIDOR LENGTH = 20' (NON-SPRINKLERED) MINIMUM CLEAR OPENING OF EXIT DOORS. FIRST FLOOR EGRESS WIDTH PER PERSON SERVED = .2 IN.

1ST FLOOR TENANT = .2 INCHES x 49 = 9.8 IN. REQUIRED (138 IN. PROVIDED) EXITS PROVIDED 1ST FLOOR TENANT: 3 EXITS PROVIDED MEZZANINE: 1

MINIMUM ALLOWABLE CORRIDOR WIDTH = 44 IN. PER CHAPTER 1020.2 2015 IBC MINIMUM ALLOWABLE STAIR WIDTH = 44 IN. PER CHAPTER 1005.3.1 2015 IBC (PER 2015 INTERNATIONAL FIRE CODE) ANCILLARY USE PER 2015 IBC BREAK ROOM ASSEMBLY USE (GROUP 'A-2' OCCUPANCY USE) MAXIMUM PROVIDED COMMON PATH OF TRAVEL = 19'-0" MINIMUM CLEAR OPENING OF EXIT DOORS.

FIRST FLOOR

SERVED - 2 IN EGRESS WIDTH PER PERSON SERVED = .2 IN. 1ST FLOOR TENANT = .2 INCHES x 10 = 2.0 IN. REQUIRED (138 IN. PROVIDED)

EXITS REQUIRED 1ST FLOOR TENANT: 1 EXITS PROVIDED 1ST FLOOR TENANT: 1 ANCILLARY USE PER 2015 IBC LOBBY ROOM ASSEMBLY/ GROUP 'A-3' OCCUPANCY USE 420 S.F. (BUSINESS USE AT 1 PER 15 S.F.)= 28 OCCUPANTS ASSEMBLY USE (GROUP 'A-3' OCCUPANCY USE) MAXIMUM PROVIDED TRAVEL DISTANCE = 39'-6" MAXIMUM PROVIDED COMMON PATH OF TRAVEL = 14'-3" MINIMUM CLEAR OPENING OF EXIT DOORS. FIRST FLOOR EGRESS WIDTH PER PERSON SERVED = .2 IN. 1ST FLOOR TENANT = .2 INCHES x 28 = 5.6 IN. REQUIRED (138 IN. PROVIDED) EXITS REQUIRED 1ST FLOOR TENANT: 2 EXITS PROVIDED 1ST FLOOR TENANT: 3 TOTAL TRAVEL DISTANCE (COMMON PATH OF TRAVEL)

CODE COMPLIANCE

BUILDING DATA

THIS SHEET IS PART OF

87 OCCUPANT

CONSTRUCTION TYPE: V-B, UNPROTECTED, NON-SPRINKLERED PER 2015-INTERNATIONAL BUILDING CODE CONSTRUCTION TYPE: V(000), UNPROTECTED, CONTINUE SPRINKLERED SERVED SERV NUMBER OF FLOORS = 1 (ORTHOPEDIC GROPEVELOPMENT CENTER)

TOTAL EXISTING GROSS BUILDING AREA = 5,454 S.F. MAXIMUM ALLOWABLE AREA: 9,000 SQ. FT. FOR NON-SPRINKLERED BUILDING

TOTAL EXISTING USABLE AREA - FIRST FLOOR SUITE = 5,321 S.F. TOTAL EXISTING USABLE AREA - MEZZANINE = 345 S.F.

TOTAL CALCULATED OCCUPANT LOAD FOR DIRECT ORTHOPEDIC CARE MAXIMUM BUILDING HEIGHT = 40' N/A TENANT IMPROVEMENTS MAXIMUM NUMBER OF STORIES ALLOWED = 2 BUILDING HEIGHT PROVIDED = 23'-7" TOP OF RIDGE

OCCUPANT LOAD (PER 2015 INTERNATIONAL BUILDING CODE) (PER 2015 INTERNATIONAL FIRE CODE) B, BUSINESS PER 2015 INTERNATIONAL FIRE CODE

PRIMARY FUNCTION IS A BUSINESS. BUSINESS / GROUP 'B' OCCUPANCY 4,752 S.F. (BUSINESS USE AT 1 PER 100 S.F.)= 48 OCCUPANT 345 S.F. (ACCESSORY STORAGE USE-MEZZANINE AT 1 PER 300 S.F.)= 1 OCCUPA TOTAL B OCCUPANCY= 49 OCCUPANTS

MEANS OF EGRESS (PER 2015 INTERNATIONAL BUILDING CODE) (PER 2015 INTERNATIONAL FIRE CODE)

COMMON PATH OF TRAVEL NOT TO EXCEED = 75' (NON-SPRINKLERED) MAXIMUM PROVIDED COMMON PATH OF TRAVEL = 17'-2" (72'-4" AT MEZZANINE)

MEZZANINE (34 IN. PROVIDED) EXITS REQUIRED 1ST FLOOR TENANT: 2 EXITS REQUIRED MEZZANINE:

OCCUPANT LOAD (PER 2015 INTERNATIONAL BUILDING CODE)

MEANS OF EGRESS (PER 2015 INTERNATIONAL BUILDING CODE) (PER 2015 INTERNATIONAL FIRE CODE)

MAXIMUM ALLOWABLE TRAVEL DISTANCE = 200 FT. (NON-SPRINKLERED)

MAXIMUM ALLOWABLE DEAD END CORRIDOR LENGTH = 20' (NON-SPRINKLERED) COMMON PATH OF TRAVEL NOT TO EXCEED = 75' (NON-SPRINKLERED)

MINIMUM ALLOWABLE CORRIDOR WIDTH = 44 IN. PER CHAPTER 1020.2 2015 IBC

MINIMUM ALLOWABLE STAIR WIDTH = 44 IN. PER CHAPTER 1005.3.1 2015 IBC

OCCUPANT LOAD (PER 2015 INTERNATIONAL BUILDING CODE) (PER 2015 INTERNATIONAL FIRE CODE)

MEANS OF EGRESS (PER 2015 INTERNATIONAL BUILDING CODE) (PER 2015 INTERNATIONAL FIRE CODE)

MAXIMUM ALLOWABLE TRAVEL DISTANCE = 200 FT. (NON-SPRINKLERED)

MAXIMUM ALLOWABLE DEAD END CORRIDOR LENGTH = 20' (NON-SPRINKLERED) COMMON PATH OF TRAVEL NOT TO EXCEED = 75' (NON-SPRINKLERED)

MINIMUM ALLOWABLE CORRIDOR WIDTH = 44 IN. PER CHAPTER 1020.2 2015 IBC MINIMUM ALLOWABLE STAIR WIDTH = 44 IN. PER CHAPTER 1005.3.1 2015 IBC

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INTERIOR IMPROVEMENTS

2220 NW 164TH STREET, EDMOND, **OKLAHOMA**

Scope Drawings: These drawings indicate the general scope of the project in terms of architectural design

concept, the dimensions of the building, the major architectural elements and the type of structural, mechanical and electrical systems. The drawings do not necessarily indicate or describe all work

required for full perfomance and completion of the requirements of the contract.

On the basis of the general scope contractors shall furnish all items required for the proper execution and completion of the work.

Drawing Title: LIFE SAFETY PLAN & CODE COMPLIANCE,

	Revisio	ns:
ITY	COMMENTS	9.23.22
111	COMMENTS	9.23.22

FIXTURE CNTS.

/2\ CITY COMMENTS 9.28.22

Issue Date | Drawn By | Checked By 6/22/22 MJA

Certified By: TE OF OKLAN Michael Joy Michael

Albanese Date: 2022.09.28


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Drawing Number: IA200

Project Number:

22199


ALL ELECTRICAL, PLUMBING, HEAT AND
AIR, FENCE, SIGN, SIDEWALK, AND DRIVEWAY
CONSTRUCTION SHALL BE FERFORMED BY
A LICENSED AND BONDED CONTRACTOR
AND SHALL CONFORM TO THE RESPECTIVE
CODE REQUIREMENTS FOR EACH.

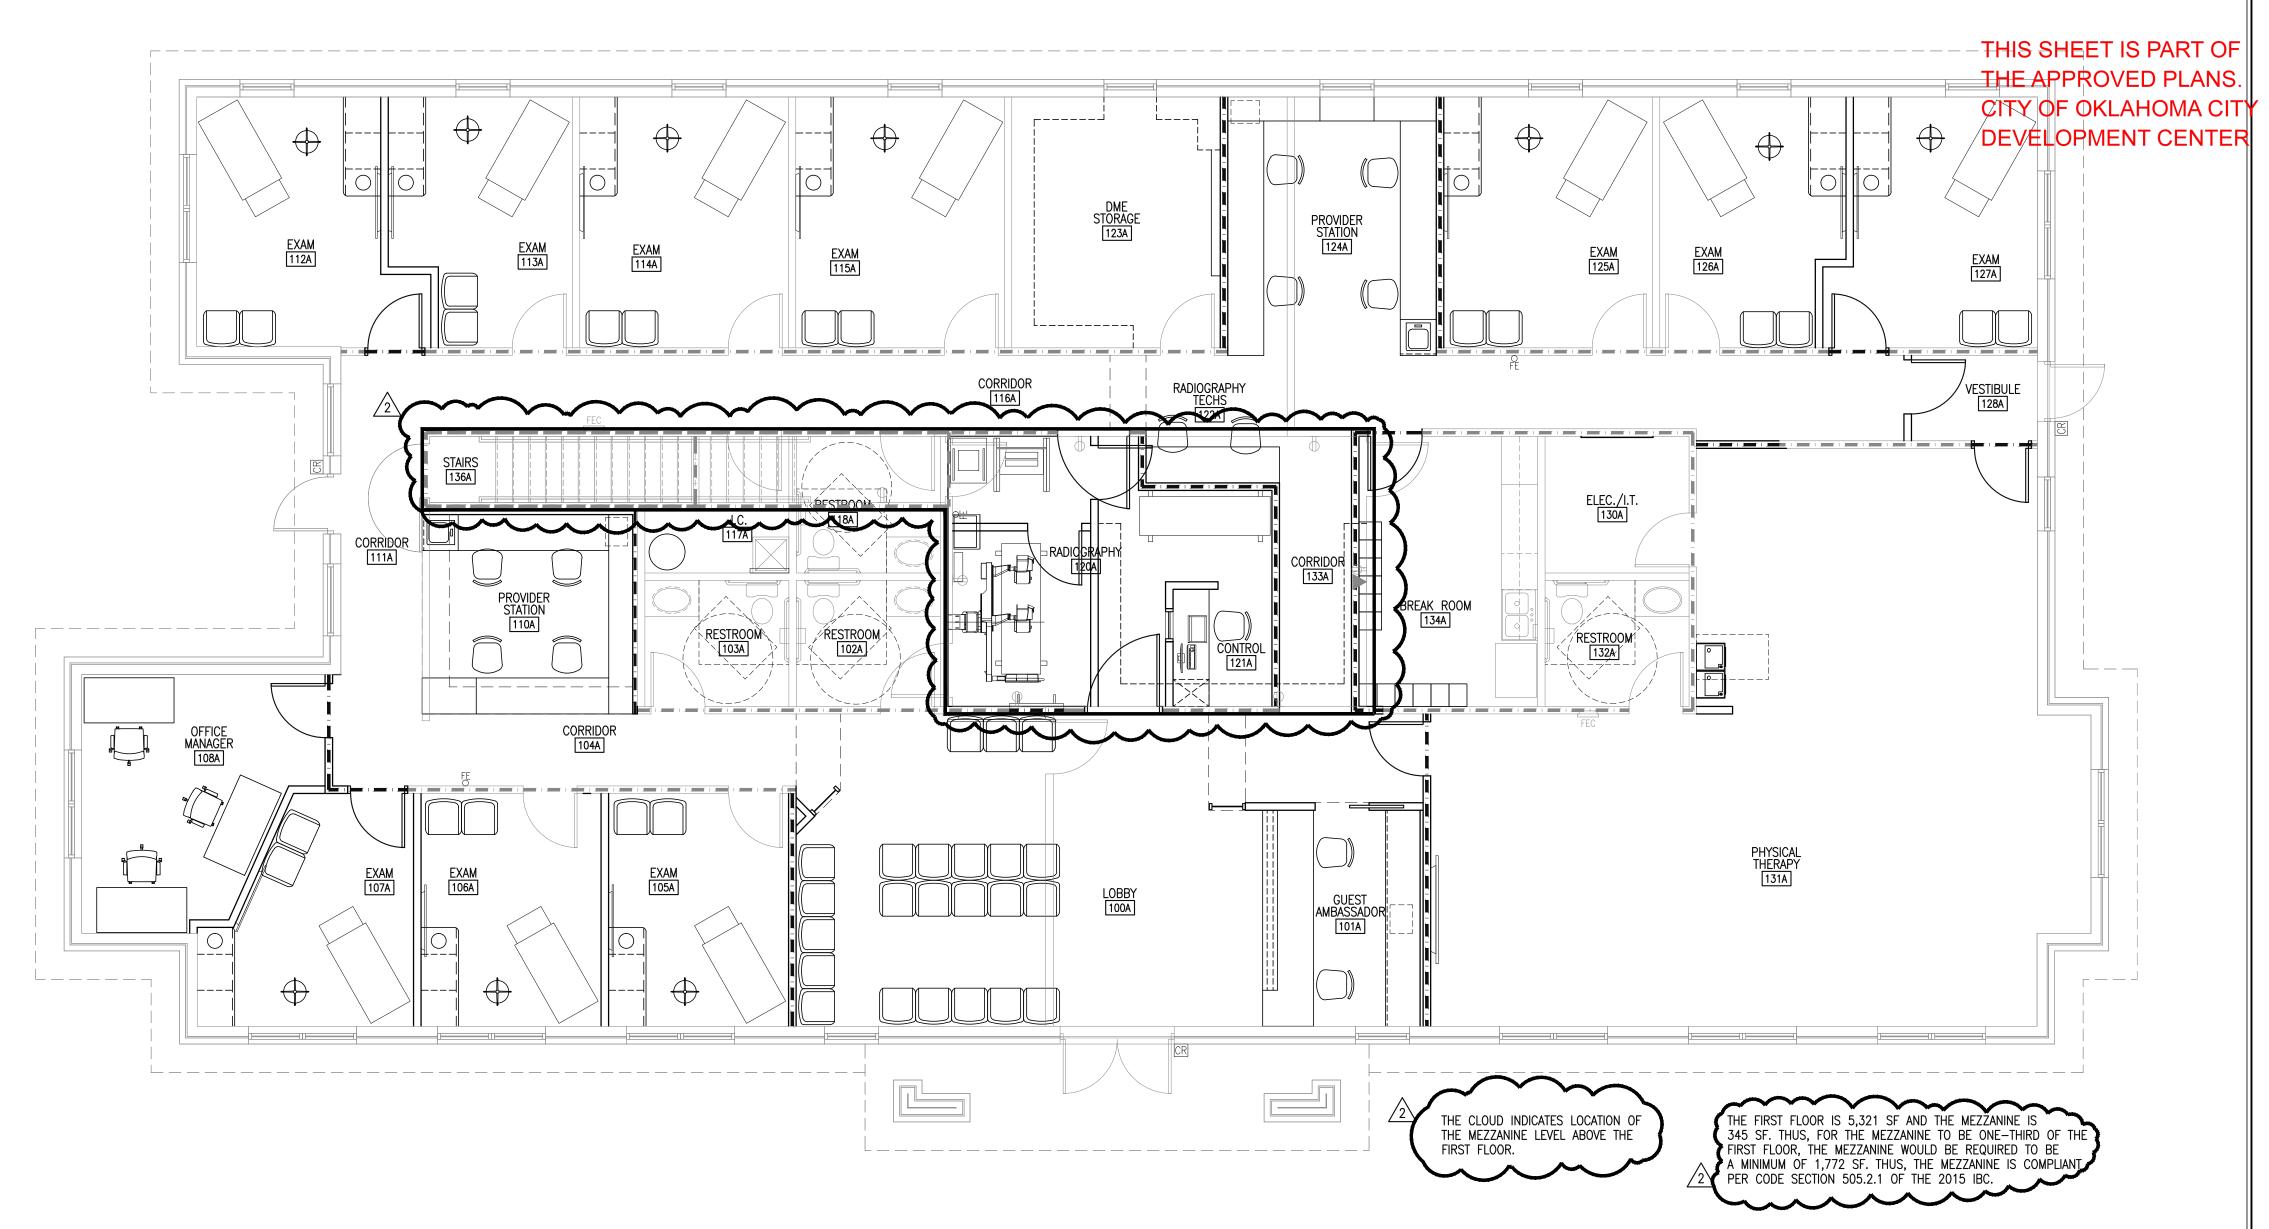

FIRST FLOOR AND MEZZANINE MERGED FLOOR PLANS

SCALE: 3/16"=1'-0" 12

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INTERIOR
IMPROVEMENTS

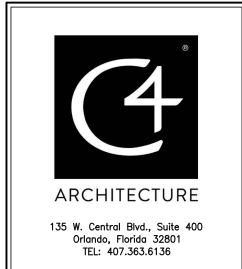2220 NW 164TH
STREET,
EDMOND,
OKLAHOMA

Scope Drawings:

These drawings indicate the general scope of the project in terms of architectural design concept, the dimensions of the building, the major architectural elements and the type of structural, mechanical and electrical systems.

The drawings do not necessarily indicate or describe all work required for full perfomance and completion of the requirements of the contract.

On the basis of the general scope indicated or described, the trade contractors shall furnish all items required for the proper execution and completion of the work.

FIRST FLOOR
AND MEZZANINE
MERGED
FLOOR PLANS

	Revisions:
2 CITY	COMMENTS 9.28.22

Issue Date Drawn By Checked
6/22/22 MJA MJA


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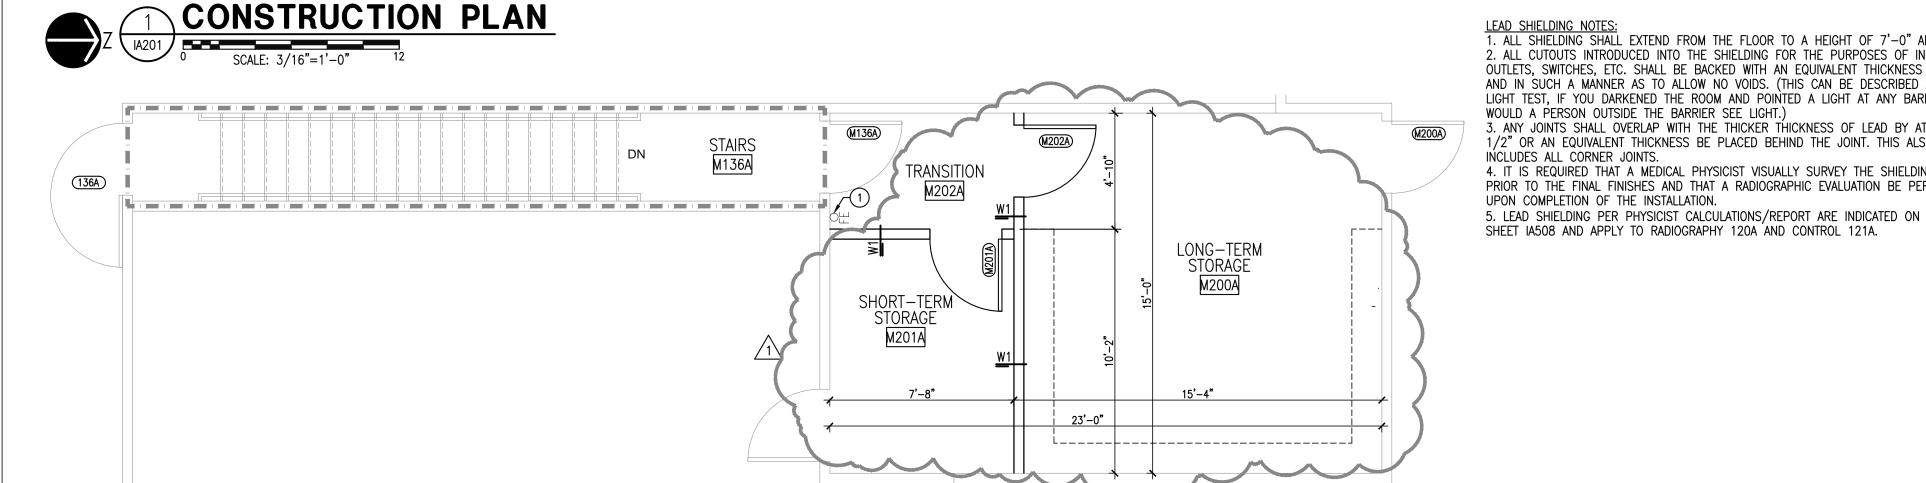


Project Number:

NOTICE

One (1) Set of Approved
Building plans <u>must</u> remain
on construction site during
construction.



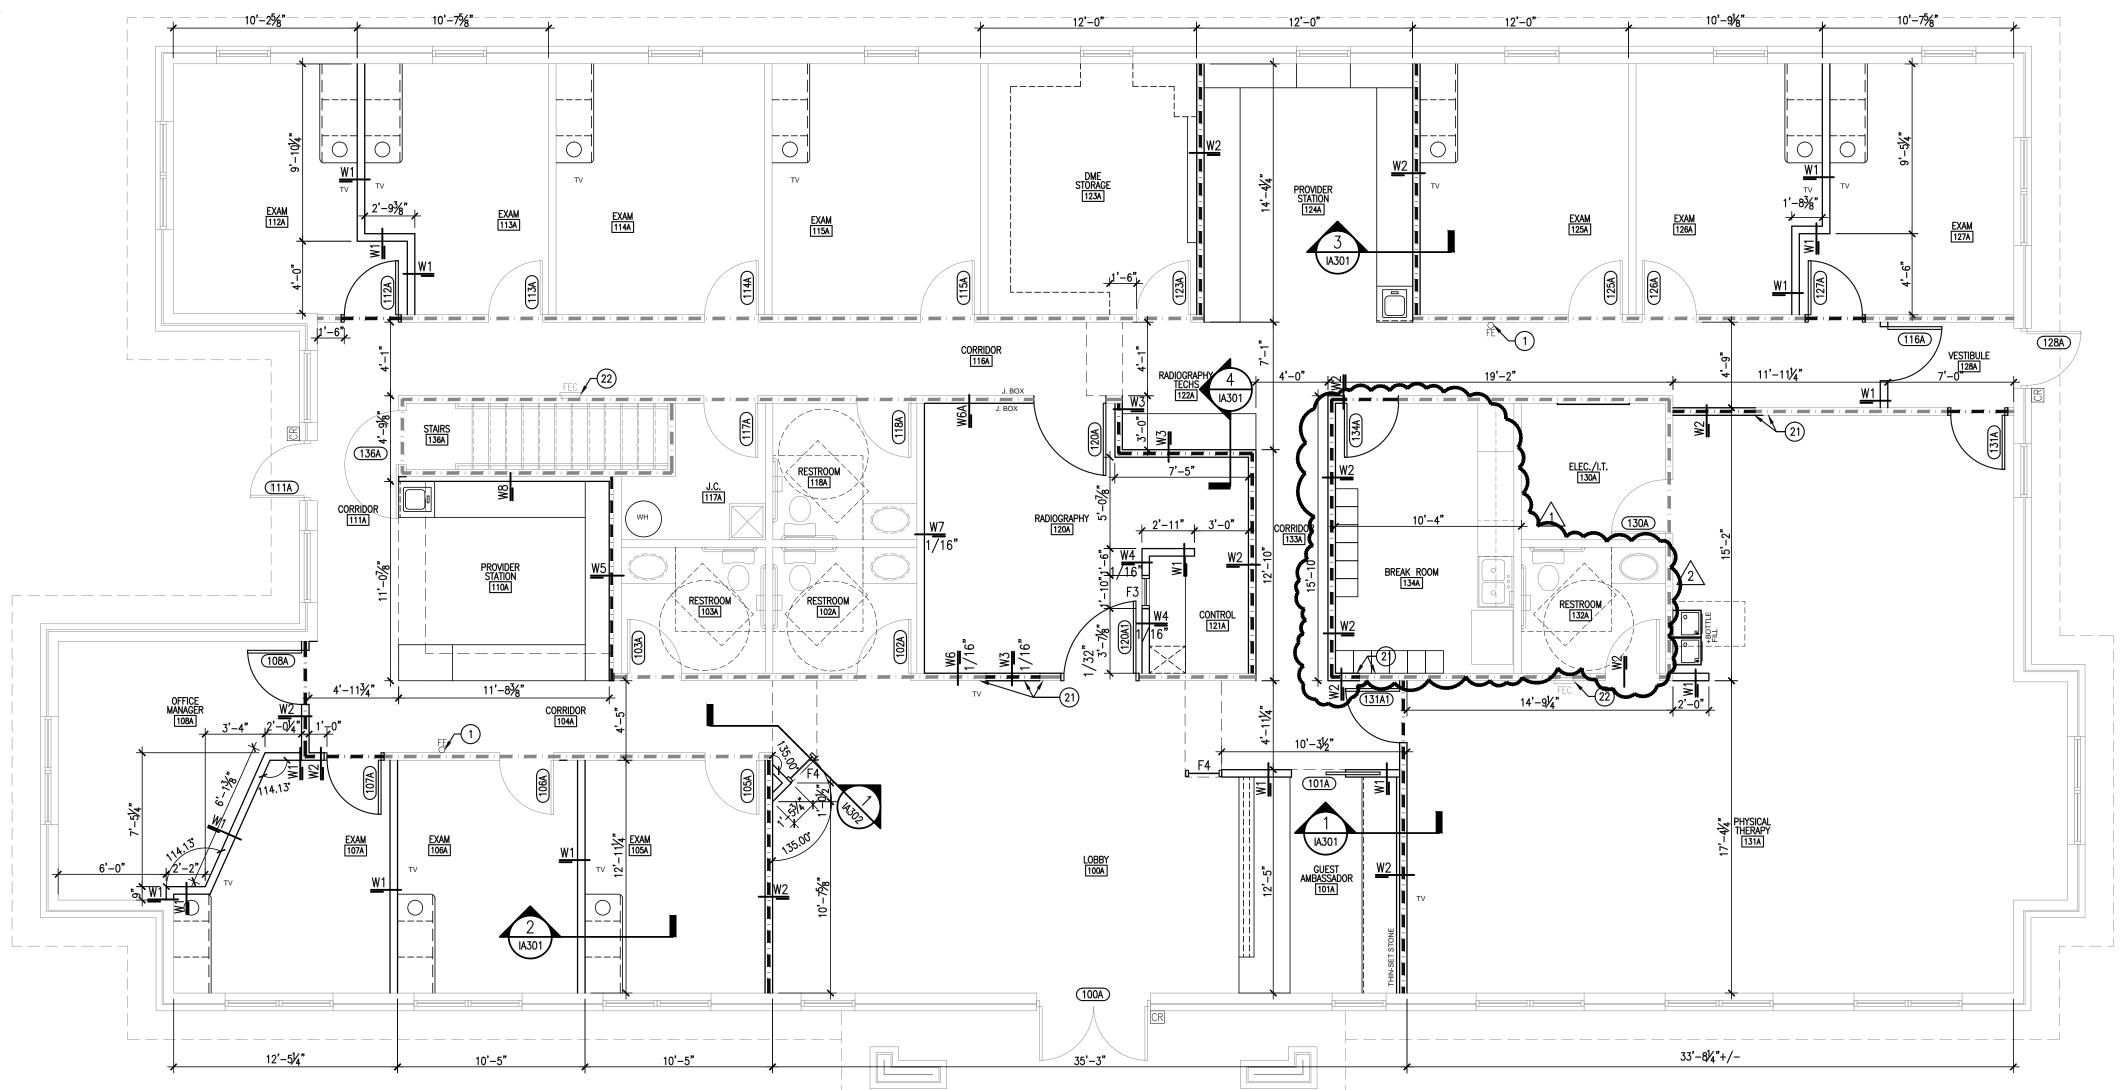

NOTE: PROVIDE MIN. 3000 PSI CONCRETE

A SLUMP OF 4" PLUS OR MINUS 1" AND

MIX DESIGN SHALL BE IN ACCORDANCE W/

THE LATEST ED. OF ACI 301 CHAPTER 3

HAVE 2 TO 4% AIR ENTRAINMENT. CONCRETE

SLAB ON GRADE. NEW CONCRETE SHALL HAVE

LEAD SHIELDING NOTES: 1. ALL SHIELDING SHALL EXTEND FROM THE FLOOR TO A HEIGHT OF 7'-0" AFF. 2. ALL CUTOUTS INTRODUCED INTO THE SHIELDING FOR THE PURPOSES OF INSTALLING OUTLETS, SWITCHES, ETC. SHALL BE BACKED WITH AN EQUIVALENT THICKNESS OF LEAD AND IN SUCH A MANNER AS TO ALLOW NO VOIDS. (THIS CAN BE DESCRIBED AS THE LIGHT TEST, IF YOU DARKENED THE ROOM AND POINTED A LIGHT AT ANY BARRIER, WOULD A PERSON OUTSIDE THE BARRIER SEE LIGHT.) 3. ANY JOINTS SHALL OVERLAP WITH THE THICKER THICKNESS OF LEAD BY AT LEAST 1/2" OR AN EQUIVALENT THICKNESS BE PLACED BEHIND THE JOINT. THIS ALSO INCLUDES ALL CORNER JOINTS. 4. IT IS REQUIRED THAT A MEDICAL PHYSICIST VISUALLY SURVEY THE SHIELDING PRIOR TO THE FINAL FINISHES AND THAT A RADIOGRAPHIC EVALUATION BE PERFORMED UPON COMPLETION OF THE INSTALLATION.

PLAN NOTES:

(1) NEW WALL MOUNTED FIRE EXTINGUISHER. MOUNT TOP AT +54" A.F.F. FIRE EXTINGUISHER TO HAVE MIN. RATING OF 2A10BC FOR EVERY 3000 SQ.FT. OF FLOOR AREA. TRAVEL DISTANCE TO AN EXTINGUISHER SHALL NOT EXCEED 75 FEET. ALL EXTINGUISHERS SHALL BE CONSPICUOUSLY LOCATED AND READILY ACCESSIBLE. THE TOP OF THE EXTINGUISHER SHALL NOT BE MORE THAN 5 FEET ABOVE THE FLOOR AND THE BOTTOM OF THE EXTINGUISHER SHALL NOT BE LESS THAN 4 INCHES ABOVE THE FLOOR.

(2) NEW STAINLESS STEEL SINK. SEE PLUMBING DRAWINGS. (3) EXISTING JANITOR'S SINK. FIELD VERIFY LOCATION.

(4) FURNITURE, PROVIDED AND INSTALLED BY TENANT.

(5) NEW HIGH-LOW ADA DRINKING FOUNTAINS, PROVIDED AND INSTALLED BY G.C., SEE PLUMBING DRAWINGS.

(6) EXAM TABLE PROVIDED & INSTALLED BY TENANT.

(7) CARD READER LOCATION.

(8) FULL SIZE REFRIGERATOR, PROVIDED AND INSTALLED BY TENANT. PROVIDE ¼" COLD WATER LINE BY G.C.

(9) MICROWAVE, PROVIDED AND INSTALLED BY TENANT.

(10) SURFACE MOUNTED PAPER TOWEL DISPENSER, PROVIDED BY TENANT INSTALLED BY GENERAL CONTRACTOR.

MOP AND BROOM RACK, TOUGH GUY 26" STAINLESS STEEL, MODEL NO. 1ECL4, PROVIDE P.T. WOOD BLOCKING @ 54" AFF.

(12) X-RAY MODALITY MODEL: KONICA KDR X-RAY. PROVIDED AND INSTALLED BY VENDOR, SOUTHWEST X-RAY.

(13) COPIER/PRINTER LOCATION, PROVIDED AND INSTALLED BY TENANT. (14) WATER HEATER, SEE PLUMBING DRAWINGS.

(15) PHONE BOARD W/ FIRE RETARDANT 4'X8' PAINTED WOOD BACKBOARD. COORDINATE LOCATION W/ ELECTRICAL DRAWINGS. (16) PRESSURE TREATED WOOD BLOCKING FROM 10'-0" AFF TO 12'-0" AFF

(17) PRESSURE TREATED WOOD BLOCKING FROM FINISHED FLOOR TO 12'-0" AFF

(18) TV MONITOR MOUNTED @ 84" AFF, PROVIDE FIRE RETARDANT

WOOD BLOCKING AS REQUIRED TO ACCOMMODATE MOUNT. (19) LEAD APRON RACK, PROVIDE FIRE RETARDANT WOOD BLOCKING AT HEIGHT PROVIDED BY TENANT.

(20) 2 OR 3 TIER LOCKERS, PROVIDED & INSTALLED BY TENANT. (21) ALIGN FINISH FACES.

(22) EXISTING FIRE EXTINGUISHER AND FIRE EXTINGUISHER CABINET

TO REMAIN.

GENERAL NOTES:

- ALL DIMENSIONS ARE FROM FACE OF PARTITION SO PACEFOR PARTITION RT OF UNLESS NOTED OR SHOWN OTHERWISE ANY DIMENSIONS NOT SHOWN DEEMED QUESTIONABLE ARE TO BE VERIFIED BY ARCHITECTOR DESIGNER ANS DO NOT SCALE DRAWINGS
 - B. PROVIDE WOOD BLOCKING SUPPORTS & REQUIRD FOR ALL OF A C
 - C. COORDINATE WORK OF THIS TRADE WITH OTHER TRADES.
 - NEW DOOR AND FRAME NUMBERS CORRESPOND TO ROOM NUMBERS. WHERE MORE THAN ONE DOOR OCCURS IN A ROOM, A SUFFIX HAS BEEN
- ADDED (I.E. 100A1). SEE SHEET IA501 FOR DOOR SCHEDULE. PROVIDE MISCELLANEOUS METAL SUPPORT FOR ALL CEILING

UNLESS OTHERWISE SPECIFIED

NEW FLOOR FINISHES AS SHOWN.

- SUSPENDED ITEMS. APPLY SEALANT AT ALL JUNCTURES BETWEEN DIFFERENT MATERIALS (I.E.
- G. ALL STEEL STUDS ARE TO BE BRACED ACCORDING TO MANUFACTURER'S
- H. SAVE ALL REMOVED ITEMS FOR OWNER, PER OWNER'S DIRECTION,
- I. APPLY SEALANT AT ALL PLUMBING FIXTURES AT JUNCTURE WITH WALL.
- ALL DOORS MUST BE INSTALLED WITH AT LEAST THE MINIMUM MANEUVERING CLEARANCE AT THE DOOR APPROACH PER THE MOST
- CURRENT AMERICANS WITH DISABILITIES ACT. K. ALL WALLS SCHEDULED TO REMAIN (I.E. CORE WALLS, AND DEMISING WALLS) SHALL BE PATCHED, REPAIRED AND SANDED SMOOTH IN
- PREPARATION FOR NEW FINISHES. FLOOR SHALL BE CLEANED, SMOOTH AND LEVEL FOR INSTALLATION OF
- M. ALL NEW FIRE EXTINGUISHER CABINETS TO BE FACTORY PAINTED BAKED ENAMEL WHITE FINISH & EQUAL TO LARSEN GEMINI SERIES. LIFE SAFETY CONTRACTOR TO VERIFY NEED FOR ANY ADDITIONAL FIRE EXTINGUISHER CABINET LOCATIONS. IF ADDITIONAL FIRE EXTINGUISHER CABINETS AR REQUIRED, LOCATIONS MUST BE SUBMITTED TO ARCHITECT OR DESIGNER
- FOR REVIEW. N. ALL FURNITURE PROVIDED & INSTALLED BY TENANT.
- O. ALL STEEL STUD RUNNER CHANNELS ATTACHED TO CONCRETE FLOOR SHALL BE FASTENED WITH CONCRETE STUB NAILS, EXPANSION ANCHORS, SHIELDED SCREWS, OR POWER-DRIVEN FASTENERS NOT EXCEEDING 24" O.C.
- ALL STEEL STUD RUNNER CHANNELS ATTACHED TO SUSPENDED CEILINGS SHALL BE FASTENED WITH "MOLLY"—TYPE EXPANDABLE FASTENERS, TOGGLE BOLTS, CLAMPS, OR SCREWS INTO CHANNELS, SPLINES, "T" RUNNERS, OR OTHER MEMBERS.
- APPLY SEALANT AT ALL COUNTERTOPS AND BACK SPLASHES AT JUNCTURE
- R. ALL INTERIOR WALLS SHALL BE MARKED IN PLACE PRIOR TO FRAMING FOR ARCHITECT/DESIGNER TO REVIEW, IF REQUIRED
- SECURITY ACCESS CONTROLS TO BE PROVIDED BY OTHERS.
- ALL BLOCKING TO BE FIRE TREATED EXCEPT THOSE USED FOR MILLWORK, HANDRAILS, CABINETS, WINDOW AND DOOR FRAMES PER IBC 603.1
- U. ALL BLOCKING TO BE FIRE TREATED WHEN USED FOR INSTALLATION OF TOILET ACCESSORIES OR USE 20 GA. STEEL PLATE WELDED TO STUDS.
- BUILDING STANDARD MINI-BLINDS, MECHO-SHADES OR TRANSLUCENT FILM TBD AT EACH EXTERIOR WINDOW.

WALL TYPES

EXISTING CONSTRUCTION TO REMAIN ===== NEW PARTITION

= = Existing partition to be demolished

■ I ■ I ■ NEW 1—HOUR FIRE PARTITION SEE REFLECTED CEILING PLANS FOR CONSTRUCTED WALL HEIGHT.

PROVIDE MOISTURE RESISTANT GYPSUM WALLBOARD ON ALL WET AREA WALLS. PROVIDE 5/8" DUROCK ON ALL PORCELAIN TILED WALLS & AT PREFAB SHOWER WALLS, IF APPLICABLE.

4. CONSTRUCT ALL STUD WALL FRAMING TO MEET MANUFACTURER'S MINIMUM REQUIREMENTS FOR FLOOR AND CEILING ATTACHMENT BASED ON 5 PSF LATERAL LOADING AND L/120 DEFLECTION.

UNLESS OTHERWISE APPROVED, IN NO CASE SHALL THE ATTACHMENT BE LESS THAN THE FOLLOWING:

• ALL STEEL STUD RUNNER CHANNELS ATTACHED TO CONCRETE FLOOR SHALL BE FASTENED WITH CONCRETE STUB NAILS, EXPANSION ANCHORS, SHIELDED SCREWS, OR POWER-DRIVEN FASTENERS NOT EXCEEDING 24" O.C. AND NO MORE THAN 2" FROM

• FASTEN STUD FLANGE TO RUNNER TRACK WITH 3/8" TYPE S PAN HEADSCREWS. • ALL STEEL STUD RUNNER CHANNELS ATTACHED TO SUSPENDED CEILINGS SHALL BE FASTENED WITH "MOLLY"-TYPE EXPANDABLE FASTENERS, TOGGLE BOLTS, CLAMPS, OR SCREWS INTO CHANNELS, SPLINES, "T" RUNNERS, OR OTHER MEMBERS.

 $\underline{\underline{\mathbb{W}}}$ 3-5/8" 20 GAUGE METAL STUDS @16"0.C. WITH (1) LAYER 5/8" GYPSUM WALL BOARD EACH SIDE AND (1) LAYER SOUND ATTENUATION BLANKETS IN EACH STUD CAVITY.

<u>W2</u> 3-5/8" 20 GAUGE METAL STUDS @16"O.C. W/ (1) LAYER 5/2" TYPE "X" GYPSUM BOARD EACH SIDE AND (1) LAYER SOUND ATTENUATION BLANKETS IN EACH STUD CAVITY PER UL U465 1 HR FIRE PARTITION.

1 HR FIRE PARTITION PER-UL U465

<u>₩3</u> 3-5/8" 20 GAUGE METAL STUDS @16"O.C. W/ (1) ₩ παλλάλλαλλαλ LAYER 5/8" TYPE "X" GYPSUM BOARD ONE SIDE AND (1) LAYER SOUND ATTENUATION BLANKETS IN DIMENSION VARIES WHEN EACH STUD CAVITY. ADD (1) LAYER 5/8" TYPE "X" LEAD SHIELDING ADDED. LEAD LINED GYPSUM BOARD. NOTE: SEE IA201 FOR 1 HR FIRE LEAD SHIELDING THICKNESS PER PHYSICIST REPORT. PARTITION-UL U465

₩4 3-5/8" 20 GAUGE METAL STUDS @16" O.C. WITH (1) LAYER 5/8" GYPSUM WALL BOARD ONE SIDE AND ONE LAYER 5/8" LEAD-LINED GYPSUM BOARD WITH ONE LAYER SOUND ATTENUATION BATTS IN EACH STUD CAVITY.

DIMENSION VARIES WHEN LEAD SHIELDING ADDED.

<u>W5</u> 2-1/2" 20 GAUGE C-H METAL STUDS @24" O.C. W/ (1) LAYER 1" SHAFT WALL LINER PANEL AND 5/8" TYPE "X" GYPSUM BOARD.

1 HR FIRE PARTITION PER-UL U415

W6 3-5/8" 20 GAUGE METAL STUDS ADJACENT TO EXISTING STUDS AND (1) LAYER 5/8" TYPE "X" LEAD LINED GYPSUM BOARD. NOTE: SEE IA201 FOR LEAD SHIELDING

DIMENSION VARIES WHEN VIII LEAD SHIELDING ADDED. THICKNESS PER PHYSICIST REPORT. 1 HR FIRE W6A NO LEAD-LINED GYPSUM BOARD PARTITION-UL U465

W7___ 3-5/8" 20 GAUGE METAL STUDS ADJACENT TO EXISTING STUDS AND (1) LAYER 5/8" GYPSUM LEAD-LINED BOARD.

DIMENSION VARIES WHEN LEAD SHIELDING ADDED.

<u>W8</u> 2−1/2" 20 GAUGE METAL STUDS @16" O.C. W/ ♣ ★ (1) LAYER 5/8" GYPSUM BOARD ONE SIDE.

NEW DOOR AND FRAME. REFER TO DOOR SCHEDULE F(X) = FRAME TYPE SEE SHEET IA501 FOR FRAME ELEVATIONS.

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Project:

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INTERIOR IMPROVEMENTS

2220 NW 164TH **STREET** EDMOND, **OKLAHOMA**

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indicated or described, the trade ontractors shall furnish all items required for the proper execution and completion of the work.

Drawing Title: CONSTRUCTION PLAN, WALL TYPES, DETAILS AND NOTES

<u> </u>	CITY	COMMENTS	9.23.22	
2	CITY	COMMENTS	9.28.22	

Revisions:

Issue Date | Drawn By | Checked By 6/22/22 MJA MJA



10:05:07 -04'00'

Drawing Number: IA201

Project Number:

22199

TRENCH INFILL DETAIL

16" LONG #4 REBAR

EXIST SLAB

@ 24" OC STAGG EPOXIED INTO

DOWELS TO BE SAW CUT TO

PREVENT END DEFORMATION

MEZZANINE CONSTRUCTION PLAN

NEW SLAB ---

AS EXISTING

6X6 1.4/W1.4 WWM —

(E) CONC SLAB -

6 MIL. VAPOR BARRIER

TREATMENT UNDER VAPOR

SLAB AS REQUIRED PER

2015 INT. BLDG. CODE

NOTE: PROVIDE TERMITE SOIL

BARRIER AND INFILL CONCRETE

SAME THICKNESS

6" MIN

FIRST FLOOR

on construction site during construction.

NOTICE

Building plans must remain

One (1) Set of Approved

ALL ELECTRICAL, PLUMBING, HEAT AND AIR, FENCE, SIGN, SIDEWALK, AND DRIVEWAY A LICENSED AND BONDE AND SHALL CONFORM TO THE RESPECTIVE CODE REQUIREMENTS FOR EACH. L-----GUEST AMBASSADOR 101A 7 IA502 10 IA502 IA502

LONG-TERM STORAGE M200A

FIRST FLOOR EQUIPMENT & MILLWORK PLAN

SCALE: 1/4"=1'-0" 8

MEZZANINE EQUIPMENT & MILLWORK PLAN

SCALE: 1/4"=1'-0" 8

16) PRESSURE TREATED WOOD BLOCKING FROM 10'-0" AFF TO 12'-0" AFF

(17) PRESSURE TREATED WOOD BLOCKING FROM FINISHED FLOOR

- TO 12'-0" AFF (18) TV MONITOR MOUNTED @ 84" AFF, PROVIDE FIRE RETARDANT WOOD BLOCKING AS REQUIRED TO ACCOMMODATE MOUNT.
- (19) LEAD APRON RACK, PROVIDE FIRE RETARDANT WOOD BLOCKING AT HEIGHT PROVIDED BY TENANT. (20) 2 OR 3 TIER LOCKERS, PROVIDED & INSTALLED BY TENANT.
- (21) ALIGN FINISH FACES.
- 22) EXISTING FIRE EXTINGUISHER AND FIRE EXTINGUISHER CABINET TO REMAIN.

PLAN NOTES:

- 1) NEW WALL MOUNTED FIRE EXTINGUISHER. MOUNT TOP AT +54" A.F.F. FIRE EXTINGUISHER TO HAVE MIN. RATING OF 2A10BC FOR EVERY 3000 SQ.FT. OF FLOOR AREA. TRAVEL DISTANCE TO AN EXTINGUISHER SHALL NOT EXCEED 75 FEET ALL EXTINGUISHERS SHALL BE CONSPICUOUSLY LOCATED AND READILY ACCESSIBLE. THE TOP OF THE EXTINGUISHER SHALL NOT BE MORE THAN 5 FEET ABOVE THE FLOOR AND THE BOTTOM OF THE EXTINGUISHER SHALL NOT BE LESS THAN 4 INCHES ABOVE THE FLOOR.
- 2 NEW STAINLESS STEEL SINK. SEE PLUMBING DRAWINGS. 3 EXISTING JANITOR'S SINK. FIELD VERIFY LOCATION.
- 4 FURNITURE, PROVIDED AND INSTALLED BY TENANT.
- 5 NEW HIGH-LOW ADA DRINKING FOUNTAINS, PROVIDED AND INSTALLED BY G.C., SEE PLUMBING DRAWINGS.
- (6) EXAM TABLE PROVIDED & INSTALLED BY TENANT. 7 CARD READER LOCATION.
- (8) FULL SIZE REFRIGERATOR, PROVIDED AND INSTALLED BY TENANT. PROVIDE ¼" COLD WATER LINE BY G.C.
- (9) MICROWAVE, PROVIDED AND INSTALLED BY TENANT.
- (10) SURFACE MOUNTED PAPER TOWEL DISPENSER, PROVIDED BY TENANT INSTALLED BY GENERAL CONTRACTOR.
- MOP AND BROOM RACK, TOUGH GUY 26" STAINLESS STEEL, MODEL NO. 1ECL4, PROVIDE P.T. WOOD BLOCKING @ 54" AFF.
- (12) X-RAY MODALITY MODEL: KONICA KDR X-RAY. PROVIDED AND INSTALLED BY VENDOR, SOUTHWEST X-RAY.
- (13) COPIER/PRINTER LOCATION, PROVIDED AND INSTALLED BY TENANT. (14) WATER HEATER, SEE PLUMBING DRAWINGS.
- (15) PHONE BOARD W/ FIRE RETARDANT 4'X8' PAINTED WOOD BACKBOARD. COORDINATE LOCATION W/ FLECTRICAL DRAWINGS.

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INTERIOR IMPROVEMENTS

2220 NW 164TH STREET, EDMOND, **OKLAHOMA**

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On the basis of the general scope required for the proper execution and completion of the work.

Drawing Title:

EQUIPMENT AND MILLWORK PLAN AND **NOTES**

/1 CITY COMMENTS 9.23.22

Issue Date | Drawn By | Checked By 6/22/22 MJA

Certified By: MICHAEL DELECTION MICHAEL MICH

Michael J. by Marchael 3

Albanese Date: 2022.09.28 10:05:29 -04'00'

> Drawing Number: **IA202**


Project Number:

22199

NOTICE


One (1) Set of Approved Building plans must remain on construction site during construction.


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CONSTRUCTION SHALL BE FERFORMED BY
A LICENSED AND BONDED CONTRACTOR
AND SHALL CONFORM TO THE RESPECTIVE
CODE REQUIREMENTS FOR EACH.

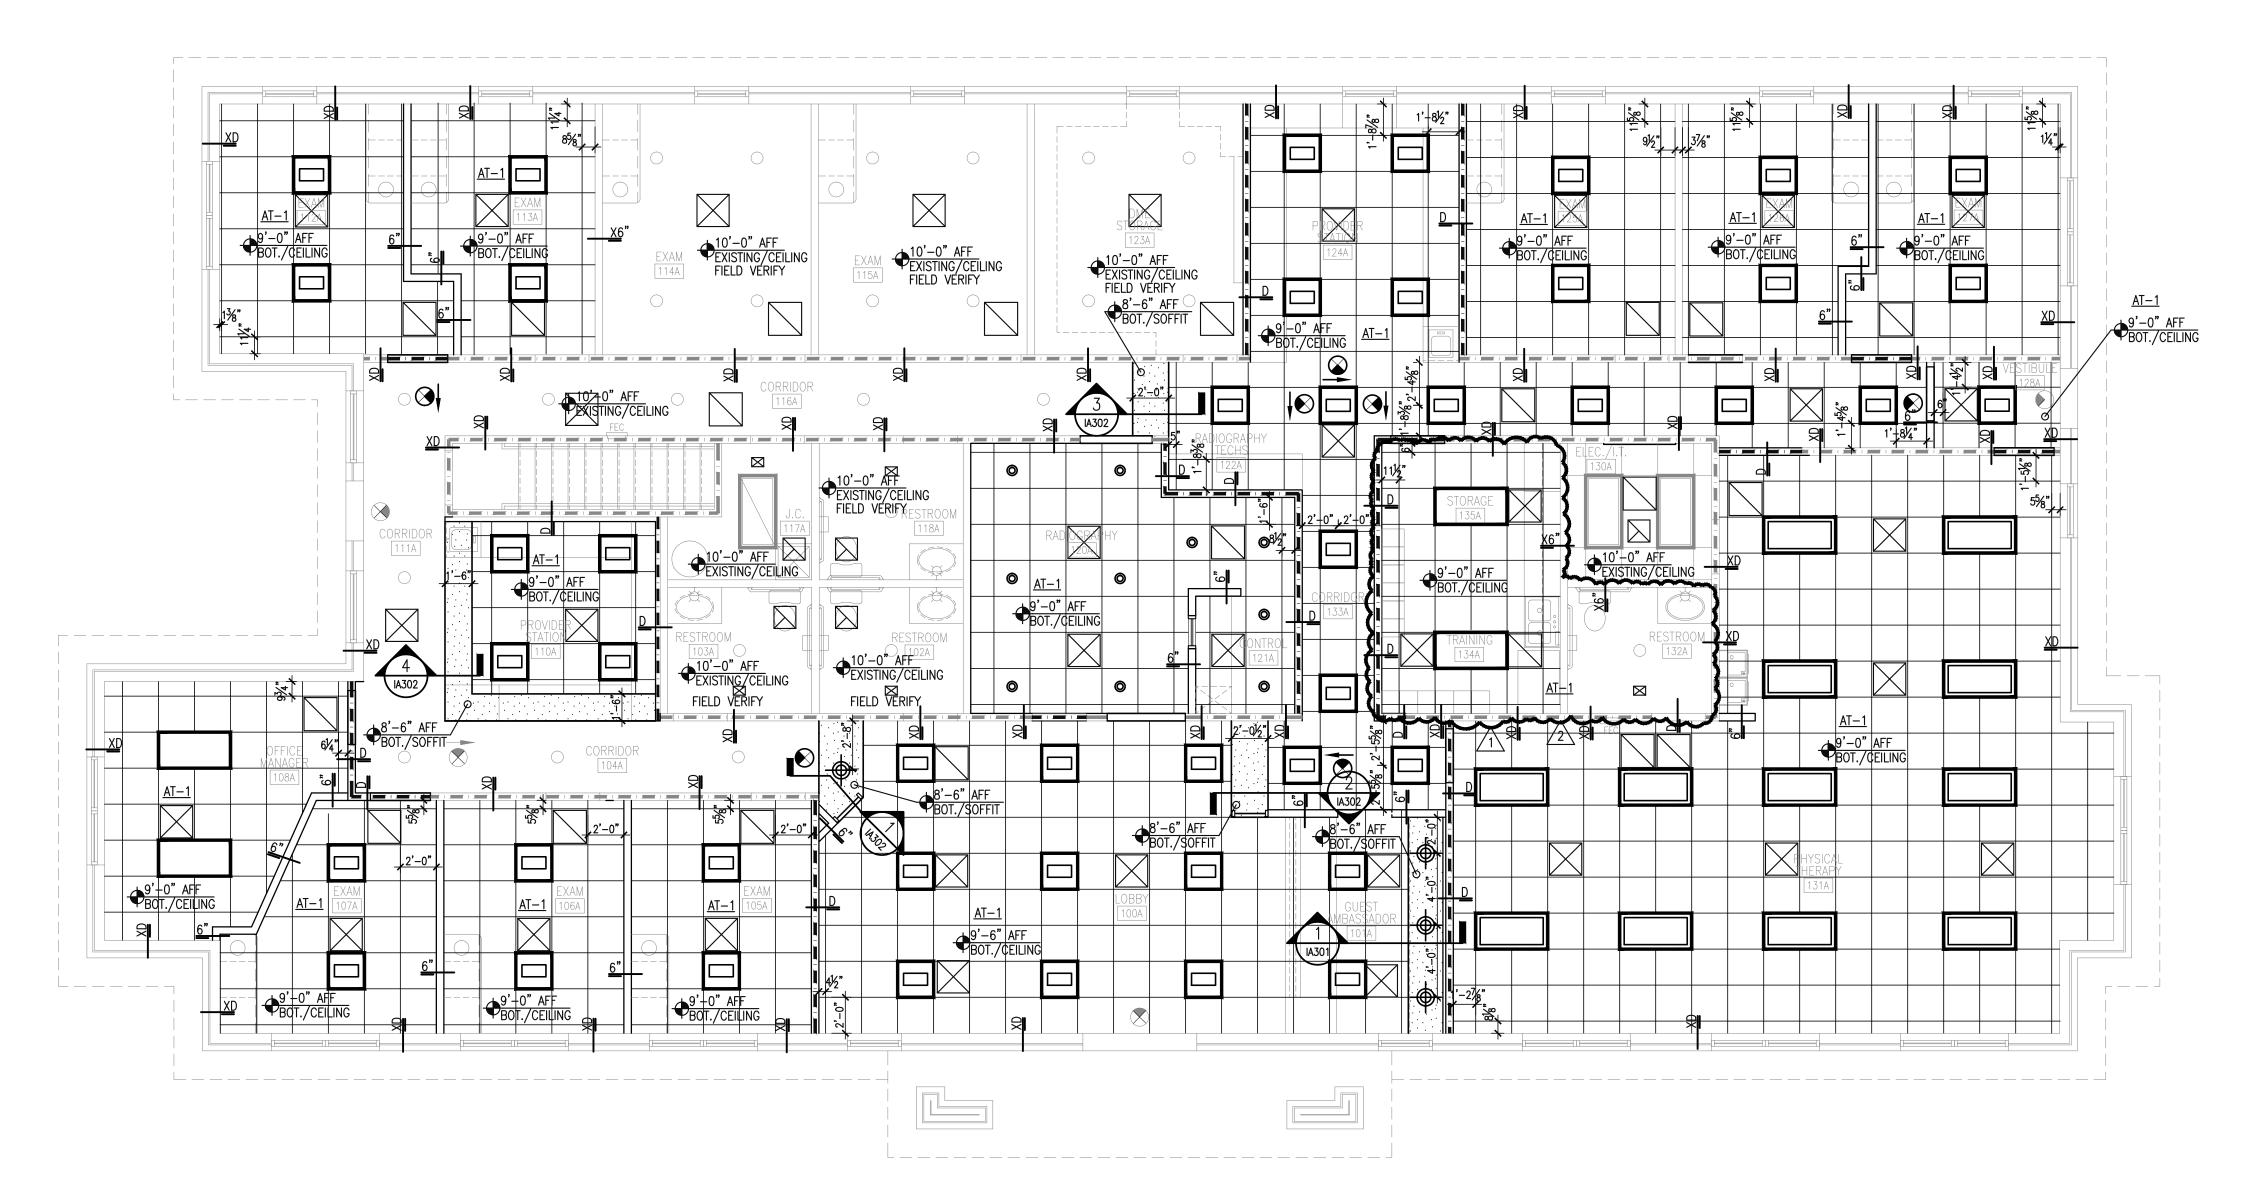

FIRST FLOOR
REFLECTED CEILING PLAN

SCALE: 3/16"=1'-0" 12

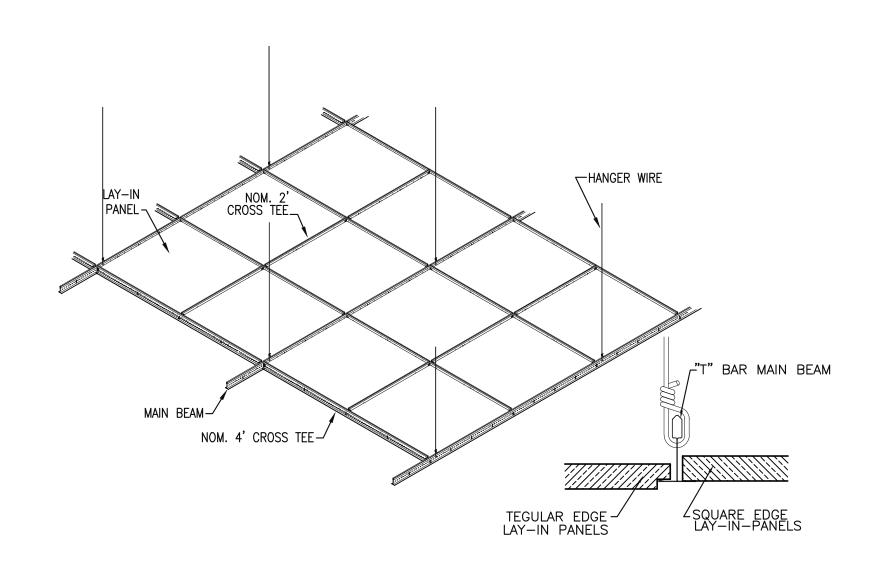

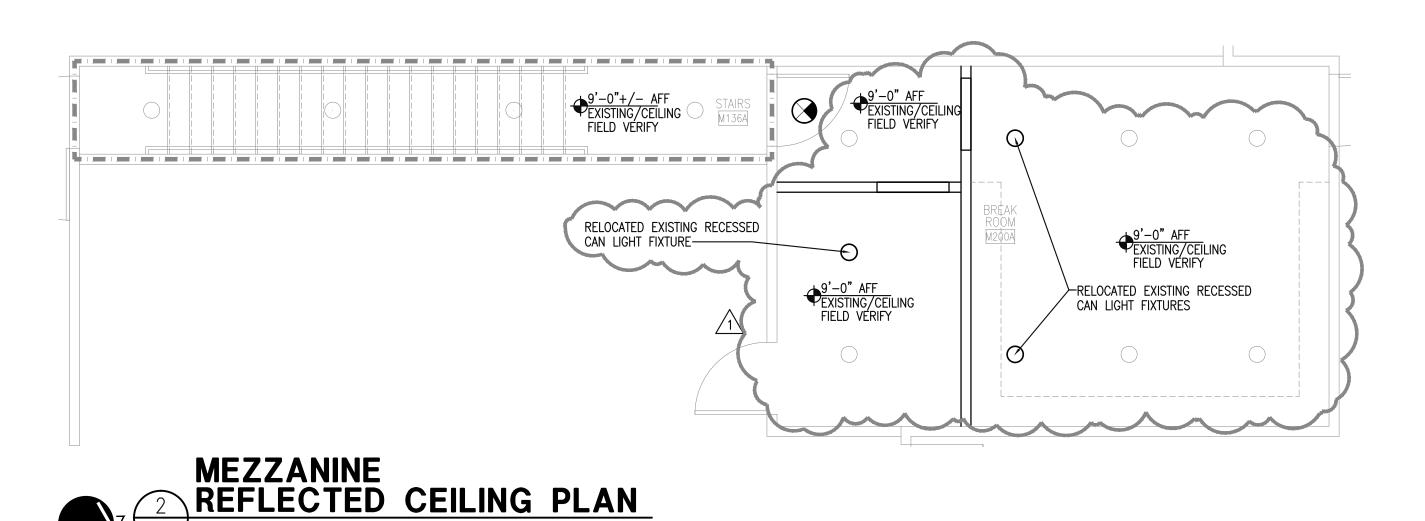

TYPICAL CEILING GRID DETAIL

NOTICE

One (1) Set of Approved
Building plans <u>must</u> remain
on construction site during
construction.

GEN. CEILING NOTES:

1. ALL NEW WALLS TERMINATE 6" PAST CEILING GRID WITH DIAGONAL BRACING @ 48" O.C. FROM CORNER OF REDUCE AS TO EXETAL STUD ARROTT. OF SEE CEILING PLAN. AT MODALITIES EXTEND TO 36" PAST CRUME CRIB LANS.

XD EXISTING WALL TO DECK**

6" NEW WALL 6" ABOVE CEILING **X6** INC.* ABOVE CEILING CIT **

DEVELOPMENT CENTER

2. LIGHTS & DIFFUSERS ON DRAWINGS ARE FOR LOCATION ONLY. COORDINATE WITH MECHANICAL AND ELECTRICAL DRAWINGS FOR EXACT SPECIFICATIONS AND VERIFICATION

3. ALL NEW CEILINGS TO BE INSTALLED AS INDICATED ABOVE FINISHED

4. ALL NEW ACOUSTIC CEILING PANELS TO BE CENTERED IN EACH DIRECTION WITHIN THE MAIN PORTION OF ANY ROOM OR SPACE, UNLESS NOTED OTHERWISE. WHERE APPLICABLE.

5. CEILING GRID SYSTEM: NRC EXPOSED "T" GRID; CEILING TILES: 2X2 CEILING TILES AS INDICATED IN NOTE 6.

6. ACOUSTIC CEILING GRID SHALL BE 15/16" AND SUSPENDED A MIN. OF 4'-0" O.C. WITH 12 GA. STEEL WIRE PER ASTM C636. EDGE GRID SHALL BE ATTACHED WITH SCREWS A MINIMUM OF 4'-0" O.C.


24" X 24" X 3/4" WHITE ACOUSTIC CEILING TILE, MFG: ARMSTRONG ULTIMA HEALTH ZONE HIGH NRC, TEGULAR #1911, PRELUDE 15/16" GRID SUSPENDED WITH EXPOSED WHITE "T" BAR FRAMING SYSTEM.

ACCEPTABLE CEILING MANUFACTURERS INCLUDE: ARMSTRONG, CELOTEX CORPORATION, USG INTERIORS, INC. OR EQUIVALENT
 INSTALL NEW 6" UNFACED SOUND ATTENUATION BATTS ABOVE NEW

CEILING TILES IN EXAM ROOMS.

9. LIGHT FIXTURES: ATTACH ALL 2X2 & 2X4 LIGHTS WITH AT LEAST TWO WIRES ON OPPOSITE CORNERS OF LIGHT FIXTURE.

CEILING LEGEND:

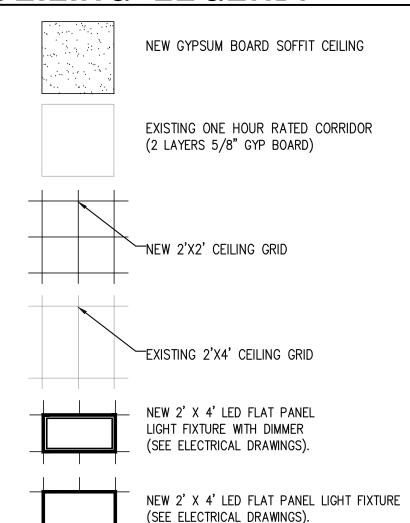

NEW 2' X 2' LED FLAT PANEL LIGHT FIXTURE (SEE ELECTRICAL DRAWINGS).

EXISTING 2' X 4' LIGHT FIXTURE (SEE ELECTRICAL DRAWINGS).

EXISTING 2' X 4' SURFACE MOUNT LIGHT FIXTURE (SEE ELECTRICAL DRAWINGS).

NEW 4" RECESSED CAN LED LIGHT FIXTURE (SEE ELECTRICAL DRAWINGS).

EXISTING WALL MOUNT LIGHT FIXTURE (SEE ELECTRICAL DRAWINGS).

NEW LED EXIT LIGHT

(SEE ELECTRICAL DRAWINGS).

EXISTING LED EXIT LIGHT (SEE ELECTRICAL DRAWINGS).

WIFI LOCATION
(IF APPLICABLE)


SUPPLY AIR DIFFUSER
(SEE MECHANICAL DRAWINGS).

RETURN AIR DIFFUSER
(SEE MECHANICAL DRAWINGS).

EXHAUST AIR DIFFUSER (SEE MECHANICAL DRAWINGS).

EXISTING 6" RECESSED CAN LED LIGHT FIXTURE ON DIMMER (SEE ELECTRICAL DRAWINGS).

NEW 4" RECESSED CAN LED LIGHT FIXTURE ON DIMMER (SEE ELECTRICAL DRAWINGS). DIRECT ORTHOPEDIC CARE

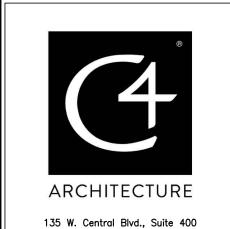

Orlando, Florida 32801 TEL: 407.363.6136

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DIRECT ORTHOPEDIC CARE

IMPROVEMENTS
2220 NW 164TH
STREET,

INTERIOR

SCOPE Drawings:

These drawings indicate the general scope of the project in terms of architectural design concept, the dimensions of the building, the major architectural elements and the type of structural, mechanical and electrical systems.

The drawings do not necessarily

indicate or describe all work required for full perfomance and completion of the requirements of the contract.

On the basis of the general scope indicated or described, the trade contractors shall furnish all items required for the proper execution and completion of the work.

Prawing Title:

REFLECTED
CEILING PLAN,
DETAIL

AND NOTES

<u>∕1</u> cith	COMMENTS	9.23.22
2 CITY	COMMENTS	9.28.22
1		

Issue Date Drawn By Checked By
6/22/22 MJA MJA


Certified By:

Michael Jeby Michael Je Albanese Date; 2022.09.28
10:05:51-04'00'

Drawing Number:


Project Number:

ALL ELECTRICAL, PLUMBING, HEAT AND AIR, FENCE, SIGN, SIDEWALK, AND DRIVEWAY CONSTRUCTION SHALL BI A LICENSED AND BONDE AND SHALL CONFORM TO THE RESPECTIVE CODE REQUIREMENTS FOR EACH.

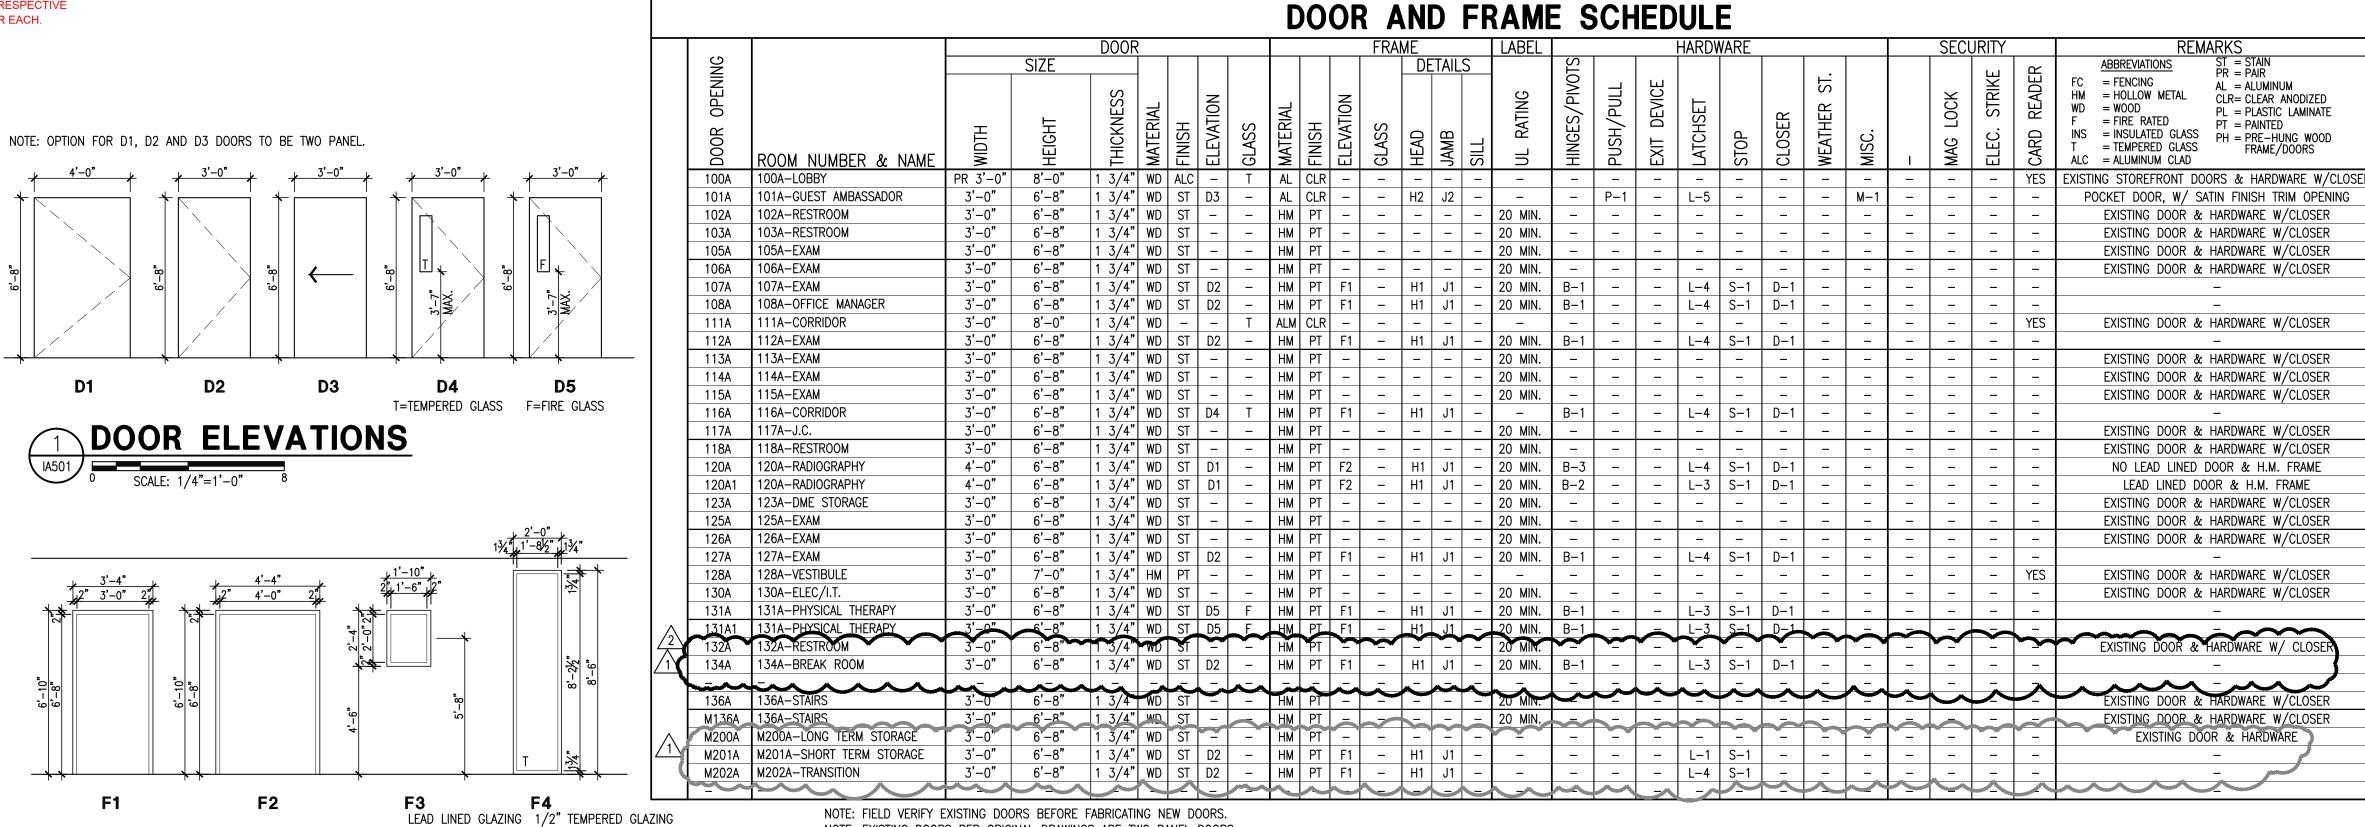

-5/8" GYPSUM WALL BOARD -5/8" GYPSUM WALL BOARD SEE WALL TYPE SEE WALL TYPE - STEEL STUDS -FLUSH WOOD DOOR HOLLOW METAL KNOCK-DOWN OR WELDED DOOR FRAME - FLUSH WOOD DOOR - HOLLOW METAL KNOCK-DOWN OR WELDED DOOR FRAME **HEAD DETAIL** JAMB DETAIL SCALE: $1 \frac{1}{2} = 1'-0"$ $1 \ 1/2" = 1'-0"$ 5/8" GYPSUM WALL BOARD-SEE WALL TYPE ---5/8" GYPSUM WALL BOARD STEEL STUDS — SEE WALL TYPE SATIN FINISH ALUMINUM TRIM — STEEL STUDS P.T. WOOD BLOCKING FIRE RETARDANT WOOD BLOCKING POCKET DOOR TRACK ASSEMBLY -SATIN FINISH ALUMINUM TRIM -FLUSH WOOD DOOR -POCKET DOOR TRACK ASSEMBLY 3'-0" WIDE FLUSH WOOD DOOR **HEAD DETAIL H2** JAMB DETAIL $1 \ 1/2" = 1'-0"$ 1 1/2" = 1'-0"


FRAME ELEVATIONS FOR RADIOGRAPHY IN 1 3/4" X 4" CLEAR ANODIZED ALUMINUM

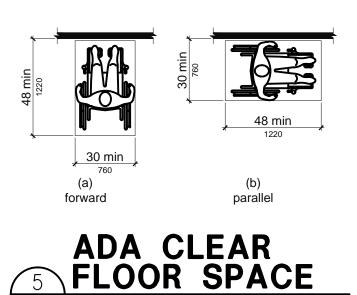


O SCALE: 1/4"=1'-0"


O SCALE: 1/4"=1'-0"


NOTE: EXISTING DOORS PER ORIGINAL DRAWINGS ARE TWO PANEL DOORS.

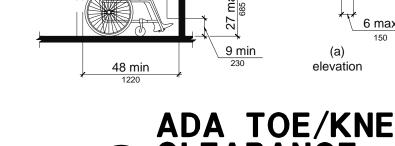



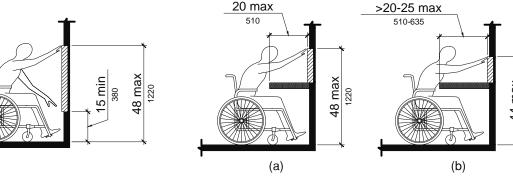

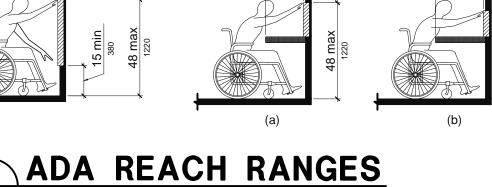


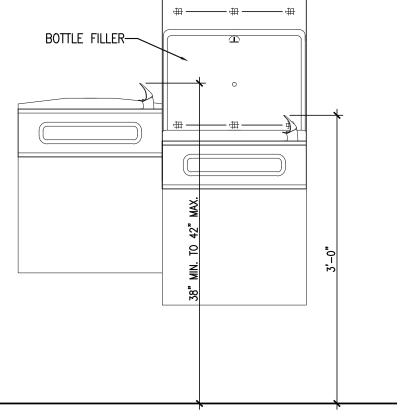



on construction site during

construction.

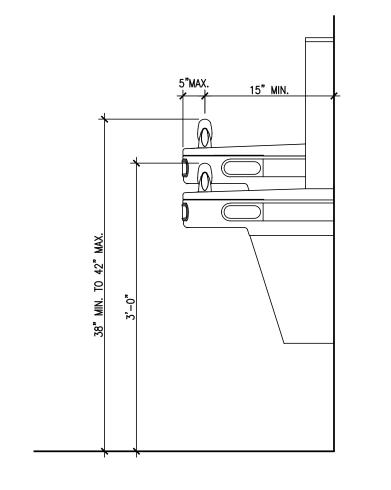

DRINKING FOUNTAINS

HARDWARE SCHEDULE

THIS SHEET IS PART OF <u>HINGES/PIVOTS</u> DES. QTY. TYPE B-1 3/LEAF HINGES B-2 1/LEAF PIVOT-FLOOR MOUNTEDCITTY OF ON USAGPION BOOK 17 1/LEAF INTERMEDIATE PIVOT ML19 #US26D RIXSON
DEM ELOPMUSDAD CHARLE B-3 3/LEAF HINGES

LATCH-FUNCTION DES. QTY. TYPE MODEL # FINISH OFFICE LOCKSET 2500 SERIES #US26D HAGER L-2 1 STOREROOM LOCKSET 2500 SERIES #US26D HAGER #US26D HAGER CLASSROOM LOCKSET 2500 SERIES L-3 1 PASSAGE NON-LOCKING 2500 SERIES #US26D HAGER SLIDING DOOR LOCK 2½" BACKSET

2001 ADAP-3 #US10B ACCURATE <u>PUSH/PULL</u> FINISH BRAND DES. QTY. TYPE MODEL # #US26D ACCURATE P-1 2/LEAF PULL-HANDLE 7200P DES. QTY. TYPE FINISH S-1 1/LEAF FLOOR STOP 3310 #US26D DCI DES. QTY. TYPE MODEL # FINISH 1460 SERIES #US26D LCN D-1 1/LEAF SURFACE MOUNTED MISCELLANEOUS DES. QTY. TYPE FINISH BRAND MODEL # #US26D ACCURATE M-1 1/LEAF INSIDE ADA HANDLE 2001ADAP OUTSIDE COIN RELEASE

DOOR SCHEDULE NOTES

1. PROVIDE NEW MEDIUM DUTY ADA LEVER HARDWARE BY HAGER. ALL HARDWARE MAY BE SUBSTITUTED WITH OWNER APPROVAL.

STRIKE PLATE

BACK TO BACK ADA PULL

DUST BOX

- VERIFY SECURITY HARDWARE WITH TENANT. 4. PROVIDE SILENCERS (3) PER SINGLE DOOR BY IVES AT ALL DOORS.
- MANUFACTURER MAY BE SUBSTITUTED AT OWNER'S REQUEST.
- 5. COORDINATE KEYING LOCKSETS WITH TENANT AND W/ LANDLORDS REMOVABLE CORE KEYING SYSTEM.
- 6. DOOR FRAMES: ALUMINUM KNOCK DOWN, 16 GAUGE. MANUFACTURER: TO BE DETERMINED, 5 3/4 JAMB DEPTH. STYLE: MITERED CORNERS. CLEAR ANODIZED FINISH. EXISTING FRAMES: HOLLOW METAL-MATCH EXISTING.
- 7. WOOD DOORS SHALL BE 5 LAYER SOLID CORE, PLASTIC LAMINATE, ROTARY SLICED BIRCH DOORS. MANUF. = EGGERS INDUSTRIES OR EQUAL; WILSONART: STERLING ASH 7995-38, FINE VELVET TEXTURE FINISH. EXISTING DOORS: SOLID CORE WOOD.

* SECURITY HARDWARE VENDOR WHEN SELECTED SHALL COMPLY WITH INTERNATIONAL FIRE CODE 1010.1.9.8 AND INTERNATIONAL BUILDING CODE 1010.1.9.8 FOR ACCESS-CONTROLLED DOORS. IF REQUESTED, SECURITY VENDOR WILL SUBMIT DOCUMENTATION CONFIRMING THE FOLLOWING:

1. A SENSOR SHALL BE PROVIDED ON THE EGRESS SIDE, ARRANGED TO DETECT AN OCCUPANT APPROACHING THE DOORS, AND SHALL CAUSE THE ELECTRIC LOCKING SYSTEM TO UNLOCK.

2. THE ELECTRIC LOCKS SHALL BE ARRANGED TO UNLOCK BY A SIGNAL FROM

OR LOSS OF POWER TO THE SENSOR. 3. LOSS OF POWER TO THE LOCK OR LOCKING SYSTEM SHALL AUTOMATICALLY UNLOCK THE ELECTRIC LOCK.

4. THE DOORS SHALL BE ARRANGED TO UNLOCK FROM A MANUAL UNLOCKING DEVICE LOCATED 40 INCHES TO 48 INCHES VERTICALLY ABOVE THE FLOOR WITHIN MANUAL UNLOCKING DEVICE AND THE DEVICE SHALL BE CLEARLY INDENTIFIED BY A SIGN THAT READS "PUSH TO EXIT". WHEN OPERATED, THE MANUAL UNLOCKING DEVICE SHALL RESULT IN DIRECT INTERRUPTION OF POWER TO THE ELECTRIC LOCK-INDEPENDENT OF OTHER ELECTRONICS-AND THE ELECTRIC LOCK SHALL REMAIN UNLOCKED FOR NOT LESS THAN 30 SECONDS. 5. ACTIVATION OF THE BUILDING FIR ALARM SYSTEM, WHERE PROVIDED, SHALL AUTOMATICALLY UNLOCK THE ELECTRIC LOCK, AND THE ELECTRIC LOCK SHALL REMAIN UNLOCKED UNTIL THE FIRE ALARM SYSTEM HAS BEEN RESET.

6. ACTIVATION OF THE BUILDING AUTOMATIC SPRINKLER SYSTEM OR FIRE DETECTION SYSTEM, WHERE PROVIDED, SHALL AUTOMATICALLY UNLOCK THE ELECTRIC LOCK. THE ELECTRIC LOCK SHALL REMAIN UNLOCKED UNTIL THE FIRE ALARM SYSTEM HAS

7. EMERGENCY LIGHTING SHALL BE PROVIDED ON THE EGRESS SIDE OF THE DOOR. 8. THE DOOR LOCKING SYSTEM UNITS SHALL BE LISTED IN ACCORDANCE WITH

DIRECT

ORTHOPEDIC CARE

ARCHITECTURE 135 W. Central Blvd., Suite 400 Orlando, Florida 32801 TEL: 407.363.6136 @Copyright 2022

DIRECT ORTHOPEDIC CARE

INTERIOR IMPROVEMENTS

2220 NW 164TH STREET EDMOND, **OKLAHOMA**

Scope Drawings: These drawings indicate the general scope of the project in

terms of architectural design concept, the dimensions of the building, the major architectural elements and the type of structural, mechanical and electrical systems.

The drawings do not necessarily indicate or describe all work required for full performance and completion of the requirements of the contract.

On the basis of the general scope indicated or described, the trade ontractors shall furnish all items required for the proper execution and completion of the work.

Drawing Title: DOOR AND **HARDWARE**

SCHEDULE & **ADA DETAILS**

/1\ CITY COMMENTS 9.23.22 2 CITY COMMENTS 9.28.22

Issue Date Drawn By Checked By 6/22/22 MJA

Certified By:

Michael Albanese 10:08:14-04'00'

> **Drawing Number:** IA501

> > **Project Number:**

22199

MEN

> 10-24 max

ADA PROTRUDING

O SCALE: 1/4"=1'-0"

OBJECTS, SIGNAGE

ALL ELECTRICAL, PLUMBING, HEAT AND AIR, FENCE, SIGN, SIDEWALK, AND DRIVEWAY A LICENSED AND BONDE AND SHALL CONFORM TO THE RESPECTIVE CODE REQUIREMENTS FOR EACH. **DIRECT** 10 IA504 LEAD LINED COUNTERTOP-9 IA504 PLASTIC LAMINATE -PLASTIC LAMINATE COUNTERTOP 2'-0" ARCHITECTURE 135 W. Central Blvd., Suite 400 KNEE SPACE Orlando, Florida 32801 TEL: 407.363.6136 KNEE SPACE @Copyright 2022 5'-01/8" RADIOGRAPHY TECHS 122A **DIRECT** NOT USED CONTROL 123A NOT USED NOT USED CARE **INTERIOR IMPROVEMENTS** STREET, EDMOND, **OKLAHOMA** SOFFIT THIN SET Scope Drawings: These drawings indicate the 14 IA504 terms of architectural design — 10" DIA. STAINLESS STEEL GROMMET 10" DIA. STAINLESS elements and the type of STEEL GROMMET-__1 1/2" STAINED WOOD CAP NOMINAL 2X12 structural, mechanical and -1 1/2" STAINED WOOD - PLASTIC LAMINATE PLASTIC LAMINATE electrical systems. CAP' NOMINAL 2X12 COUNTERTOP COUNTERTOP --FIBERGLASS BEAM -FIBERGLASS BEAM The drawings do not necessarily - PLASTIC LAMINATE PLASTIC LAMINATE 18 IA504 19 IA504 SOLID SURFACE indicate or describe all work CABINET SOLID SURFACE 15 IA504 CABINET ---required for full perfomance and COUNTERTOP-PLASTIC LAMINATE FULL PLASTIC LAMINATE FULL EXTENSION DRAWERS EXTENSION DRAWERS -PLASTIC LAMINATE the contract. COUNTERTOP -PLASTIC LAMINATE contractors shall furnish all items required for the proper execution and completion of the work. SLIDE-OUT SHELF-—PLASTIC LAMINATE FULL EXTENSION DRAWERS KNEE SPACE Drawing Title: SLIDE-OUT SHELF— 1'-6" 1'-11½" 1'-11½" 1'-8" 1'-7½" 1'-7½" 2'-0" 1'-7½" 1'-7½" 1'-8" 9 115A/125A/127A 115A/125A/127A SCALE: 1/2"=1'-0" 4 EXAM 105A/106A 107A/112A/126A **ELEVATIONS 8 GUEST AMBASSADOR 101A** 7 GUEST AMBASSADOR 101A GUEST AMBASSADOR 101A IA502 0 SCALE: 1/2"=1'-0" 4 1 CITY COMMENTS 9.23.22 2 CITY COMMENTS 9.28.22 Issue Date Drawn By Checked By ADJUSTABLE SHELF (TYP.) 6/22/22 MJA —ALUMINUM REVEALS PLASTIC LAMINATE COUNTERTOP ADJUSTABLE SHELF (TYP ADJUSTABLE SHELF (TYP 8 IA504 PLASTIC LAMINATE COUNTERTOP 20 IA504 (2) IA504 PRINTER ROLL-OUT SHELF-20 IA504 **Certified By:** 1 IA504 ROLL-OUT SHELF PLASTIC LAMINATE COUNTERTOP 2'-0" 2'-0" MICHAEL ALBANGSEally signed PLASTIC LAMINATE Michael Jabred Michael J Albanese Date: 2022.09.28 KNEE SPACE KNEE SPACE KNEE SPACE 1" 1'-8¾" 2'-0" 1" 1'-4" 10'-43/8" 1'-4" Drawing Number: IA502 PROVIDER STATION 110A PROVIDER STATION 110A 14 PROVIDER STATION 110A PROVIDER STATION 110A IA502 0 SCALE: 1/2"=1'-0" IA502 0 SCALE: 1/2"=1'-0" 4 IA502 0 SCALE: 1/2"=1'-0" 4 NOTION SCALE: 1/2"=1'-0" Project Number: One (1) Set of Approved Building plans must remain 22199 on construction site during

construction.

ORTHOPEDIC CARE

ORTHOPEDIC

2220 NW 164TH

general scope of the project in concept, the dimensions of the building, the major architectural

completion of the requirements of

On the basis of the general scope

MILLWORK

10:06:40 -04'00'

1 INTÉRIOR FINISH PLAN

SCALE: 3/16"=1'-0"


MEZZANINE INTERIOR FINISH PLAN

STAIRS M136A

M201A

RB1 P1

IA801 / IA801

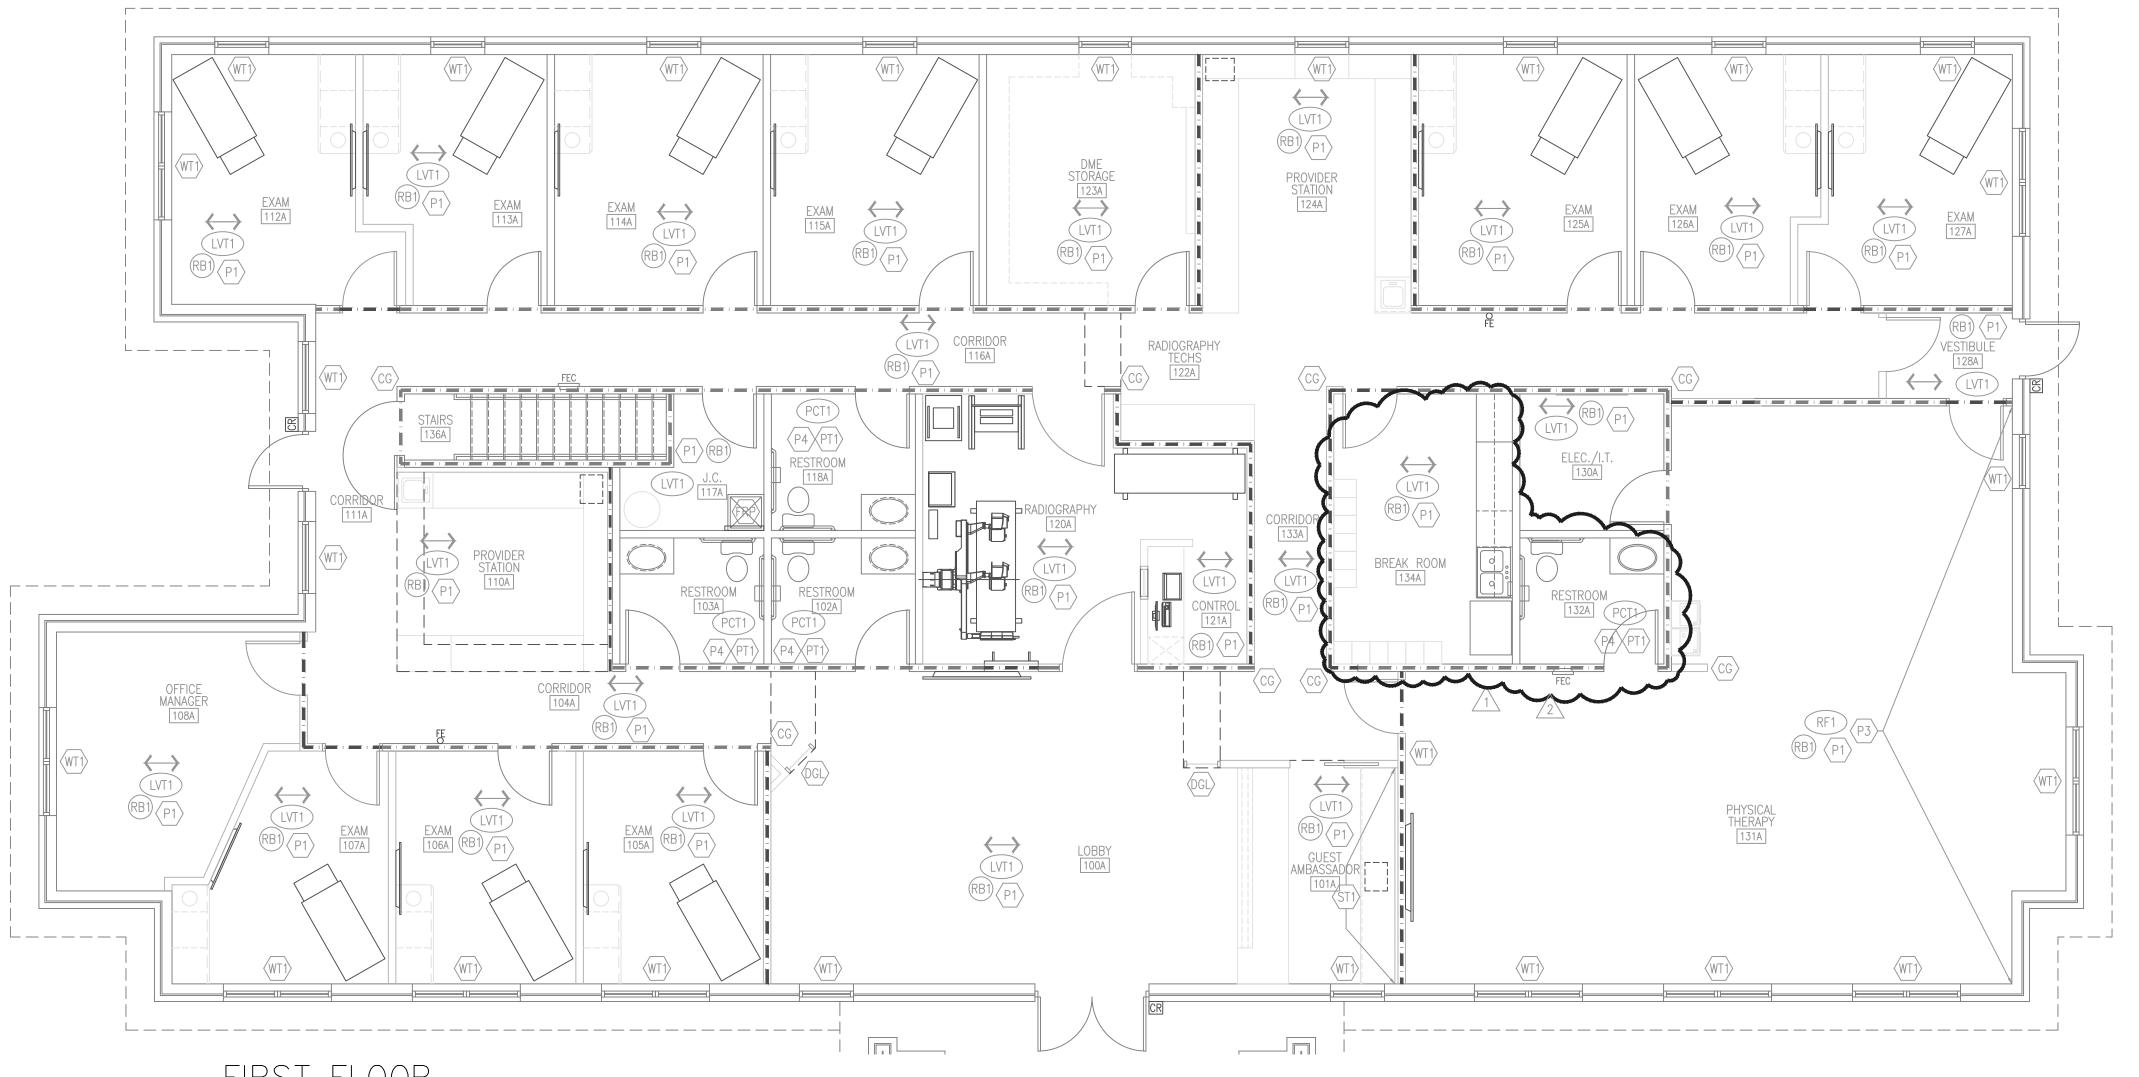

LONG—TERM STORAGE M200A



FLOOR FINISHES RF1 MATERIAL: RESILIENT RUBBER FLOORING MFG: ECORE COLLECTION: BASIC FIT DESIGN NAME: BASIC FIT NAME: BASIC FIT

R NAME: GREEN TEA

SIZE: 12"X24" TO 5'-0" AFF

SIZE: 48" WIDE ROLL OR 23" INTERLOCK TILE LOCATION: SEE 1/IA801 COLOR NAME: GREEN TEA INSTALLATION: _ LOCATION: SEE 1/IA801

MATERIAL: LUXURY VINYL TILE MFG: SHAW CONTRACT STYLE: UNVEIL 0601V COLOR: ALTER 01518 SIZE: 9"X36" INSTALLATION: BRICK

LOCATION: SEE 1/IA801

MATERIAL: PORCELAIN TILE MFG: CONCEPT SURFACES STYLE: KEANU COLOR: AZUL SIZE: 12"X24" - MATTE FINISH INSTALLATION: RUNNING BOND LOCATION: SEE 1/IA801

> MATERIAL: GROUT MFG: BOSTIK, TRUCOLOR COLOR: DELORÉAN GRAY H160

BASE FINISHES

MATERIAL: RUBBER COVE BASE MFG: JOHNSONITE (RB1) STYLE: COVE BASE COLOR: RECESS, RWDC-20, GREY SIZE: 4" HIGH, CONT. ROLL LOCATION: SEE FINISH PLAN SHEET

DECORATIVE WALL

MATERIAL: GLAZING FILM COLOR: CHAMONIX-SH2EMCH LOCATION: LOBBY 100A

MATERIAL: EPOXY PAINT MFG: SHERWIN WILLIAMS \(P4 \rightarrow \)
 FINISH: 2 PART EPOXY COLOR: MARCH WIND SW7668 LOCATION: RESTROOMS ONLY

NORTH WALL

WALL FINISHES

MATERIAL: PORCELAIN TILE MFG: CONCEPT SURFACES

MFG: BOSTIK, TRUCOLOR

COLOR: DELORÉAN GRAY H160

COLOR: MARCH WIND SW7668

STYLE: KEANU COLOR: AZUL

MATERIAL: GROUT

MATERIAL: PAINT

MATERIAL: PAINT

LOCATION: SOFFITS

MATERIAL: PAINT

(P3) FINISH: EGGSHELL

P1 MFG: SHERWIN WILLIAMS FINISH: EGGSHELL

LOCATION: FIELD COLOR

P2 MFG: SHERWIN WILLIAMS FINISH: EGGSHELL FINISH

COLOR: SOFTWARE SW7074

LOCATION: PHYSICAL THERAPY

MFG: SHERWIN WILLIAMS: PANTONE

COLOR: 368 C (RGB 120, 190, 32)

MATERIAL: THIN-SET STONE MFG: REALSTONE SYSTEMS STYLE: PEWTER HONED PANEL COLOR: RES WSCR SVBH SIZE: 6" X 24"
INSTALLATION: RUNNING BOND

LOCATION: SEE 1/IA801 MATERIAL: FRP WALL PANELS (48"H.) MFG: USFRP.COM OR EQUAL (FRP) FINISH: SMOOTH COLOR: WHITE

LOCATION: JANITOR'S CLOSET 117A

MILLWORK SS-1 MATERIAL: SOLID SURFACE MFG: WILSONART COLOR NAME: DESIGNER WHITE COLOR NUMBER: D354SL(1) FINISH: EASED EDGE INSTALLATION: FRONT RECEPTION DESK

INDICATES BASE FINISH TO BE DETERMINED

BAKED WHITE ENAMEL FINISH.

CONCRETE ELEVATED SLABS ONLY.

DESIGNER BEFORE INSTALLATION.

INFORMATION.

INSTALLATION JOINT AND SEAM LAY-OUTS.

B. REFERENCE INTERIOR ELEVATIONS, WHERE PROVIDED, FOR ADDITIONAL FINISH

D. ALTERNATES WILL NOT BE ACCEPTED WITHOUT WRITTEN APPROVAL OF

F. ALL CARPET IS TO BE DIRECT GLUE, UNLESS NOTED OTHERWISE.

UNIFORM TRANSITION. UNLESS NOTED OTHERWISE.

TO MATCH WALL COLOR THAT DOOR IS LOCATED ON.

K. ELECTRICAL DEVICES & COVERS COLOR TO MATCH EXISTING.

SURFACE IF WALL TILE NOT BEING USED.

STAIRS= CLASS A, ROOMS AND ENCLOSED SPACES= CLASS C.

C. PAINT ALL EXPOSED METAL SURFACES (ie. GRILLES, HEATERS, AND FIRE EXTINGUISHER CABINETS) TO MATCH ADJACENT SURFACE. FIRE EXTINGUISHER CABINETS CAN ALSO BE

ARCHITECT/DESIGNER. SAMPLES, WHEN APPLICABLE, SHALL BE SUBMITTED FOR REVIEW. E. ALL FLOORING TRANSITIONS ARE TO BE EASED USING LATEX TO ACHIEVE A SMOOTH AND

G. GC TO HAVE MOISTURE TESTING DONE BEFORE INSTALLING CARPET ON NEW LIGHTWEIGHT

H. TRANSITIONS BETWEEN UNLIKE FLOORING SURFACES ARE TO BUTT UP TO EACH OTHER

BE USED BETWEEN UNLIKE FLOORING SURFACES. TRANSITION STRIPS ARE TO BE

I. ALL HOLLOW METAL DOORS AND/OR FRAMES TO BE PAINTED WITH TWO (2) COATS OF ZERO VOC LATEX SEMI-GLOSS ENAMEL OVER PROPERLY PRIMED SURFACE. PAINT COLOR

J. ALL FINISHES TO MEET CLASS C OR BETTER FOR FLAME SPREAD AND SMOKE DEVELOPED PER 2021 INTERNATIONAL BUILDING CODE TABLE 803.13 & 803.1.2.

MANUFACTURERS STANDARD - SCHLUTER SYSTEMS. VERIFY WITH ARCHITECT/INTERIOR

WITHOUT ANY GRADE DIFFERENCE. IF THIS IS NOT POSSIBLE THEN TRANSITION STRIPS TO

NON-SPRINKLERED: CORRIDORS & EXIT ENCLOSURES=CLASS B, EXIT PASSAGEWAYS, EXIT

PRIME ALL WALL SURFACES WITH A MINIMUM OF TWO (2) COATS BEFORE WALL PAINT TO

L. USE 2-PART EPOXY PAINT ON ALL INTERIOR RESTROOM WALLS TO CREATE A WASHABLE

M. PATCH AND REPAIR ALL GYPSUM BOARD TO REMOVE ALL HOLES AND IMPERFECTIONS.

N. PAINT ALL WALL SURFACES, WITH A MINIMUM OF TWO (2) COATS OF QUALITY GRADE

O. INTERIOR FINISHES SHALL BE IN ACCORDANCE WITH 2021 INTERNATIONAL FIRE CODE, &

P. ALL NEW WOOD DOORS TO HAVE ONE (1) COAT OF STAIN, ONE (1) COAT OF SEALER,

T. ALL QUARTZ, SOLID SURFACE, MARBLE TYPE MATERIALS WITH PATTERNS: AWARDED

FABRICATOR TO SUBMIT PATTERN MATCHING DRAWINGS TO ARCHITECT/INTERIOR DESIGNER

ARCHITECT/INTERIOR DESIGNER FOR APPROVAL PRIOR TO PURCHASE AND INSTALLATION.

V. GC OR INSTALLER MUST STORE FLOORING MATERIAL WITHIN THE SUITE OF INSTALLATION. PER MANUFACTURE SPECIFICATION REQUIREMENTS THE FLOORING MATERIAL MUST BECOME

LABORATORIES AND FACTORY MUTUAL OR ANY EQUIPMENT ID, PERFORMANCE RATING,

ACCLIMATED TO THE ENVIRONMENT PRIOR TO INSTALLATION. THIS WILL PREVENT

SHRINKAGE AND OR EXPANDING OF THE PRODUCT AFTER INSTALLATION.

X. DO NOT PAINT OVER ANY CODE REQUIRED LABELS, SUCH AS UNDERWRITERS

W. ALL NEW PARTITIONS TO BE FINISHED TO A LEVEL 4 FINISH PER ASTM C 840.

AND TWO (2) COATS OF POLYURETHANE SATIN FINISH OVER PROPERLY PREPARED SURFACE. PAINT COLOR TO MATCH EXISTING OR USE PLASTIC LAMINATE VENEER DOORS. Q. G.C. TO PROVIDE NEW BLINDS AT NEW WINDOWS IN OFFICE AREA TO MATCH EXISTING IF

TABLE 803.3, BUSINESS NON-SPRINKLERED: CORRIDORS & EXIT ENCLOSURES: B, EXIT

ASSURE COMPLETE COVERAGE AND NO PREVIOUS COLOR BLEED THROUGH.

PAINT, INCLUDING TOUCH UPS AFTER MOVE IN OR UPON PUNCH-LIST.

STAIRS & EXIT PASSAGEWAYS: A, ROOMS & ENCLOSED SPACES: C.

R. ALL BULKHEADS ARE TO BE PAINTED SAME COLOR AS WALL IF REQUIRED.

U. INSTALLER TO SUBMIT RUN DIAGRAMS FOR ALL BROADLOOM CARPET TO

S. ALL FURNITURE AND WORKSTATIONS INSTALLED BY TENANT.

FOR APPROVAL PRIOR TO CUTTING SLABS.

NAME OR NOMENCLATURE PLATES.

LOCATION: GUEST AMBASSADOR PL-1 MATERIAL: PLASTIC LAMINATE

MFG: NEVAMAR THRUCOLOR HPL COLOR NAME: CHALK WHITE COLOR NUMBER: NM55S-7024-GL FINISH: GLOSS

INSTALLATION: CABINETS-VERTICAL SURFACES LOCATION: ALL MILLWORK

PL-2 MATERIAL: PLASTIC LAMINATE MFG: WILSONART COLOR NAME: NORTH SEA COLOR NUMBER: D90-60 FINISH: MATTE FINISH INSTALLATION: COUNTERTOPS LOCATION: ALL MILLWORK

PL-3 MATERIAL: PLASTIC LAMINATE MFG: WILSONART COLOR NAME: STERLING ASH COLOR NUMBER: 7995-38 FINISH: FINE VELVET TEXTURE INSTALLATION: VERTICAL LOCATION: INTERIOR WOOD DOORS

WD1 MATERIAL: SOLID PREMIUM GRADE HARDWOOD MFG: N/A COLOR NAME: COGNAC MAPLE COLOR NUMBER: 7738-58

FINISH: MATTE FINISH INSTALLATION: HORIZONTAL LOCATION: RECEPTION DESK OVER FIBERGLASS BEAM

CG MATERIAL: CORNER GUARD
MFG: C/S ACROVYN SSM-20AN COLOR NAME: FOLKSTONE COLOR NUMBER: 927

FINISH: SHADOWGRAIN TEXTURE H.M. DOORS AND FRAMES TO BE SEMI-GLOSS INSTALLATION: PARTIAL HEIGHT 48"AFF, 2",1/4" RADIUS FINISH USING SHERWIN WILLIAMS PAINT TO MATCH FIELD COLOR. SEE P1 ABOVE. LOCATION: INTERIOR WALL CORNERS

WINDOW TREATMENTS

COLOR NAME: VELA, WHITE

FINISH: 3% OPENNESS

LOCATION: SEE 1/IA801

COLOR NUMBER: 0002

INDICATES FLOOR FINISH TO BE DETERMINED

A. PROVIDE SAMPLES OF ALL FINISHES TO ARCHITECT/DESIGNER FOR REVIEW INCLUDING

INDICATES MICHTAYCOOF OKLAHOMA CITY

Owner:



135 W. Central Blvd., Suite 400 Orlando, Florida 32801 TEL: 407.363.6136

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Project:

INTERIOR **IMPROVEMENTS**

2220 NW 164TH STREET EDMOND, OKLAHOMA

Scope Drawings: These drawings indicate the

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Drawing Title: INTERIOR FINISH PLAN,

SCHEDULE

Revisions: /1\ CITY COMMENTS 9.23.22 2 CITY COMMENTS 9.28.22

Issue Date | Drawn By | Checked By 6/22/22 MJA MJA

Certified By: THE OF OKLAN MICHAEL ADANTE ally signed

**Albaneśe Date: 2022.09.28 MATERIAL: MANUEL ROLLER SHA MFG: SWF CONTRACT 10:07:07 -04'00'

Drawing Number:

Project Number:

22199

<u>GLAZING</u> MFG: 3M

DGL FINISH: FASARA GLASS

Building plans must remain on construction site during

NOTICE

One (1) Set of Approved construction.