

## 2504 VMP TENANT FINISH 2504 Veterans Memorial Parkway South Lafayette, Indiana 47909

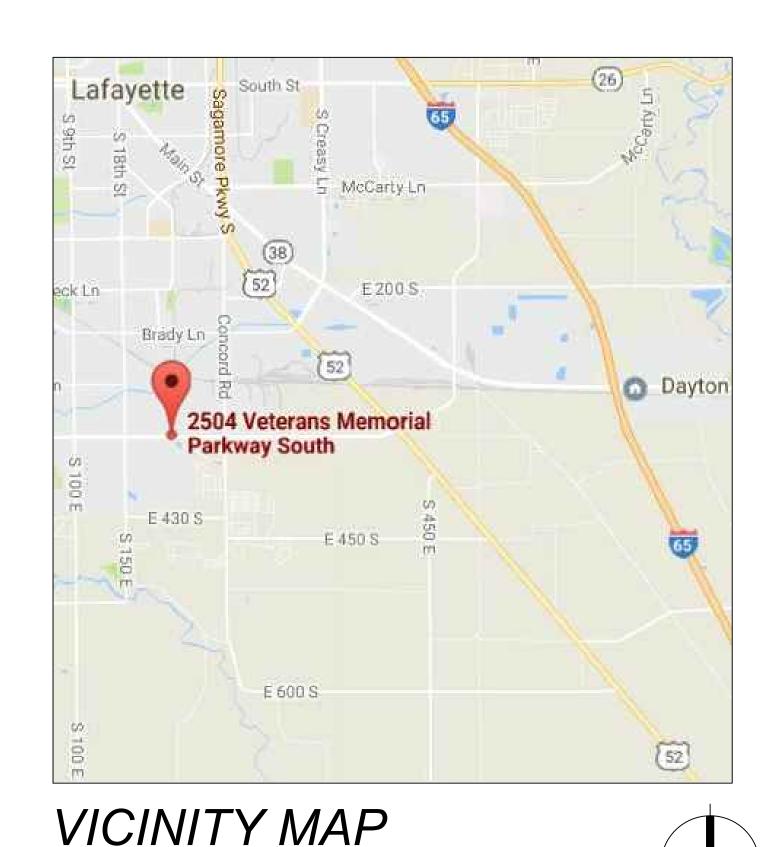

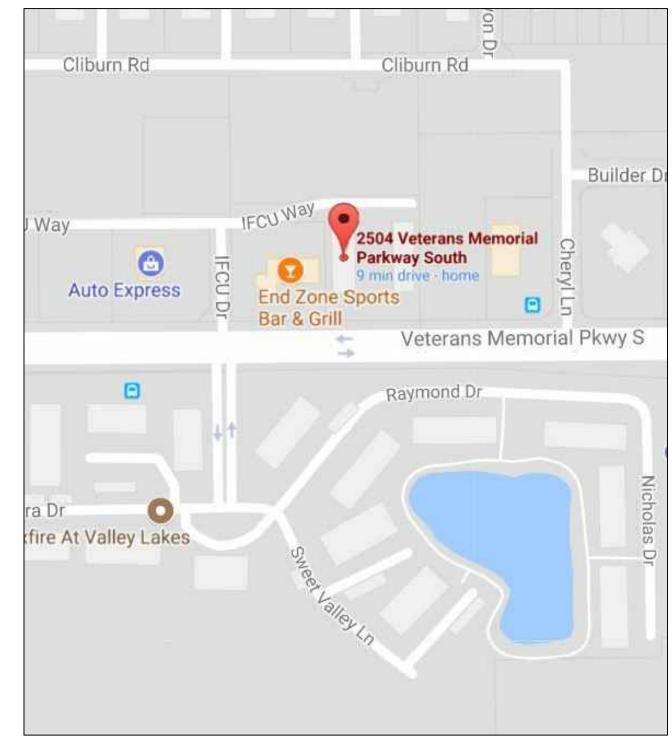









#### THIS PROJECT IS DESIGNED ACCORDING TO

FIRE & BUILDING SAFETY STANDARDS INDIANA BUILDING CODE, 2014 EDITION (IBC, 2012 EDITION, 1ST PRINTING) ANSI A117.1-2009 EFFECTIVE 12/1/14 **INDIANA PLUMBING CODE, 2012 EDITION EFFECTIVE 12/24/12** ELECTRICAL CODE 2009 EDITION (NFPA 70-2008) EFFECTIVE 8/26/09 DIANA FIRE CODE, 2014 EDITION (IFC 2012 EDITION, 1ST PRINTING) EFFECTIVE 12/1/14 DIANA FUEL GAS CODE, 2014 EDITION (IFGC, 2012 EDITION, 2ND PRINTING) EFFECTIVE 12/1/14 675 IAC 28-1-2 NFPA# 10-2010

NORTH


#### ENGINEERING SERVICES BY:


HOFFMAN ENGINEERS P.C. 8261 BASELINE ROAD PARAGON, INDIANA 46166 765-537-2991 ~ *FAX* 765-537-2992 steve@hoffmanengineers.com www.hoffmanengineers.com "GLOBAL COMMITMENT WITH A MAIN STREET ATTITUDE"

#### INDEX OF DRAWINGS

- T1 TITLE SHEET / MAPS / INDEX
- C1 ARCHITECTURAL SITE PLAN
- A1 LIFE SAFETY PLAN & CODE
- A2 ADA STANDARDS
- A3 FLOOR PLAN
- A4 SECTIONS & DETAILS
- P1 PLUMBING PLAN
- M1 MECHANICAL PLAN
- E1 ELECTRICAL POWER PLAN
- E2 ELECTRICAL LIGHTING PLAN

UNITS A9 - A16, SYCAMORE PROFESSIONAL VILLAGE PLANNED DEVELOPMENT SECTION ONE PART OF THE NE 1/4 OF SECTION 9-T22N-R4W, WEA TOWNSHIP, TIPPECANOE COUNTY, INDIANA

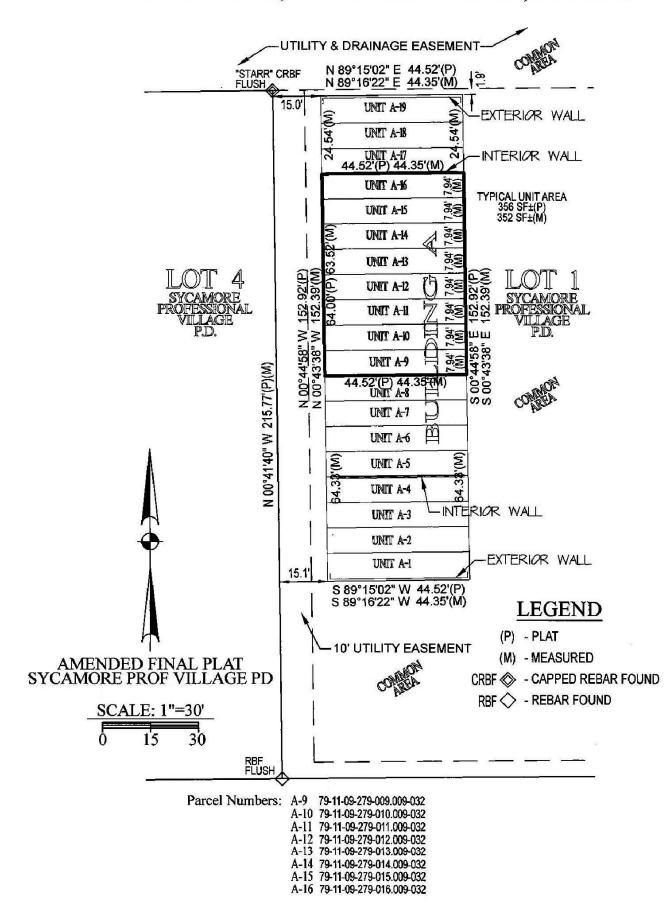


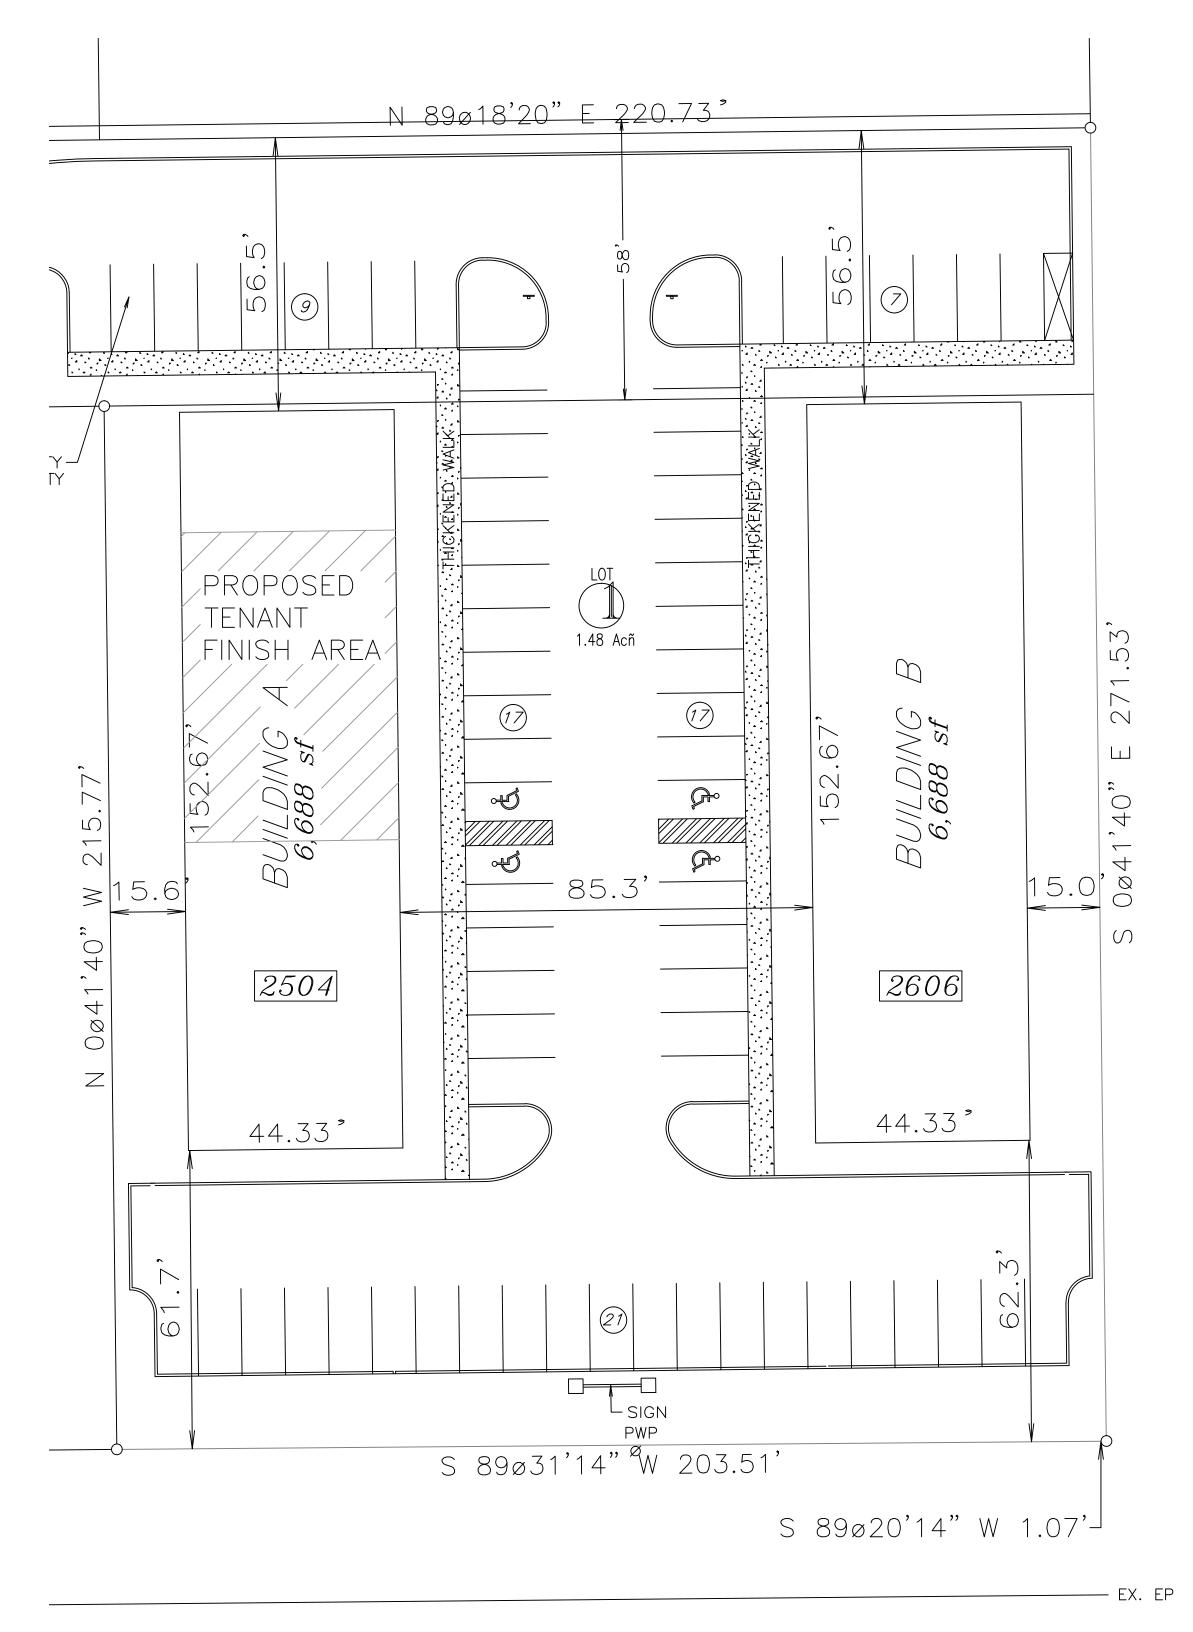


VETERANS MEMORIAL PWKY SOUTH

ARCHITECTURAL SITE PLAN

SCALE: 1"=20'-0"

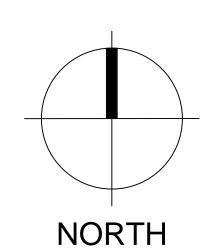

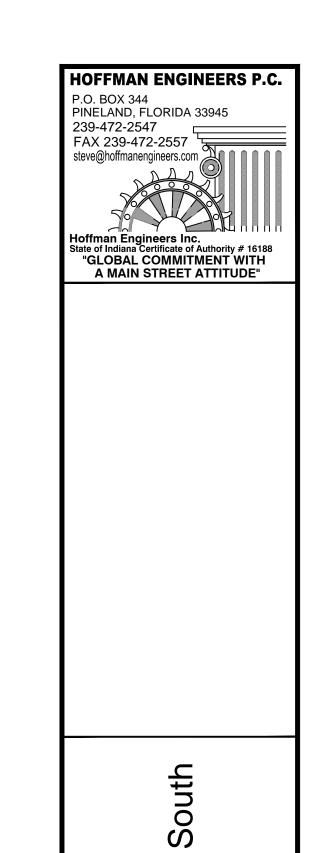

2504 VMP TENANT FINISH 2504 Veterans Memorial Parkway Lafayette, Indiana 47909

CONSTRUCTION DOCUMENT


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| No. 1                                   | PE6001618<br>       | 38   |   |
|   | STATE OF            | MEET   |   |
| 111111111111111111111111111111111111111 | ONAL EN             | Milling.   |   |
|   | M                   |  |   |
|   |                     | 144  |   |
| Stephen C. I                            | Hoffman<br># PE6001 | - Enginee<br>6188  | r |
| =                                       |                     | •  | r |
| IN :                                    | # PE6001            | •  | r |
| IN:                                     | # PE6001            | •  | r |
| IN:                                     | # PE6001            | •  | r |
| IN:                                     | # PE6001            | •  | r |
| IN:                                     | # PE6001            | •  | r |


ARCHITECTURAL SITE PLAN

SHEET TITLE

**C**1

| COD   | <i>E SUMMARY</i>  |
|---|---|
| Applicable Code                                       | 2014 Indiana Building Code (2012 IBC)                                   |
| Scope of Project:                                     | 2,817 Square Foot Tenant Finish   |
| Occupancy Classification                              | В   |
| Construction Type                                     | V B   |
| Allowable Area  | 9,000 SF Based on 'B' Group Occupancy Existing 6,758 SF < 9,000 SF (OK) |
| Existing Total Area                                   | 6,758 SF (Tenant Finish Area 2,817 SF)                                  |
| Fire Walls/ Building<br>Separation                    | None Required   |
| Occupancy Separations                                 | None Required   |
| Building Elements -<br>Fire Resistive<br>Requirements | None Required   |
| Incidental Use<br>Separations                         | Tenant Separation   |
| Corridors   | None Required   |
| Panic Hardware  | Required  |
| Fire Doors  | None Required   |
| Fire Dampers  | None Required   |
| Smoke Dampers   | None Required   |
| Automatic Sprinklers                                  | None Required   |
| Standpipes  | None Required   |
| Fire Alarm System                                     | None Required   |
| Smoke Detectors                                       | None Required   |

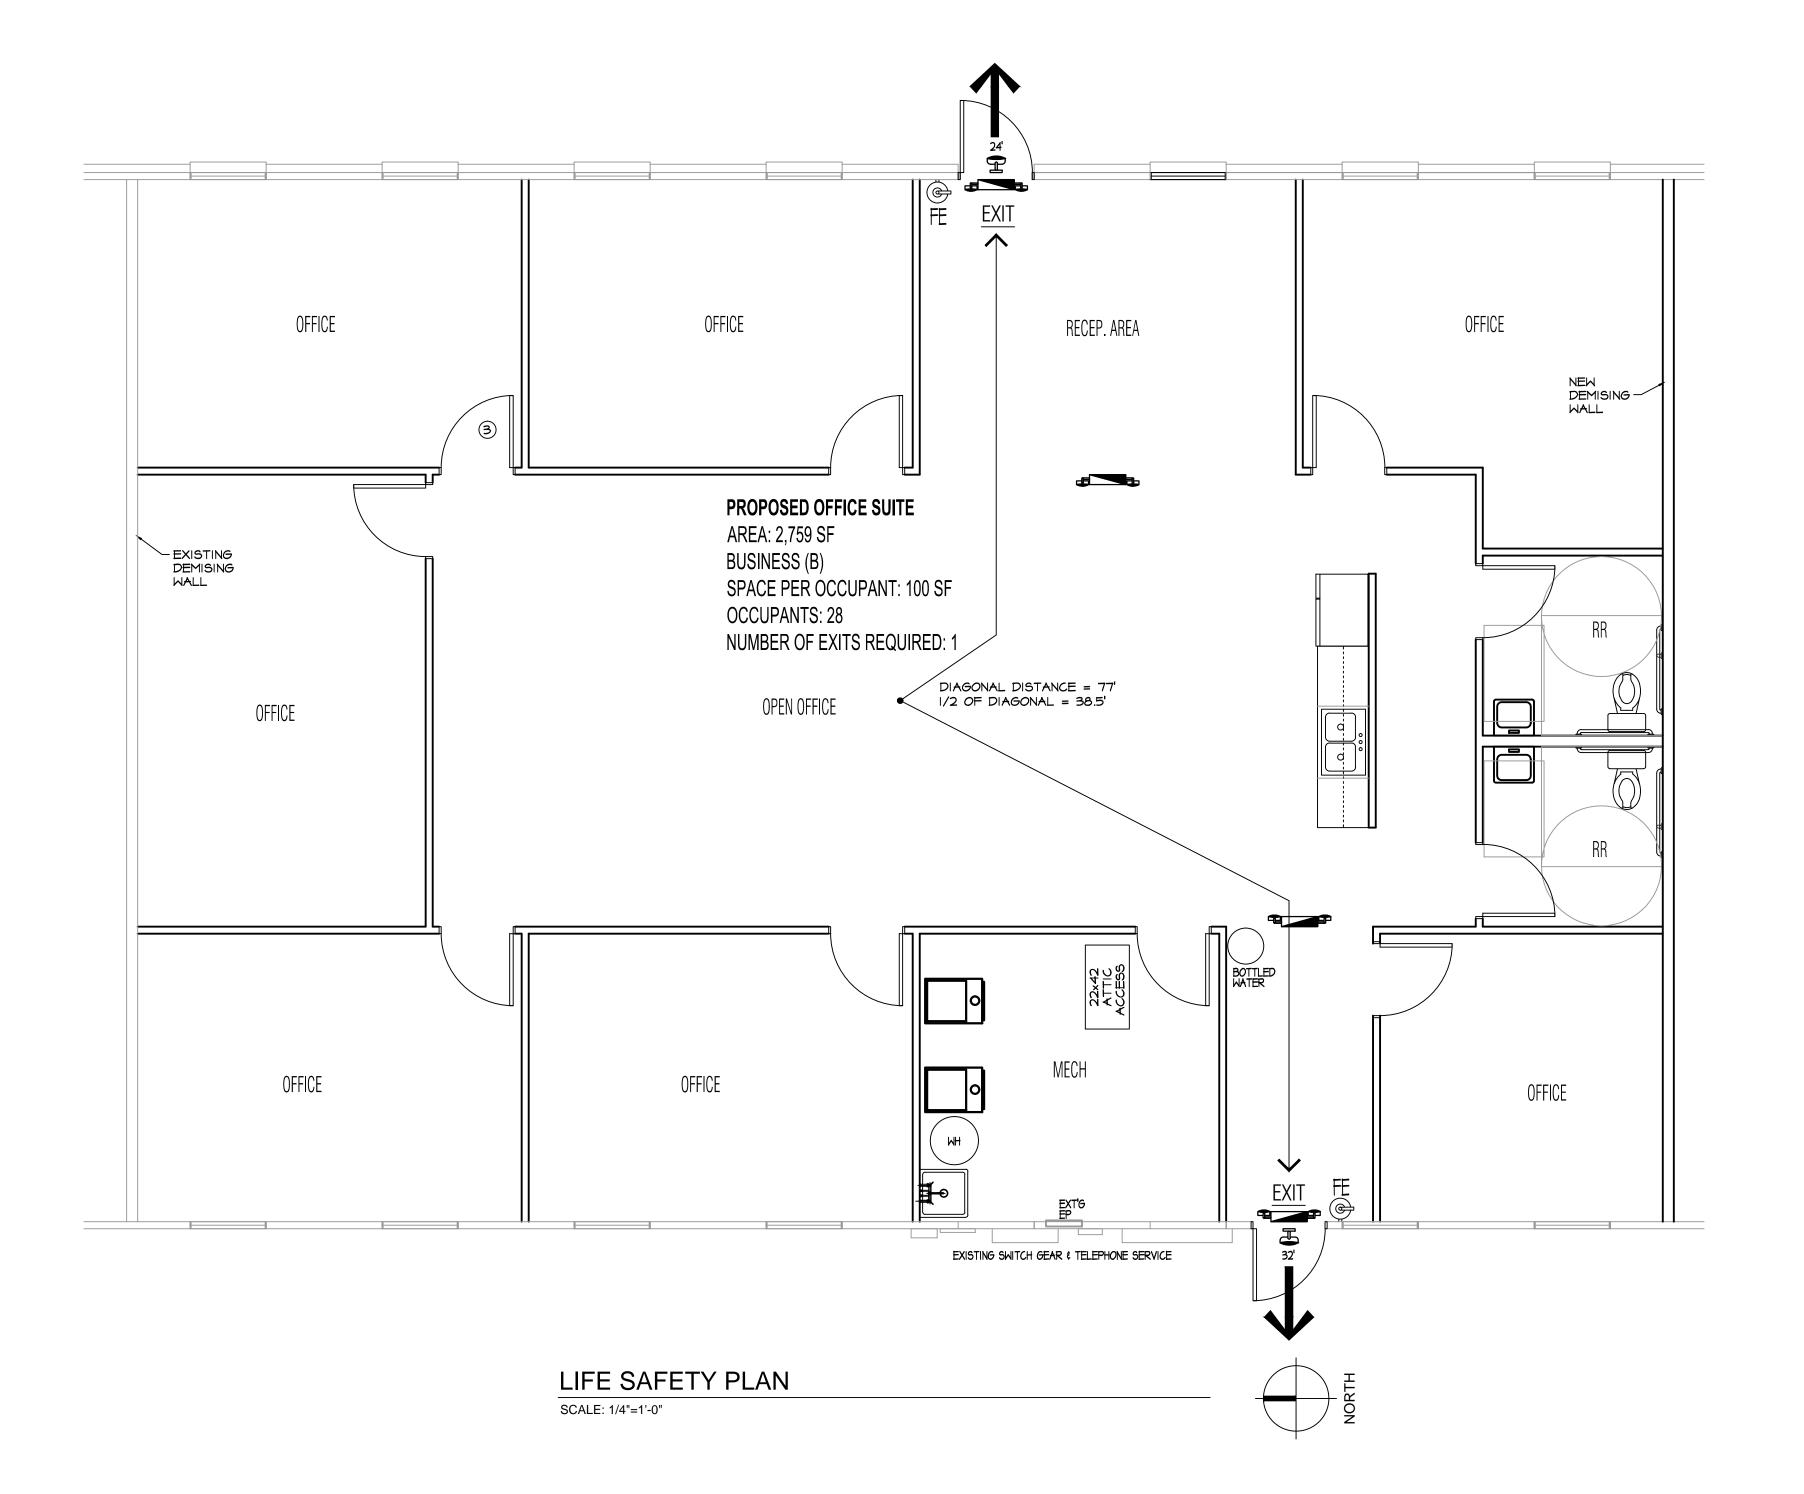

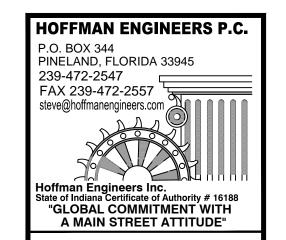

2504 VMP TENANT FINISH 2504 Veterans Memorial Parkway Sout Lafayette, Indiana 47909

## CONSTRUCTION DOCUMENT

|                | SSIONAL SEAL   |
|----------------|--|
| nninnin<br>HE  | N C. HOF 111   |
| THE STATE OF   | N C. HOMINION 09/05/2017<br>N C. HOMINION 09/05/2017<br>GISTERED 19/09/09/2017 |
| PROFILES No. 1 | PE60016188   |
| PROT           | STATE OF WOLAND ONAL ENGINEERING   |
| 11111551       | WOIANA CENTIFIED   |
| . 0            | winnin.  |
|                | Hoffman - Engineer   |
| IN :           | # PE60016188   |
| DRAWN BY       | JAC  |
| REVISIONS      |  |

DRAWN BY
REVISIONS

SHEET TITLE

LIFE SAFETY

PLAN

ROJECT NO:

WARNING

DETECTABLE

DO NOT USE TRUNCATED DOMES FOR DETECTABLE WARNING.
USE "V" OR "U" SHAPED TACTILE SURFACE

WARNING SIGNALS AT

CURB RAMPS


SCALE: N.T.S.

SCALE: N.T.S.

(1) SLOPE = Y / X WHERE X IS A LEVEL PLANE NOT TO EXCEED 1:12
(2) COUNTERSLOPE SHALL NOT EXCEED 1:20

# - 1/4 MAX

VERTICAL CHANGES IN LEVEL

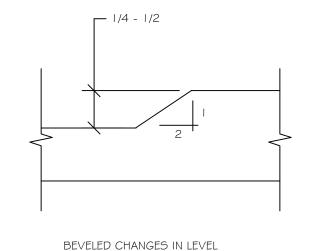

#### ACCESSIBLE ROUTES AND GROUND AND FLOOR SURFACES


#### PLUMBING NOTES:

Hot water and drain pipes under lavatories shall be insulated or otherwise configured to protect against contact. There shall be no sharp or abrasive surfaces under lavatories.

#### OTHER NOTES:

## Sinks shall be mounted with the counter or rim no higher than 34 inches above fin. floor. Each sink will have a mirror above the sink that complies with this standards. Knee clearance that is at least 27 in. high, 30 in. wide, and 19 in. deep shall be provided under sinks. Each sink shall be a max. of 6 1/2 in. deep. A clear floor space at least 30 in. by 48 in. shall be provided in front of sink to allow forward approach. The clear floor space shall be on an accessible route and shall extend a max. of 19 in. underneath the sink. -Items like such, but limited to coat hooks, dispensers, shelves, and toilet partitions to comply.

## MEASUREMENT OF CURB RAMP SLOPES

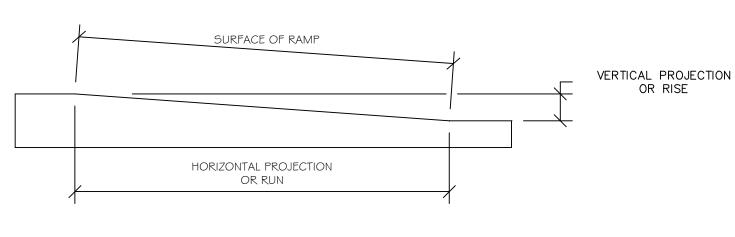

|                                      | MAXIMUM RISE   |                   | MAXIMUM HOI<br>PROJECTIC |               |  |
|--------------------------------------|----------------|-------------------|--------------------------|---------------|--|
| SLOPE                                | IN.            | MM                | FT.                      | М             |  |
| 1:12 TO 1:15<br>1:16 TO 1:19<br>1:20 | 30<br>30<br>30 | 760<br>760<br>760 | 30<br>40<br>50           | 9<br>12<br>15 |  |

ALLOWABLE RAMP DIMENSIONS FOR CONSTRUCTION IN EXISTING SITES, BUILDINGS, AND FACILITIES

|  | MAXIMUM RISE |     | MAXIMUM HORIZONTAL<br>PROJECTION |     |
|--|--------------|-----|----------------------------------|-----|
| SLOPE*   | IN.          | MM  | FT.                              | М   |
| STEEPER THAN 1:10<br>BUT NO STEEPER<br>THAN 1:8  | 3            | 75  | 2                                | 0.6 |
| STEEPER THAN 1:12<br>BUT NO STEEPER<br>THAN 1:10 | 6            | 150 | 3                                | 1.5 |

\* A SLOPE STEEPER THAN 1:8 NOT ALLOWED


#### NOTES:


G.C. IS TO VERIFY THAT ALL HANDICAP FIXTURES, HARDWARE, RAMPS & STAIRWAYS MEET THE MINIMUMS & MAXIMUMS SHOWN ON THIS SHEET.

SCALE: N.T.S.

 $\begin{tabular}{l} \underline{Note:}\\ I.\ These\ details\ are\ not\ all\ inclusive.\ See\ plumbing\ sheets\ for\ additional\ information.\end{tabular}$ 2. Handicapped sign age for the bathrooms is located on the wall adjacent to the latch side of the door . Sign must be located 60" from center


3. Water closet flush handles are to be on the wide side of the room or stall.

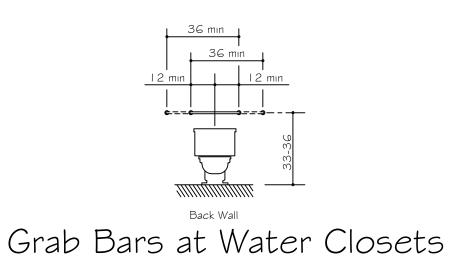

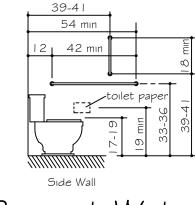

Grab Bars at Water Closets


#### **Standards**

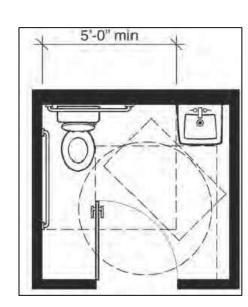

**Plan-2B: Standards Minimum** with In-Swinging Door

#### 7'-0" x 6'-6" 45.50 Square Feet


This plan shows a typical example of a single-user toilet room that meets the minimum requirements of the 2010 Standards when the entry door swings into the room. In the 2010 Standards an exception allows the entry door to swing over the clear floor spaces and clearances required at the fixtures if a clear floor space complying with section 305.3 (minimum 30 inches by 48 inches) is provided outside the arc of the door swing, section 603.2.3 exception 2. The required maneuvering space for the door, section 404.2.4.1 and Figure 404.2.4.1(a), also is a factor in room size. This clear space cannot be obstructed by the plumbing fixtures.

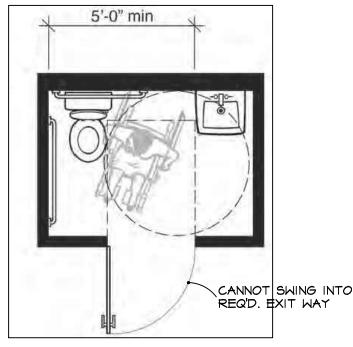


Plan-1B: Standards Minimum with **Out-Swinging Door** 

#### 7'-0" x 5'-0" 35.00 Square Feet


This plan shows a typical example of a single-user toilet room that meets the minimum requirements of the 2010 Standards. Features include: five-foot minimum width between the side wall of the water closet and the lavatory; 60-inch minimum circular wheelchair turning space; and 36-inch by 48-inch clear maneuvering space for the out-swinging entry door. Section 604.3.1 of the 2010 Standards requires a floor clearance at a water closet that is a minimum of 60 inches wide by 56 inches deep regardless of approach. Section 604.3.2 prohibits any other plumbing fixtures from being located in this clear space, except in residential dwelling units. The 2010 Standards, at section 304.3, allows the turning space to extend into toe and knee space provided beneath fixtures and other elements. Required maneuvering space for the entry door (inside the room) must be clear of all fixtures. If the door had both a closer and latch, section 404.2.4.1 and Figure 404.2.4.1(c) require additional space on the latch side.

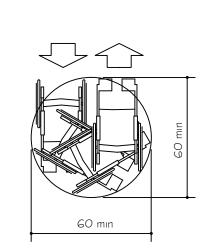


Wheelchair Turning Space

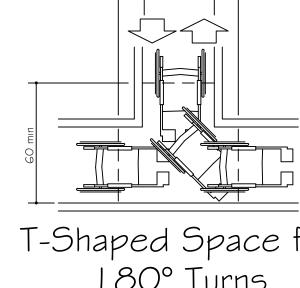


T-Shaped Space for 180° Turns

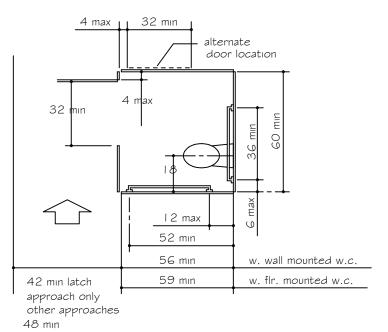


Standard Stall

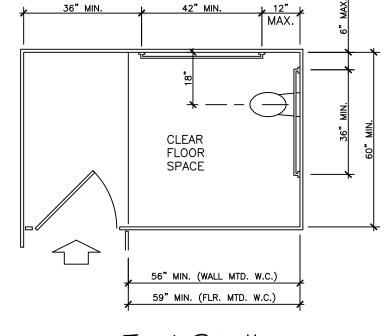


End Stall

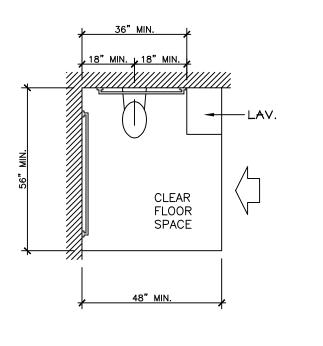

W.C. Clearance

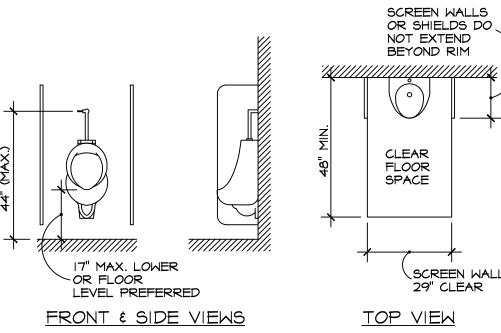

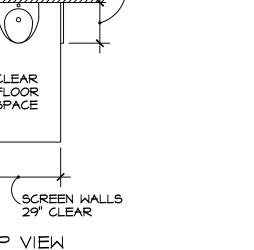


Urinal Detail



48 min


36" by 36" Stall Shower Size and Clearances

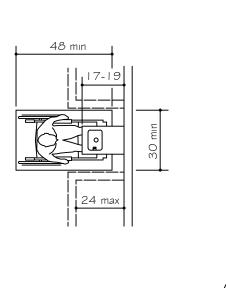






36" by 36" Stall



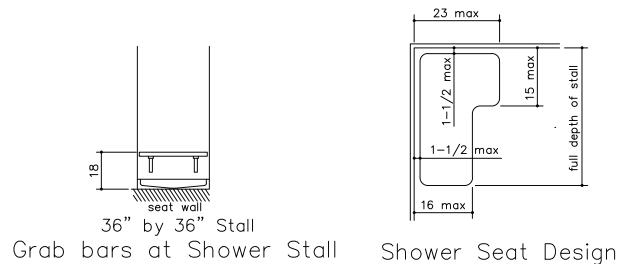

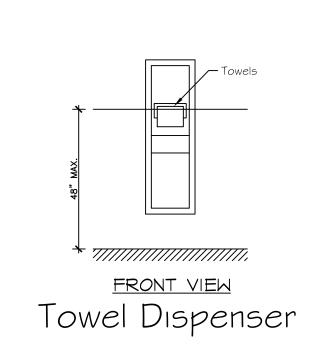

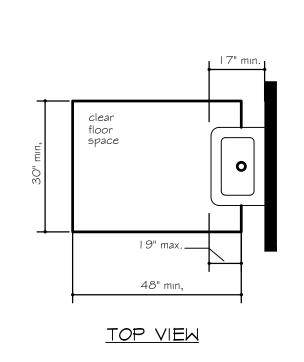

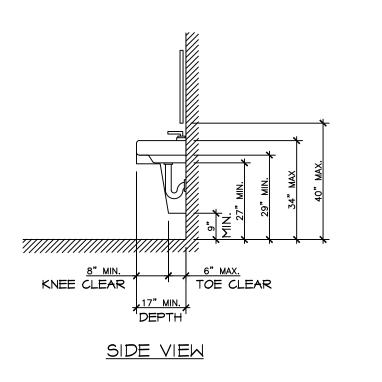


Clear Floor Space @ Lavatories

**HOFFMAN ENGINEERS P.C.** P.O. BOX 344 PINELAND, FLORIDA 33945 239-472-2547 FAX 239-472-2557 steve@hoffmanengineers.com 💥 🛭 🗎 🗎 🖺 ate of Indiana Certificate of Authority # 16188
"GLOBAL COMMITMENT WITH A MAIN STREET ATTITUDE"

> arkway 47909 FINIS TENANT lemorial F , Indiana 2504 Vetera Lafa 2504

 W

#### CONSTRUCTION **DOCUMENT**

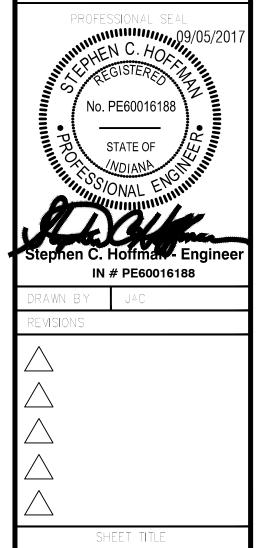

**ADA STANDARDS** 

|      | DOOR SCHEDULE      |  |  |         |  |  |  |
|------|--------------------|--|--|---------|--|--|--|
|      |                    | DOOR   | LATCH TYPE                             | REMARKS |  |  |  |
| MARK | SIZE               | DESCRIPTION TYPE                                       | LAICHTIPE                              | KEWAKKS |  |  |  |
| 1    | 3/4"x3'-0"x6'-8"   | EXTERIOR INSULATED STEEL WITH HALF GLASS DIVIDED LITES | PANIC W EXTERIOR PULLS & LOCK CYLINDER |         |  |  |  |
| 2    | 1 3/4"x3'-0"x6'-8" | EXTERIOR INSULATED FLUSH STEEL                         | PANIC W EXTERIOR PULL & LOCK CYLINDER  |         |  |  |  |
| 3    | 3/4"x3'-0"x6'-8"   | INTERIOR FLUSH SOLID CORE                              | OFFICE                                 |         |  |  |  |
| 4    | 1 3/4"x3'-0"x6'-8" | INTERIOR FLUSH SOLID CORE                              | OFFICE                                 |         |  |  |  |
| 5    | 1 3/4"x3'-0"x6'-8" | INTERIOR FLUSH SOLID CORE                              | OFFICE                                 |         |  |  |  |
| 6    | 1 3/4"x3'-0"x6'-8" | INTERIOR FLUSH SOLID CORE                              | PRIVACY                                |         |  |  |  |
| 7    | 3/4"x3'-0"x6'-8"   | INTERIOR FLUSH SOLID CORE                              | PRIVACY                                |         |  |  |  |
| 8    | 1 3/4"x3'-0"x6'-8" | INTERIOR FLUSH SOLID CORE                              | OFFICE                                 |         |  |  |  |
| 9    | 1 3/4"x3'-0"x6'-8" | INTERIOR FLUSH SOLID CORE                              | STOREROOM                              |         |  |  |  |
| 10   | 1 3/4"x3'-0"x6'-8" | INTERIOR FLUSH SOLID CORE                              | OFFICE                                 |         |  |  |  |
| II   | 1 3/4"x3'-0"x6'-8" | INTERIOR FLUSH SOLID CORE                              | OFFICE                                 |         |  |  |  |
| 12   | 1 3/4"x3'-0"x6'-8" | INTERIOR FLUSH SOLID CORE                              | OFFICE                                 |         |  |  |  |

#### DOOR/FRAME SCHEDULE GENERAL NOTES:

- A. ALL DOORS TO HAVE I 1/2 PAIR OF HINGES.
- B. ALL EXTERIOR DOORS TO HAVE NON REMOVABLE PIN HINGES AND LATCH GUARDS, ALONG WITH DOOR CLOSURES, STOP, WEATHER STRIPPING & HANDICAP THRESHOLDS.
- C. ALL DOORS SHALL BE SWING TYPE UNLESS OTHERWISE SPECIFIED.
- D. VERIFY DOOR SIZES WITH FIELD CONDITIONS, ADJUST AS REQUIRED.
- E. ALL KEYED LOCKS TO BE "MASTER KEYED" TO OWNER'S SYSTEM, VERIFY KEYING WITH OWNER PRIOR TO ORDERING.

#### ROOM FINISH SCHEDULE

OFFICE
WALLS:

MECHANICAL
WALLS:

PAINTED DRYWALL

FLOORS:

FLOORS:

CARPET STAINED & SEALED CONCRETE

BASE:
VINYL COVE
VINYL COVE
CEILING:
CEILING:
PAINTED DRYWALL

RESTROOMS
WALLS:
CERAMIC TILE / PAINTED DRYWALL
FLOORS:
VCT
BASE:

RECEP. AREA
WALLS:
PAINTED DRYWALL
FLOORS:
CERAMIC TILE / CARPET
BASE:

BASE:

VINYL COVE

VINYL COVE


CEILING:


PAINTED DRYWALL

PAINTED DRYWALL

#### GENERAL FLOOR PLAN NOTES:


- DO NOT SCALE DRAWINGS, USE ONLY WRITTEN DIMENSIONS.
- 2. ENGINEER MUST BE NOTIFIED OF ANY
  DISCREPANCIES IN DIMENSIONS, CODE
  REQUIREMENTS (BOTH STATE AND LOCAL), AND
  OTHER CONDITIONS INDICATED BY THESE
  DOCUMENTS PRIOR TO PROCEEDING WITH THE
  PROJECT.
- 3. THE CONTRACTOR SHALL VERIFY ALL MECHANICAL AND ELECTRICAL REQUIREMENTS AND CLEARANCES PRIOR TO PROCEEDING WITH THE PROJECT AND SHALL NOTIFY THE CONSTRUCTION MANAGER OF ANY DISCREPANCIES.
- 4. IF CONDITIONS AT THE JOB SITE ARE DIFFERENT THAN THOSE ILLUSTRATED IN THE CONTRACT DOCUMENTS, NOTIFY THE ENGINEER IMMEDIATELY.
- 5. ALL DIMENSIONS ARE TAKEN FROM FACE OF STUD TO FACE OF STUD OR OUT TO OUT OF MASONRY AND CONCRETE UNLESS OTHERWISE NOTED. DIMENSIONS WITH + TO BE FIELD VERIFIED BY CONTRACTOR.
- 6. CONTRACTOR SHALL PROVIDE SOLID BLOCKING FOR GRAB BARS, CABINETRY, BATH ACCESSORIES, HANDRAILS, ETC. AND ROUGH OPENINGS AS REQUIRED.
- 7. INTERIOR WALLS AND PARTITIONS ARE 2 X 4 STUD (3 1/2"), 16" O.C. UNLESS OTHERWISE NOTED.
- 8. ALL WOOD IN CONTACT WITH CONCRETE OR MASONRY SHALL BE PRESSURE TREATED MATERIAL.

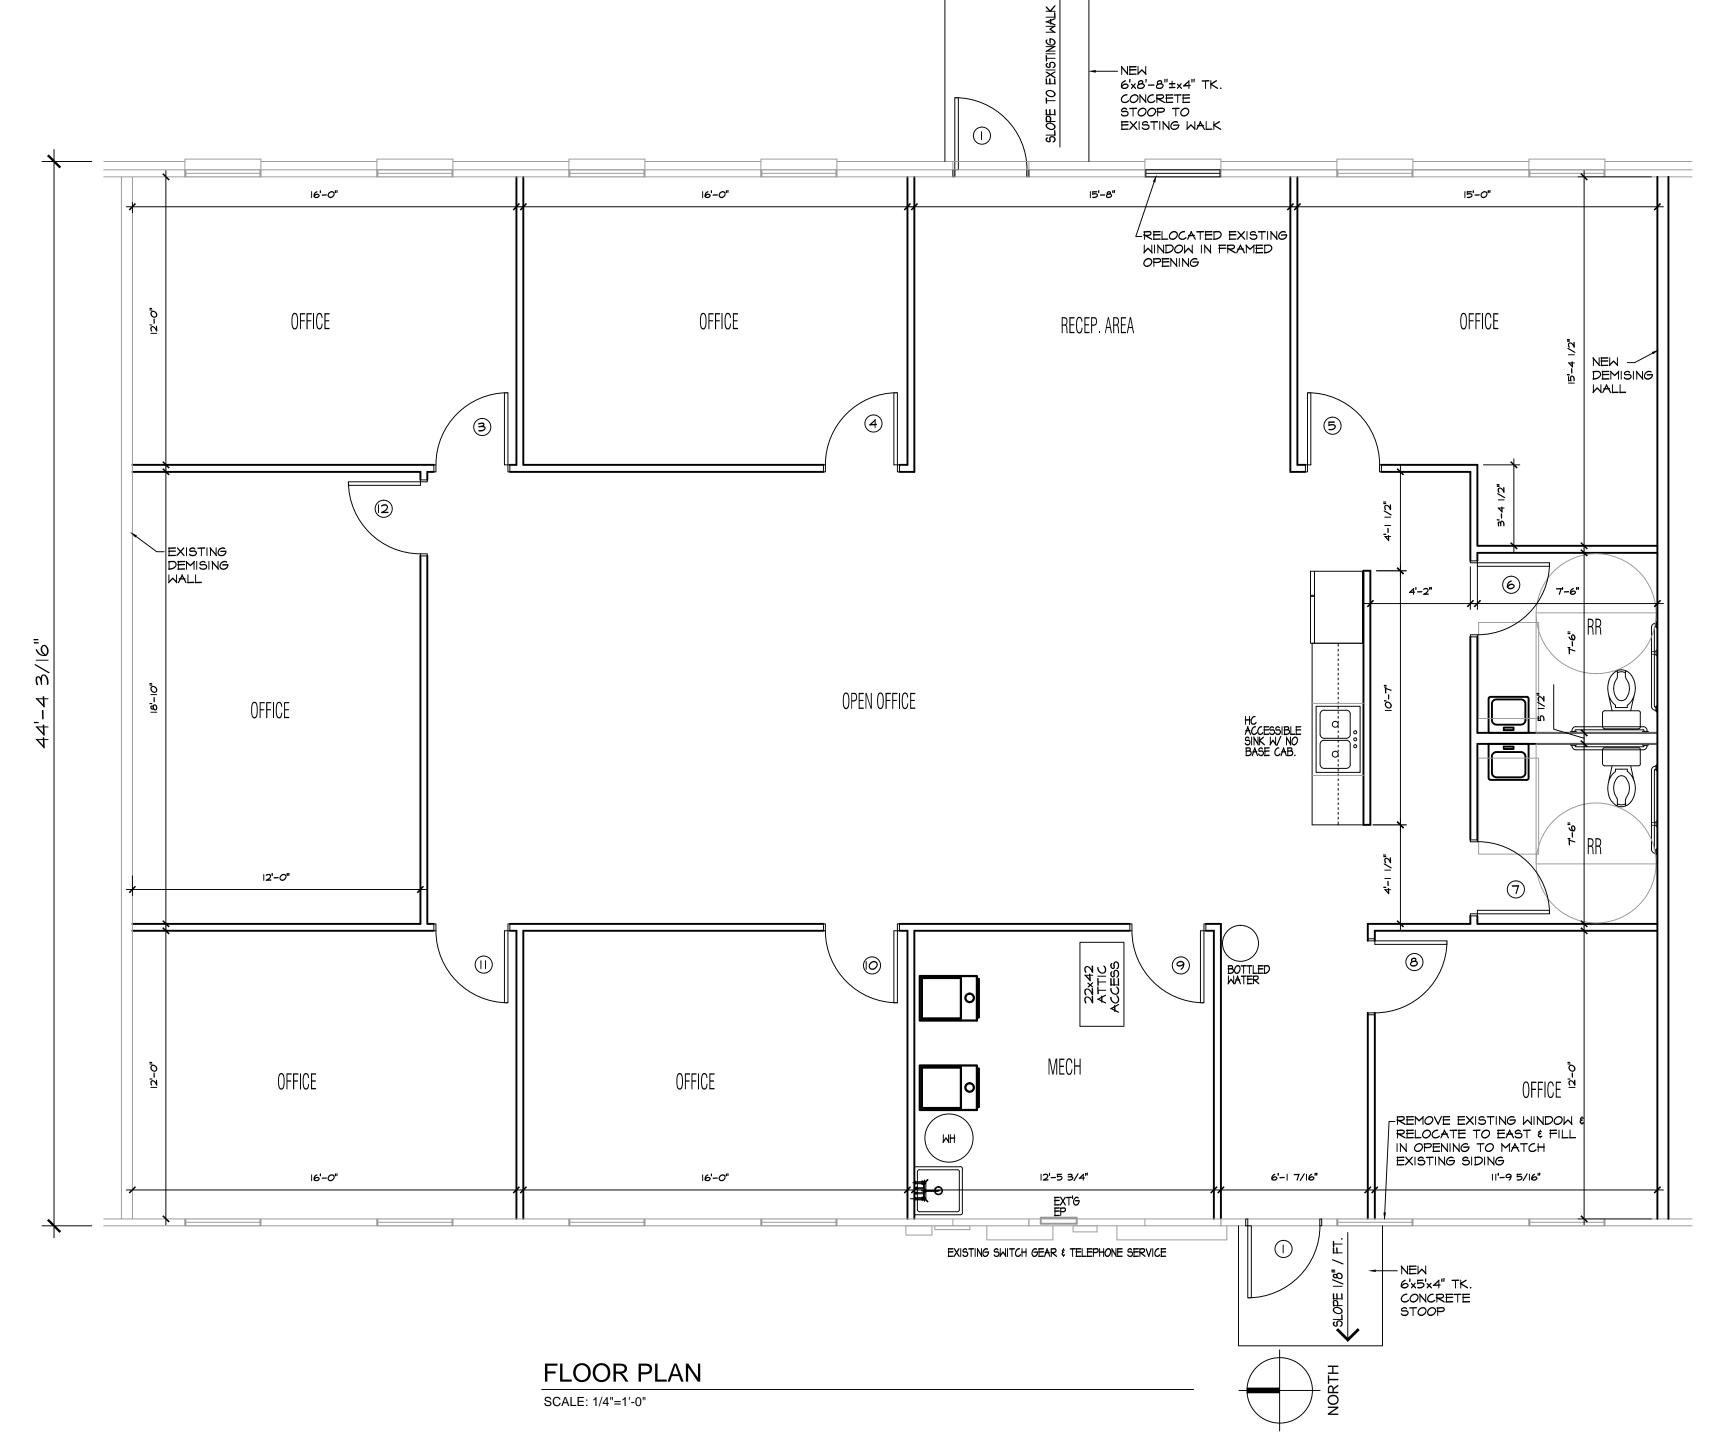


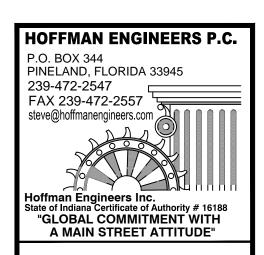

2504 VMP TENANT FINISH 2504 Veterans Memorial Parkway So Lafayette, Indiana 47909

## CONSTRUCTION DOCUMENT

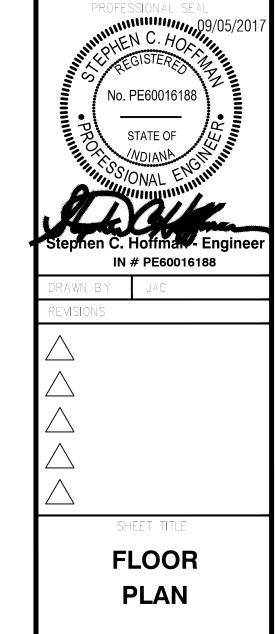


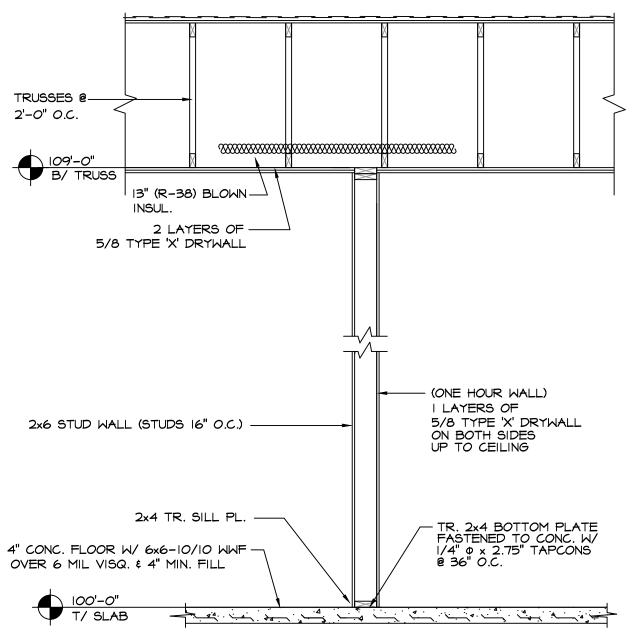

PROVIDE ONE PART ELASTOMERIC SEALANT FORMULATED FOR USE IN A THROUGH-PENETRATION FIRE STOP SYSTEM FILLING OPENINGS AROUND PENETRATIONS THROUGH WALLS AND FLOORS, HAVING FIRE RESISTANCE RATING INDICATED AS ESTABLISHED BY TESTING IDENTICAL ASSEMBLIES PER ASTM 814 BY UNDERWRITERS LABORATORIES OR OTHER TESTING AND INSPECTING AGENCY ACCEPTABLE TO AUTHORITIES HAVING JURISDICTION. SUBJECT TO COMPLIANCE WITH REQUIREMENTS, PRODUCTS THAT MAY BE INCORPORATED IN THE WORK INCLUDE, BUT ARE NOT LIMITED TO THE FOLLOWING: I)"DOW CORNING FIRE STOP SEALANT", DOW CORNING CORP.; 2)"3M FIRE BARRIER CAULK CP-2 ELECTRICAL PRODUCTS DIV./3M; 3)"RTV 7403", GENERAL ELECTRIC CO.; AND 4)"FYRE PUTTY", STANDARD OIL MATERIALS CO.

#### TYPICAL DEMISING WALL

SCALE: 1/2"=1'-0"

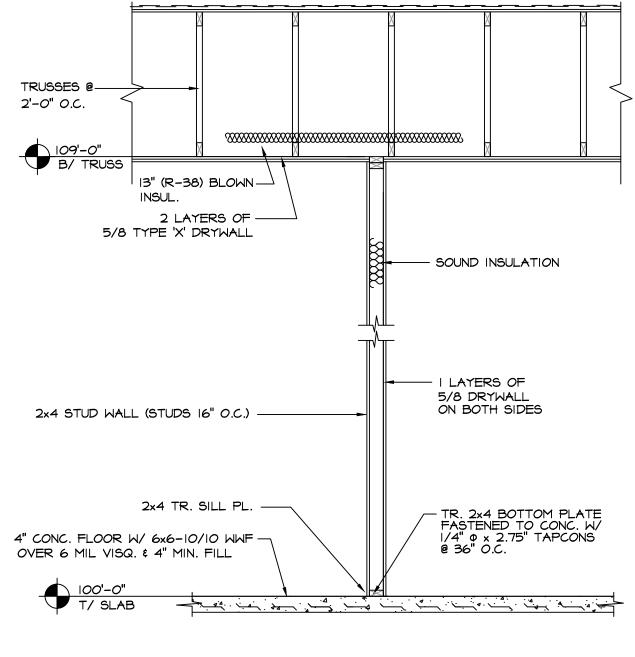


SCALE: 1/2"=1'-0"


TYPICAL INTERIOR STUD WALL

NOTE: DO NOT ATTACH STUD WALL DIRECTLY TO TRUSSES OR CEILING PURLINS. USE FASTENER & SET 1/4" BELOW. —DTC TRUSS FASTENER W/ (4) IOd's IN TOP PLATE € (2) ION's IN TRUSS BOTTOM CHORD OF TRUSS ----DOUBLE TOP PLATE - STUD WALL

TYPICAL INTERIOR STUD WALL DETAIL NOT TO SCALE

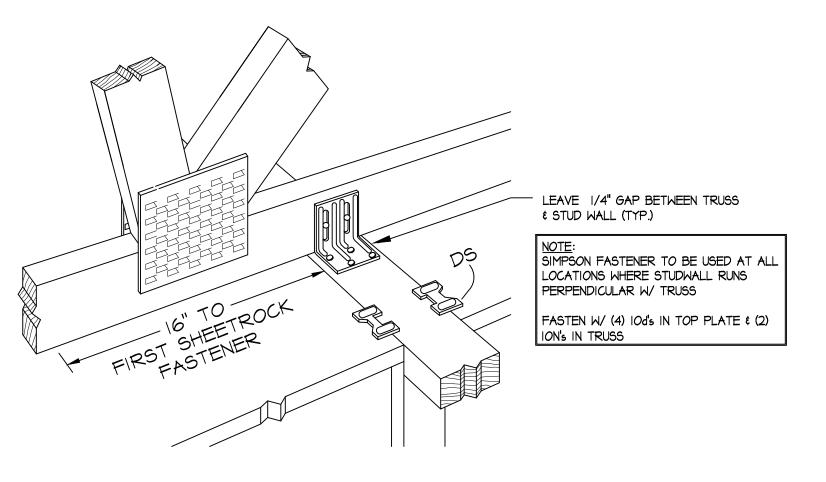


#### DTC PLATE-TO-TRUSS FASTENER NOT TO SCALE

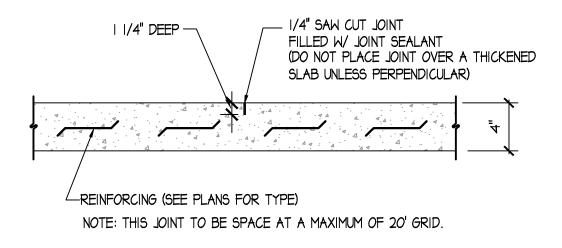


TYPICAL CONTROL JOINT

NOT TO SCALE

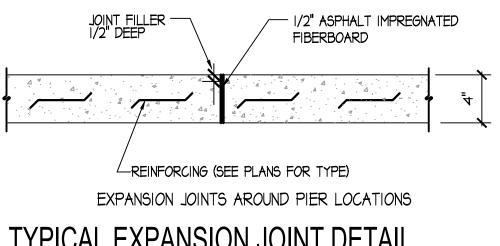


TYPICAL EXPANSION JOINT DETAIL

NOT TO SCALE

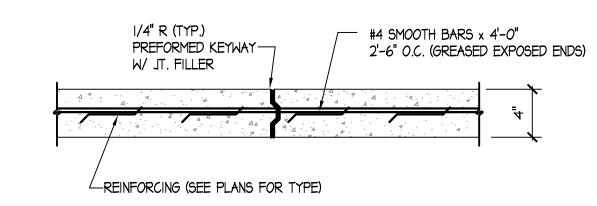

#### TYPICAL CONSTRUCTION JOINT

NOT TO SCALE

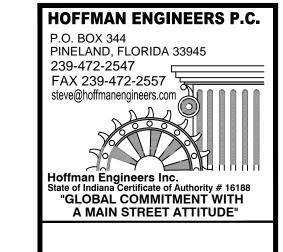

FINISH Parkway (47909 2504 etera Lafa 50,

#### CONSTRUCTION **DOCUMENT**

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|-------------|------------|---|---|------|
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|             | ROKES I    | STATE OF<br>NDIANA<br>ONAL E                    | 88 NATIONAL REPORTS                       | •    |
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| DR <i>A</i> |            | JAC   | 10100                                     |      |

**SECTIONS & DETAILS** 

SHEET TITLE

#### PLUMBING FIXTURE PIPING SCHEDULE

| ITEM | FIXTURE                  | WASTE | VENT   | C.X. | Ξ.   | FIXTURE MOUNTING HEIGHTS |
|------|--------------------------|-------|--------|------|------|--------------------------|
| P-I  | Handicapped Water Closet | 3"    | 2"     | 1/2" |      | Floor Mounted            |
| P-2  | Wall Hung Lavatory       | /4"   | /4"    | 1/2" | 1/2" | Wall Mounted 34" Max.    |
| P-3  | Stainless Steel Sink     | /2"   | 1 1/2" | 1/2" | 1/2" | Counter Mounted          |
| P-4  | Mop Sink                 | 3"    | 2"     | 3/4" | 3/4" | Floor Mounted            |

#### . . . . . . . . . .

- I. ALL BRANCH SIZES SHOWN IN THE ABOVE SCHEDULE ARE INDIVIDUAL BRANCH SIZES TO VALVES, FAUCETS, BUBBLERS, ECT..
- 2. WATER CLOSETS TO BE OF TANK TYPE CONSTRUCTION.
- 3. ALL FIXTURES SHALL HAVE A CHROME-PLATED SHUT OFF VALVE ACCESSIBLE AT THE FIXTURES.
- 4. HANDICAPPED WATER CLOSETS SHALL HAVE THE FLUSH TRIP LEVER LOCATED ON THE

#### FLOOR DRAIN SCHEDULE

| TYPE | JAY R. SMITH |          | WADE        |          | ZURN        |          | SEE  |
|------|--------------|----------|-------------|----------|-------------|----------|------|
|      | FLOOR DRAIN  | TRAP     | FLOOR DRAIN | TRAP     | FLOOR DRAIN | TRAP     | NOTE |
| FD   | 2040-A       | Integral | 1120-CO-A   | Integral | ZI-22       | Integral | 1,2  |

#### NOTES:

- ALL FLOOR DRAINS SHALL BE FULL SIZE OF THE CONNECTING WASTE LINE SHOWN ON THE DRAWINGS, UNLESS OTHERWISE NOTED.
- 2. ALL FLOOR DRAINS SHALL HAVE NICKEL BRONZE RIMS AND STRAINERS. THE STRAINERS SHALL HAVE A 5" MINIMUM DIAMETER OR TWICE THAT OF THAT OF THE CONNECTING WASTE LINE, UNLESS OTHERWISE NOTED. ALL FLOOR DRAINS TO HAVE TRAP SEALS.

#### GENERAL PLUMBING NOTES:

- . ALL WASTE AND VENT PIPING SHALL BE SCHEDULE 40 PVC PER CHAPTERS 7, 8 & 9 OF THE I.P.C. WITH INDIANA AMENDMENTS TO INCLUDED CHAPTER 14.
- 2. ALL FITTINGS USED FOR THE DRAIN, WASTE AND VENT SYSTEMS MUST BE IN ACCORDANCE WITH CHAPTERS 7, 8 & 9 OF THE I.P.C. WITH INDIANA AMENDMENTS TO INCLUDED CHAPTER 14.
- 3. VENTS BELOW THE FLOOR & BELOW THE FLOOD LEVEL OF THE FIXTURE ARE NOT PERMITTED. THE MAXIMUM DISTANCE FROM FLOOR DRAIN TO VENT IS 5'-0" AND MAXIMUM DISTANCE FROM WATER CLOSET TO VENT IS 6'-0".
- 4. VENTS SHALL TERMINATE A MINIMUM DISTANCE ABOVE THE ROOF AS PER SECTION 906 I
- 5. ALL HORIZONTAL WASTE AND DRAIN PIPING OF 3" IN DIAMETER OR LESS MUST BE INSTALLED WITH A GRADE OF AT LEAST 1/4" PER FOOT AND PIPING LARGER THAN 3" IN DIAMETER MUST BE INSTALLED WITH A GRADE OF AT LEAST 1/8" PER FOOT.
- 6. ALL UNDERGROUND WATER SUPPLY PIPING TO BE TYPE "K" BELOW CONCRETE SLAB. ALL HOT AND COLD WATER PIPING SHALL BE TYPE "L" HARD COPPER WITH COPPER OR WROUGHT BRASS FITTINGS OR CPVC PER CHAPTER 6 OF THE I.P.C. WITH INDIANA AMENDMENTS TO INCLUDE CHAPTER 14. PEX IS ALLOWED. ALL RUNS MUST BE LOOPED TO REDUCE THE NUMBER OF TEES AND ELBOWS TO A MINIMUM. SUPPORTS AT 2'-8" O.C. HORIZONTAL AND AT EACH FLOOR AND AT MID FLOOR.
- 7. ALL FIXTURES AND PIPING SHALL MEET NSF/ANSI 61-G, NSF/ANSI 372-2011 AND FEDERAL LEAD PLUMBING LAW (U.S. SENATE BILL NO S. 3874) AS IT APPLIES TO LEAD CONTENT OF FIXTURES, PIPING, SOLDER AND FLUXES (.25% LEAD WITH RESPECT TO WETTED SURFACES AND .20% LEAD IN SOLDER AND FLUXES). EFFECTIVE 4 JAN. 2014 PER SECTION 316.1.3.
- 8. ALL HOT AND COLD WATER PIPING SHALL BE COVERED WITH 1/2" ARMAFLEX PIPE
- 9. BACKFLOW PREVENTERS MUST BE IN ACCORDANCE WITH STANDARDS REFERENCED IN SECTIONS 204, 603, € 1002.
- IO. PLUMBING CONTRACTOR SHALL PROVIDE SHUT-OFF VALVES AT EACH FIXTURE.
- II. PLUMBING CONTRACTOR SHALL COORDINATE WITH CARPENTER FOR LOCATIONS OF PLUMBING FIXTURES & PIPING.
- 12. PLUMBING CONTRACTOR SHALL PROVIDE THEIR OWN EXCAVATION, BACK FILL & COMPACTION TESTING (WITH REPORT).
- 13. ALL PLUMBING NOT SPECIFICALLY REFERENCED ABOVE SHALL BE ACCORDING TO 1.P.C. WITH AMENDMENTS.
- 14. ALL FIXTURES SHALL HAVE A CHROME-PLATED KEY OPERATED VALVE ACCESSIBLE AT THE FIXTURES.
- 15. HANDICAPPED WATER CLOSETS SHALL HAVE THE FLUSH TRIP LEVER LOCATED ON THE WIDE SIDE OF THE ROOM.
- 16. ALL NEW PENETRATIONS THROUGH FLOOR, CEILING OR ROOF WILL HAVE THE ANNULAR AREA BETWEEN THE ITEM AND THE OPENING SEALED AROUND THE OPENING TO PREVENT THE PASSAGE OF FIRE AND SMOKE.

#### PLUMBING FIXTURE SCHEDULE


ITEM P-I, HANDICAPPED WATER CLOSET: SHALL BE EQUAL TO AMERICAN STANDARD (CADET #2998.012) OR EQUAL, VITREOUS CHINA, FREE STANDING CLOSE COUPLED TOILET COMBINATION, SIPHON JET ACTION, ELONGATED BOWL, TANK WITH COVER, 2 BOLT CAPS WITH RETAINER CLIP WITH BENEKE # 523, OPEN FRONT WHITE SEAT WITH SELF-SUSTAINING /CHECK TYPE HINGES. NOTE: TRIP LEVER TO BE ON WIDE SIDE OF


ITEM P-2, WALL HUNG LAVATORY: SHALL BE EQUAL TO AMERICAN STANDARD (LUCERNE #0355.012) OR EQUAL, WALL HUNG, VITREOUS CHINA LAVATORY, HAVING DELTA FAUCET #520 HDF COMBINATION SUPPLY AND POP-UP DRAIN FITTING WITH AERATOR, CHICAGO FAUCET # 1019 SUPPLY PIPES WITH WHEEL HANDLE STOPS TO WALL AND FLEXIBLE TUBE RISERS, I 1/4" X I 1/4" CAST BRASS "P" TRAP WITH CLEANOUT AND TRUEBRO #102 TRAP AND STOP COVER W/ J.R. SMITH CHAIR CARRIER, AND ALL PARTS NECESSARY FOR PROPER INSTALLATION. PROVIDED WITH AN AUTOMATIC SAFETY WATER MIXING DEVICE WITH A MAXIMUM SETTING OF 110 DEGREE WATER TEMPERATURE.


ITEM P-3, STAINLESS STEEL SINK: SHALL BE EQUAL TO ELKAY (LUSTERTONE #LRAD3322), I8 GAUGE TYPE 304 SELF-RIMMING STAINLESS STEEL SINK COMPLETE WITH DELTA FAUCET MODEL 100HDF, #LK-99 DRAINAGE FITTING, CHICAGO FAUCET # 1019 SUPPLY PIPES WITH WHEEL HANDLE STOPS TO WALL WITH FLEXIBLE TUBE RISERS, CAST BRASS "P" TRAP WITH CLEANOUT.

ITEM P-4, MOP SINK: SHALL BE EQUAL TO FIAT MODEL MSB2424 24"X24"X12" MOLDED STONE MOP SERVICE BASIN. PROVIDE 3" CAST BRASS DRAIN WITH CHROME INTEGRAL STRAINER. PROVIDE CHICAGO FAUCET #897 COMBINATIONS SERVICE SINK FITTING HAVING SPOUT WITH VACUUM BREAKER, PAIL HOOK WALL BRACE, AND 3/4" HOSE THREAD. PROVIDE 4'-0" LONG HOSE WITH MALE AND FEMALE CONNECTIONS.

ELECTRICAL WATER HEATER: SHALL BE 20 GALLON STORAGE. SUPPLY COMPLETE WITH SAFE PAN AND TEMPERATURE AND PRESSURE RELIEF VALVE AND DISCHARGE PIPING FROM THE TEMPERATURE AND PRESSURE RELIEF VALVE DISCHARGING INDIRECTLY AND INDEPENDENTLY INTO A FLOOR DRAIN, SERVICE SINK, SUMP OR A TRAPPED AND VENTED P-TRAP, WHICH IS LOCATED IN THE SAME ROOM AS THE WATER HEATER. SECTION 504.7.I ALONG WITH A PROPERLY SIZED THERMAL EXPANSION TANK ON THE COLD WATER INLET TO EACH HEATER. NO VALVES ARE PERMITTED BETWEEN THE HEATER AND THE THERMAL EXPANSION TANK. SECTION 607.3.

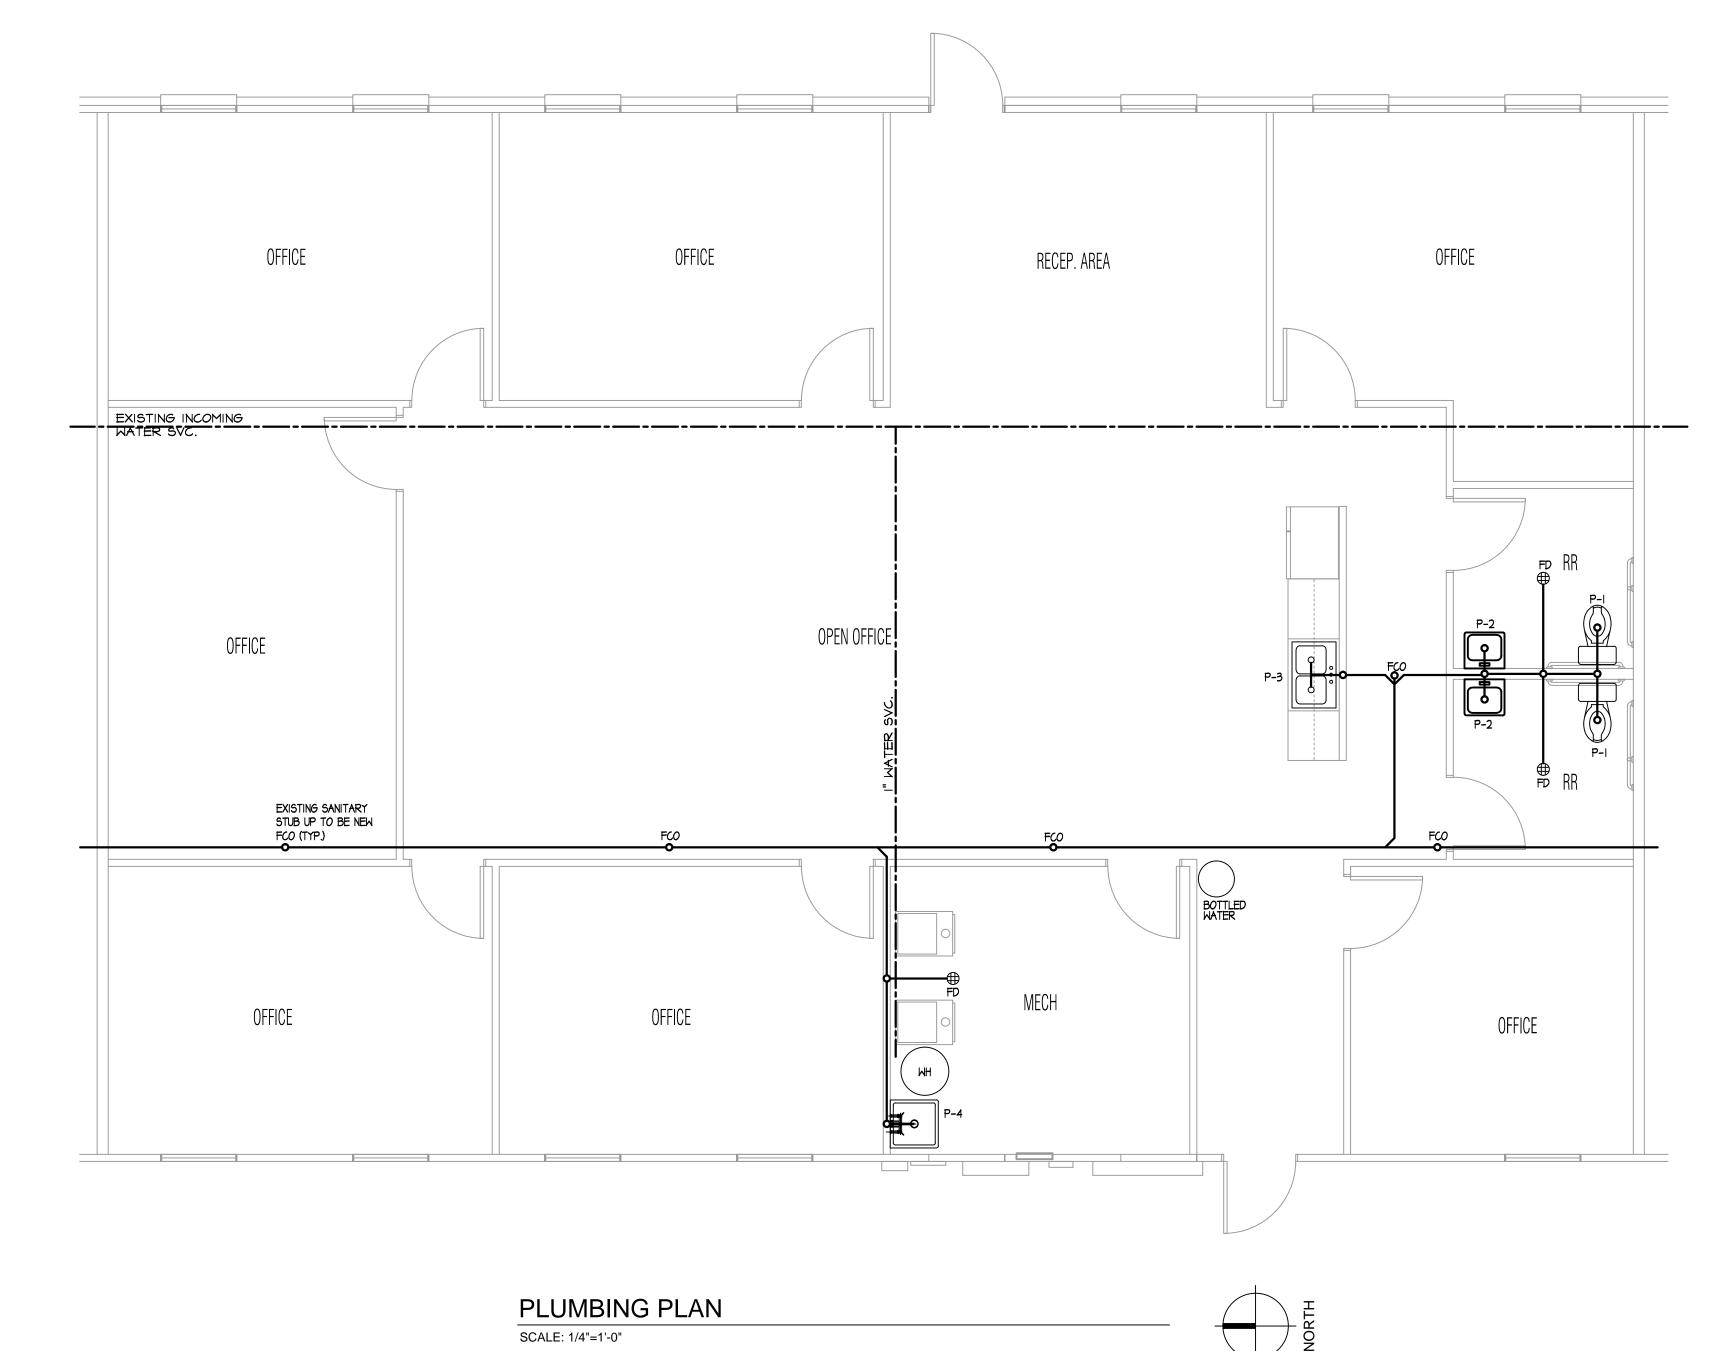

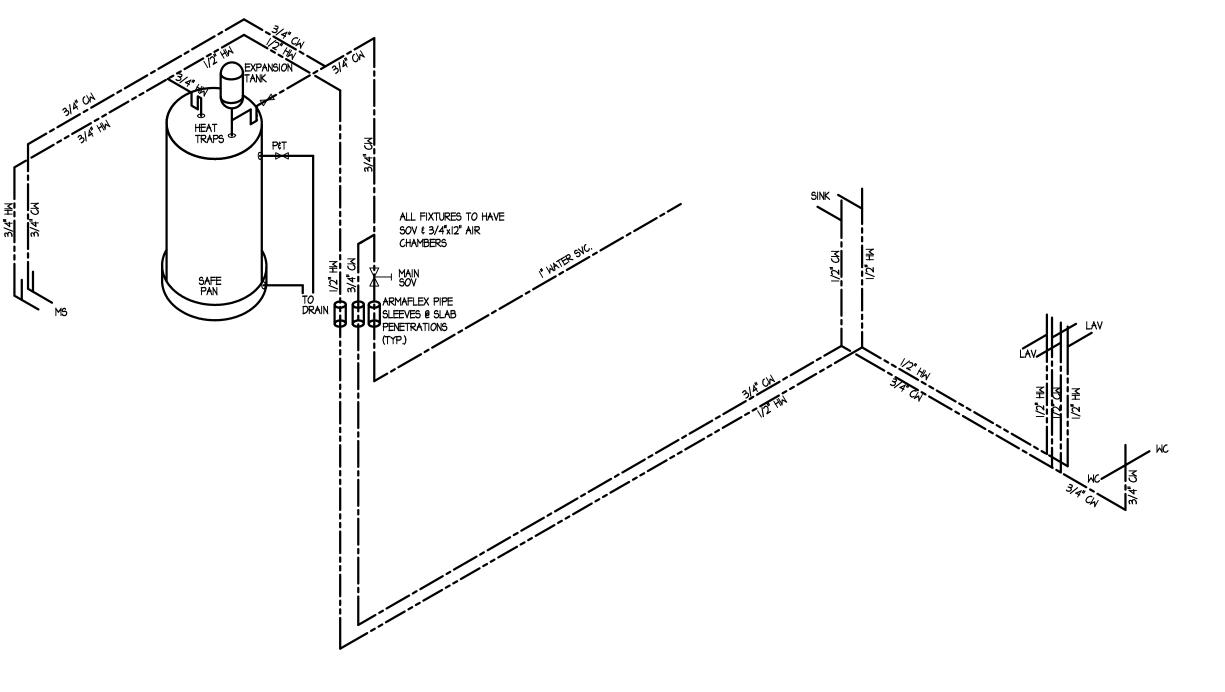

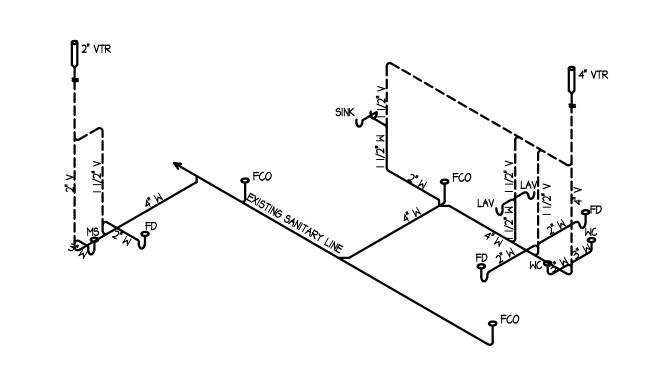

HOT & COLD WATER ISOMETRIC

DRAIN WASTE & VENT ISOMETRIC

NOT TO SCALE

2504 VMP TENANT FINISH
4 Veterans Memorial Parkway South
Lafayette, Indiana 47909

**HOFFMAN ENGINEERS P.C.** 

steve@hoffmanengineers.com


ate of Indiana Certificate of Authority # 16188
"GLOBAL COMMITMENT WITH
A MAIN STREET ATTITUDE"

PINELAND, FLORIDA 33945

P.O. BOX 344

239-472-2547 FAX 239-472-2557

## CONSTRUCTION DOCUMENT

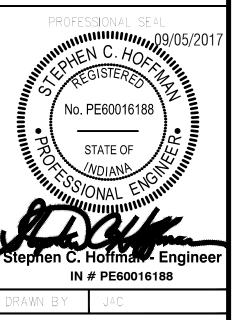

PLUMBING PLAN

SHEET TITLE

SHEET NUMBER

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Pot 17


#### MECHANICAL GENERAL NOTES:

- I. MECHANICAL CONTRACTOR TO FURNISH ALL LABOR, MATERIAL AND EQUIPMENT REQUIRED FOR THE COMPLETION AND OPERATION ON ALL SYSTEMS IN THIS SECTION OF WORK. ALL MECHANICAL WORK SHALL BE IN STRICT ACCORDANCE WITH INDIANA MECHANICAL CODE (I.M.C.), LATEST EDITION INCLUDING ADOPTED INDIANA AMENDMENTS, ASHRAE, SMACNA, NFPA AND EPA. THE APPLICABLE PORTIONS OF THE SPECIFICATIONS ARE INCLUDED AS PART OF THIS SPECIFICATION. ALL INSTALLATIONS SHALL BE PERFORMED IN A GOOD WORKMANLIKE MANNER.
- 2. ALL PIPING, VENTS, ETC., EXTENDING THROUGH WALLS & ROOF SHALL BE FLASHED, COUNTER FLASHED IN A WATERPROOF MANNER.
- 3. ALL DUCTWORK INSULATION SHALL BE RUN CONTINUOUSLY THROUGH FLOORS, PARTITIONS, ROOF STRUCTURE AND DECK.
- 4. ALL PIPING LOCATIONS SHALL BE COORDINATED W/ WORK UNDER OTHER DIVISIONS OF THE SPECIFICATIONS, TO AVOID INTERFERENCE. COORDINATE WITH ALL OTHER TRADES PRIOR TO PURCHASING OR INSTALLING EQUIPMENT AND MATERIALS.
- 5. METAL DUCTWORK SHALL COMPLY WITH SMACMA, "HVAC DUCT CONSTRUCTION STANDARDS, METAL AND FLEXIBLE." COMPLY WITH ASHRAE HANDBOOK FOR INSTALLATION OF METAL DUCTWORK. ALSO COMPLY WITH NFPA 90A. ALL TRUNK METAL DUCTWORK SHALL BE WRAPPED WITH 11/2" FOIL BACK INSULATION OR PROVIDE I" FIBERGLASS DUCT BOARD WITH PROPER SUPPORTS OR INTERNAL LINING WITH I" FIBERGLASS DUCT INSULATION. ALL COVERING AND LINERS INCLUDING ADHESIVES SHALL HAVE A FLAME SPREAD RATING NOT MORE THAN TWENTY-FIVE (25) AND SMOKE-DEVELOPED RATING NOT MORE THAN FIFTY (50) WHEN TESTED IN ACCORDANCE WITH ASTM-E-84. ALL SQUARE ELBOWS SHALL HAVE AIRFOIL TYPE TURNING VANES. PROVIDE VOLUME CONTROL DAMPERS AT ALL BRANCH DUCTS TO DIFFUSERS AND A MAXIMUM OF 5 FEET ABOVE THE CEILING. ALL DUCTWORK SHALL BE GALVANIZE SHEET METAL & SHALL BE CONSTRUCTED & INSTALLED IN ACCORDANCE WITH SMACMA STANDARDS. DUCT SIZES SHOWN ARE NET FREE AREA. INCREASE RECTANGULAR SHEET METAL DUCT SIZES BY TWO TIMES THE THICKNESS OF INSULATION.
- 6. MAXIMUM FLEXIBLE DUCT LENGTH SHALL BE 10'-0". ALL FLEXIBLE DUCT SHALL CONFORM TO THE REQUIREMENTS OF UL 181 FOR CLASS I FLEXIBLE AIR DUCTS. SUPPORT TO ELIMINATE SAGGING & KINKING.
- 7. SUPPORT PIPING RIGIDLY WITH APPROVED HANGERS AT INTERVALS NOT EXCEEDING TEN FEET OR BY ANOTHER APPROVED DUCT SUPPORT SYSTEM DESIGNED IN ACCORDANCE WITH THE BUILDING CODE, RUNS SHOULD BE NEAT, STRAIGHT LINES, TIGHT TO STRUCTURES OR WALLS. DO NOT OBSTRUCT USABLE SPACE. WHERE DUCTS PASS THROUGH WALLS, FLOORS, CEILINGS, ETC., PROVIDE FLANGES AND APPROPRIATE SEALING METHODS TO MAINTAIN INTEGRITY OF SURFACE PENETRATED AND PROVIDE A FINISHED APPEARANCE. PROVIDE FIRE STOPPING AS REQUIRED FOR FIRE RATED PENETRATIONS.
- 8. ALL HVAC EQUIPMENT TO BE INSTALLED PER MFG. REQUIREMENTS AS SHOWN. UTILIZE FACTORY FILTERS DURING CONSTRUCTION & REPLACE W/ REPLACEABLE METAL FILTER FRAME JUST PRIOR TO TEST & BALANCE & AT TIME BUILDING IS TURNED OVER TO THE OWNER. COORDINATE WITH THE OWNER.
- 9. PROVIDE FLEXIBLE CONNECTIONS AT ALL EQUIPMENT FOR SOUND AND VIBRATION
- IO. MAINTAIN MIN IO' BETWEEN OUTDOOR AIR INTAKES AND EXHAUST FAN DISCHARGE, PLUMBING, VENT, ETC.
- II. INSTALL ACCESSORY ITEMS, SUCH AS THROUGH THE WALL UNITS, AIR CLEANERS, HUMIDIFIERS, ETC. IN STRICT ACCORDANCE WITH MANUFACTURER'S PRINTED
- 12. PROVIDE AND INSTALL ALL CONDENSATE DRAIN LINES FROM HUMIDIFIERS AND COOLING COILS AS REQUIRED. TERMINATE ALL DRAIN LINES OVER OPEN SIGHT DRAINS, FLOOR DRAINS OR ROOF DRAINS WITH A MIN. OF 6" AIR GAP.
- 13. THERMOSTAT WIRING AND LOCATION: THERMOSTAT MUST BE MOUNTED ON A VERTICAL VIBRATION-FREE SURFACE FREE FROM AIR CURRENTS AND IN ACCORDANCE WITH THE FURNISHED INSTRUCTION. MOUNT THE THERMOSTAT APPROXIMATELY 5 FEET (I.5M) ABOVE THE FLOOR AREA WHERE IT WILL BE EXPOSED TO A FREE CIRCULATION OF AVERAGE TEMPERATURE AIR, ALWAYS REFER TO THE THERMOSTAT INSTRUCTIONS AS WELL AS UNIT WIRING DIAGRAM AND WIRE ACCORDINGLY. AVOID MOUNTING THE THERMOSTAT IN THE FOLLOWING LOCATIONS: COLD AREAS - OUTSIDE WALLS OR AREAS WHERE DRAFTS MAY AFFECT THE OPERATION OF THE CONTROL. HOT AREAS - AREAS WHERE THE SUN'S RAYS, RADIATION OR WARM AIR CURRENTS MAY AFFECT CONTROL OPERATION. DEAD AREAS - AREAS WHERE AIR CANNOT CIRCULATE FREELY, SUCH AS BEHIND DOORS OR IN
- 14. CONTRACTOR SHALL VISIT THE JOB SITE AND BE FAMILIAR WITH ALL PROJECT CONDITIONS PRIOR TO FABRICATING ANY EQUIPMENT, DUCTWORK, ETC. NO ALLOWANCES WILL BE MADE FOR CONTRACTOR UNFAMILIARITY WITH PROJECT
- 15. MECHANICAL CONTRACTOR SHALL BALANCE SYSTEM TO WITHIN 10% OF AIR QUANTITIES INDICATED ON PLANS AND PROVIDE OWNERS REPRESENTATIVE A COMPLETE BALANCE REPORT.
- 16. ALL EQUIPMENT SHALL HAVE I-YEAR WARRANTY & COMPRESSORS SHALL HAVE ADDITIONAL 4-YEAR EXTENDED WARRANTY.
- 17. ALL CONTROL WIRING & CONDUIT SHALL COMPLY WITH NEC.
- 18. PIPE & DUCT ROUTING SHOWN IS SCHEMATIC. HVAC CONTRACTOR SHALL PROVIDE ANY ADDITIONAL OFFSETS AND FITTING, INCLUDING DIVIDED DUCTS, REQUIRED FOR PROPER INSTALLATION AND TO MAINTAIN CLEARANCES AS ENCOUNTERED IN THE FIELD.
- 19. LIGHT FIXTURE LOCATIONS TAKE PRECEDENCE OVER DUCT RUNS, DIFFUSER AND GRILLE LOCATIONS. LOCATE DIFFUSERS AND GRILLES TO ACCOMMODATE LIGHTING
- 20. DO NOT SCALE DRAWINGS. SEE ARCHITECTURAL DRAWINGS & REFLECTED CEILING PLANS FOR EXACT LOCATION OF DOORS, WINDOWS, CEILING DIFFUSERS, ETC.
- 21. M.C. SHALL COORDINATE THE WORK WITH ALL TRADES INVOLVED IN THE CEILING WORK TO INSURE CLEARANCES FOR FIXTURES, DUCTS, PIPING CEILING SUSPENSION SYSTEMS, ETC., NECESSARY TO MAINTAIN THE FINISHED CEILING HEIGHTS INDICATED ON ARCHITECTURAL DRAWINGS.
- 22. ALL NEW PENETRATIONS THROUGH FLOOR, CEILING OR ROOF WILL HAVE THE ANNULAR AREA BETWEEN THE ITEM AND THE OPENING SEALED AROUND THE OPENING TO PREVENT THE PASSAGE OF FIRE AND SMOKE.
- 23. CONTRACTOR SHALL VISIT THE JOB SITE AND BE FAMILIAR WITH ALL PROJECT CONDITIONS PRIOR TO FABRICATING ANY EQUIPMENT, ETC. NO ALLOWANCES WILL BE MADE FOR CONTRACTOR UNFAMILIARITY WITH PROJECT CONDITIONS.


#### EQUIPMENT SCHEDULE

FI/CI & F2/C2 SPLIT SYSTEM = 1400 CFM, 3.5 TON A/C , 90,000 BTU LP GAS HEAT, 92% EFF. W/ 8.3% - 116 CFM, EACH O.A., LO AMBIENT KIT. O.A. DUCT TO BE FITTED WITH AUTOMATIC DAMPER THAT WILL GO TO FULLY OPEN DURING "OCCUPIED" MODE AND FULLY CLOSED DURING "UNOCCUPIED" MODE.

EF = 75 CFM RESTROOM EXHAUST FANS & LIGHT COMBO VENTED TO THE EXTERIOR.

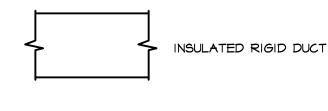


INSULATED FLEX DUCT

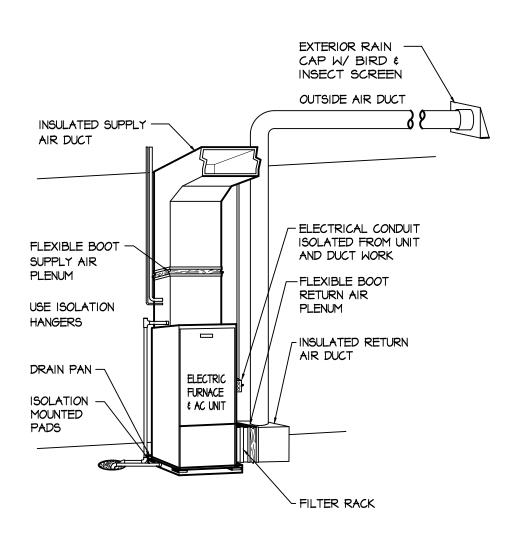



THE ABOVE REQUIREMENTS ARE ESSENTIAL TO THE INSTALLATION IN ORDER TO ISOLATE THE UNIT AND PREVENT ANY VIBRATION FROM BEING TRANSMITTED TO THE STRUCTURE.

#### MAJOR INSTALLATION REQUIREMENTS

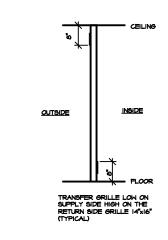


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#### CONSTRUCTION **DOCUMENT**

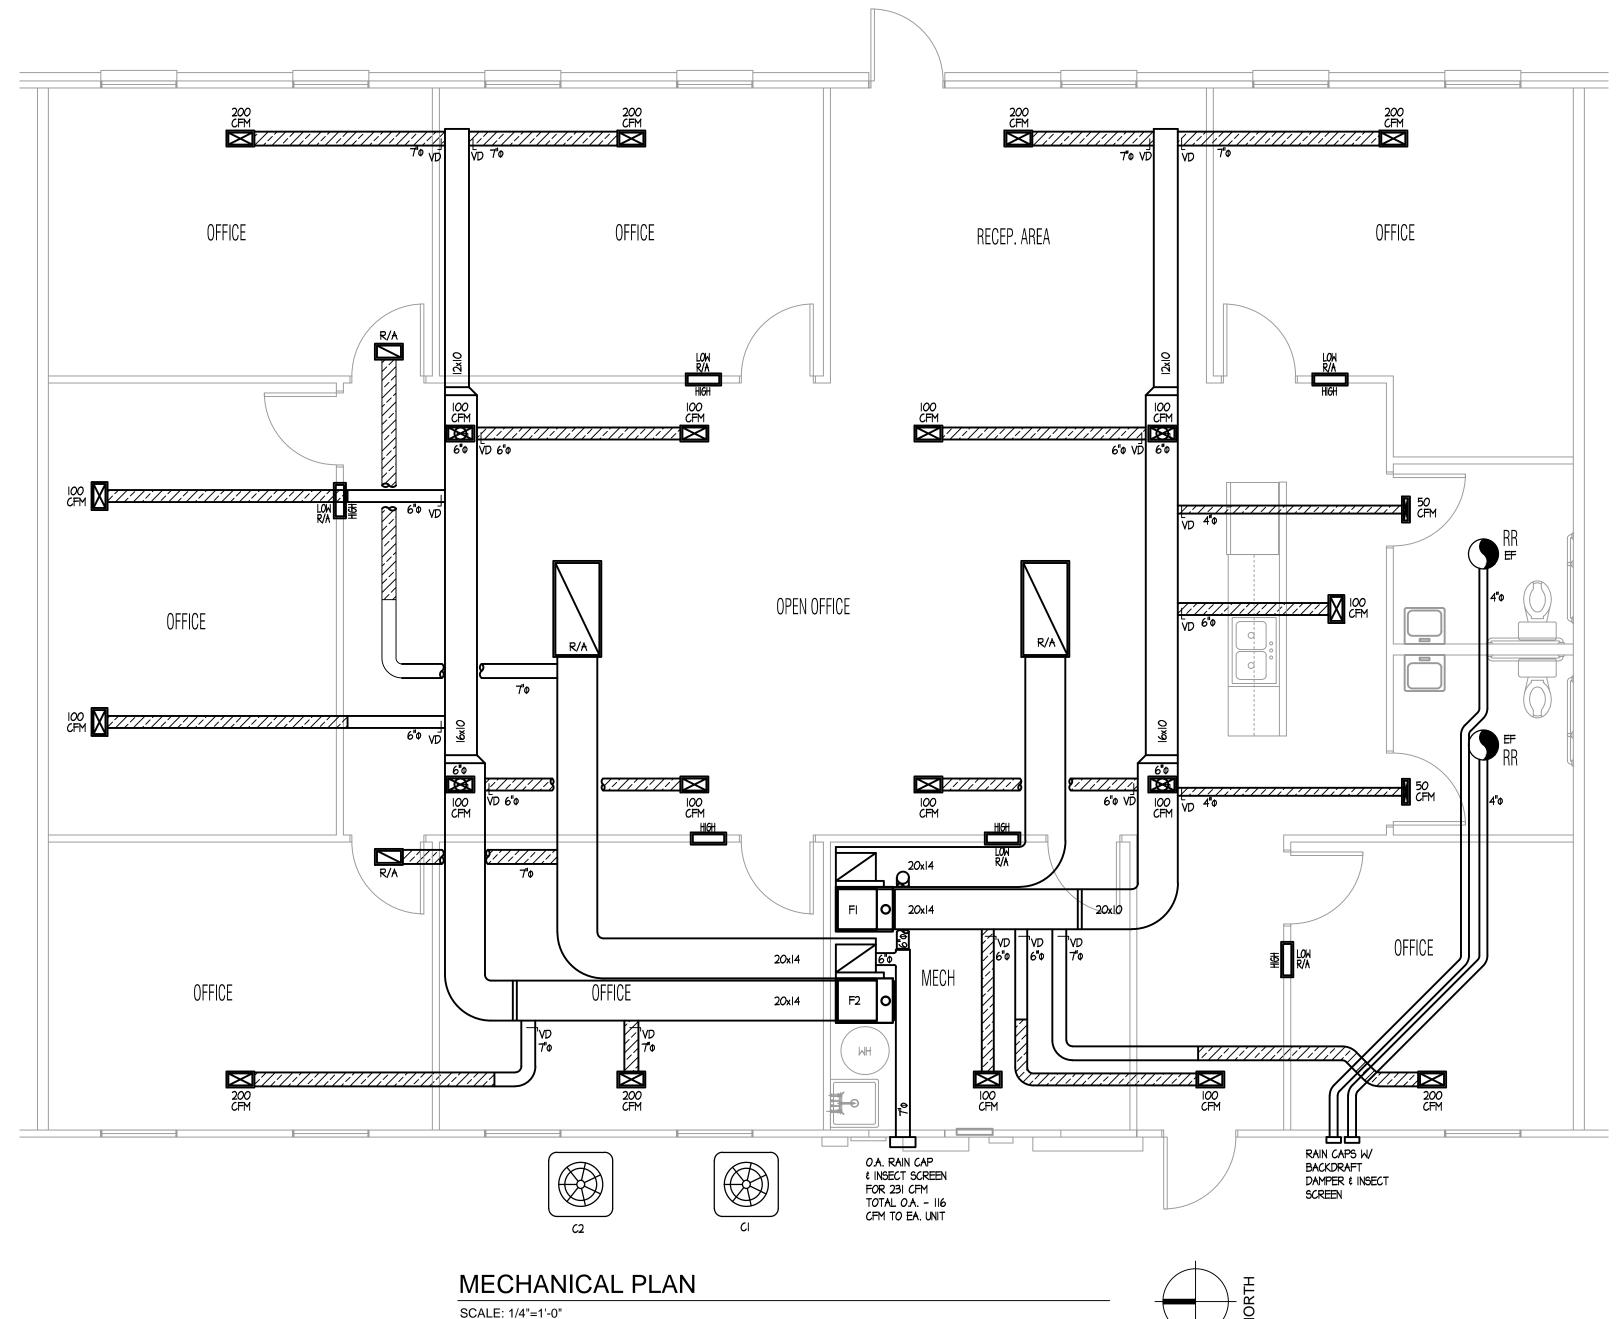

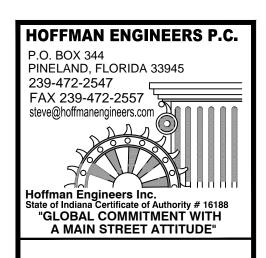
SHEET TITLE MECHANICAL **PLAN** 


#### ELECTRICAL GENERAL NOTES:

- I. THE ELECTRICAL CONTRACTOR SHALL CONSULT WITH THE LOCAL POWER COMPANY AND PROVIDE ALL MATERIALS AND LABOR AND PAY ALL COSTS AND FEES NOT BORNE BY THE LOCAL POWER COMPANY TO PROVIDE A COMPLETE ELECTRICAL SERVICE AS REQUIRED.
- 2. ALL ELECTRICAL WORK SHALL BE PERFORMED IN STRICT ACCORDANCE WITH THE IBC, N.F.P.A. STANDARD NO. 70 (INDIANA ELECTRICAL CODE IEC), LATEST EDITION, WITH ADOPTED STATE AMENDMENTS, AND SHALL BE PERFORMED IN A GOOD WORKMANLIKE MANNER. WORK SHALL BE IN ACCORDANCE WITH ALL LOCAL CODES AND INSPECTIONS.
- 3. NO CIRCUIT OR FEEDER SHALL EXCEED 3% VOLTAGE DROP.
- 4. ANY CONDUCTORS RUNNING UNDERGROUND (SERVICE, FEEDERS, BRANCH CIRCUITS, ETC.) TO HAVE "WET LOCATION" RATING IN ACCORDANCE WITH THE REQUIREMENTS OF THE NEC, SECTION 310-8.
- 5. ALL WIRING SHALL BE IN EMT CONDUIT, 100% COPPER, UNLESS OTHERWISE NOTED ON THE DRAWINGS. WIRES SHALL BE SIZED ACCORDING TO THE NEC ARTICLE 310-15.
- 6. SPLICES SHALL BE MADE ONLY AT ACCESSIBLE LOCATIONS, OUTLET BOXES, PANELBOARDS, JUNCTION BOXES, ETC. TERMINAL CONNECTIONS AND SPLICES IN ALL WIRE #6 AND LARGER SHALL BE MADE WITH APPROVED SOLDERLESS CONNECTORS, PROPERLY INSULATED AND TAPED WHERE NECESSARY. IN SMALLER WIRES ALL SPLICES SHALL BE MADE EITHER WITH APPROVED SOLDERLESS CONNECTORS OR SHALL BE SOLDERED AND TAPED AS REQUIRED TO INSURE PROPER INSULATION.
- 7. ELECTRICAL BOXES AND FITTINGS SHALL COMPLY WITH UL STANDARD #50, 514-SERIES AND 886 AND NEMA STANDARDS PUBLICATIONS #051, 052 AND PUBLICATION 250.
- 8. WIRING DEVICES SHALL COMPLY WITH NEC, UL 20, 486A, 498 AND 943, IEEE STANDARD 241
- 9. RECEPTACLES SHALL BE GENERAL DUTY TYPE, 2-POLE, 3-WIRE, GROUNDED, 20 AMPS, 125 VOLTS. RECEPTACLES SHALL BE INSTALLED 18" ABOVE FINISH FLOOR, UNLESS OTHERWISE NOTED
- IO. SWITCHES SHALL BE GENERAL DUTY, 20 AMPS, I20-277 VOLTS.

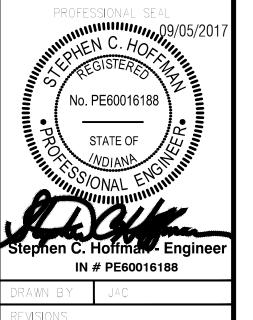
AND NEMA STANDARDS PUBLICATION NO. WDI, WD2 AND WD5.

- II. FIXTURE SUPPORTS SHALL BE PROVIDED IN ACCORDANCE WITH THE REQUIREMENTS OF THE NEC, ARTICLE 700.
- 12. ALL EQUIPMENT SHALL BEAR THE UL LABEL AND BE INSTALLED ACCORDING TO THE LATEST EDITION OF THE NEC.
- 13. SERVICE EQUIPMENT SHALL BE SUITABLE FOR SHORT-CIRCUIT CURRENT AVAILABLE AT ITS SUPPLY TERMINALS AS PER NEC ARTICLE 230-90.
- 14. LIGHTING FIXTURES SHALL COMPLY WITH NEC, NEMA, UL AND IES (APPLICABLE ARTICLES).
- 15. EMERGENCY MEANS OF EGRESS LIGHTING WITH BATTERY BACKUP POWER SHALL PROVIDE EMERGENCY ILLUMINATION FOR A DURATION OF NOT LESS THAN 1.5 HOURS MINIMUM, WITHOUT THE VOLTAGE APPLIED TO THE LOAD FALLING BELOW 87.5% OF NORMAL. LOCAL AUTHORITY SHALL FIELD VERIFY AND LOCATE ADDITIONAL FIXTURES IF NEEDED. PROVIDE LOCK-ON FEATURE ON CIRCUIT BREAKER.
- 16. PROVIDE MANUFACTURER'S RECOMMENDED LAMPS FOR ALL FIXTURES AND CLEAN AND REPLACE BURNED OUT LAMPS AT SUBSTANTIAL COMPLETION.
- 17. ELECTRICAL DEVICES SUCH AS SWITCHES, RECEPTACLES, ETC. THAT PENETRATE A FIREWALL, MUST BE IN ACCORDANCE WITH SECTION 711 OF THE IBC.
- 18. ALL DISCONNECTS AND CIRCUIT BREAKERS SHALL BE MARKED FOR IDENTIFICATION.
- 19. OPERATING HANDLE OF THE SWITCH OR CIRCUIT BREAKER, WHEN IN ITS HIGHEST POSITION, WILL NOT BE MORE THAN 6'-7" ABOVE THE FINISH FLOOR OR PLATFORM.
- 20. PROVIDE A BONDING JUMPER AT THE WATER METER AND AT WATER HEATER.
- 21. THE WORKING CLEARANCE FROM THE SIDE EDGE OF ALL ELECTRICAL EQUIPMENT HAS BEEN INCREASED FROM 30" TO 36".
- 22. THE ELECTRICAL CONTRACTOR WILL PROVIDE DESIGN NUMBER AND MANUFACTURER'S CUT SHEETS TO THE LOCAL BUILDING DEPARTMENT WHEN WIRING METHODS, WHICH WILL PENETRATE THROUGH FIRE RESISTANT RATED WALLS, PARTITIONS, FLOORS, OR CEILINGS, AND INCLUDE APPROVED METHODS TO MAINTAIN THE RESISTANCE RATING.
- 23. THE ELECTRICAL CONTRACTOR WILL NEED TO PROVIDE MANUFACTURER'S ELECTRICAL FIXTURE CUT SHEETS TO THE LOCAL BUILDING DEPARTMENT, IF REQUIRED.

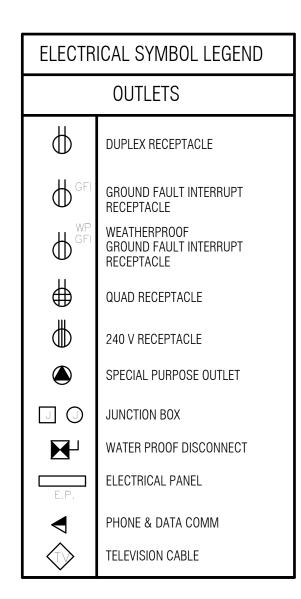


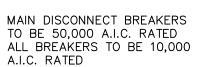


| WIRE &      | CONDUIT S        | SIZE SCHEDULE      |
|-------------|------------------|--------------------|
| <u>AMPS</u> | WIRE SIZE        | CONDUIT SIZE       |
| 20A         | #12              | 3/4"               |
| 25A         | <i>"</i> #10     | 3/4"               |
| 30A         | <del>"</del> #10 | 3/4"               |
| 35A         | <del>"</del> #8  | 1"                 |
| 50A         | <del>"</del> #8  | 1"                 |
| 60A         | <b>#</b> 6       | 1"                 |
| 85A         | #4               | 1 1/4"             |
| 100A        | #3               | 1 1/2"             |
| 200A        | #3/0 TH          | HN 2" <sup>′</sup> |

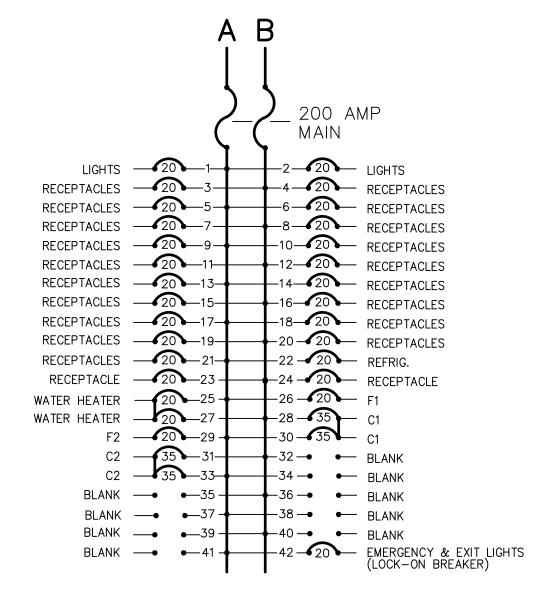


ELECTRICAL PANEL
120/240 10 200 AMP

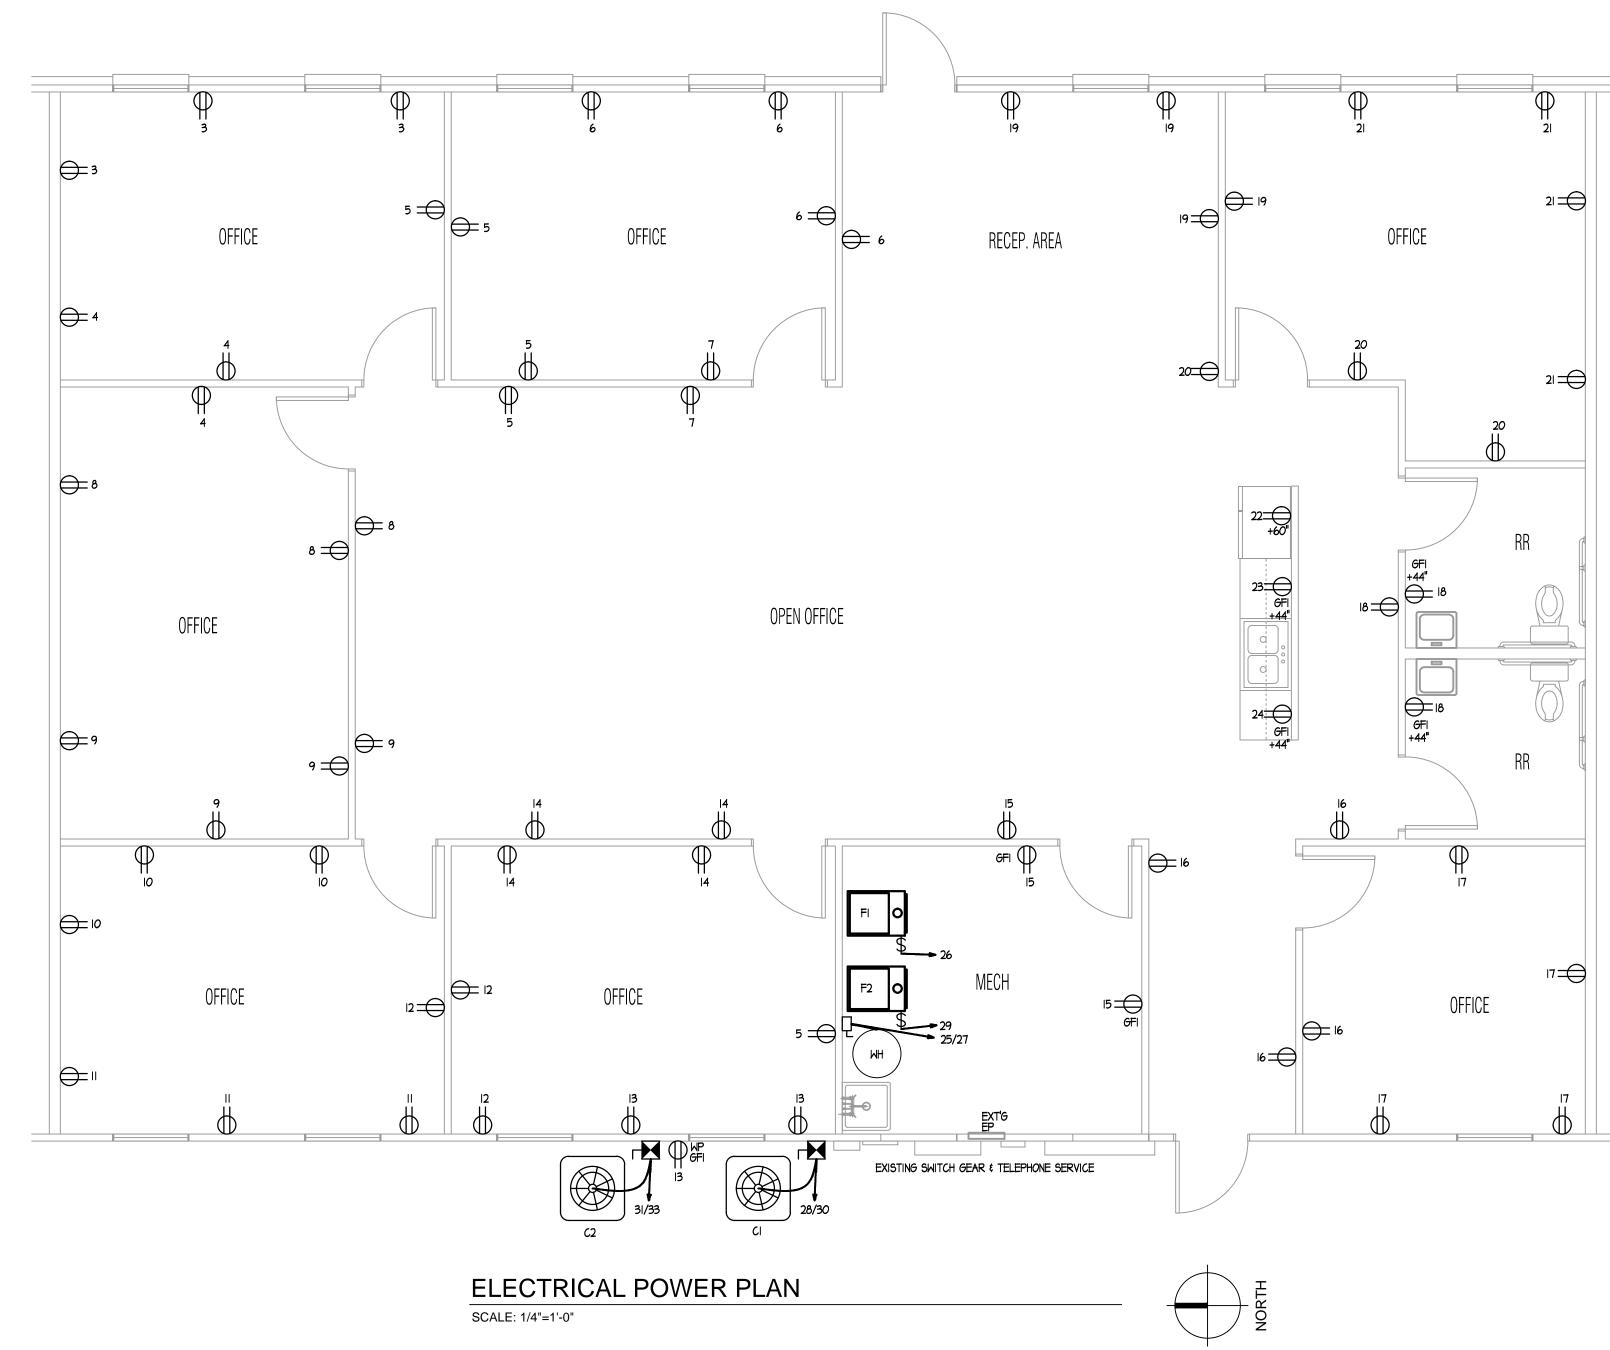

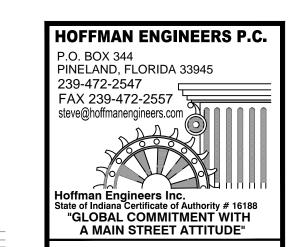

2504 VMP TENANT FINISH 2504 Veterans Memorial Parkway Sc Lafayette, Indiana 47909

### CONSTRUCTION DOCUMENT

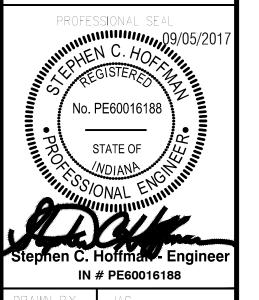

Stephen C. Hoffman - Enginee IN # PE60016188

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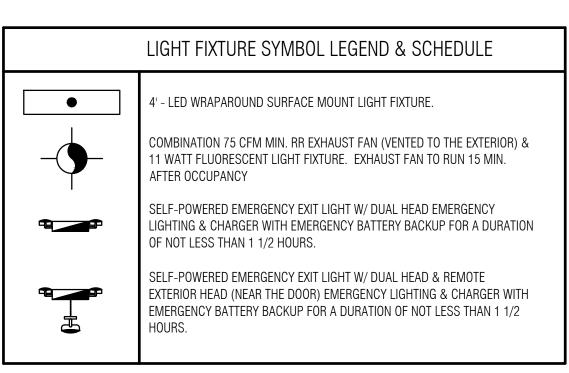
REVISIONS


ELECTRICAL POWER PLAN


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#### ELECTRICAL GENERAL NOTES:


- . THE ELECTRICAL CONTRACTOR SHALL CONSULT WITH THE LOCAL POWER COMPANY AND PROVIDE ALL MATERIALS AND LABOR AND PAY ALL COSTS AND FEES NOT BORNE BY THE LOCAL POWER COMPANY TO PROVIDE A COMPLETE ELECTRICAL SERVICE AS REQUIRED.
- 2. ALL ELECTRICAL WORK SHALL BE PERFORMED IN STRICT ACCORDANCE WITH THE IBC, N.F.P.A. STANDARD NO. 70 (INDIANA ELECTRICAL CODE IEC), LATEST EDITION, WITH ADOPTED STATE AMENDMENTS, AND SHALL BE PERFORMED IN A GOOD WORKMANLIKE MANNER. WORK SHALL BE IN ACCORDANCE WITH ALL LOCAL CODES AND INSPECTIONS.
- 3. NO CIRCUIT OR FEEDER SHALL EXCEED 3% VOLTAGE DROP.
- 4. ANY CONDUCTORS RUNNING UNDERGROUND (SERVICE, FEEDERS, BRANCH CIRCUITS, ETC.) TO HAVE "WET LOCATION" RATING IN ACCORDANCE WITH THE REQUIREMENTS OF THE NEC, SECTION 310-8.
- 5. ALL WIRING SHALL BE IN EMT CONDUIT, 100% COPPER, UNLESS OTHERWISE NOTED ON THE DRAWINGS. WIRES SHALL BE SIZED ACCORDING TO THE NEC ARTICLE 310-15.
- 6. SPLICES SHALL BE MADE ONLY AT ACCESSIBLE LOCATIONS, OUTLET BOXES, PANELBOARDS, JUNCTION BOXES, ETC. TERMINAL CONNECTIONS AND SPLICES IN ALL WIRE #6 AND LARGER SHALL BE MADE WITH APPROVED SOLDERLESS CONNECTORS, PROPERLY INSULATED AND TAPED WHERE NECESSARY. IN SMALLER WIRES ALL SPLICES SHALL BE MADE EITHER WITH APPROVED SOLDERLESS CONNECTORS OR SHALL BE SOLDERED AND TAPED AS REQUIRED TO INSURE PROPER INSULATION.
- 7. ELECTRICAL BOXES AND FITTINGS SHALL COMPLY WITH UL STANDARD #50, 514-SERIES AND 886 AND NEMA STANDARDS PUBLICATIONS #051, 052 AND PUBLICATION 250.
- 8. WIRING DEVICES SHALL COMPLY WITH NEC, UL 20, 486A, 498 AND 943, IEEE STANDARD 241 AND NEMA STANDARDS PUBLICATION NO. WDI, WD2 AND WD5.
- 9. RECEPTACLES SHALL BE GENERAL DUTY TYPE, 2-POLE, 3-WIRE, GROUNDED, 20 AMPS, 125 VOLTS. RECEPTACLES SHALL BE INSTALLED 18" ABOVE FINISH FLOOR, UNLESS OTHERWISE NOTED.
- IO. SWITCHES SHALL BE GENERAL DUTY, 20 AMPS, 120-277 VOLTS.
- II. FIXTURE SUPPORTS SHALL BE PROVIDED IN ACCORDANCE WITH THE REQUIREMENTS OF THE NEC, ARTICLE 700.
- 12. ALL EQUIPMENT SHALL BEAR THE UL LABEL AND BE INSTALLED ACCORDING TO THE LATEST EDITION OF THE NEC.
- 3. SERVICE EQUIPMENT SHALL BE SUITABLE FOR SHORT-CIRCUIT CURRENT AVAILABLE AT ITS SUPPLY TERMINALS AS PER NEC ARTICLE 230-90.
- 4. LIGHTING FIXTURES SHALL COMPLY WITH NEC, NEMA, UL AND IES (APPLICABLE ARTICLES).
- 5. EMERGENCY MEANS OF EGRESS LIGHTING WITH BATTERY BACKUP POWER SHALL PROVIDE EMERGENCY ILLUMINATION FOR A DURATION OF NOT LESS THAN 1.5 HOURS MINIMUM, WITHOUT THE VOLTAGE APPLIED TO THE LOAD FALLING BELOW 87.5% OF NORMAL. LOCAL AUTHORITY SHALL FIELD VERIFY AND LOCATE ADDITIONAL FIXTURES IF NEEDED. PROVIDE LOCK-ON FEATURE ON CIRCUIT BREAKER.
- 16. PROVIDE MANUFACTURER'S RECOMMENDED LAMPS FOR ALL FIXTURES AND CLEAN AND REPLACE BURNED OUT LAMPS AT SUBSTANTIAL COMPLETION.
- 7. ELECTRICAL DEVICES SUCH AS SWITCHES, RECEPTACLES, ETC. THAT PENETRATE A FIREWALL, MUST BE IN ACCORDANCE WITH SECTION 711 OF THE IBC.
- 18. ALL DISCONNECTS AND CIRCUIT BREAKERS SHALL BE MARKED FOR IDENTIFICATION.
- 9. OPERATING HANDLE OF THE SWITCH OR CIRCUIT BREAKER, WHEN IN ITS HIGHEST POSITION, WILL NOT BE MORE THAN 6'-7" ABOVE THE FINISH FLOOR OR PLATFORM.
- 20. PROVIDE A BONDING JUMPER AT THE WATER METER AND AT WATER HEATER.
- 21. THE WORKING CLEARANCE FROM THE SIDE EDGE OF ALL ELECTRICAL EQUIPMENT HAS BEEN INCREASED FROM 30" TO 36".
- 22. THE ELECTRICAL CONTRACTOR WILL PROVIDE DESIGN NUMBER AND MANUFACTURER'S CUT SHEETS TO THE LOCAL BUILDING DEPARTMENT WHEN WIRING METHODS, WHICH WILL PENETRATE THROUGH FIRE RESISTANT RATED WALLS, PARTITIONS, FLOORS, OR CEILINGS, AND INCLUDE APPROVED METHODS TO MAINTAIN THE RESISTANCE RATING.
- 23. THE ELECTRICAL CONTRACTOR WILL NEED TO PROVIDE MANUFACTURER'S ELECTRICAL FIXTURE CUT SHEETS TO THE LOCAL BUILDING DEPARTMENT, IF REQUIRED.





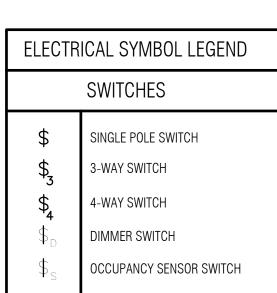

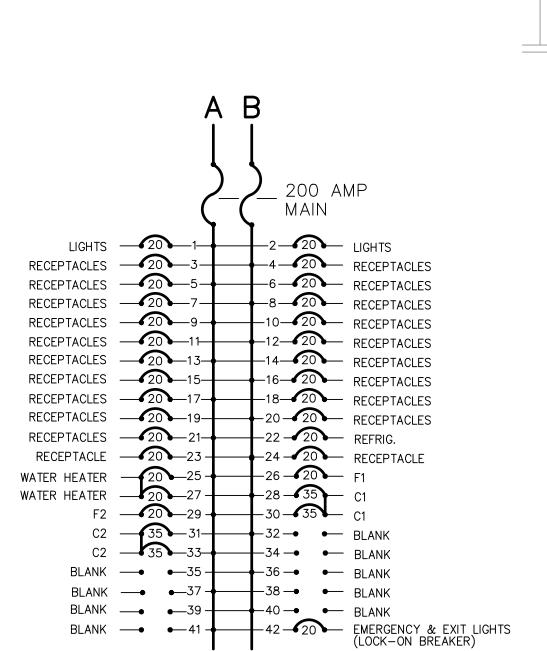


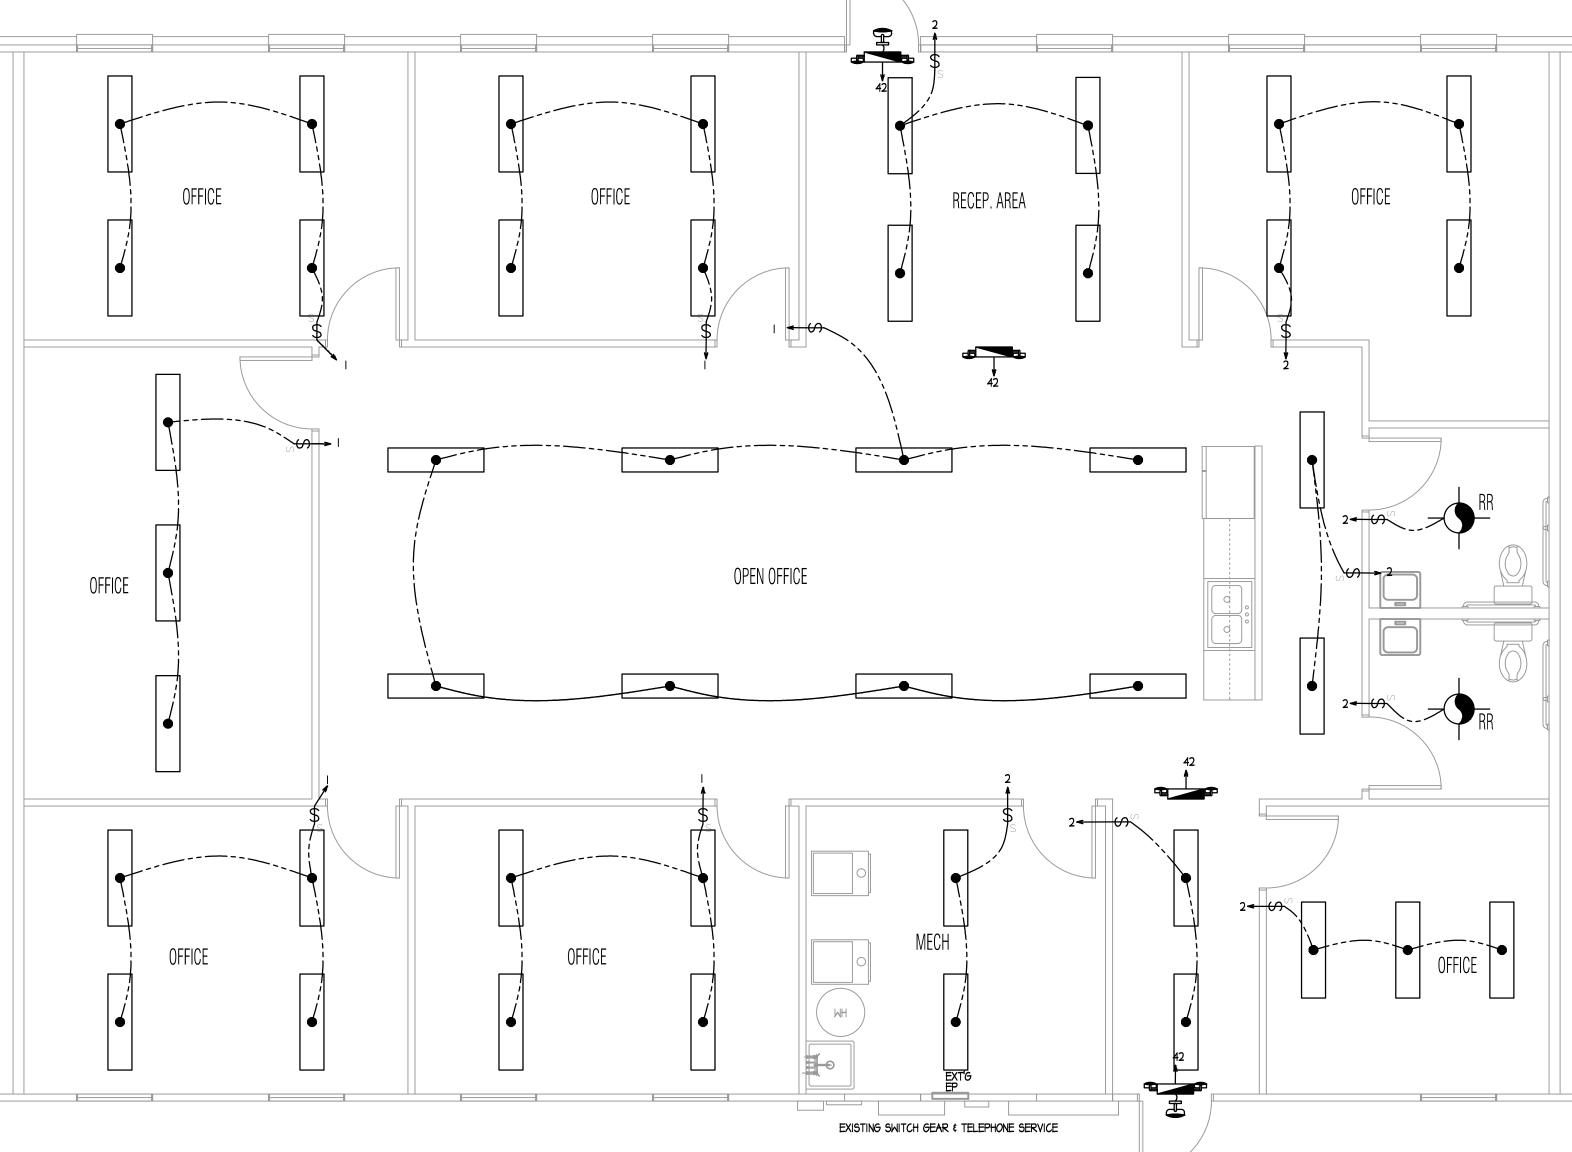

ELECTRICAL LIGHTING PLAN

SCALE: 1/4"=1'-0"



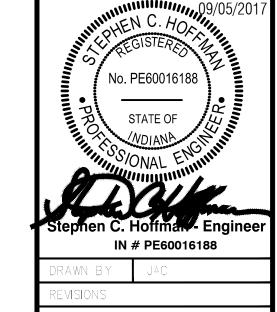

**HOFFMAN ENGINEERS P.C.** 

steve@hoffmanengineers.com

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"GLOBAL COMMITMENT WITH
A MAIN STREET ATTITUDE"

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PINELAND, FLORIDA 33945

P.O. BOX 344

239-472-2547 FAX 239-472-2557

IN # PE60016188

DRAWN BY JAC

REVISIONS

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ELECTRICAL
LIGHTING PLAN