

Form: 2021 IFC w/ FBC Amend. Plan Review Civil &

Construction

Fort Bend County Fire Marshal

Occupancy: WAREHOUSE AT BELLFORT BLDG T

Occupancy ID: 8839

Address: 18120 W BELLFORT ST

RICHMOND TX 77407

Inspection Type: Plan Review

Inspection Date: 4/28/2022

By: Porter, Daniel (4015)

Time In: 15:42

Time Out: 15:57

Authorized Date: 04/28/2022

By: Porter, Daniel (4015)

Inspection Description:

Construction and Civil Plan review form to help with identifying the needs and changes to a submitted project.

Inspection Topics:

Administrative

Application of Permit Submitted

Permit fees must be paid according to the permit fee pay scale of the Fort Bend County Fire Marshal's Office. Two sets of plans must be submitted prior to conducting plan reviews.

Status: PASS

Notes: Permit # 2022-04-1583 2 Sets of Plans submitted 1 Set of Plans retained 1 Set of Plans returned

Fire Code Design Signed and Sealed

Signed and sealed by a duly licensed architect or engineer authorized to practice in the State of Texas. Designed according to all applicable codes.

Status: PASS

Notes: TALLURI, MADHAVI

PE# 113329

Status Active Branch(s) Civil Granted 12-12-2012 Expires 09-30-2022

Re-submittable, Remodel, New Construction, or Add-on construction

Type of plan submitted. **Status:** OBSERVED

Notes: New Construction of SHELL only office building

Total Floor area (All Stories Combined)

List of total square footage for the areas of construction.

Status: OBSERVED Notes: Total SQFT - 5,700

1004.1 Occupant Load Calculated

In determining means of egress requirements, the number of occupants for whom means of egress facilities shall be provided shall be determined in accordance with this section.

Status: OBSERVED Notes: Total O/L - 17

Required Inspections

This review in no way excludes items that may be discovered in the field during inspections. The items discovered are required to be corrected or completed in order to comply with the applicable code or standard. Required inspections on the project are:

Status: REQUIRED

Notes: Final - Life Safety COC

Fire Service Features

503.1 Fire Access roads required. (Ft. Bend County Amend.)

Fire apparatus access roads shall be provided and maintained in accordance with Sections 503.1.1 through 503.1.3. 503.1.1 - Except for one- or two-family dwellings, the path of measurement shall be along a minimum of a 10 feet (3048 mm) wide unobstructed pathway around the external walls of the structure.

Status: REQUIRED

Notes:

503.3 Fire lane marking. (Ft. Bend County Amend.)

Marking. Striping, signs, or other markings, when approved by the fire code official, shall be provided for the fire apparatus access roads to identify such roads or prohibit the obstruction thereof. Striping, signs, and other markings shall be maintained in a clean and legible condition at all times and be replaced or repaired when necessary to provide adequate visibility. (1) Striping – Fire apparatus access roads shall be continuously marked by painted lines of red traffic paint six inches (6") in width to show the boundaries of the lane. The words "NO PARKING FIRE LANE" or "FIRE LANE NO PARKING" shall appear in four inch (4") white letters at 25 feet intervals on the red border markings along both sides of the fire lanes. Where a curb is available, the striping shall be on the vertical face of the curb. (2) Signs – Signs shall read "NO PARKING FIRE LANE" or "FIRE LANE NO PARKING" and shall be 12" wide and 18" high. Signs shall be painted on a white background with letters and borders in red, using not less than 2" lettering. Signs shall be permanently affixed to a stationary post and the bottom of the sign shall be six feet, six inches (6'6") above finished grade. Signs shall be spaced not more than fifty feet (50') apart along both sides of the fire lane. Signs may be installed on permanent buildings or walls or as approved by the Fire Marshal.

Status: REQUIRED

Notes:

505.1 Property Identifying numbers (Ft. Bend County Amended)

New and existing buildings shall be provided with approved address identification. The address identification shall be legible and placed in a position that is visible from the street or road fronting the property. Address identification characters shall contrast with their background. Address numbers shall be Arabic numbers or alphabetical letters. Numbers shall not be spelled out. Each character shall be not 6 inches (152.4 mm) high with a minimum stroke width of 1/2 inch (12.7 mm). Where required by the fire code official, address numbers shall be provided in additional approved locations to facilitate emergency response. Where access is by means of a private road, buildings do not immediately front a street, and/or the building cannot be viewed from the public way, a monument, pole or other sign with approved 6 inch (152.4 mm) height building numerals or addresses and 4 inch (101.6 mm) height suite/apartment numerals of a color contrasting with the background of the building or other approved means shall be used to identify the structure. Numerals or addresses shall be posted on a minimum 20 inch (508 mm) by 30 inch (762 mm) background on border. Address identification shall be maintained.

Status: REQUIRED

Notes:

Fire Protection Systems

906.1 Portable Fire Extinguisher required

Portable fire extinguishers shall be installed in the following locations. 1. In new and existing Group A, B, E, F, H, I, M, R-1, R-2, R-4 and S occupancies. Exception: In Group R-2 occupancies, portable fire extinguishers shall be required only in locations specified in Items 2 through 6 where each dwelling unit is provided with a portable fire extinguisher having a minimum rating of 1-A:10-B:C. 2. Within 30 feet (9144 mm) of commercial cooking equipment. 3. In areas where flammable or combustible liquids are stored, used or dispensed. 4. On each floor of structures under construction, except Group R-3 occupancies, in accordance with Section 3315.1. 5. Where required by the sections indicated in Table 906.1. 6. Special-hazard areas, including but not limited to laboratories, computer rooms and generator rooms, where required by the fire code official.

Status: REQUIRED

Notes:

906.3 Minimum extinguisher size 2A:5B maximum 75' spacing & 30' for flammable liquids

The size and distribution of portable fire extinguishers shall be in accordance with Sections 906.3.1 through 906.3.4.

Status: REQUIRED

Notes:

906.5 Extinguishers need to be in a conspicuous location along an exit pathway

Portable fire extinguishers shall be located in conspicuous locations where they will be readily accessible and immediately available for use. These locations shall be along normal paths of travel, unless the fire code official determines that the hazard posed indicates the need for placement away from normal paths of travel.

Status: REQUIRED

Notes:

Means of Egress

1008.2 Illumination Required

The means of egress, including the exit discharge, shall be illuminated at all times the building space served by the means of egress is occupied.

Status: REQUIRED

Notes:

1008.3 Emergency power for illumination

The power supply for means of egress illumination shall normally be provided by the premises' electrical supply. In the event of power supply failure, an emergency electrical system shall automatically illuminate all of the following areas: 1. Aisles and unenclosed egress stairways in rooms and spaces that require two or more means of egress. 2. Corridors, interior exit stairways and ramps and exit passageways in buildings required to have two or more exits. 3. Exterior egress components at other than their levels of exit discharge until exit discharge is accomplished for buildings required to have two or more exits. 4. Interior exit discharge elements, as permitted in Section 1028.1, in buildings required to have two or more exits. 5. Exterior landings as required by Section 1010.1.6 for exit discharge doorways in buildings required to have two or more exits. The emergency power system shall provide power for a duration of not less than 90 minutes and shall consist of storage batteries, unit equipment or an on-site generator. The installation of the emergency power system shall be in accordance with Section 604.

Status: REQUIRED

Notes:

1010.2.4 Thumb lock signage THIS DOOR TO REMAIN UNLOCKED WHEN BUILDING IS OCCUPIED

Locks and latches shall be permitted to prevent operation of doors where any of the following exists: 1. Places of detention or restraint. 2. In buildings in occupancy Group A having an occupant load of 300 or less, Groups B, F, M and S, and in places of religious worship, the main exterior door or doors are permitted to be equipped with key-operated locking devices from the egress side provided: 2.1. The locking device is readily distinguishable as locked; 2.2. A readily visible durable sign is posted on the egress side on or adjacent to the door stating: THIS DOOR TO REMAIN UNLOCKED WHEN BUILDING IS OCCUPIED. The sign shall be in letters 1-inch (25 mm) high on a contrasting background; and 2.3. The use of the key-operated locking device is revocable by the fire code official for due cause. 3. Where egress doors are used in pairs, approved automatic flush bolts shall be permitted to be used, provided that the door leaf having the automatic flush bolts has no doorknob or surface mounted hardware. 4. Doors from individual dwelling or sleeping units of Group R occupancies having an occupant load of 10 or less are permitted to be equipped with a night latch, dead bolt or security chain, provided such devices are openable from the inside without the use of a key or tool. 5. Fire doors after the minimum elevated temperature has disabled the unlatching mechanism in accordance with listed fire door test procedures.

Status: REQUIRED

Notes:

1013.1 Exit signs needed (any room requiring two or more exits needs to have signs)

Exits and exit access doors shall be marked by an approved exit sign readily visible from any direction of egress travel. The path of egress travel to exits and within exits shall be marked by readily visible exit signs to clearly indicate the direction of egress travel in cases where the exit or the path of egress travel is not immediately visible to the occupants. Intervening means of egress doors within exits shall be marked by exit signs. Exit sign placement shall be such that no point in an exit access corridor or exit passageway is more than 100 feet (30 480 mm) or the listed viewing distance for the sign, whichever is less, from the nearest visible exit sign. Exceptions: 1. Exit signs are not required in rooms or areas that require only one exit or exit access. 2. Main exterior exit doors or gates that are obviously and clearly identifiable as exits need not have exit signs where approved by the fire code official. 3. Exit signs are not required in occupancies in Group U and individual sleeping units or dwelling units in Group R-1, R-2 or R-3. 4. Exit signs are not required in dayrooms, sleeping rooms or dormitories in occupancies in Group I-3. 5. In occupancies in Groups A-4 and A-5, exit signs are not required on the seating side of vomitories or openings into seating areas where exit signs are provided in the concourse that are readily apparent from the vomitories. Egress lighting is provided to identify each vomitory or opening within the seating area in an emergency.

Status: REQUIRED

Notes:

1017.1 Exit Access Travel Distance

The common path of egress travel shall not exceed the common path of egress travel distances in Table 1017.2.

Status: OBSERVED Notes: Plans Show 90 Feet

Misc/Other

No Corrective actions needed

At time of plan review, this occupancy was found to be in compliance with adopted Fort Bend County Fire Code.

Status: SEE COMMENTS BELOW

Notes: Items marked REQUIRED are informational and items that must be complied with that will be verified during


inspections. Re-submittal and return comments are NOT necessary for items marked REQUIRED.

This review in no way excludes items that may be discovered in the field during inspect in order to comply with the applicable code or standard. Status: REQUIRED Notes:	ections. The items discovered are required to be corrected or completed
Schedule Inspections The general contractor shall schedule all inspections. Status: REQUIRED Notes: Contact the Fort Bend County Fire Marshal's Office to schedule.	dule all inspections 281-238-1500
Signed Plans and Permit The signed plans and a copy of the review letter shall be on jobsite. Status: REQUIRED Notes: A set of originally signed approved plans and this review letter and inspections	er must remain on site during construction, installations,
Additional Time Spent on Inspection:	
Category	Start Date / Time End Date / Time
Notes: No Additional time recorded	
	Total Additional Time: 0 minute Inspection Time: 15 minute Total Time: 15 minute
Summary:	
Overall Result: Plans Approved for Permit	
Inspector Notes:	
Inspector:	
Name: Porter, Daniel Rank: Inspector/Investigator Work Phone(s): 281-238-1500 Email(s): daniel.porter@fortbendcountytx.gov	
Signature	Date
Representative Signature:	
Rafig Signature	5/3/2Z Date

Requirements

Field Inspections by Fire Marshal's Office


PROPOSED WARE HOUSE LOCATED AT 18120 W BELLFORT STREET, BUILDING-T RICHMOND, TX 77407

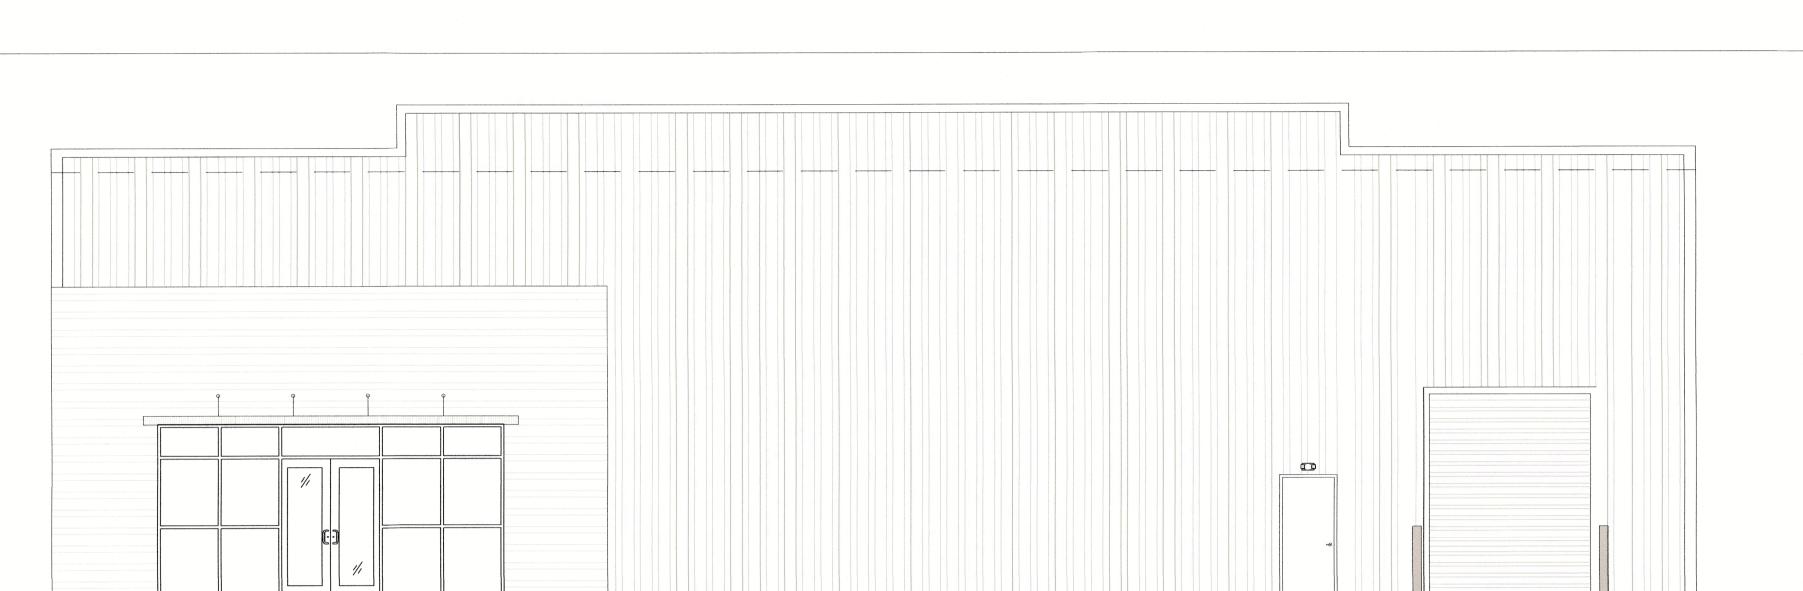

FRONT ELEVATION

PROJECT LOCATION

CATALYST TECHNICAL GROUP, INC.

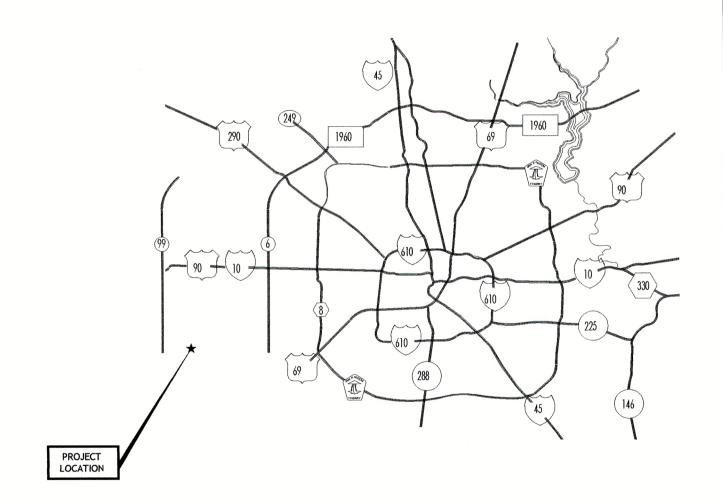

KEY MAP



SHEET INDEX

CIVIL

ARCHITECTURAL

A-0.0	COVER SHEET
A-0.1	GENERAL NOTES
A-1.0	FLOOR PLAN
A-1.1	ROOF PLAN
A-2 0	FLEVATIONS

REFLECTED CEILING PLAN DOOR AND WINDOW & FINISH SCHEDULE

REST ROOM DETAILS PARTITION WALL TYPES ada notes & details-1 ADA NOTES & DETAILS-2



CODE ANALYSIS

PROJECT DESCRIPTION

PROPOSED ONE STORY OFFICE / WARE HOUSE BUILDING W BELLFORT STREET, RICHMOND, BUILDING-C, TX 77471

PROJECT DESCRIPTION: A GROUND UP CONSTRUCTION OF A ONE STORY WARE HOUSE BUILDING (SHELL)

BUILDING CODES:

ALL WORK PROCEDURES, CRAFTSMANSHIP & CONSTRUCTION SHALL COMPLY WITH THE FOLLOWING CODES & AMENDMENTS PER THEIR ADOPTING ORDINANCES.

INTERNATIONAL FIRE CODE INTERNATIONAL MECHANICAL CODE NATIONAL ELECTRICAL CODE INTERNATIONAL PLUMBING CODE

INTERNATIONAL ENERGY CONSERVATION CODE ASHRAE 90.1.2013 ENERGY CODE

B - accessory occupancy < 10%

ALLOWABLE HEIGHT AND BUILDING SQ.FT AREA

OFFICE

WARE HOUSE OCCUPANCY GROUP : BUSSINESS (B) OCCUPANCY GROUP : STORAGE GROUP (S-2) V

TYPE OF CONSTRUCTION: TYPE II-B (NON SPRINKLED) TYPE OF CONSTRUCTION: TYPE II-B (NON SPRINKLED)

NON-SEPARATED USE AS PER SEC 508.2.3 OF IBC 2015 Office area less than 10% ALLOWABLE HEIGHT : 3 STORY (55'-0") S-2 occupancy

ALLOWABLE AREA PROPOSED HEIGHT : 1 STORY BUILDING (28'-6"-T.O.P.)
PROPOSED AREA : 5,700 Sq.Ft

MEANS OF EGRESS:

AS PER SECTION 1005 & 1005.3.2 : EGRESS WIDTH REQUIREMENT
AS PER SECTION 1016.1 EXIT ACCESS TRAVEL DISTANCE (WITHOUT SPRINKLER SYSTEM)

means of egress	REQUIRED	PROVIDED
number of exits	2	3
TRAVEL DISTANCE	200' MAXIMUM	90'-0"
SIZE OF EGRESS DOORS	(0.2" x 20) = 4" MINIMUM	36 INCH EA. x 3 = 108"

AREA & OCCUPANCY SUMMARY

ROOM NO.	ROOM NAME	SQUARE FOOTAGE	SQ-FT/ PER OCCUPANT	DESIGN LOAD
101	WARE HOUSE	5,180 Sq.Ft	500	11
102	OFFICE	520 Sq.ft.	100	6
	TOTAL SQUARE FOOT	= 3,500 Sq.ft. (GR	OSS)	
		TOTAL OC	CUPANT LOAD	17

PLUMBING FIXTURE ANALYSIS

SECTION 2902.1	MINIMUM NUMBER	OF PLUMBING	FIXTURES REQUIRED

SECTION 2702.1 MINIMON HOMBER OF LEGISLITO FIXTORES REGISLES										
CLASSIFICATION	OCCUPANCY	DESCRIPTION	WATER CLC	OSETS	LAVATO	RIES	DRINKING F	OUNTAINS	OTHE	R
			REQUIRED	PROVIDED	REQUIRED	PROVIDED	REQUIRED	PROVIDED	REQUIRED	PROVIDED
OFFICE	В	OFFICE	1 PER 25	1	1 PER 40	1	1 PER 100	1	1 SERVICE SINK	
WARE HOUSE	S-2	WARE HOUSE	1 PER 100	1	1 PER 100	1	1 PER 1,000	1	1 SERVICE SINK	

written consent of CTG, INC.

No.	DATE	\triangle	REVISIONS	

PROJECT TITLE



DATE: 4/5/2022

GENERAL NOTES:

CTG Project Number:	19-006
Drawn By:	S.K
Checked By:	T.M
Scale:	N.T.S

File Path: r:\dwg\2019 dwg\2019 commercial\19006 w bellfort oad\ctg\arch\bldg—t\a=0.0 cover sheet

SHEET TITLE: BUILDING-T

SHEET NUMBER:

COVER SHEET

A-0.0

ACC = ACCESSIBLE OR ACCESS ACT OR AT = ACOUSTICAL **CEILING TILE** ADJ = ADJOINING OR ADJACENT OR ADJUSTABLE

ADMIN = ADMINISTRATION AFF = ABOVE FINISHED FLOOR AHU = AIR HANDLING UNIT ALT = ALTERNATE ALUM OR AL = ALUMINUM APPROX = APPROXIMATE ARCH = ARCHITECTURAL AV = AUDIO VISUAL AVG = AVERAGE

BAL = BALANCE BITUM = BITUMINOUS BKG = BACKING BL = BUILDING LINEBLDG = BUILDING BLKG = BLOCKING **BOS = BOTTOM OF STEEL** BOT = BOTTOMBR = BRICKBRDG = BRIDGING BRG = BEARING BUR = BUILT-UP ROOFING

C TO C = CENTER TO CENTER CALC = CALCULATE CANT = CANTILEVER CBB OR CB = CONCRETE OR CEMENTITIOUS (BACKER) BOARD CBD = CEMENT BOARD CC = COLOR CODE CD = CONSTRUCTION DOCUMENTS OR CONTRACT DOCUMENT CI = CAST IRON CIR = CIRCLE CJ OR CJT = CONSTRUCTION JOINT OR CONTROL JOINT CL = CENTER LINE CLG = CEILING

CLR = CLEAR CMU = CONCRETE MASONRY UNIT CO = CLEANOUT COL = COLUMN COMB = COMBINATION, COMBINE COMM = COMMUNICATION CONC OR C = CONCRETE

CONT = CONTINUE CPT = CARPET TILE CR = CARD READER CSWK OR CW = CASEWORK CT = CERAMIC TILE CTB = CERAMIC TILE BASE CTF = CERAMIC TILE FLOOR CTRL = CONTROL

DB = DECIBEL DBL = DOUBLE DEL = DELETE DEPT = DEPARTMENT DET = DETAIL DIA = DIAMETER DIM = DIMENSION DIV = DIVIDE OR DIVISION DN = DOWNDOC = DOCUMENT DR = DOORDS = DOWNSPOUT DW = DISHWASHER DWG = DRAWING

ENTR = ENTRANCE EP OR EPY = EPOXY PAINT EQ = EQUALESMT = EASEMENT ETC = AND SO FORTH ET CETERA EW = EACH WAY EWC = ELECTRIC WATER COOLER EXH = EXHAUSTEXIST OR EX OR (E) = EXISTING EXP = EXPAND OR

EXPANSION OR EXPOSED EXT = EXTERIOR OR EXTERNAL E = EASTEA = EACH EIFS = EXTERIOR INSULATION

AND FINISH SYSTEM EJ OR EXP JT OR EJT = EXPANSION JOINT OC = ON CENTER EL = ELEVATION ELEC = ELECTRIC ELEV = ELEVATOR

CONTRACTOR INSTALLED OF/OI = OWNER FURNISHEDOWNER INSTALLED OH = OVERHEAD F = FEMALEOPNG = OPENING F/F = FACE TO FACEOPT = OPTIONAL FAB = FABRIC FD = FLOOR DRAIN FDC = FIRE DEPARTMENT CONNECTION PANB = PANIC BOLT FDR = FIRE DOOR PB = PAINTED BASE FDTN OR FDN OR FND = FOUNDATION PB = PANIC BAR FDV = FIRE DEPARTMENT VALVE PBD = PARTICLEBOARD FE = FIRE EXTINGUISHER PFW = POLYPROPYLENE FEC = FIRE EXTINGUISHER CABINET FF&E = FURNITURE, FIXTURE, AND FABRIC WALLCOVERING PH OR P = PANIC HARDWARE **EQUIPMENT** PCF = POUNDS PER CUBIC FFE = FINISH FLOOR ELEVATION FGL = FIBERGLASS FOOT FHC = FIRE HOSE CABINET PL = PROPERTY LINE FIG = FIGURE PLAM = PLASTIC LAMINATE FIXT = FIXTURE PLF = POUNDS PER LINEAR FLR = FLOOR **FOOT**

FP = FIRE PROTECTION OR FIRE PROOF FRA = FIRE RATED ASSEMBLY FRP = FIBER REINFORCED PLASTIC FT = FEET OR FOOT OR FIRE TREATED

FURN = FURNISH OR**FURNITURE** FW = FIRE WALL FWC = FABRIC WALLCOVERING FWP = FABRIC WRAPPED

PANEL

GA = GAUGE GAL = GALLON GALV = GALVANIZED GC = GENERAL CONTRACTOR GEN = GENERAL OR GENERATOR GI = GALVANIZED IRON

WOOD GLZ = GLAZING

GPC = GYPSUM PLASTER

GYP BD OR GYB OR GWB =

GL = GLASS

CEILING

GT = GLASS TILE

GYPSUM BOARD

HB = HOSE BIBB

HC = HANDICAP

HD = HAND DRYER

HEX = HEXAGON

HR = HANDRAIL

HVAC = HEATING,

HYD = HYDRANT

INC = INCREASE

INT = INTERIOR

AND AIR CONDITIONING

ILLUM = ILLUMINATION

INFO = INFORMATION

INSUL = INSULATION

INTERCOM OR IC =

IR = INSIDE RADIUS

JS = JANITOR'S SINK

ISO = ISOMETRIC

JAN = JANITOR

JT = JOINT

KIT = KITCHEN

KO = KNOCKOUT

KPL = KICKPLATE

LINED FIGURED

LMST = LIMESTONE

LOC = LOCATION

LP = LIGHTPROOF

MAX = MAXIMUM

LTD = LIMITED

LAM = LAMINATE

LAU OR LDRY = LAUNDRY

LF = LINEAR FEET (FOOT) OR

LM = LATEX MASTIC FLOORING

LWC = LINEAR WOOD CEILING

MATL OR MAT = MATERIAL

MECH = MECHANICAL

ELECTRICAL & PLUMBING

MISC = MISCELLANEOUS

MOD BIT = MODIFIED BITUMEN

MPC = METAL PAN CEILING

MR = MOISTURE RESISTANT

MKD = MASTERKEYED

MLWK = MILLWORK

MTL OR MET = METAL

NTS = NOT TO SCALE

OCC = OCCUPANT

PLUMB = PLUMBING

PREFAB = PREFABRICATE

PTD OR PTC = PAPER TOWEL

PVC = POLYVINYL CHLORIDE (PLASTIC)

PTN OR PART = PARTITION

PWP = PLASTIC WALL

PRELIM = PRELIMINARY

PRES = PLASTIC RESIN

PROJ = PROJECT

PROP = PROPERTY

PS = PULL STATION

PT OR P = PAINT

DISPENSER

PROTECTION

PP = PUSH PLATE

OF/CI = OWNER FURNISHED/

MW OR MICRO =

MICROWAVE

N = NORTH

NO = NUMBER

OA = OVERALL

MF = MILL FINISH OR MASTIC

MEMB = MEMBRANE

MEP = MECHANICAL

MFR OR MFG =

MANUFACTURER

MIN = MINIMUM

LAV OR L = LAVATORY

INTERCOMMUNICATION

J-BOX OR JB = JUNCTION BOX

HT = HEIGHT

HTR = HEATER

VENTILATING,

HLDN = HOLDDOWN

HM = HOLLOW METAL

HORIZ = HORIZONTAL

HDW OR HDWR OR HW =

GYM = GYMNASIUM

GYP SHTG = GYPSUM

GT = GROUT

SHEATHING

HARDWARE

 $\overline{R} = RADIUS$ R = RISERRB = RUBBER BASE GLU LAM = GLUED LAMINATED RBRB = RUBBER BASE RC = REINFORCED CONCRETE GMKD GRAND MASTER KEYED RCP = REFLECTED CEILING

QT = QUARRY TILE

QTY = QUANTITY

QTB = QUARRY TILE BASE

QTF = QUARRY TILE FLOOR

RD = ROOF DRAIN REC = RECESSED RECP = RECEPTION REF OR REFR = REFRIGERATOR REINF = REINFORCE REQ OR REQD = REQUIRE OR REQUIRED REST = RESTROOMREV = REVISION OR REVERSE RF = RESILIENT FLOORING RFS = ROOM FINISHES

SCHEDULE RM = ROOMRO = ROUGH OPENING **ROW = RIGHT OF WAY** RR = REST ROOMRTF = RUBBER TILE FLOOR RTG = RATING RTU = ROOF TOP UNIT

S = SOUTH OR SINK SAN = SANITARYSC = SPECIAL COATING, HIGH BUILD GLAZED COATING SCH = SCHEDULE SECT = SECTION SHDR OR SD = SHOWER DRAIN SP = STANDPIPESPEC = SPECIFICATION SS = SANITARY SEWER STC = SOUND TRANSMISSION CLASS ST OR STNT = STONE TILE STD = STANDARD STRUCT = STRUCTURAL SV = SHEET VINYL

SWDR = SWING DOOR SYM = SYMBOLSYS = SYSTEM $\overline{T} = THERMOSTRAT$ TC = TERRA COTTA

TECH = TECHNICAL TEL= TELEPHONE TEMP = TEMPORARY THK = THICKNESS TR = TREAD OR TOWEL RACK TMPD GL OR GL (T) =TEMPERED GLASS TOB = TOP OF BEARING TOS = TOP OF STEEL TS = TUBULAR STEEL

UL = UNDERWRITERS LABORATORIES UNO = UNLESS NOTED **OTHERWISE** UON = UNLESS OTHERWISE NOTED

VAR = VARIATION OR VARIES VAN = VANITYVB = VINYL BASE VCT = VINYL COMPOSITION


VENT = VENTILATION OR VENTILATOR VERT = VERTICAL VIF = VERIFY IN FIELD VP = VANEER PLASTER VTR = VENT THROUGH ROOF VR = VAPOR RETARDER VWC = VINYL WALL COVERING


VWF = VINYL WALL FABRIC

W = WESTW/ = WITHW/O = WITHOUTWB OR WDB = WOOD BASE WC = WATER CLOSET WD = WOODWFAB OR WF = WALL FABRIC WH = WEEP HOLE WP = WALL PROTECTION WPM = WATERPROOF **MEMBRANE** WR = WEATHER RESISTANT WS = WEATHERSTRIP WSCT = WAINSCOT WT = WATERTIGHT WWF = WELDED WIRE FABRIC WPM = WATER PROOFING

MEMBRANE XPS = EXTRUDED POLYSTYRENE BOARD $\overline{YD} = YARD$

DRAWING SYMBOLOGY LEGEND

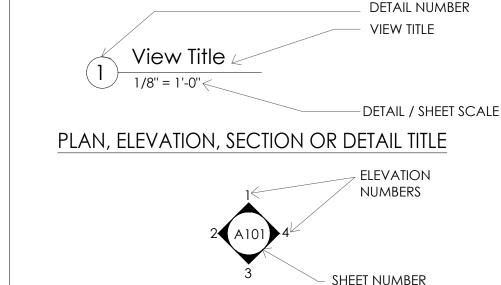

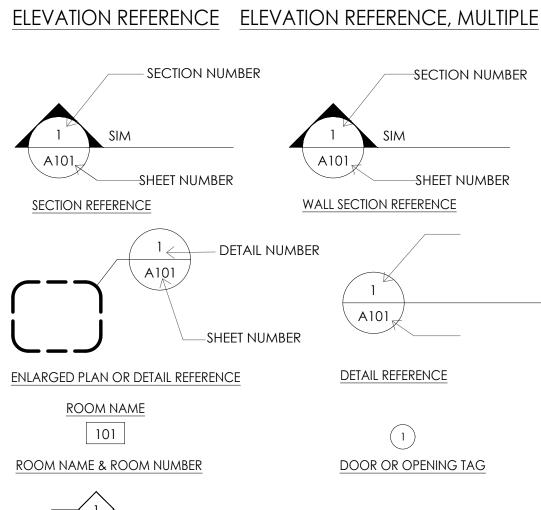

SEE PARTITION SHEET FOR TAG INFO. WINDOW, LOUVER OR **CURTAINWALL TYPE** PARTITION TYPE **KEYNOTES** - CEILING TYPE 8'-6" ACT-1

HEIGHT ABOVE 8'-0" AFL < FLOOR LEVEL **CEILING TAG** ELEVATION SYMBOL,

MATCH LINE INDICATOR

PHYSICAL ACCESSIBLE

DESIGNATED ROOM.

ELEVATION SYMBOL

<u>GRIDS</u>

IDENTIFICATION

ACCESSIBLITY SYMBOLOGY LEGEND THESE CODE REQUIRED CLEARANCE MUST BE ME CLEAR FLOOR SPACE 4'-0"

3'-0" TURNING SPACE 5'-0" IF BOTH CLOSER AND LATCH PROVIDED DOOR CLEARANCES. FRONT APPROACHES INDICATED, SEE PLANS AND CODES FOR SIDE APPROACHES. 1'-6" **GENERAL NOTES**

1. ALL CONSTRUCTION SHALL CONFORM TO THE MINIMUM STANDARDS OF THE APPLICABLE CODE INDICATED IN THE BUILDING SUMMARY COLUMN AND ALL LOCAL, STATE AND NATIONAL CODE ORDINANCES PRESENTLY IN EFFECT UNLESS MORE STRINGENT REQUIREMENTS ARE INDICATED.

2. ALL NEW CONSTRUCTION SHALL COMPLY W/THE AMERICANS WITH DISABILITIES ACT ACCESSIBILITY GUIDELINES (ADAAG) AND CHAPTER 11 OF THE INTERNATIONAL BUILDING CODE (INCLUDES ICC A117.1 PER IBC)

3. THE GENERAL CONTRACTOR SHALL BE RESPONSIBLE FOR COORDINATING BUILDING & SITE UTILITIES BETWEEN CIVIL & MEP DRAWINGS. THE CONTRACTOR SHALL ALSO CONTACT ALL APPLICABLE UTILITY COMPANIES & PROVIDE CONDUIT & OTHER FACILITIES AS REQUIRED.

4. THE GENERAL CONTRACTOR AND ALL SUBCONTRACTORS SHALL VERIFY ALL DIMENSIONS & CONDITIONS ON THE JOB SITE PRIOR TO THE BIDDING OF THE CONTRACT DOCUMENTS. THE CONTRACTOR SHALL NOTIFY THE ARCHITECT IMMEDIATELY OF ANY DISCREPANCIES. IN CASES OF DISCREPANCY CONCERNING DIMENSIONS, QUANTITIES AND LOCATION, THE CONTRACTOR SHALL, IN WRITING, CALL TO THE ATTENTION OF THE ARCHITECT ANY DISCREPANCIES BETWEEN SPECIFICATIONS, PLANS, DETAILS OR SCHEDULES. THE

ARCHITECT WILL THEN INFORM THE CONTRACTOR, IN WRITING, WHICH DOCUMENT TAKES PRECEDENCE. THERE SHALL BE NO ADJUSTMENT TO THE COST OR TIME OF THE WORK RESULTING FROM CLARIFICATION OF SUCH DISCREPANCIES.

5. ALL MATERIALS SPECIFIED OR NOTED SHALL BE INSTALLED IN ACCORDANCE WITH THE MANUFACTURERS RECOMMENDATIONS.

6. THE GENERAL CONTRACTOR AND SUBCONTRACTORS SHALL OBTAIN AND PAY FOR ALL REQUIRED PERMITS, LICENSES, AND ALL UTILITY CHARGES, AND ARRANGE FOR ALL REQUIRED INSPECTIONS.

7. DIMENSIONS ON DRAWINGS ARE SHOWN TO FINISHED FACE OF WALLS AND PARTITIONS OF EXISTING OR NEW CONSTRUCTION UNLESS OTHERWISE NOTED. CEILING HEIGHT DIMENSIONS AND ALL OTHER VERTICAL DIMENSIONS ARE TO THE FINISHED FLOOR SURFACE UNLESS OTHERWISE NOTED.

8. THE CONTRACTOR SHALL BE RESPONSIBLE FOR SUBMITTING SHOP DRAWINGS, PRODUCT DATA, OR SAMPLES FOR CASEWORK, FINISHES, DOORS, FRAMES, HARDWARE, MECHANICAL, ELECTRICAL, AND PLUMBING FIXTURES, AND OTHER ITEMS REQUIRING ARCHITECT'S REVIEW FOR CONFORMANCE WITH THE CONTRACT DOCUMENTS, AND FOR ALL ITEMS WHICH ALLOWED CONTRACTOR OPTIONS. PRIOR TO FORWARDING TO THE ARCHITECT FOR REVIEW. THESE SUBMITTALS MUST BE REVIEWED BY THE CONTRACTOR FOR CONFORMANCE WITH THE MEANS, METHODS, TECHNIQUES, SEQUENCES, AND OPERATIONS OF CONSTRUCTION AND SAFETY PRECAUTIONS AND PROGRAMS INCIDENTAL THERETO, ALL OF WHICH ARE THE SOLE RESPONSIBILITY OF THE CONTRACTOR. THE

CONTRACTOR SHALL AFFIX A STAMP TO SUBMITTAL INDICATING HIS REVIEW, SUBMITTALS FORWARDED WITHOUT A STAMP WILL BE RETURNED. ALL SUBMITTALS MUST BE REVIEWED BY THE ARCHITECT PRIOR TO CONSTRUCTION.

9. CONTRACTOR SHALL GUARANTEE ALL WORK AGAINST FAULT OF ANY MATERIAL OR WORKMANSHIP FOR A PERIOD OF NOT LESS THAN ONE YEAR AFTER COMPLETION OR ACCEPTANCE, FAULTY WORK SHALL BE REPLACED OR REPAIRED AS REQUIRED AT NO COST TO THE OWNER.

10. CONTRACTOR SHALL COORDINATE WITH OWNER ALL ITEMS TO BE SALVAGED PRIOR TO SUBMISSION OF BIDS AND START OF CONSTRUCTION. OWNER SHALL HAVE SALVAGE RIGHTS TO RETAIN ALL REMOVED ITEMS.

11. ALL CHANGES PROPOSED DURING CONSTRUCTION WHICH RESULT IN A CHANGE TO THE CONTRACT TIME AND/OR SUM SHALL BE SUBMITTED TO THE ARCHITECT IN WRITING AND APPROVED BY THE ARCHITECT AND OWNER BEFORE SUCH WORK SHALL COMMENCE.

12. CONTRACTOR SHALL COORDINATE CLEAR OPENINGS FOR ALL APPLIANCES PRIOR TO CONSTRUCTION OF CASEWORK.

13. CONTRACTOR SHALL FURNISH AND INSTALL CONCEALED FIRE-RETARDANT TREATED WOOD BLOCKING BEHIND ALL CABINETS, TOILET ACCESSORIES, PLUMBING FIXTURES, AND OTHER WALL MOUNTED ITEMS AS REQUIRED FOR ADEQUATE SUPPORT.

14. CONTRACTOR SHALL COORDINATE ALL LOCK AND LATCH SETS AND FINAL KEYING WITH OWNER. DOUBLE KEYED LOCKS ARE NOT PERMITTED ON ANY REQUIRED OR MARKED EXIT. MATCH EXISTING KEYING SYSTEM IF ONE IS EXISTING.

15. ALL DOOR HARDWARE ON EXIT DOORS SHALL BE READILY OPERABLE FROM THE EGRESS SIDE WITHOUT THE USE OF A KEY, SPECIAL KNOWLEDGE, OR EFFORT.

16. CONTRACTOR SHALL PREPARE ALL NEW AND EXISTING SURFACES SCHEDULED TO RECEIVE NEW FINISHES IN ACCORDANCE WITH THE MANUFACTURER'S RECOMMENDATIONS FOR THE SUBSTRATE & FINISH BEING APPLIED.

17. CONTRACTOR SHALL BE RESPONSIBLE FOR PROTECTION OF ALL EXISTING CONSTRUCTION INDICATED TO REMAIN AND SHALL REPAIR AND/OR REPLACE ALL AREAS AND/OR MATERIALS DAMAGED DURING CONSTRUCTION AT A MINIMUM TO THE CONDITION WHICH EXISTED PRIOR TO

18. CONTRACTOR SHALL COORDINATE FINAL QUANTITY AND LOCATIONS OF FIRE EXTINGUISHERS WITH THE FIRE DEPARTMENT AND/OR BUILDING DEPARTMENT. SEE SYMBOLS LEGEND FOR TYPE OF EXTINGUISHER.

19. ALL CONSTRUCTION MATERIALS EXPOSED WITHIN PLENUMS SHALL BE NON-COMBUSTIBLE OR SHALL HAVE A MAXIMUM FLAME SPREAD RATING OF 25 AND MAXIMUM SMOKE DEVELOPED RATING OF 50.

20. ALL PIPING, LOW VOLTAGE WIRE AND CABLE, OPTICAL FIBER, PNEUMATIC TUBING, AND ALL DUCT AND DUCT COVERINGS, LININGS AND CONNECTORS INSTALLED WITHIN PLENUMS MUST BE RATED FOR

PLENUM USE. 21. TENANT SHALL BE RESPONSIBLE FOR COORDINATION AND INSTALLATION OF VOICE AND DATA

22. CONTRACTOR SHALL BE RESPONSIBLE FOR THE DESIGN OF THE AUTOMATIC SPRINKLER SYSTEM. THE DESIGN SHALL BE PER NFPA REQUIREMENTS.

23. ALL NEW GLASS AND GLAZING LOCATED IN HAZARDOUS LOCATIONS AS DEFINED IN IBC SECTION

2406.3 SHALL MEET THE REQUIREMENTS FOR SAFETY GLAZING AS DEFINED IN IBC SECTION 2406. 24. IF THE CONTRACTOR FAILS TO SUBMIT A MATERIAL FOR APPROVAL, THE MATERIAL MAY BE

REQUIRED TO BE REMOVED BY THE CONTRACTOR EITHER BY DIRECTION OF THE OWNER 25. INSTALL ELASTOMERIC JOINT SEALER AROUND ALL PIPES, DUCTWORK, & STRUCTURE PASSING THRU

INTERIOR NON-RATED CONCRETE AND MASONRY WALLS, GYPSUM BOARD PARTITIONS, AND CONCRETE FLOOR/ROOF SLABS. FOR FIRE RATED INTERIOR CONCRETE AND MASONRY WALLS, GYPSUM BOARD PARTITIONS, AND CONCRETE FLOOR/ROOF SLABS SEAL ALL PIPES, DUCTWORK, AND STRUCTURE. INSTALL FIRESTOP MATERIALS IN ALL GAPS PRIOR TO SEALANT APPLICATION. INSTALL SEALER ACCORDING TO MANUFACTURER'S WRITTEN INSTRUCTIONS.

26.CONTRACTOR SHALL OBTAIN AND SUBMIT ALL REQUIRED CERTIFICATES OF INSURANCE TO THE OWNER'S AND LANDLORD'S REPRESENTATIVE PRIOR TO COMMENCEMENT OF ANY WORK.

27. ----NOT USED-

CABLING AND EQUIPMENT.

28.THE CONTRACTOR SHALL MAINTAIN THE PREMISES IN A CLEAN AND ORDERLY FASHION DURING THE DURATION OF CONSTRUCTION PERIOD. THE LANDLORD'S TRASH FACILITIES SHALL NOT BE USED FOR CONSTRUCTION TRASH AND DEBRIS.

29.ALL WORK UNDER THIS CONTRACT SHALL BE PERFORMED BY COMPETENT WORKMEN AND EXECUTED IN A NEAT WORKMEN LIKE MANNER. THE TENANT SHALL REQUIRE EXTENDED WARRANTIES ON SOME EQUIPMENT.

30.NO PENETRATION SHALL OCCUR WITHIN 12" OF ANY OTHER ROOF PENETRATIONS, EXPANSION JOINT OR EDGE DETAIL.

31.ALL MATERIALS FOR PARTITIONS, WALLS, CEILINGS AND FINISHES SHALL BE APPROVED NON-COMBUSTUBLE MATERIALS.

32.THE CONTRACTOR SHALL SAW CUT AND EXCAVATE ANY CONCRETE REQUIRED FOR ELECTRICAL, PLUMBING OR PIPING INSTALLATION REQUIRED BY VENDORS OR SHOWN ON DRAWINGS. BACK FILL WITH SAND COMPACTED TO 95 PROCTOR NEW REINFORCING SHALL BE INSTALLED AS PART OF CRITERIA CONSTRUCTION REQUIREMENT.

uite #1503 Katy, TX 77494 Ph: 832-913-1888 into@texasctgroup.cor www.texasctgroup.cor Γ.B.P.E FIRM # 15775

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PROJECT TITLE

П

ME Щ Ш 20

SEAL



DATE: 4/5/2022

GENERAL NOTES:

CTG Project Number: 19-006 Drawn By: S.K Checked By T.M

N.T.S

Scale: File Path:


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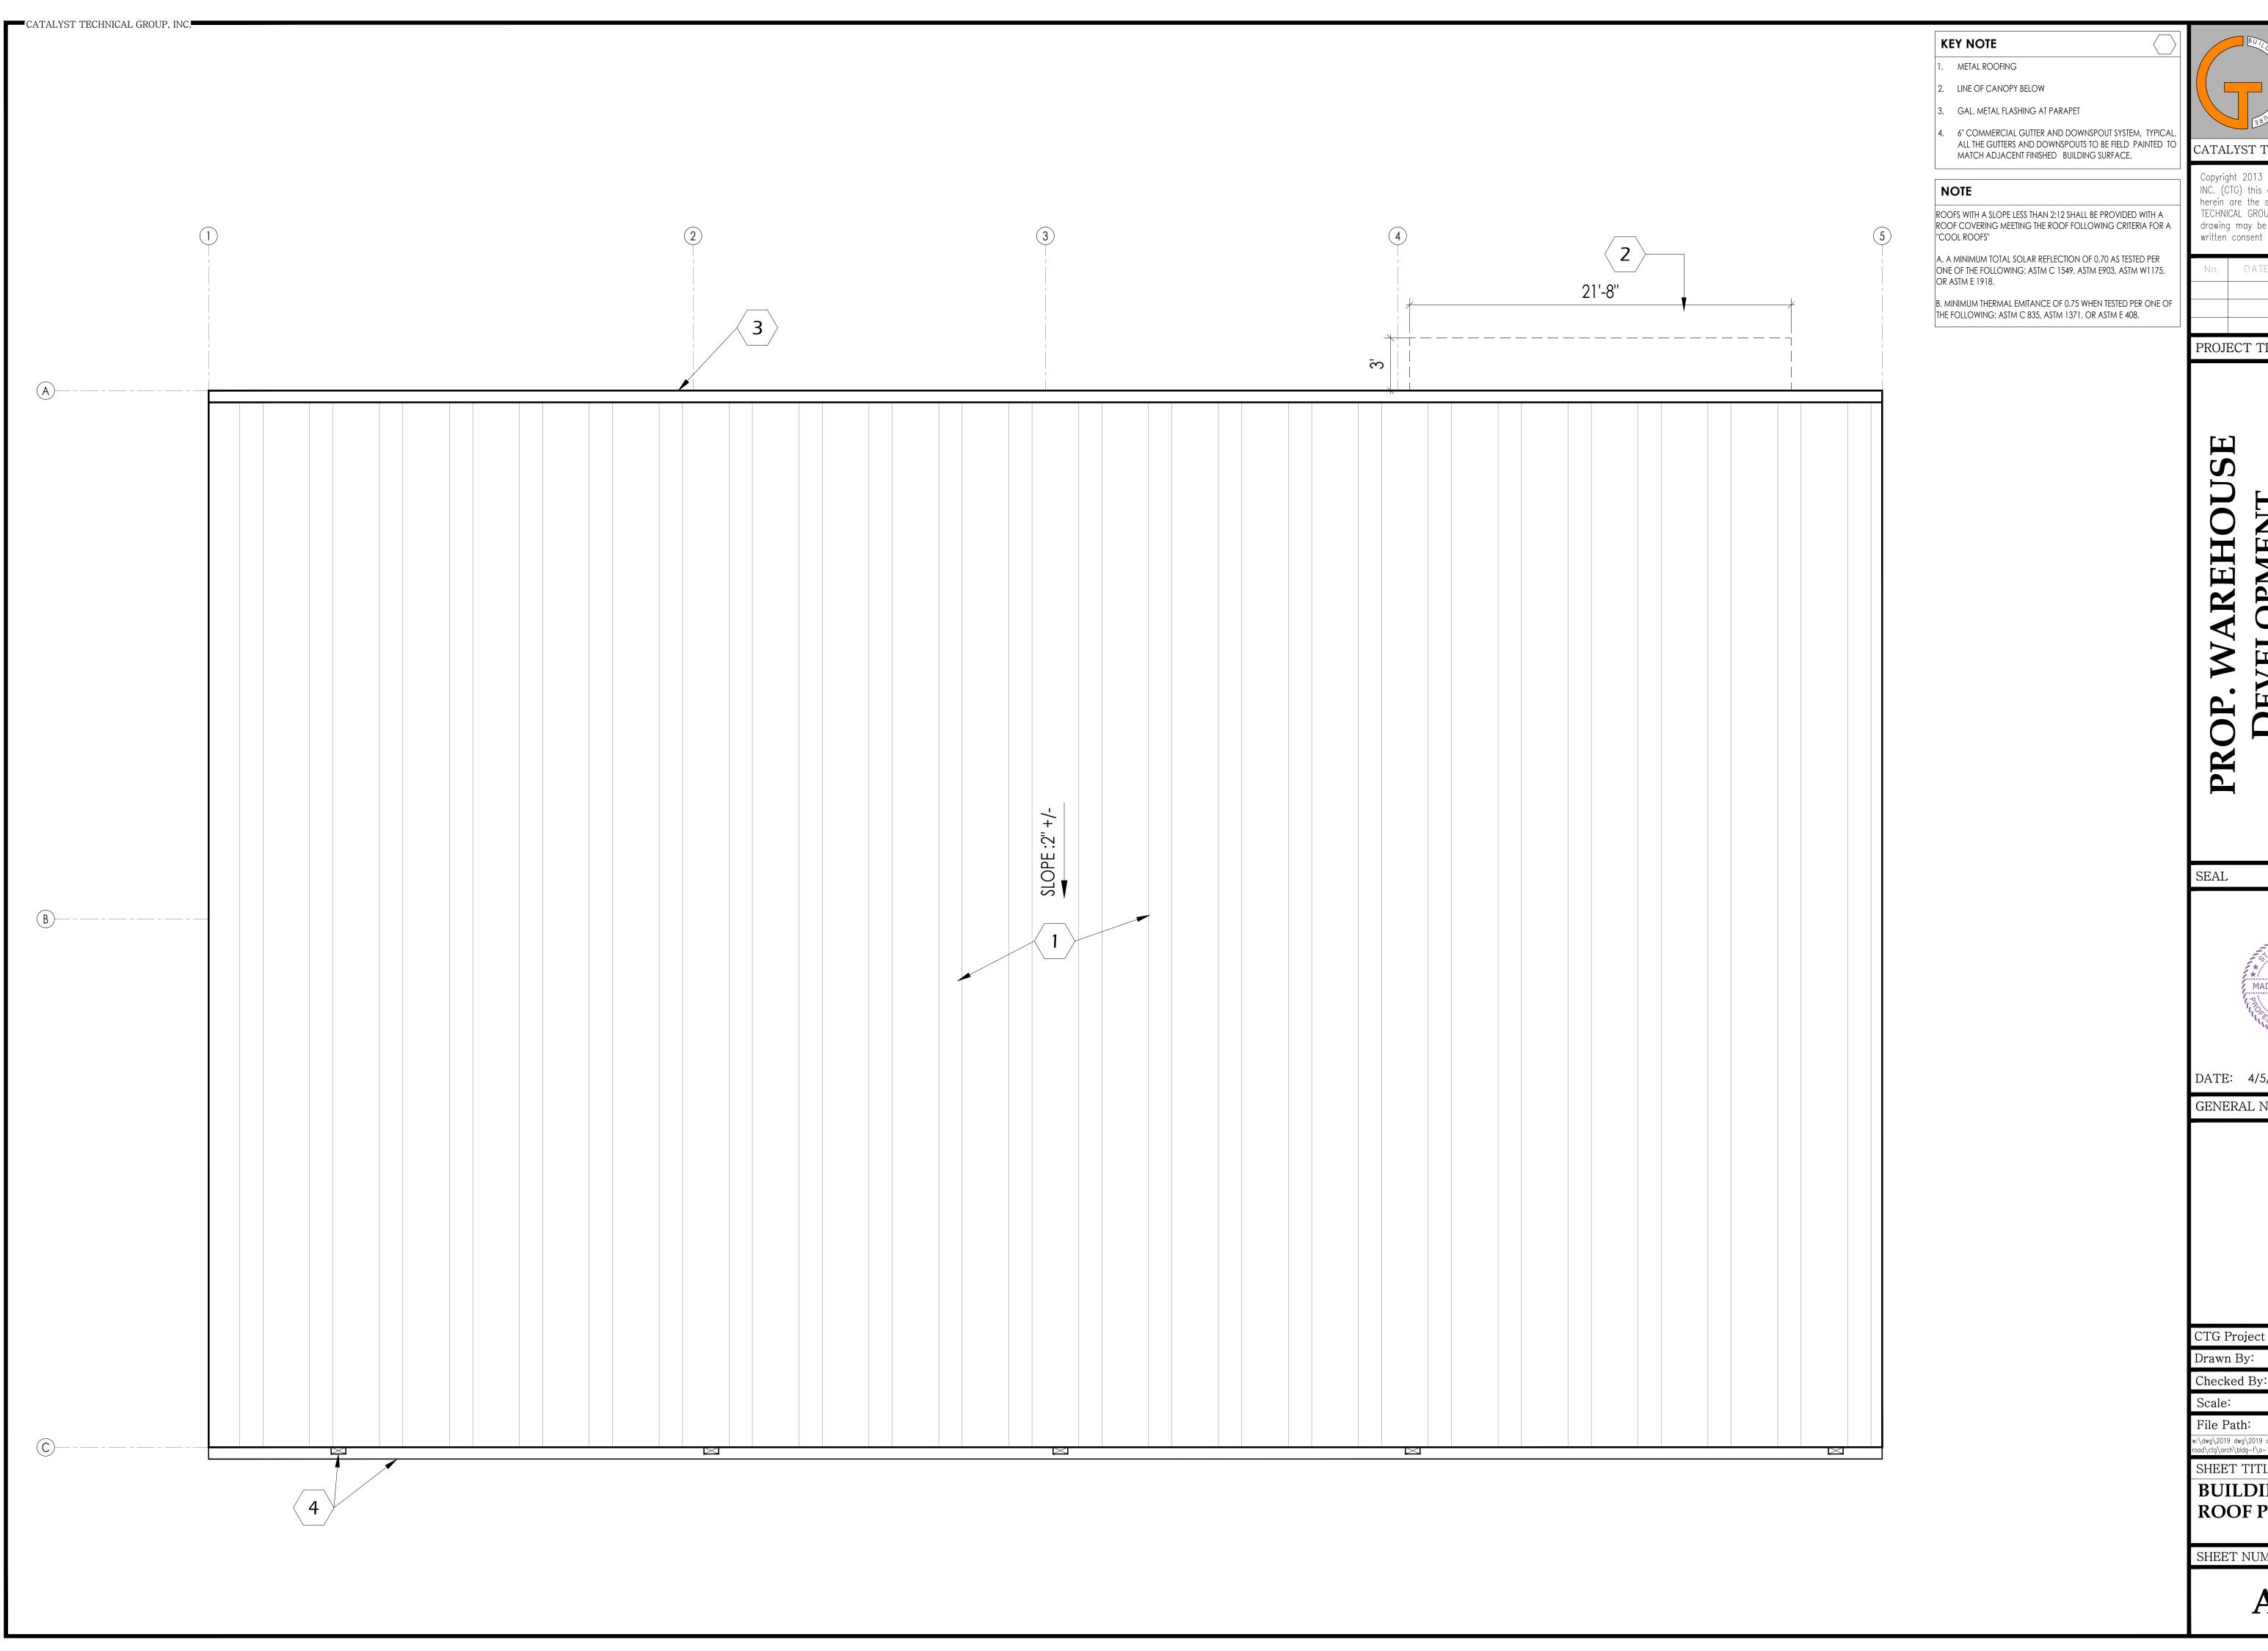
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GENERAL NOTES

SHEET NUMBER:

A-0.1



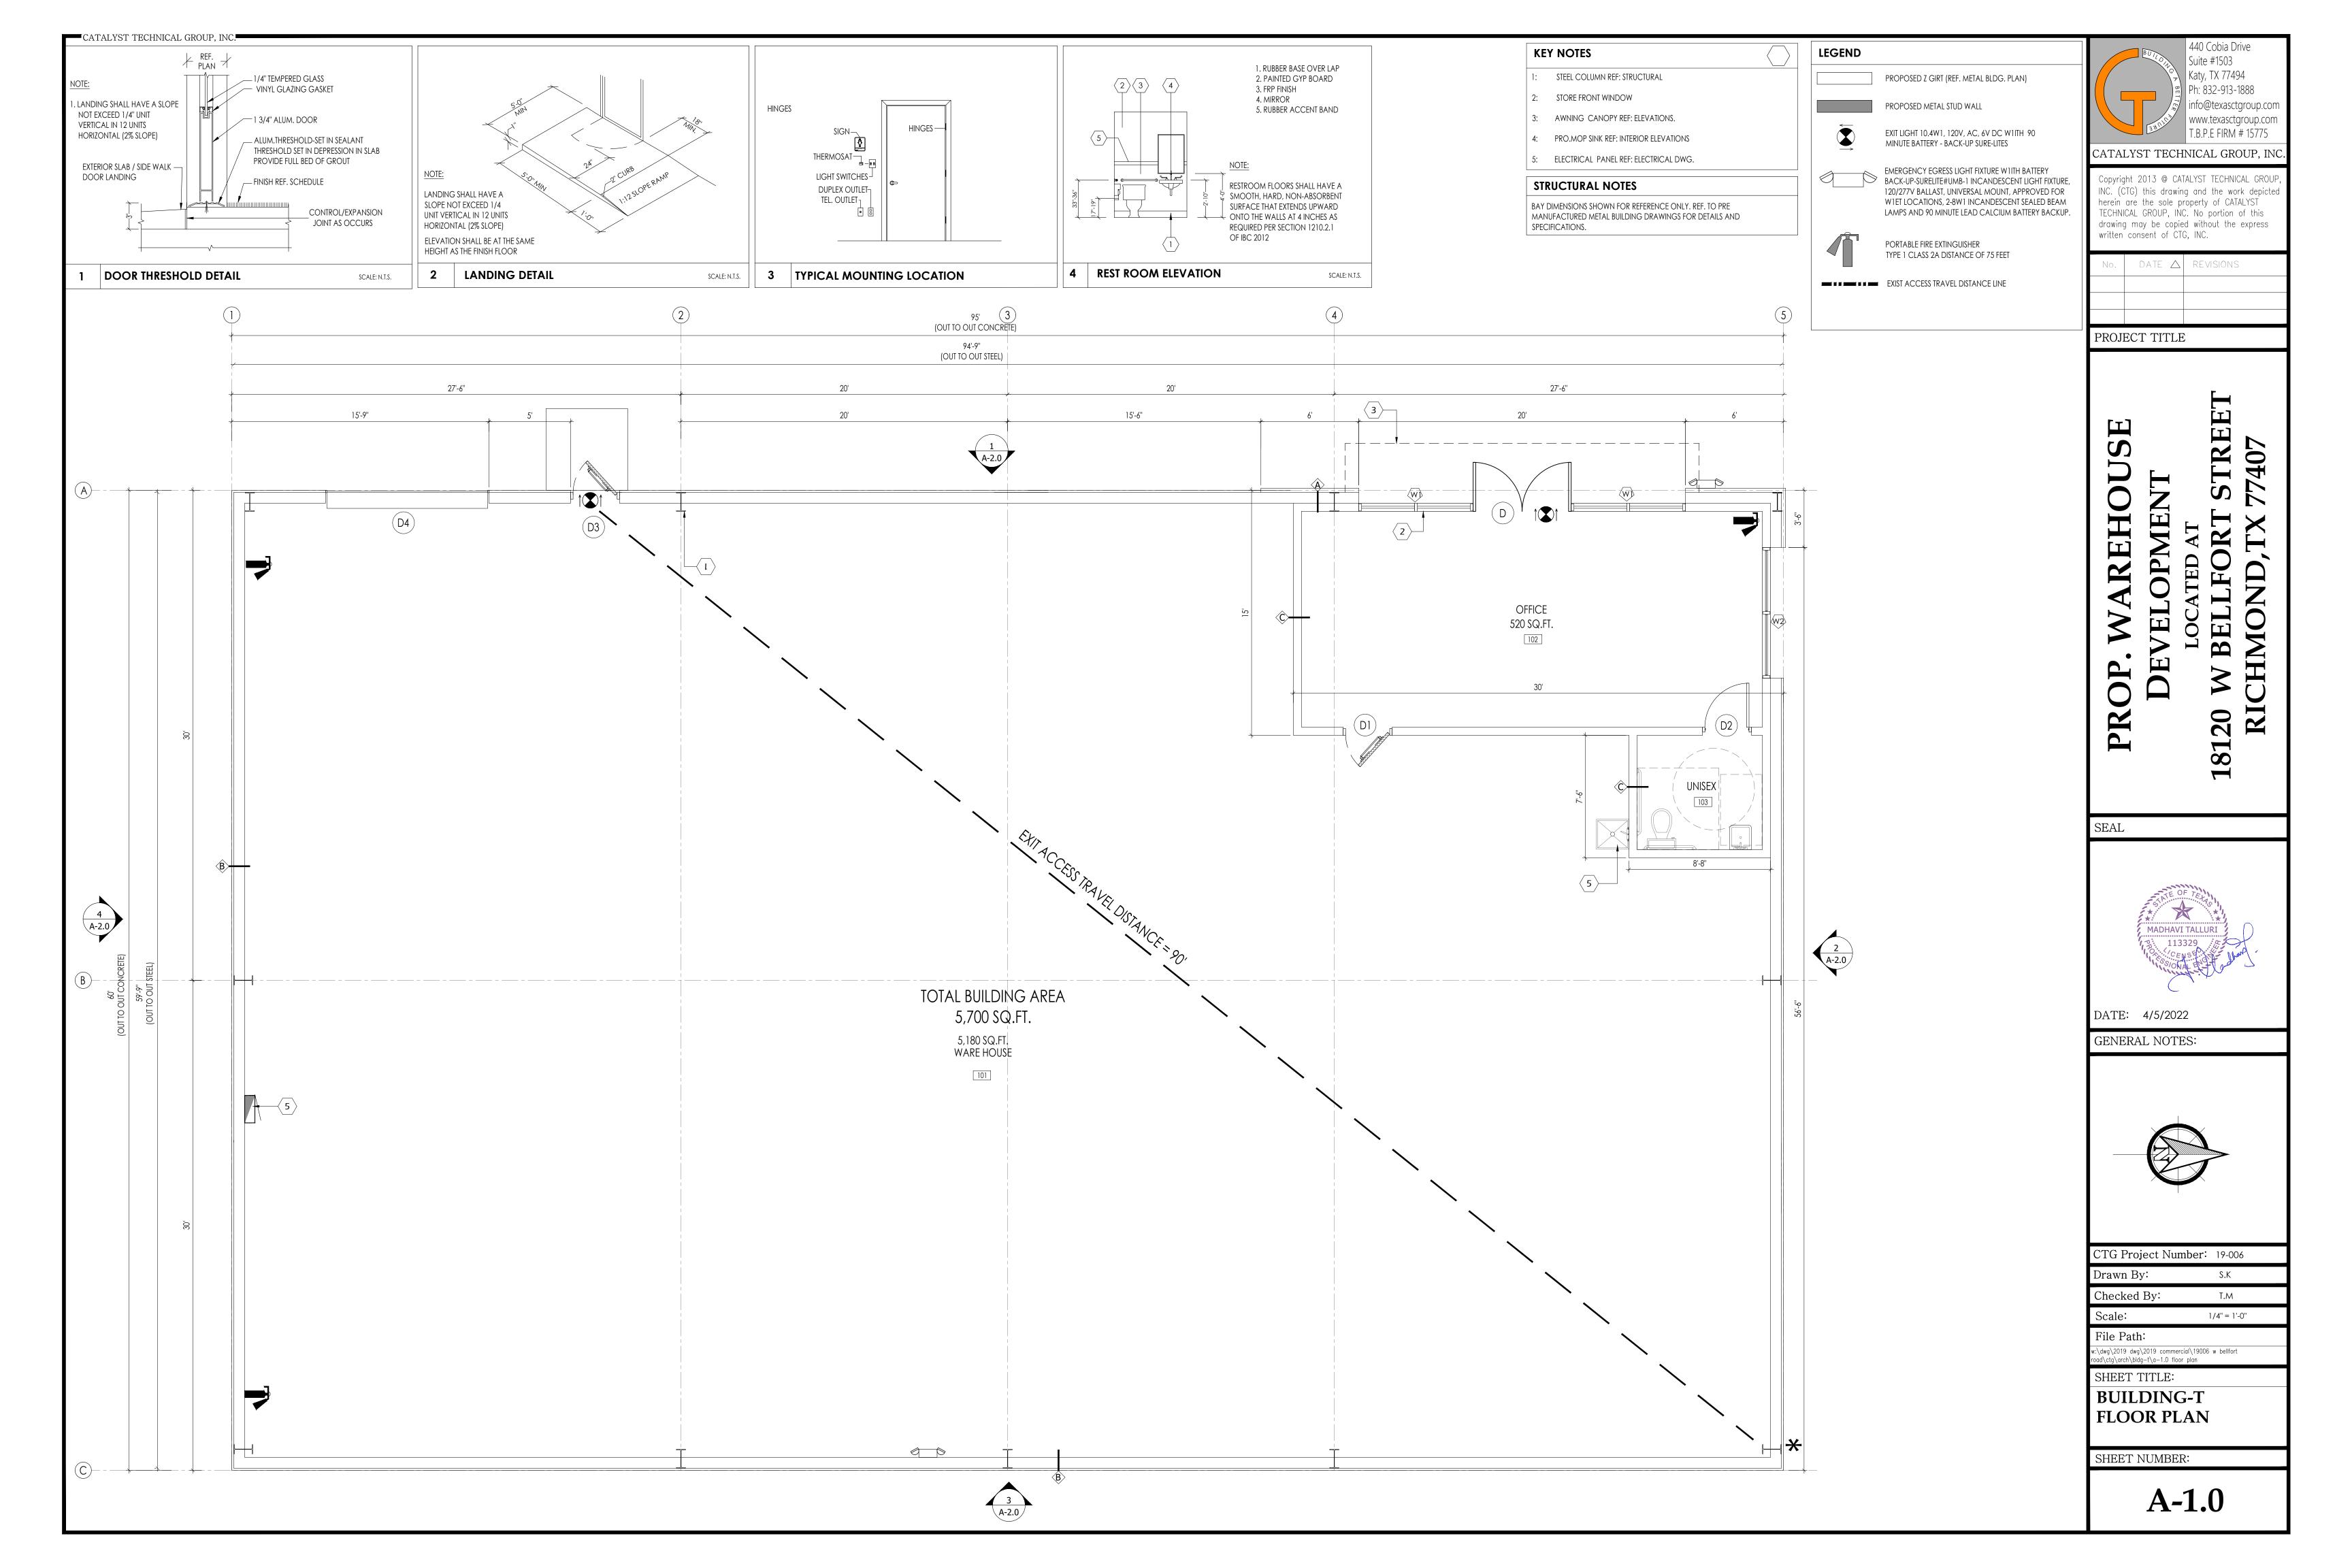

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PROJECT TITLE



DATE: 4/5/2022

GENERAL NOTES:

CTG Project Number: 19-006


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oad\ctg\arch\bldg-t\a-1.1 roof plan

SHEET TITLE:

BUILDING-T ROOF PLAN

SHEET NUMBER:

A-1.1

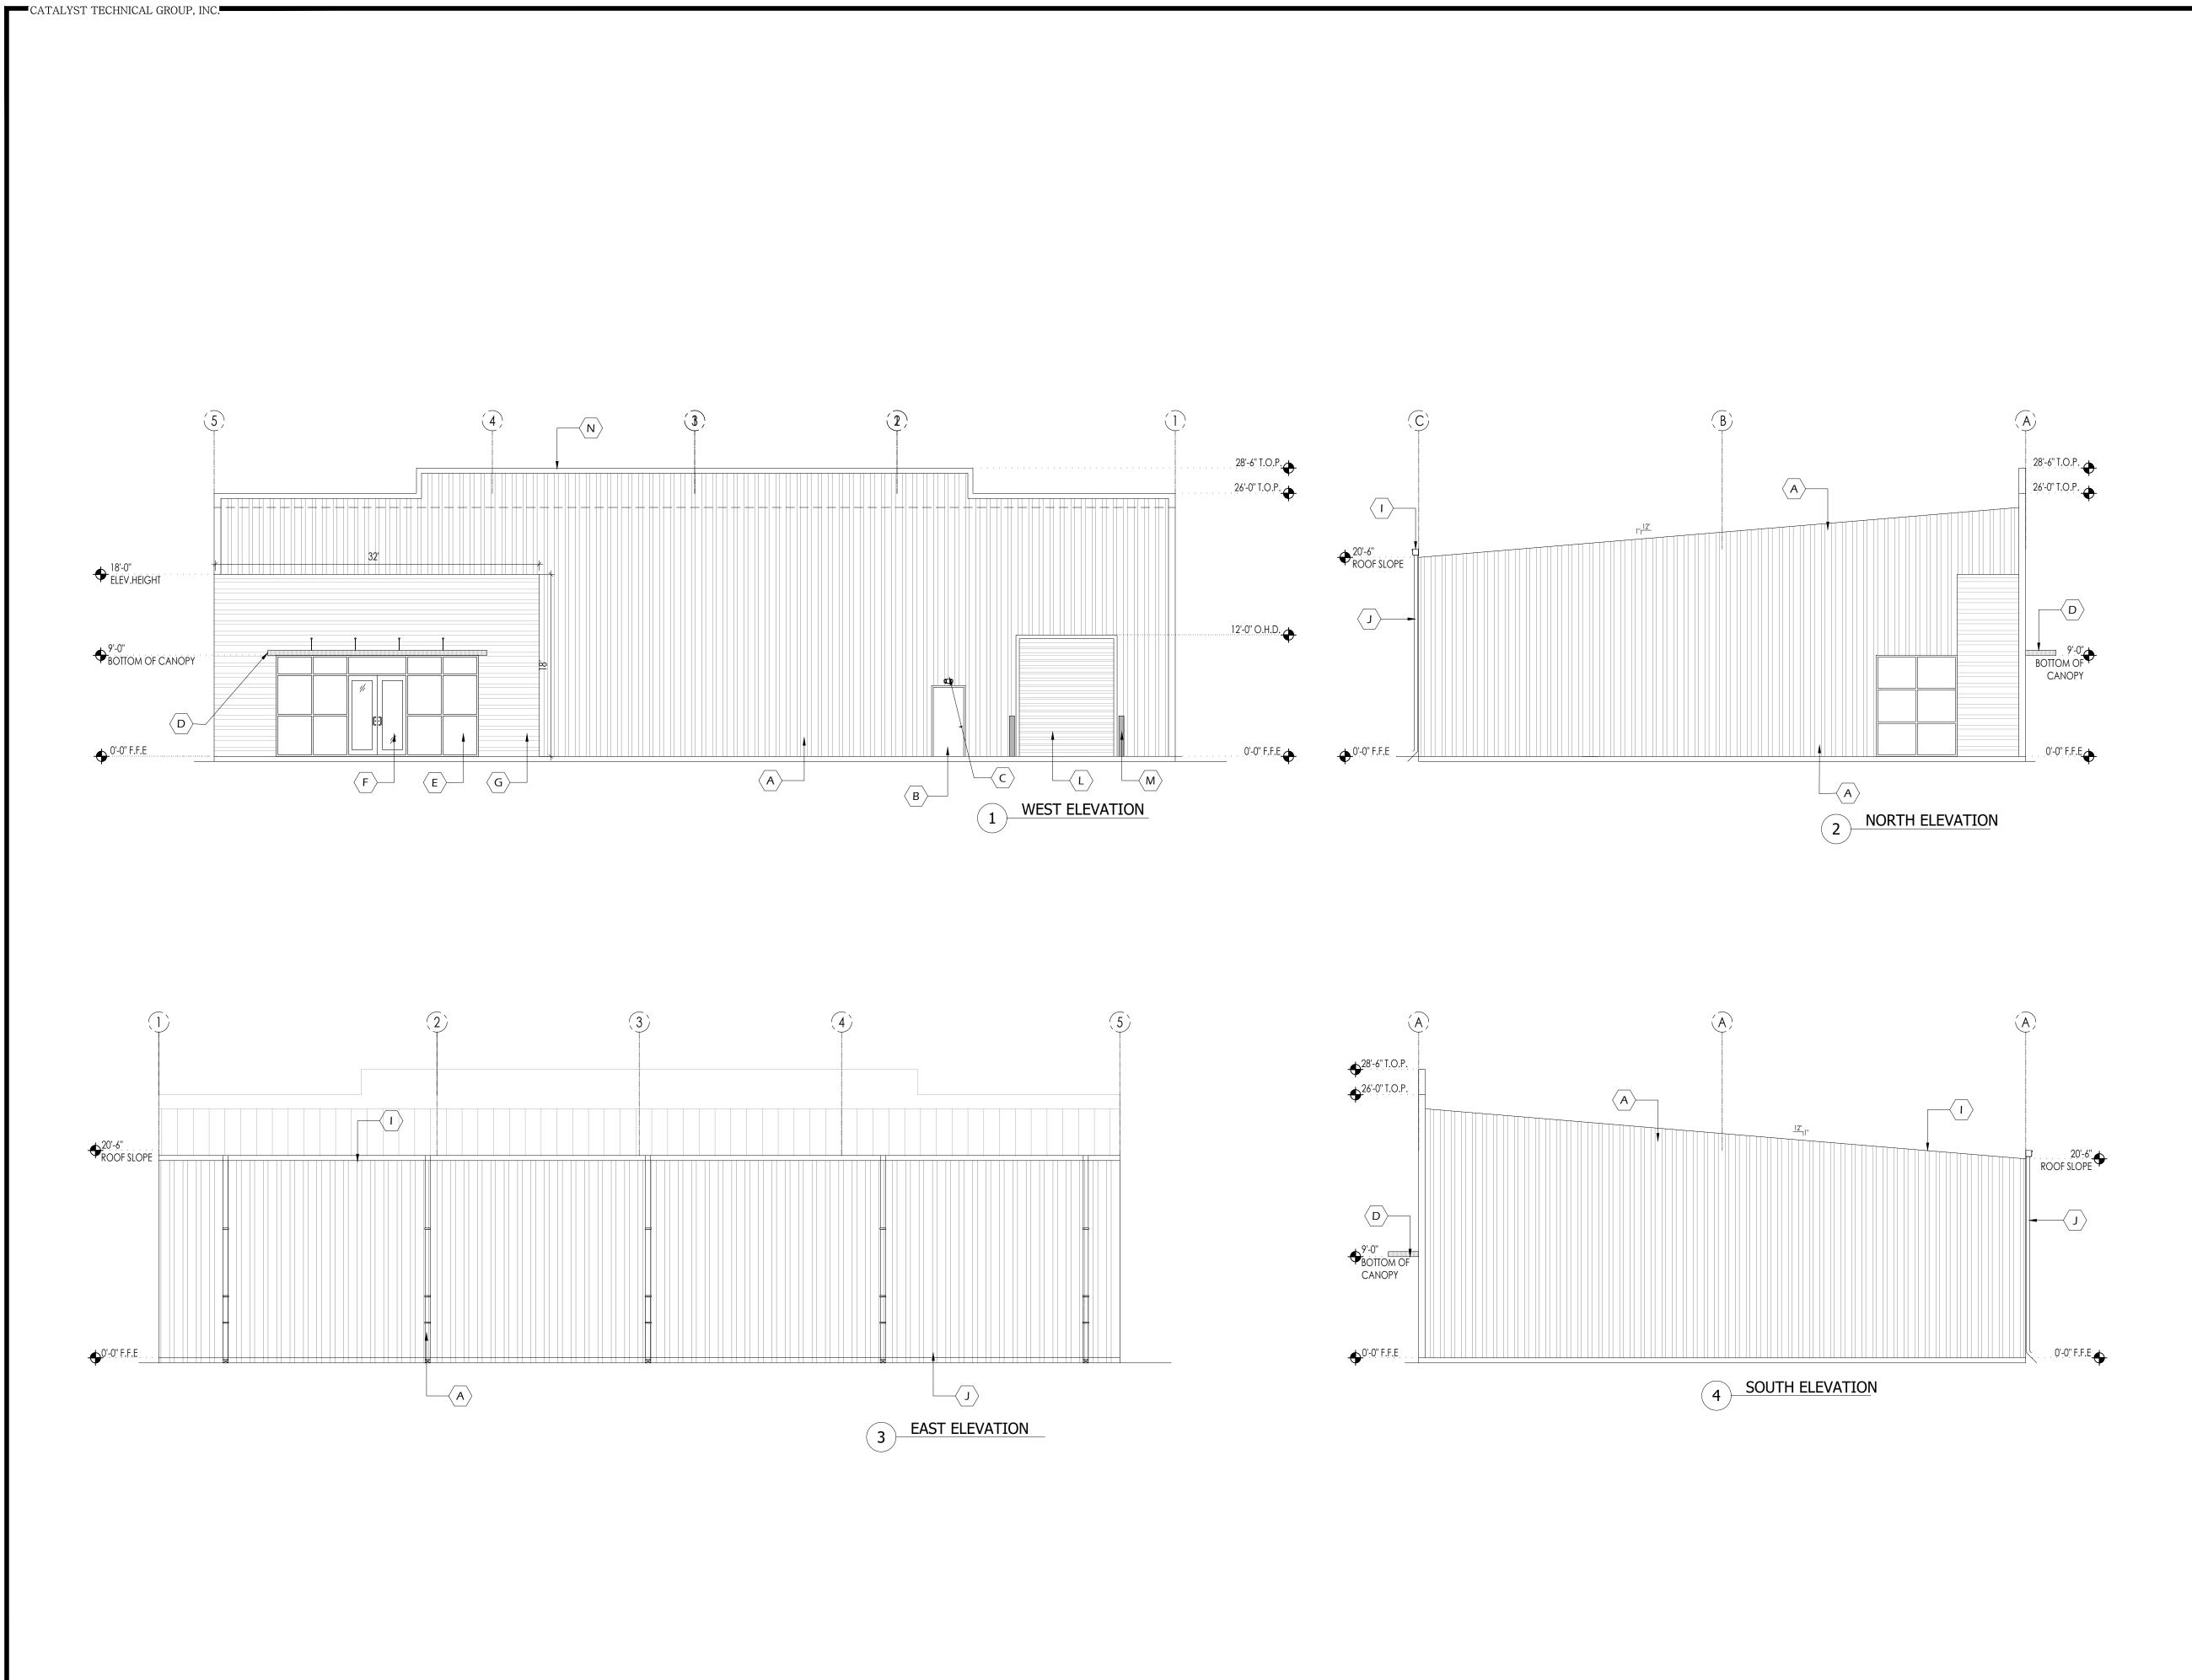


KEY NOTES

- A. KYNAR 500 (OR) HYLAR 5000 SNOW WHITE PANELS
- B. EMERGENCY EXIT DOOR (COLOR BY OWNER)
- C. EXTERIOR EGRESS LIGHTING (REF. ELECTRICAL DRAWING)
- INSTALL AWNING WITH BOTTOM AT +10' -0" ABOVE FINISHED FLOOR LEVEL. REF: ELEVATIONS.
- ALUMINUM STOREFRONT WINDOW SYSTEM (COLOR BY OWNER). PROVIDE DOUBLE GLAZED, THERMALLY BROKEN, LOW E CLEAR GLAZING. MAXIMUM SHADING CO-EFFICIENT OF 50 OR LESS (TEMPERED). VERIFY ALL FRAME, GLASS SPECIFICATIONS & COLOR SELECTIONS W / OWNER / ARCHITECT. SUBMIT SHOP DRAWINGS FOR REVIEW. ADD ALTERNATE FOR IMPACT RESISTANT SYSTEM.
- ALUMINUM STOREFRONT ENTRANCE, MEDIUM STILE W / DOUBLE GLAZED, THERMALLY BROKEN, 1/4" THICK TEMPERED GLASS. CLEAR TINT, MAX. SHADING COEFFICIENT OF 80 OR LESS. FRAME COLOR BY OWNER
- G. KYNAR 500 SLATE GRAY COLOR METAL PANEL (OR APPROVE EQ.)
- H. PARAPET WALL
- **ROOF GUTTER**
- J. DOWN SPOUTS (COLOR SAME AS PAINTED CMU)
- K. NOT USED
- OVER HEAD DOOR
- M. BOLLARDS
- N. TRIM (KYNAR 500 SLATE GRAY COLOR OR APPROVE EQ.)

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PROJECT TITLE

SEAL

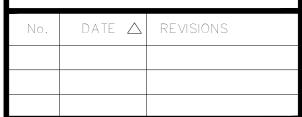

DATE: 1/6/2023

GENERAL NOTES:

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Checked By:


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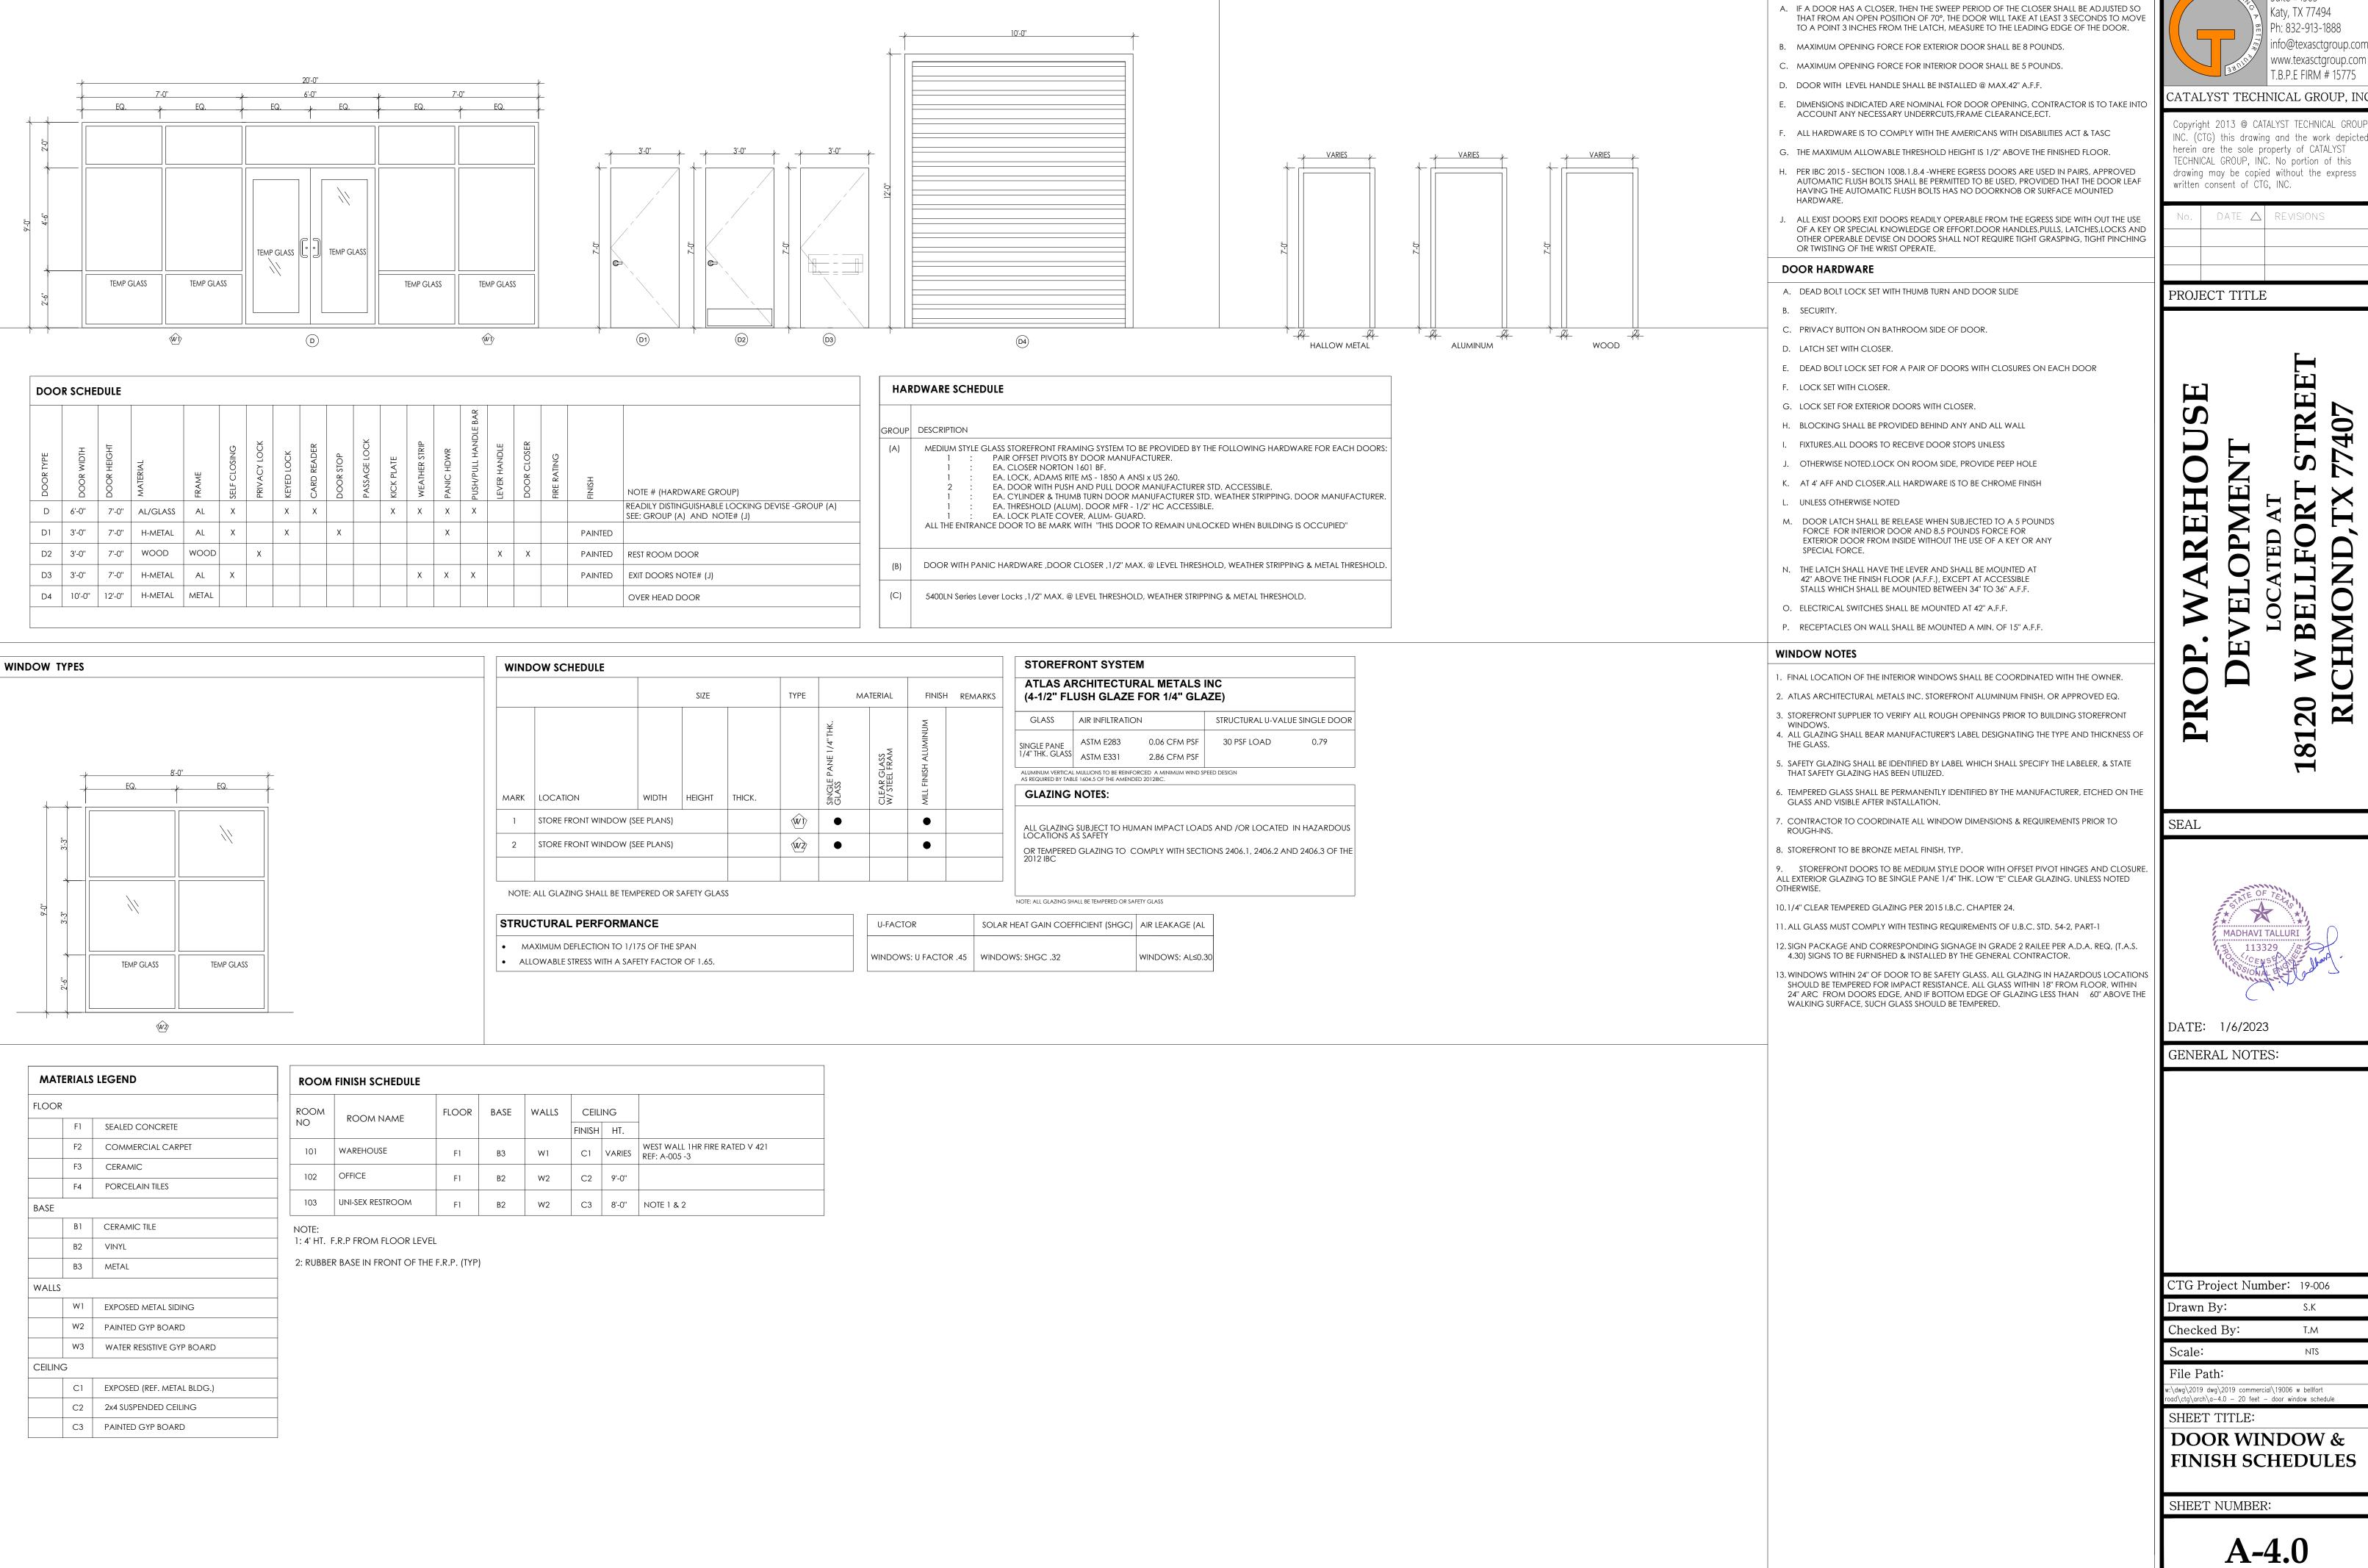
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BUILDING-T ELEVATIONS

SHEET NUMBER:

A-2.0



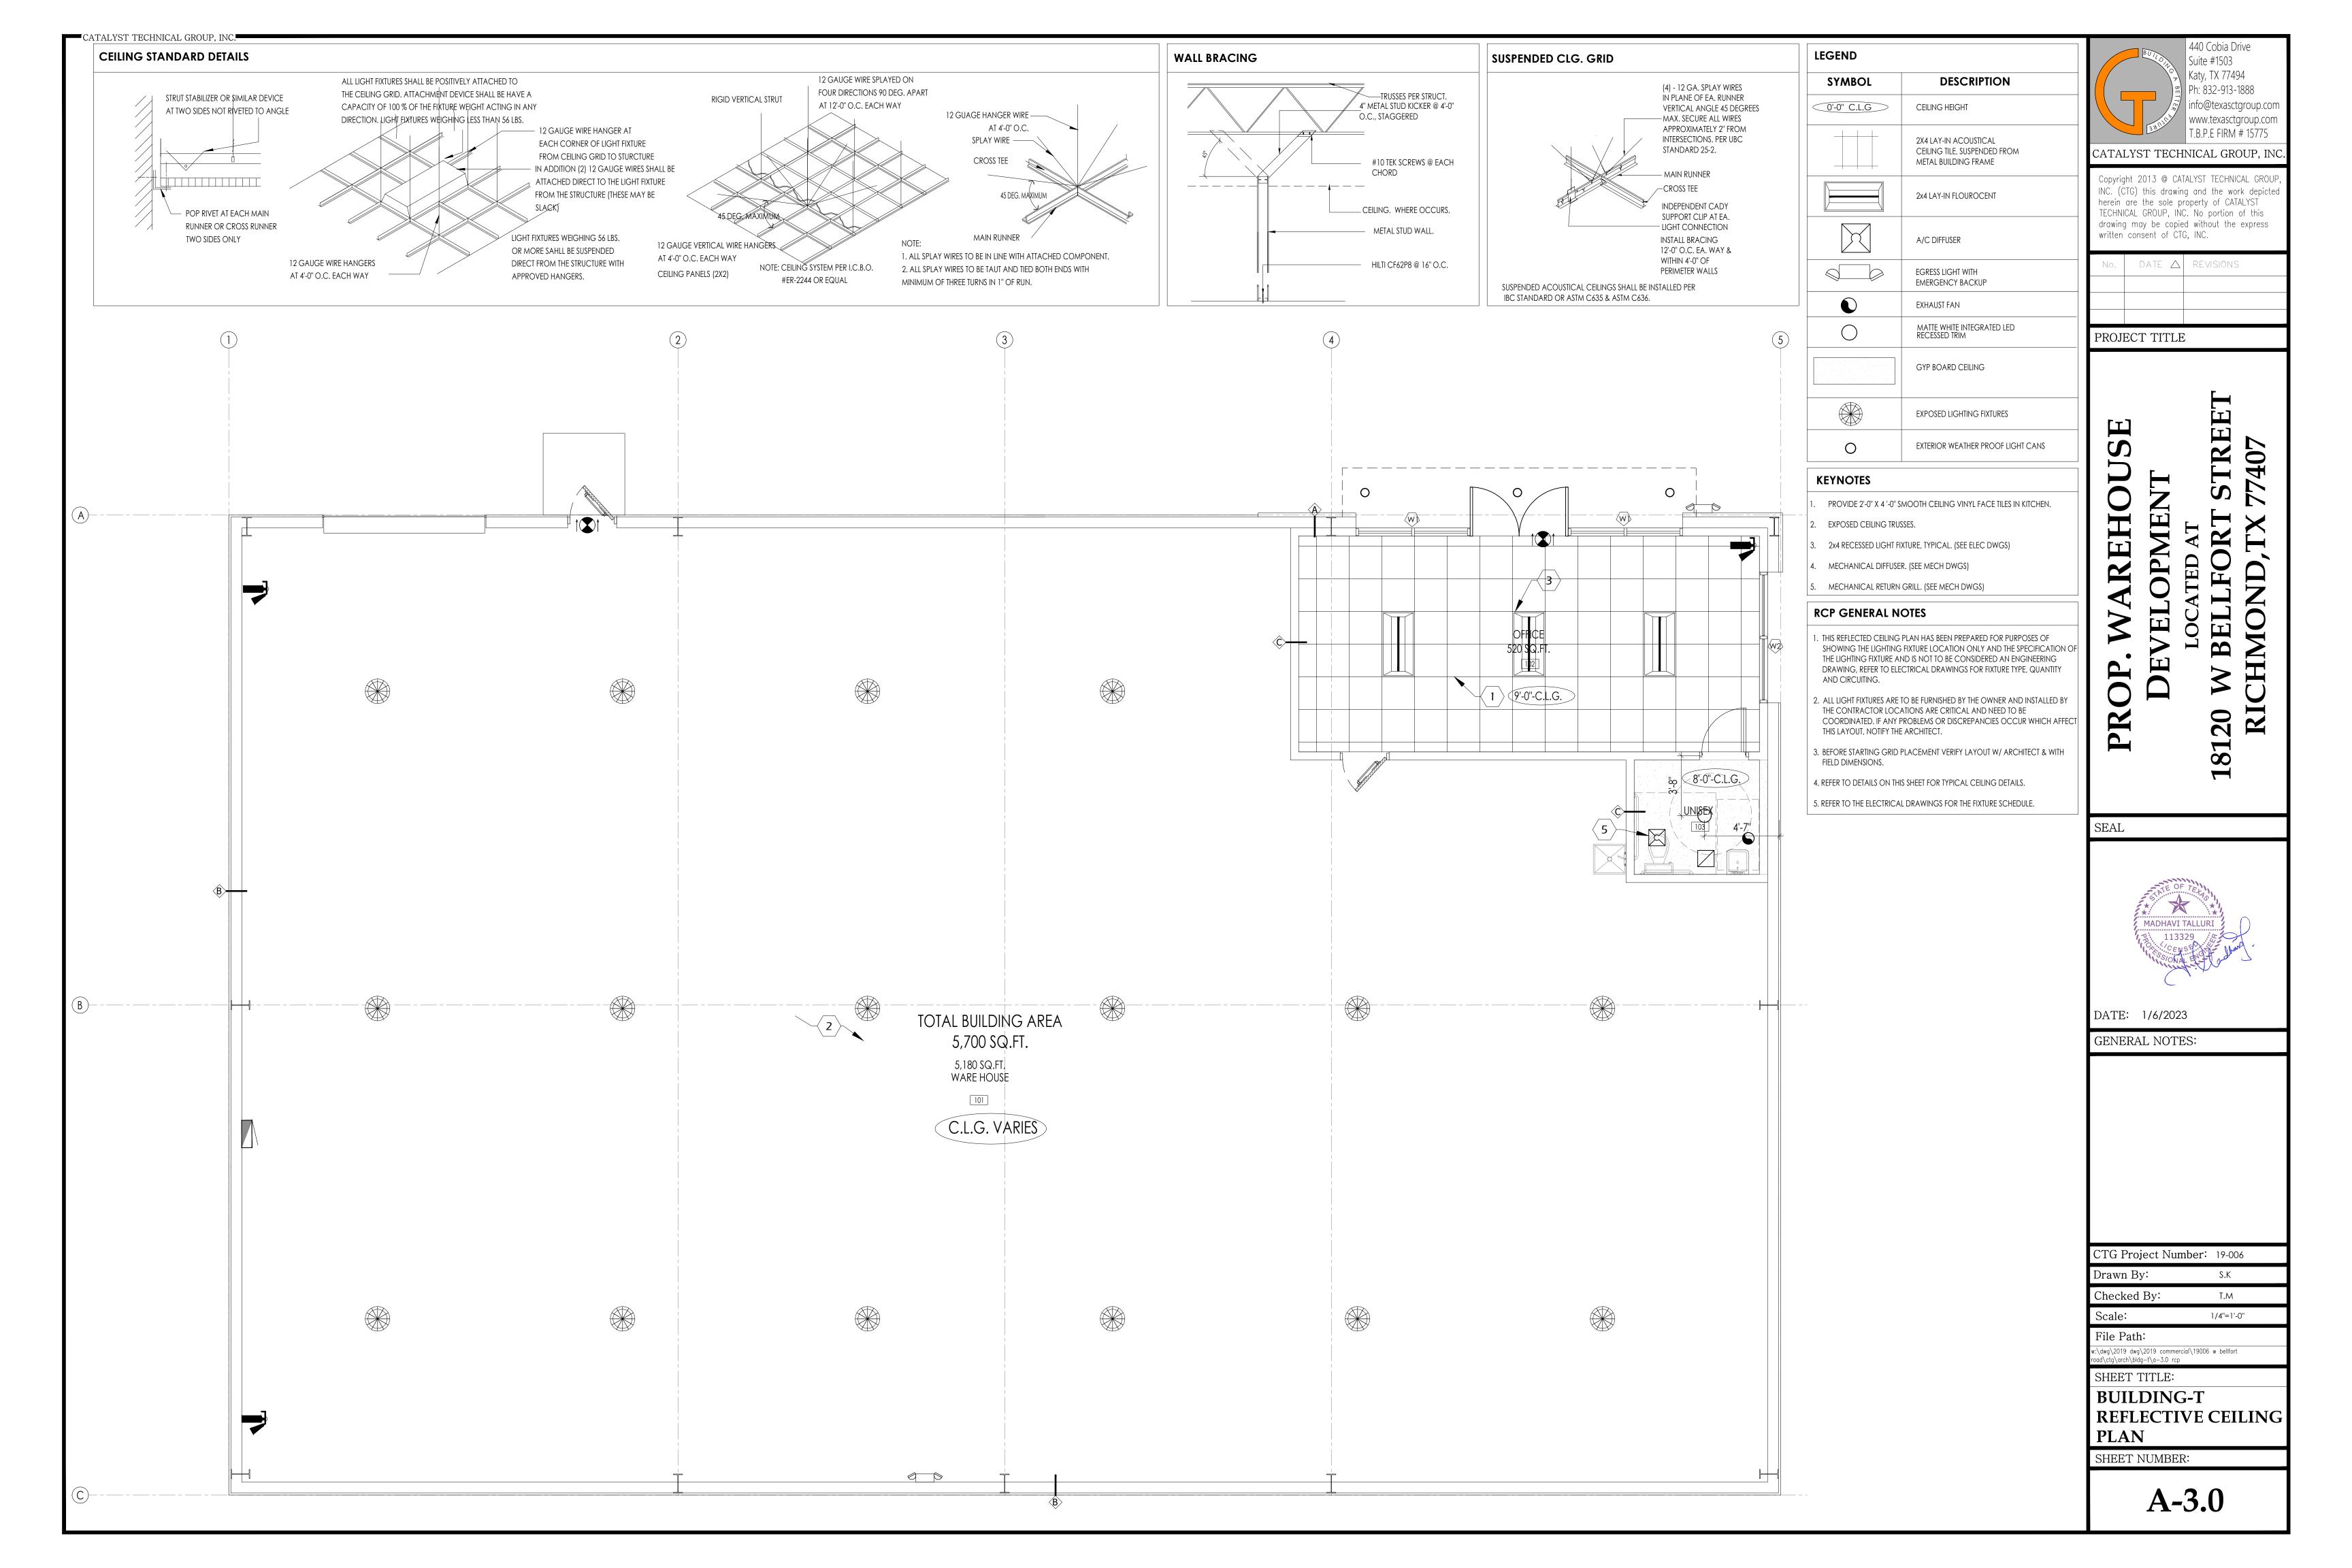

DOOR FRAMES


CATALYST TECHNICAL GROUP, INC.

DOOR TYPES

Suite #1503

DOOR NOTES

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KEY NOTES

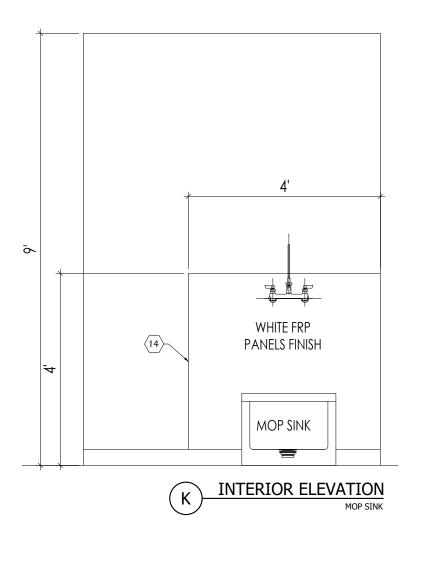- 1. 5'-0" DIA ADA WHEELCHAIR TURNING SPACE.
- 2. 30" X 48" MIN. CLEAR FLOOR SPACE AT LAVATORIES.
- 3. WATER CLOSET (ADULT 18" RIM HT.) PROVIDE FLUSH LEVER ON OPEN SIDE OF TOILET. (TYP.)
- 4. WALL HUNG LAVATORY (TYP.)
- 5. 36" STAINLESS STEEL GRAB BAR
- 6. 42" STAINLESS STEEL GRAB BAR
- 7. TOILET PAPER DISPENSER (TYP.)
- 8. WRAP EXPOSED WATER & DRAIN PIPE WITH ELASTOMERIC THERMAL INSULATION
- (BROCAR "TRAP WRAP" OR "PLUMBERX" #3011/3021) (TYP)
- 9. TEMPERED GLASS MIRROR 10. PAPER TOWEL ROLL HOLDER
- 11. ----
- 12. SOAP DISPENSER
- 14. F.R.P TILL 4' HT.
- 15. PAINTED GYP BOARD


GENERAL NOTES

- A. LAVATORY FAUCETS SHALL BE LEVER OR PUSH TYPE, SELF-CLOSING CONTROLS TO REMAIN ON FOR AT LEAST 10 SECONDS.
- B. ALL ACCESSIBILITY REQUIREMENTS SHALL COMPLY PER ADA / ADAAG & CITY CODE REQUIREMENTS.
- C. UNISEX TOILET SIGN W/ HANDICAP SYMBOL & BRAILLE. LAMINATED PLASTIC. MOUNT @ 60" A.F.F. TO CENTERLINE.
- D. LAVATORY CLEARANCES TO COMPLY W/ ANSI A117.1-1992, FIGURE B4.20.3.1.



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PROJECT TITLE

SEAL

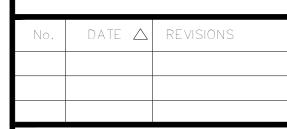

DATE: 1/6/2023

GENERAL NOTES:

CTG Project Number:	19-006
Drawn By:	S.K
Checked By:	T.M

File Path:


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SHEET TITLE:

REST ROOM ELEVATIONS TYPE-2


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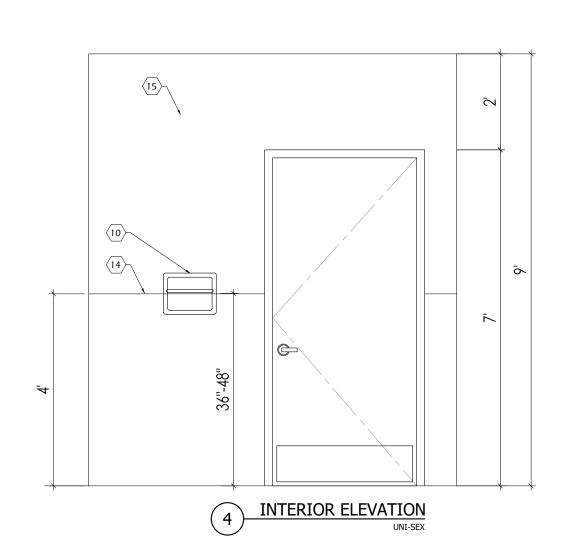



REFER FLOOR PLAN


FOR MOP SINK LOCATION

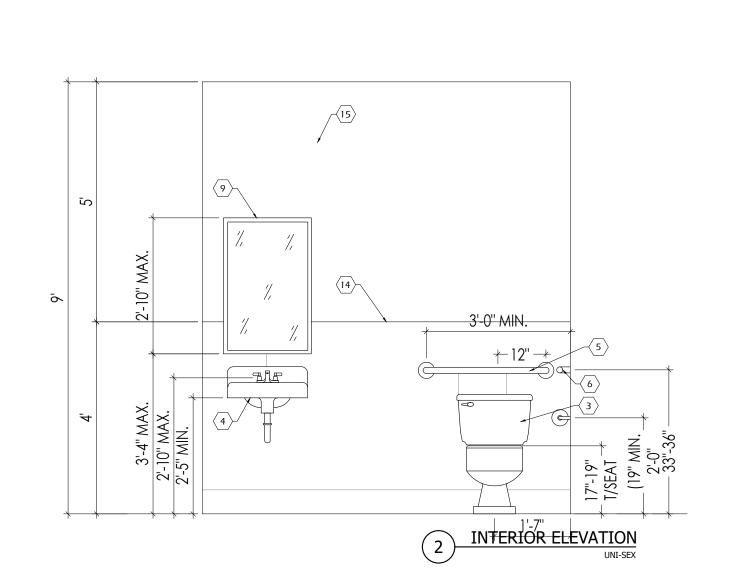


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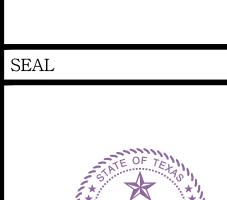
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PROJECT TITLE					

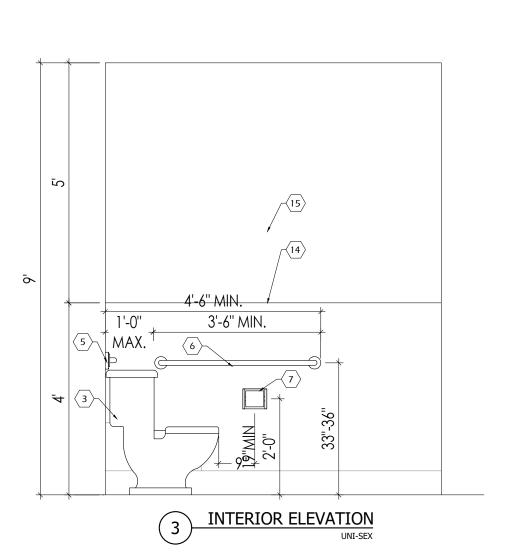STREET **OPMENT**
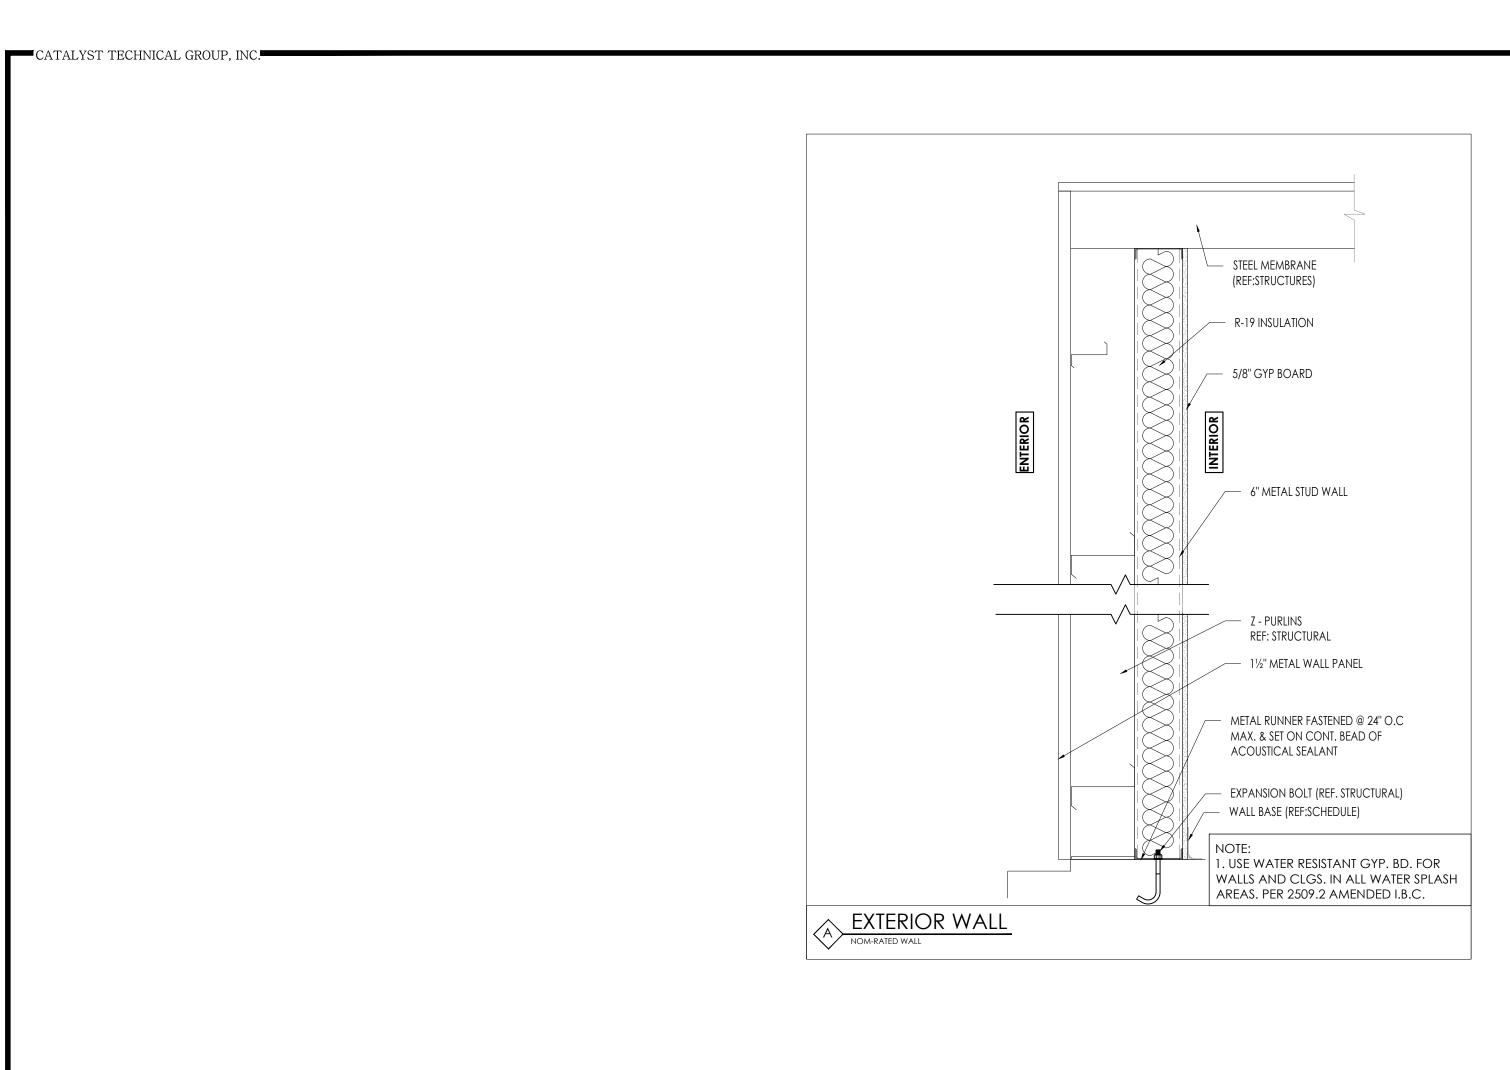
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PARTITION WALL TYPES

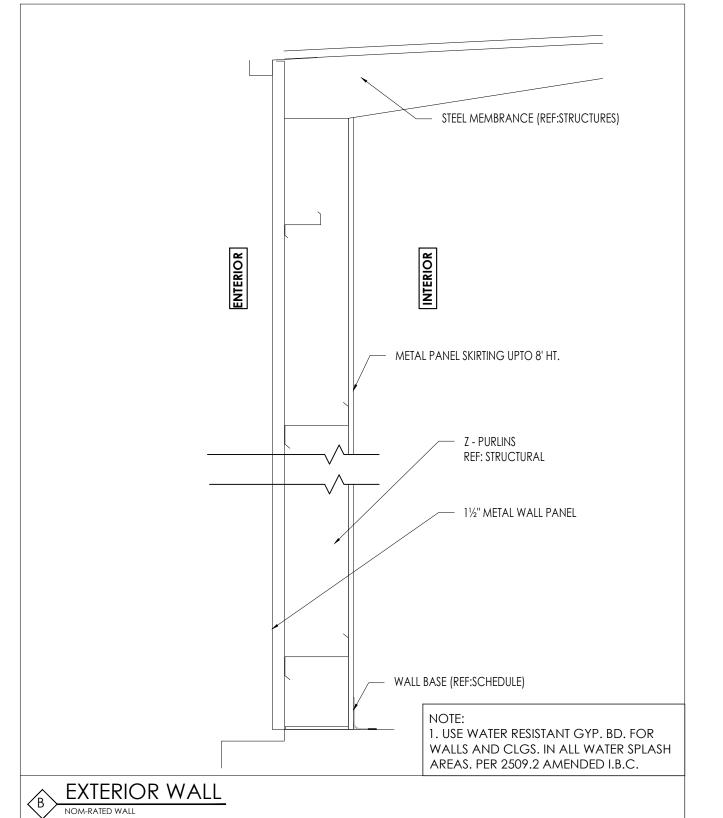
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DATE: 4/5/2022 GENERAL NOTES: CTG Project Number: 19-006 Drawn By: S.K

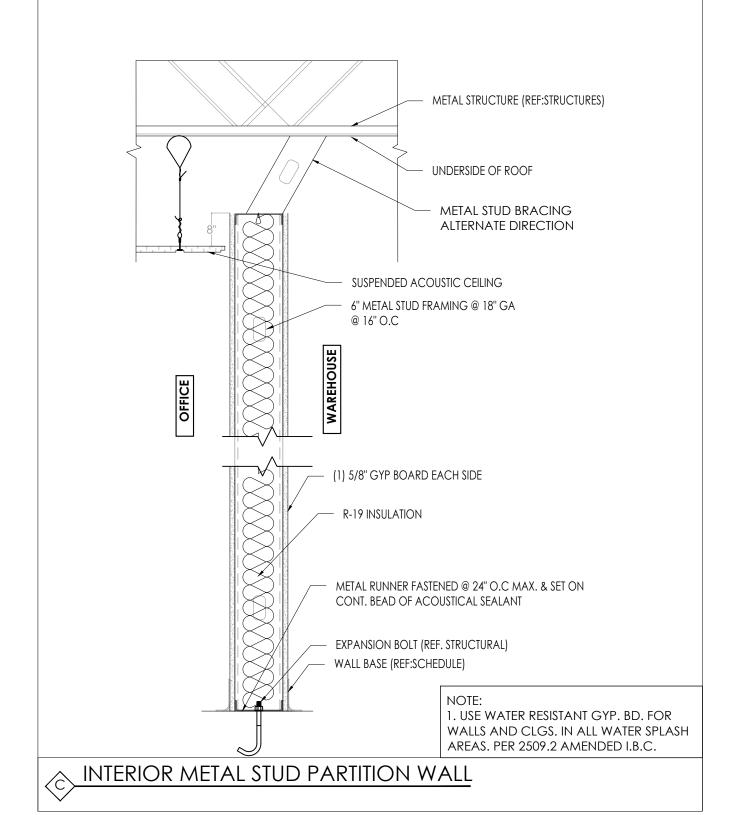



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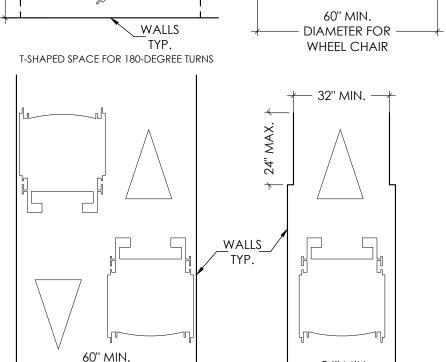
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ACCESSIBILITY NOTES

- IN BUILDINGS AND FACILITIES, FLOORS OF A GIVEN STORY SHALL BE A COMMON LEVEL THROUGHOUT, OR SHALL BE CONNECTED BY PEDESTRIAN RAMPS, PASSENGER ELEVATORS, OR SPECIAL ACCESS LIFTS.
- FLOOR SURFACES SHALL BE SLIP-RESISTANT.
- EVERY CORRIDOR AND AISLE SERVING AN OCCUPANT LOAD OF 10 OR MORE SHALL BE NOT LESS THAN 44" IN CLEAR WIDTH.
- ABRUPT CHANGES IN LEVEL ALONG ANY ACCESSIBLE ROUTE SHALL NOT EXCEED 1 "IN HEIGHT, LEVEL CHANGES NOT EXCEEDING 1 MAY BE VERTICAL. BEVEL OTHERS WITH A SLOPE OF NO GRATER THAN 1:2.
- LATCHING AND LOCKING DOORS THAT ARE HAND ACTIVATED AND WHICH ARE IN A PATH OF TRAVEL SHALL BE OPERABLE WITH A SINGLE EFFORT BY LEVER TYPE HARDWARE, PANIC BARS, PUSH ACTIVATING BARS, OR OTHER HARDWARE DESIGNED TO PROVIDE PASSAGE WITHOUT REQUIRING THE ABILITY TO GRASP THE OPENING HARDWARE. MOUNT DOOR OPENING HARDWARE BETWEEN 30" AND 44" ABOVE THE FLOOR
- CENTER HAND ACTIVATED DOOR OPENING HARDWARE 30" AND 44 ABOVE FINISHED FLOOR.
- MAXIMUM PULL OR PUSH EFFORT TO OPERATE DOORS SHALL NOT EXCEED 8.5 POUNDS FOR EXTERIOR DOORS, AND 5 POUNDS FOR INTERIOR DOORS, MEASURED AT RIGHT ANGLES TO HINGED DOORS AN AT CENTER PLAN OF SLIDING OR FOLDING DOORS. CORRESPONDING DEVICES OR AUTOMATIC DOOR OPENERS MAY BE UTILIZED TO MEET THE ABOVE STANDARDS. MAXIMUM EFFORT TO OPERATE REQUIRED FIRE DOORS MAY BE INCREASED NOT TO EXCEED 15 POUNDS.
- THE BOTTOM 10" OF ALL DOORS, (EXCEPT SLIDING AND AUTOMATIC) SHALL HAVE A SMOOTH UNINTERRUPTED SURFACE TO ALLOW THE DOOR TO BE OPENED USING A WHEELCHAIR FOOTREST WITHOUT CREATING A TRAP OR HAZARDOUS CONDITION. PROVIDE A 10" SMOOTH PANEL ON THE PUSH SIDE OF NARROW FRAME DOORS.
- EVERY REQUIRED ENTRANCE OR PASSAGE DOORWAY SHALL BE NOT LES THAN 3' IN WIDTH AND NOT LESS THAN 6"-8" IN HEIGHT. DOORS SHALL BE CAPABLE OF OPENING AT LEAST 90 DEGREES AND SHALL BE MOUNTED SO THAT THE CLEAR WIDTH OF THE DOORWAY IS NOT LESS THAN 32".
- WHERE A PAIR OF DOORS IS UTILIZED, AT LEAST ONE OF THE DOORS SHALL PROVIDE A CLEAR, UNOBSTRUCTED OPENING WIDTH OF 32" WITH THE LEAF POSITIONED AT AN ANGLE OF 90 DEGREES FROM ITS CLOSED
- IDENTIFY ACCESSIBLE ENTRANCES WITH AT LEAST ONE STANDARD SIGN AND WITH ADDITIONAL DIRECTIONAL SIGNS AS REQUIRED, VISIBLE FROM APPROACHING PEDESTRIAN WAYS.
- THE FLOOR OR LANDING ON EACH SIDE OF AN ENTRANCE OR PASSAGE DOOR SHALL BE LEVEL AND CLEAR. THE LEVEL AND CLEAR AREA SHALL HAVE A LENGTH IN THE DIRECTION OF DOOR SWING OF AT LEAST 60", AND THE LENGTH OPPOSITE THE DIRECTION OF DOOR SWING OF 44" AS MEASURED AT RIGHT ANGLES TO THE PLANE OF THE DOOR IN ITS CLOSED
- FLOORS OR LANDINGS SHALL BE NOT MORE THAN 21" LOWER THAN THE THRESHOLD OF THE DOORWAY. CHANGE IN LEVEL BETWEEN 41" AND 21' SHALL BE BEVELED, WITH A SLOPE NO GREATER THAN 1:2.
- TO ALERT THE VISUALLY IMPAIRED, MARK THE UPPER APPROACH AND THE LOWER TREAD OF EACH INTERIOR STAIR WITH A STRIP OF CLEARLY CONTRASTING COLOR AT LEAST 2" WIDE, PLACED PARALLEL TO AND NOT MORE THAN 1" FROM THE NOSE OF THE STEP OR LANDING. THE STRIF SHALL BE OF A MATERIAL THAT IS AS LEAST AS SLIP RESISTANT AS THE OTHER TREADS OF THE STAIR.
- ELECTRICAL RECEPTACLES CANNOT BE LESS THAN 15" FROM THE FLOOR AS MEASURED TO THE LOWEST OPERABLE PART MAKING THE BOTTOM OF



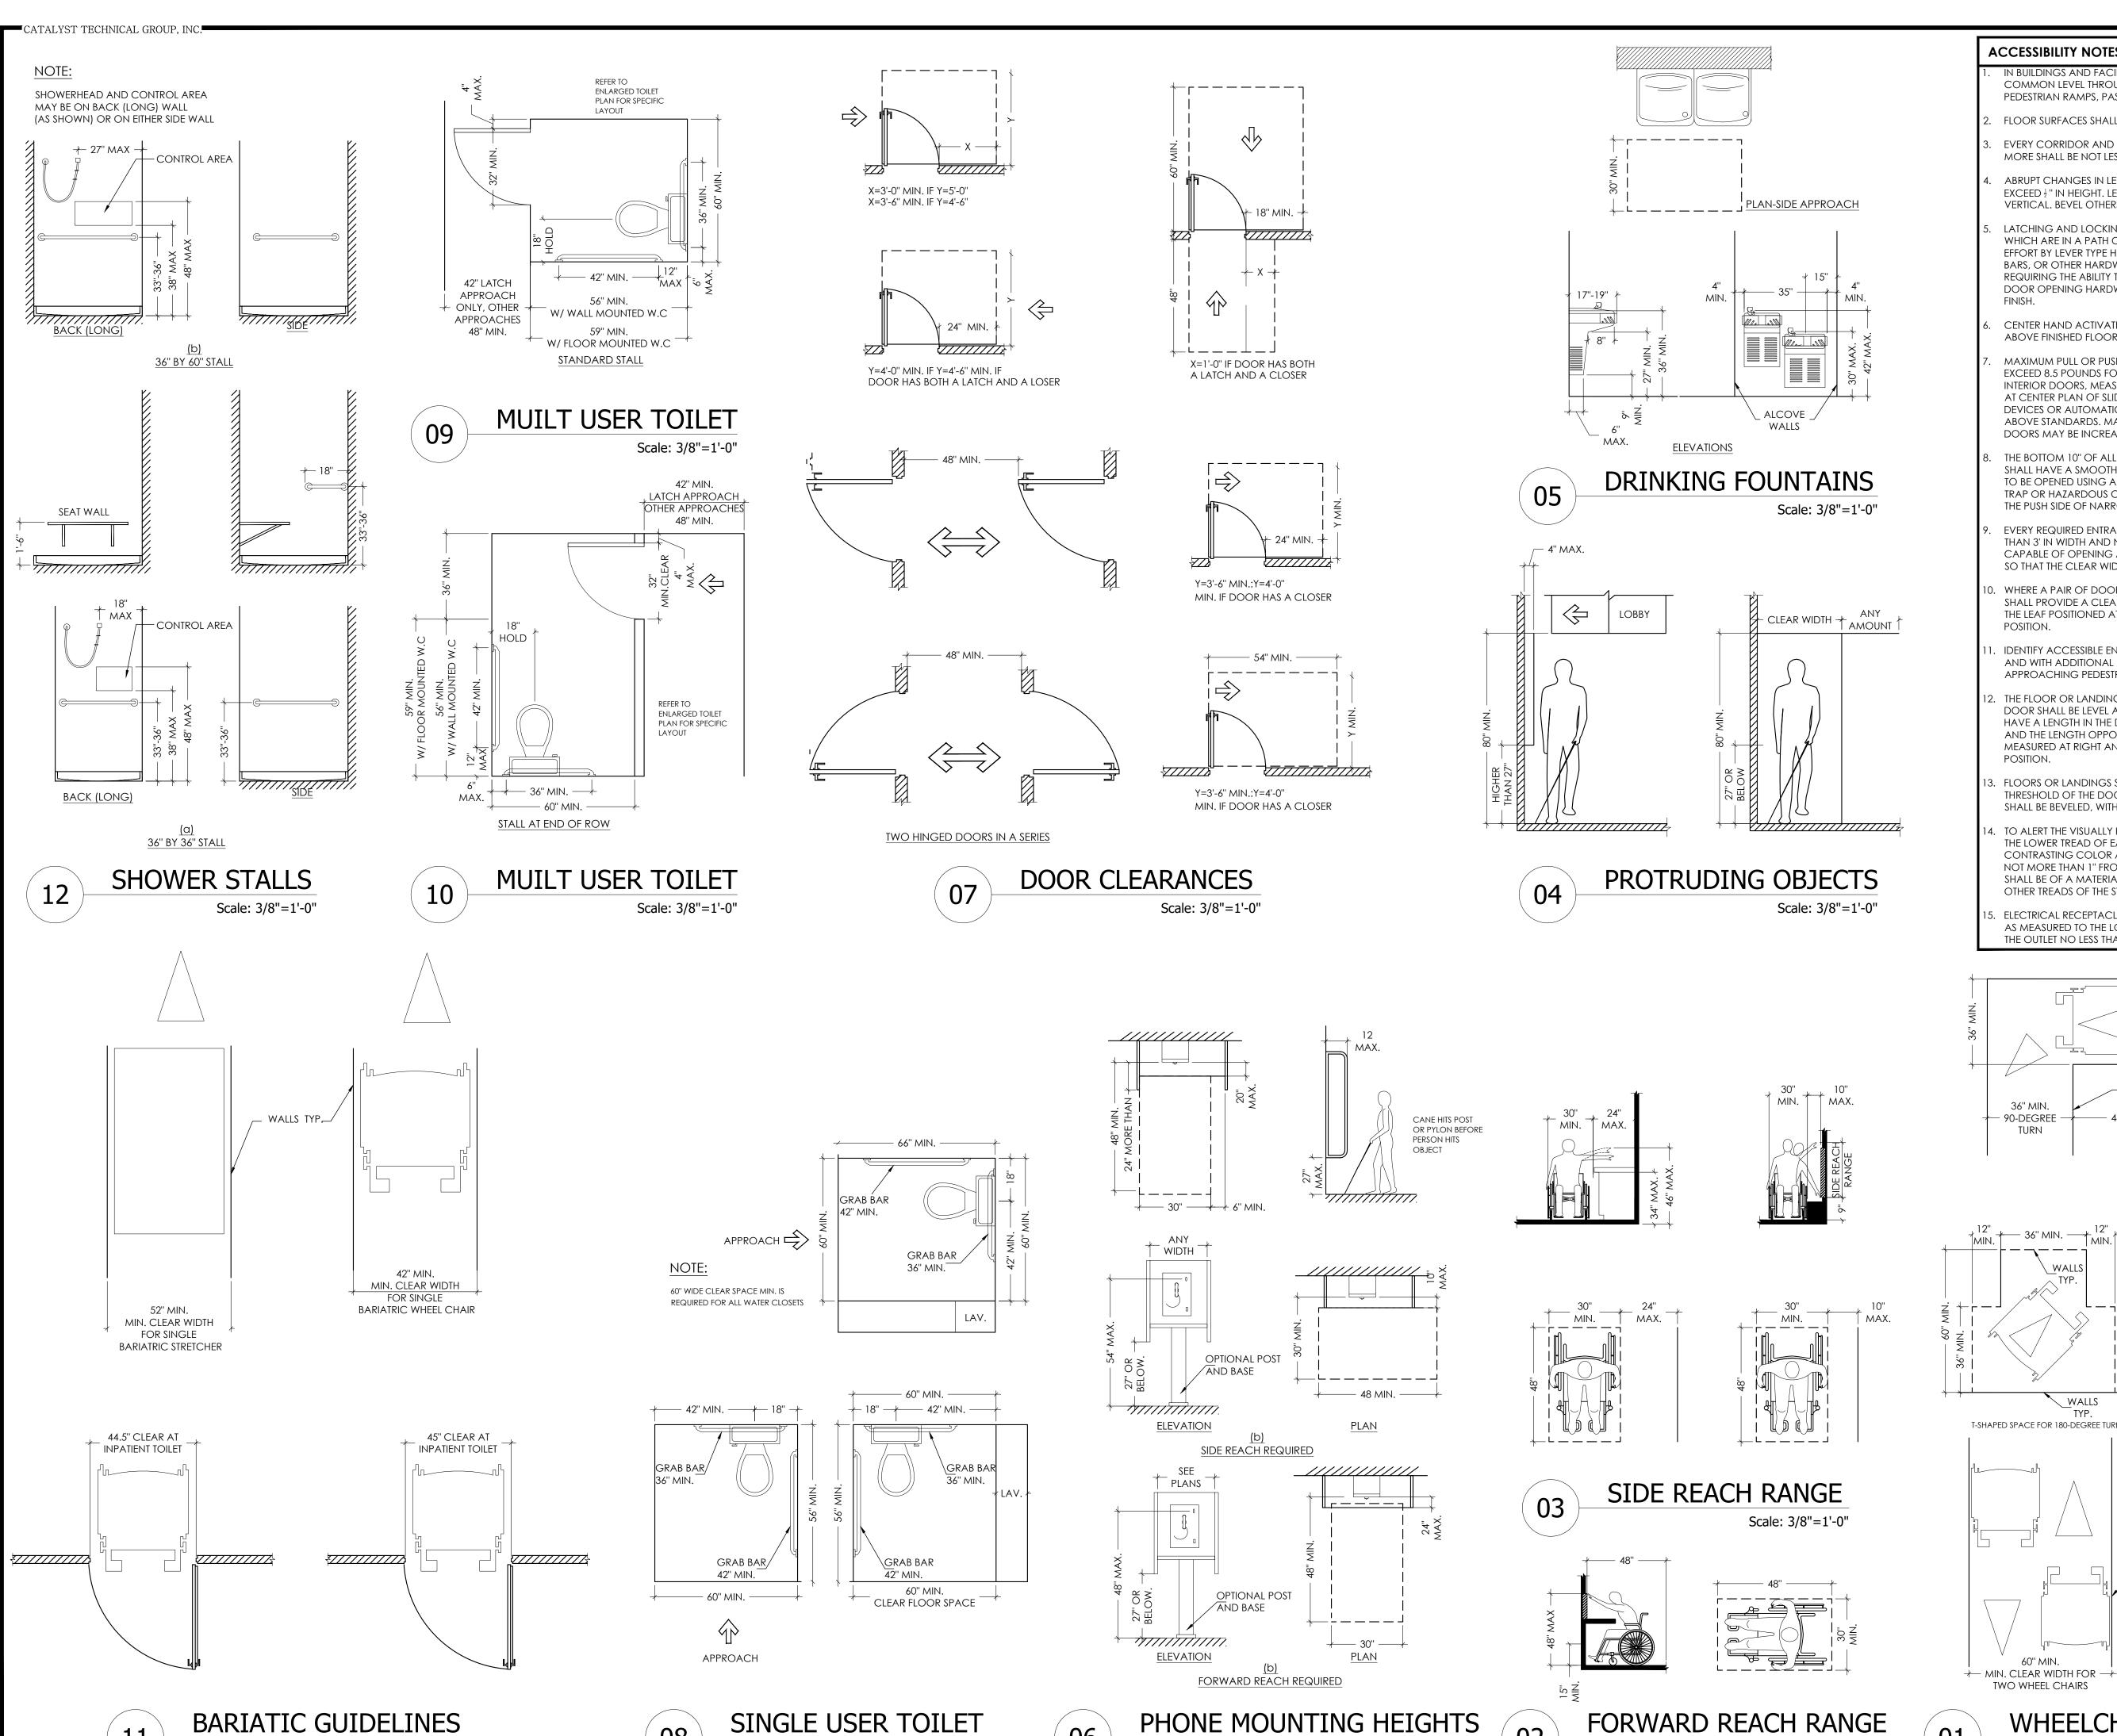

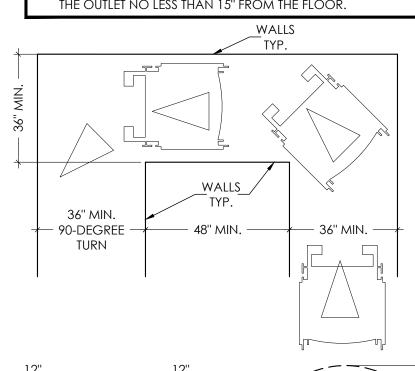

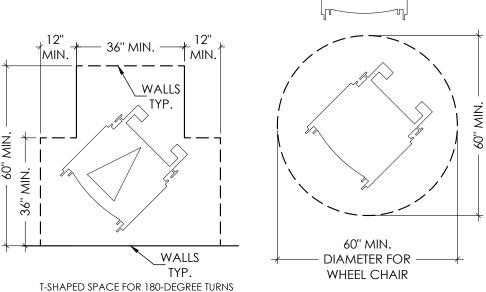01

Scale: 3/8"=1'-0"

Scale: 3/8"=1'-0"

MÎN. CLEAR WIDTH FOR SINGLE WHEEL CHAR WHEELCHAIR CLEARANCES

Scale: 3/8"=1'-0"

CTG Project Number: 19-006 Drawn By: S.K Checked By T.M 3/8"=1'-0" File Path:

MADHAVI TALLURI

DATE: 4/5/2022

GENERAL NOTES:

Suite #1503

Katy, TX 77494

Ph: 832-913-1888

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PROJECT TITLE

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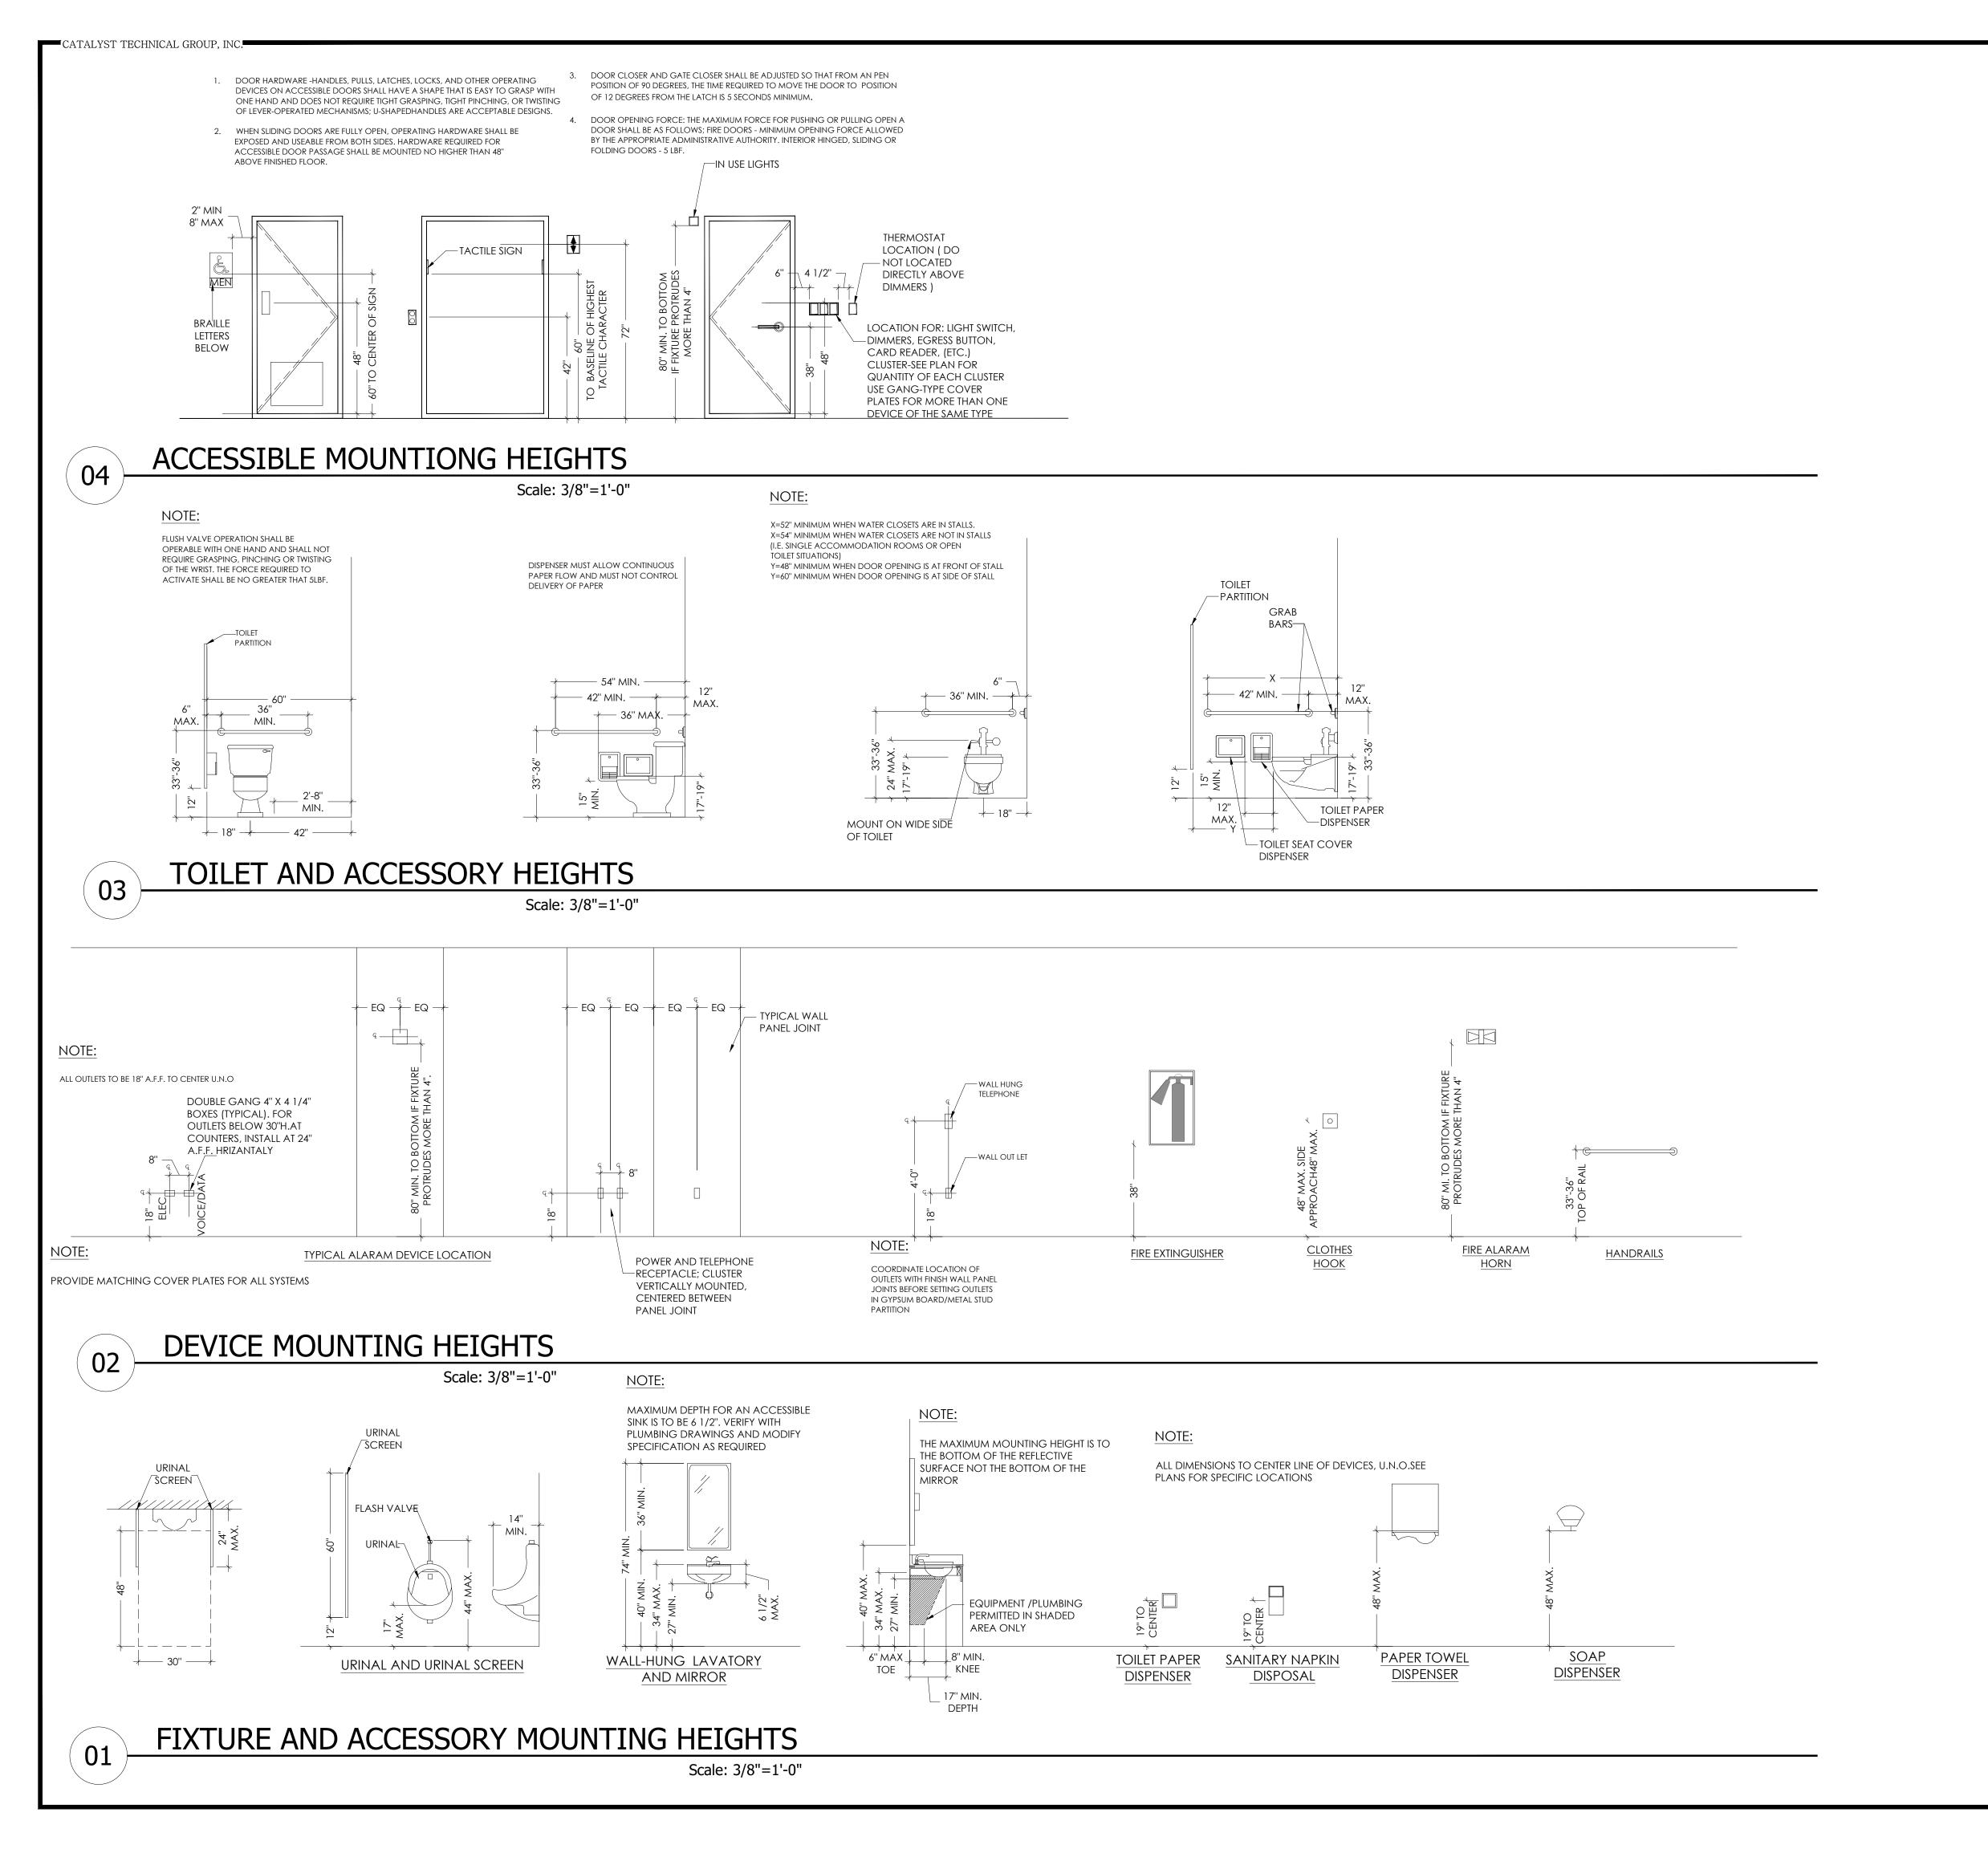
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ad\ctg\arch\bldg—t\ada interior elevations SHEET TITLE:

ADA NOTES & **DETAILS-1**

SHEET NUMBER:

ADA-1



ACCESSIBILITY NOTES

703.1 GENERAL. SIGNS SHALL COMPLY WITH 703. WHERE BOTH VISUAL AND TACTILE CHARACTERS ARE REQUIRED, EITHER ONE SIGN WITH BOTH VISUAL AND TACTILE CHARACTERS, OR TWO SEPARATE SIGNS, ONE WITH VISUAL. AND ONE WITH TACTILE CHARACTERS, SHALL BE PROVIDED. 703.2 RAISED CHARACTERS. RAISED CHARACTERS SHALL COMPLY WITH 703.2 AND SHALL BE DUPLICATED IN BRAILLE COMPLYING WITH 703.3. RAISED CHARACTERS SHALL BE INSTALLED IN ACCORDANCE WITH 703.4. ADVISORY

703.2 RAISED CHARACTERS. SIGNS THAT ARE DESIGNED TO BE READ BY TOUCH SHOULD NOT HAVE SHARP OR ABRASIVE EDGES.

703.2.1DEPTH.RAISEDCHARACTERS SHALL BE 1/32 INCH (0.8 MM) MINIMUM ABOVE THEIR BACKGROUND.

703.2.2 CASE. CHARACTERS SHALL BE UPPERCASE.

703.2.3 STYLE. CHARACTERS SHALL BE SANS SERIF. CHARACTERS SHALL NOT BE ITALIC, OBLIQUE, SCRIPT, HIGHLY DECORATIVE, OR OF OTHER UNUSUAL

703.2.4 CHARACTER PROPORTIONS. CHARACTERS SHALL BE SELECTED FROM FONTS WHERE THE WIDTH OF THE UPPERCASE LETTER "O" IS 55 PERCENT MINIMUM AND 110 PERCENT MAXIMUM OF THE HEIGHT OF THE UPPERCASE

703.2.5 CHARACTER HEIGHT. CHARACTER HEIGHT MEASURED VERTICALLY FROM THE BASELINE OF THE CHARACTER SHALL BE 5/8 INCH (16MM) MINIMUM AND 2 INCHES (51 MM) MAXIMUM BASED ON THE HEIGHT OF THE UPPERCASE LETTER "I". EXCEPTION: WHERE SEPARATE RAISED AND VISUAL CHARACTERS WITH THE SAME INFORMATION ARE PROVIDED, RAISED CHARACTER HEIGHT SHALL BE PERMITTED TO BE 1/2 INCH (13 MM) MINIMUM.

703.2.6 STROKE THICKNESS. STROKE THICKNESS OF THE UPPERCASE LETTER "I" SHALL BE 15 PERCENT MAXIMUM OF THE HEIGHT OF THE CHARACTER.

703.2.7 CHARACTER SPACING. CHARACTER SPACING SHALL BE MEASURED BETWEEN THE TWO CLOSEST POINTS OF ADJACENT RAISED CHARACTERS WITHIN A MESSAGE, EXCLUDING WORD SPACES. WHERE CHARACTERS HAVE RECTANGULAR CROSS SECTIONS, SPACING BETWEEN INDIVIDUAL RAISED CHARACTERS SHALL BE 1/8 INCH (3.2 MM) MINIMUM AND 4 TIMES THE RAISED CHARACTER STROKE WIDTH MAXIMUM. WHERE CHARACTERS HAVE OTHER CROSS SECTIONS, SPACING BETWEEN INDIVIDUAL RAISED CHARACTERS SHALL BE 1/16 INCH (1.6 MM) MINIMUM AND 4 TIMES THE RAISED CHARACTER STROKE WIDTH MAXIMUM AT THE BASE OF THE CROSS SECTIONS, AND 1/8 INCH (3.2MM) MINIMUM AND 4 TIMES THE RAISED CHARACTER STROKE WIDTH MAXIMUM AT THE TOP OF THE CROSS SECTIONS. CHARACTERS SHALL BE SEPARATED FROM RAISED BORDERS AND DECORATIVE ELEMENTS 3/8 INCH (9.5 MM) MINIMUM. 703.2.8 LINE SPACING. SPACING BETWEEN THE BASELINES OF SEPARATE LINES OF RAISED CHARACTERS WITHIN A MESSAGE SHALL BE 135 PERCENT MINIMUM AND 170 PERCENT MAXIMUM OF THE RAISED CHARACTER

703.5.1 FINISH AND CONTRAST. CHARACTERS AND THEIR BACKGROUND SHALL HAVE A NON-GLARE FINISH. CHARACTERS SHALL CONTRAST WITH THEIR BACKGROUND WITH EITHER LIGHT CHARACTERS ON A DARK BACKGROUND OR DARK CHARACTERS ON A LIGHT BACKGROUND. ADVISORY

703.5.1 FINISH AND CONTRAST. SIGNS ARE MORE LEGIBLE FOR PERSONS WITH LOW VISION WHEN CHARACTERS CONTRAST AS MUCH AS POSSIBLE WITH THEIR BACKGROUND, ADDITIONAL FACTORS AFFECTING THE EASE WITH WHICH THE TEXT CAN BE DISTINGUISHED FROM ITS BACKGROUND INCLUDE SHADOWS CAST BY LIGHTING SOURCES, SURFACE GLARE, AND THE UNIFORMITY OF THE TEXT AND ITS BACKGROUND COLORS AND TEXTURES.

703.5.2 CASE. CHARACTERS SHALL BE UPPERCASE OR LOWERCASE OR A COMBINATION OF BOTH.

703.5.3 STYLE. CHARACTERS SHALL BE CONVENTIONAL IN FORM. CHARACTERS SHALL NOT BE ITALIC, OBLIQUE, SCRIPT, HIGHLY DECORATIVE, OR OF OTHER UNUSUAL FORMS.

703.5.4 CHARACTER PROPORTIONS. CHARACTERS SHALL BE SELECTED FROM FONTS WHERE THE WIDTH OF THE UPPERCASE LETTER "O" IS 55 PERCENT MINIMUM AND 110 PERCENT MAXIMUM OF THE HEIGHT OF THE UPPERCASE LETTER "I".703.5.5 CHARACTER HEIGHT. MINIMUM CHARACTER HEIGHT SHALL COMPLY WITH TABLE

703.5.5. VIEWING DISTANCE SHALL BE MEASURED AS THE HORIZONTAL DISTANCE BETWEEN THE CHARACTER AND AN OBSTRUCTION PREVENTING FURTHER APPROACH TOWARDS THE SIGN, CHARACTER HEIGHT SHALL BE BASED ON THE UPPERCASE LETTER "I". TABLE 703.5.5 VISUAL CHARACTER HEIGHT HEIGHT TO FINISH FLOOR OR GROUND FROM BASELINE OF CHARACTER HORIZONTAL VIEWING DISTANCE MINIMUM CHARACTER HEIGHT 40 INCHES (1015 MM) TO LESS THAN OR EQUAL TO 70 INCHES (1780 MM) LESS THAN 72 INCHES (1830MM) 5/8 INCH (16 MM) 72 INCHES (1830 MM) AND GREATER 5/8 INCH(16 MM), PLUS 1/8 INCH (3.2MM) PER FOOT (305 MM) OF VIEWING DISTANCE ABOVE 72 INCHES (1830 MM)GREATER THAN 70 INCHES (1780MM) TO LESS THAN OR EQUAL TO 120 INCHES (3050 MM) LESS THAN 180 INCHES (4570 MM) 2 INCHES (51 MM) 180 INCHES (4570 MM) AND GREATER 2 INCHES (51 MM), PLUS 1/8 INCH (3.2 MM) PER FOOT (305 MM) OF VIEWING DISTANCE ABOVE 180 INCHES (4570MM) GREATER THAN 120 INCHES (3050 MM) LESS THAN 21 FEET (6400 MM) 3 INCHES (75 MM)21 FEET (6400 MM) AND GREATER 3 INCHES (75 MM), PLUS 1/8 INCH (3.2MM) PER FOOT (305 MM) OF VIEWING DISTANCE ABOVE 21 FEET (6400 MM)

703.5.6 HEIGHT FROM FINISH FLOOR OR GROUND. VISUAL CHARACTERS SHALL BE 40 INCHES (1015MM) MINIMUM ABOVE THE FINISH FLOOR OR GROUND. EXCEPTION: VISUAL CHARACTERS INDICATING ELEVATOR CAR CONTROLS SHALL NOT BE REQUIRED TO COMPLY WITH 703.5.6.

703.5.7 STROKE THICKNESS. STROKE THICKNESS OF THE UPPERCASE LETTER "I" SHALL BE 10 PERCENT MINIMUM AND 30 PERCENT MAXIMUM OF THE HEIGHT OF THE CHARACTER. - 150 -2012 TEXAS ACCESSIBILITY STANDARDS • EFFECTIVE MARCH 15, 2012 • TEXAS DEPARTMENT OF LICENSING AND REGULATION

703.5.8 CHARACTER SPACING. CHARACTER SPACING SHALL BE MEASURED BETWEEN THE TWO CLOSEST POINTS OF ADJACENT CHARACTERS EXCLUDING WORD SPACES. SPACING BETWEEN INDIVIDUAL CHARACTERS SHALL BE 10 PERCENT MINIMUM AND 35 PERCENT MAXIMUM OF CHARACTER HEIGHT.


703.5.9 LINE SPACING. SPACING BETWEEN THE BASELINES OF SEPARATE LINES OF CHARACTERS WITHIN A MESSAGE SHALL BE 135 PERCENT MINIMUM AND 170 PERCENT MAXIMUM OF THE CHARACTER HEIGHT.

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PROJECT TITLE

OPME



DATE: 4/5/2022

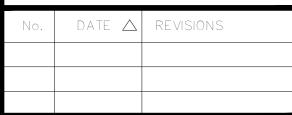GENERAL NOTES:

CTG Project Number: 19-006 S.K Drawn By:

T.M

3/8"=1'-0" File Path:

\dwg\2019 dwg\2019 commercial\19006 w bellfort
ad\ctg\arch\bldg—t\ada interior elevations SHEET TITLE:

ADA NOTES & **DETAILS-2**

SHEET NUMBER:

Checked By

ADA-2