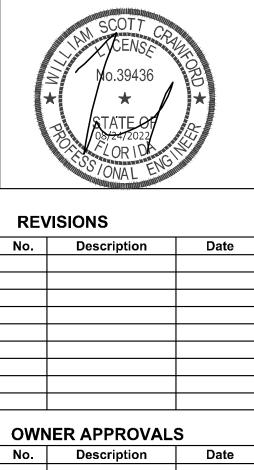


MECHANICAL
ELECTRICAL
PLUMBING
& FIRE



INBAR

ARCHITECTURE, AIA

FLORIDA LICENSE NO. AA0002701

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PROPOSED NEW HOME FOR:	NOKOMIS MEDICAL CENTER	498 S. TAMIAMI TRL. NOKOMIS, FL.

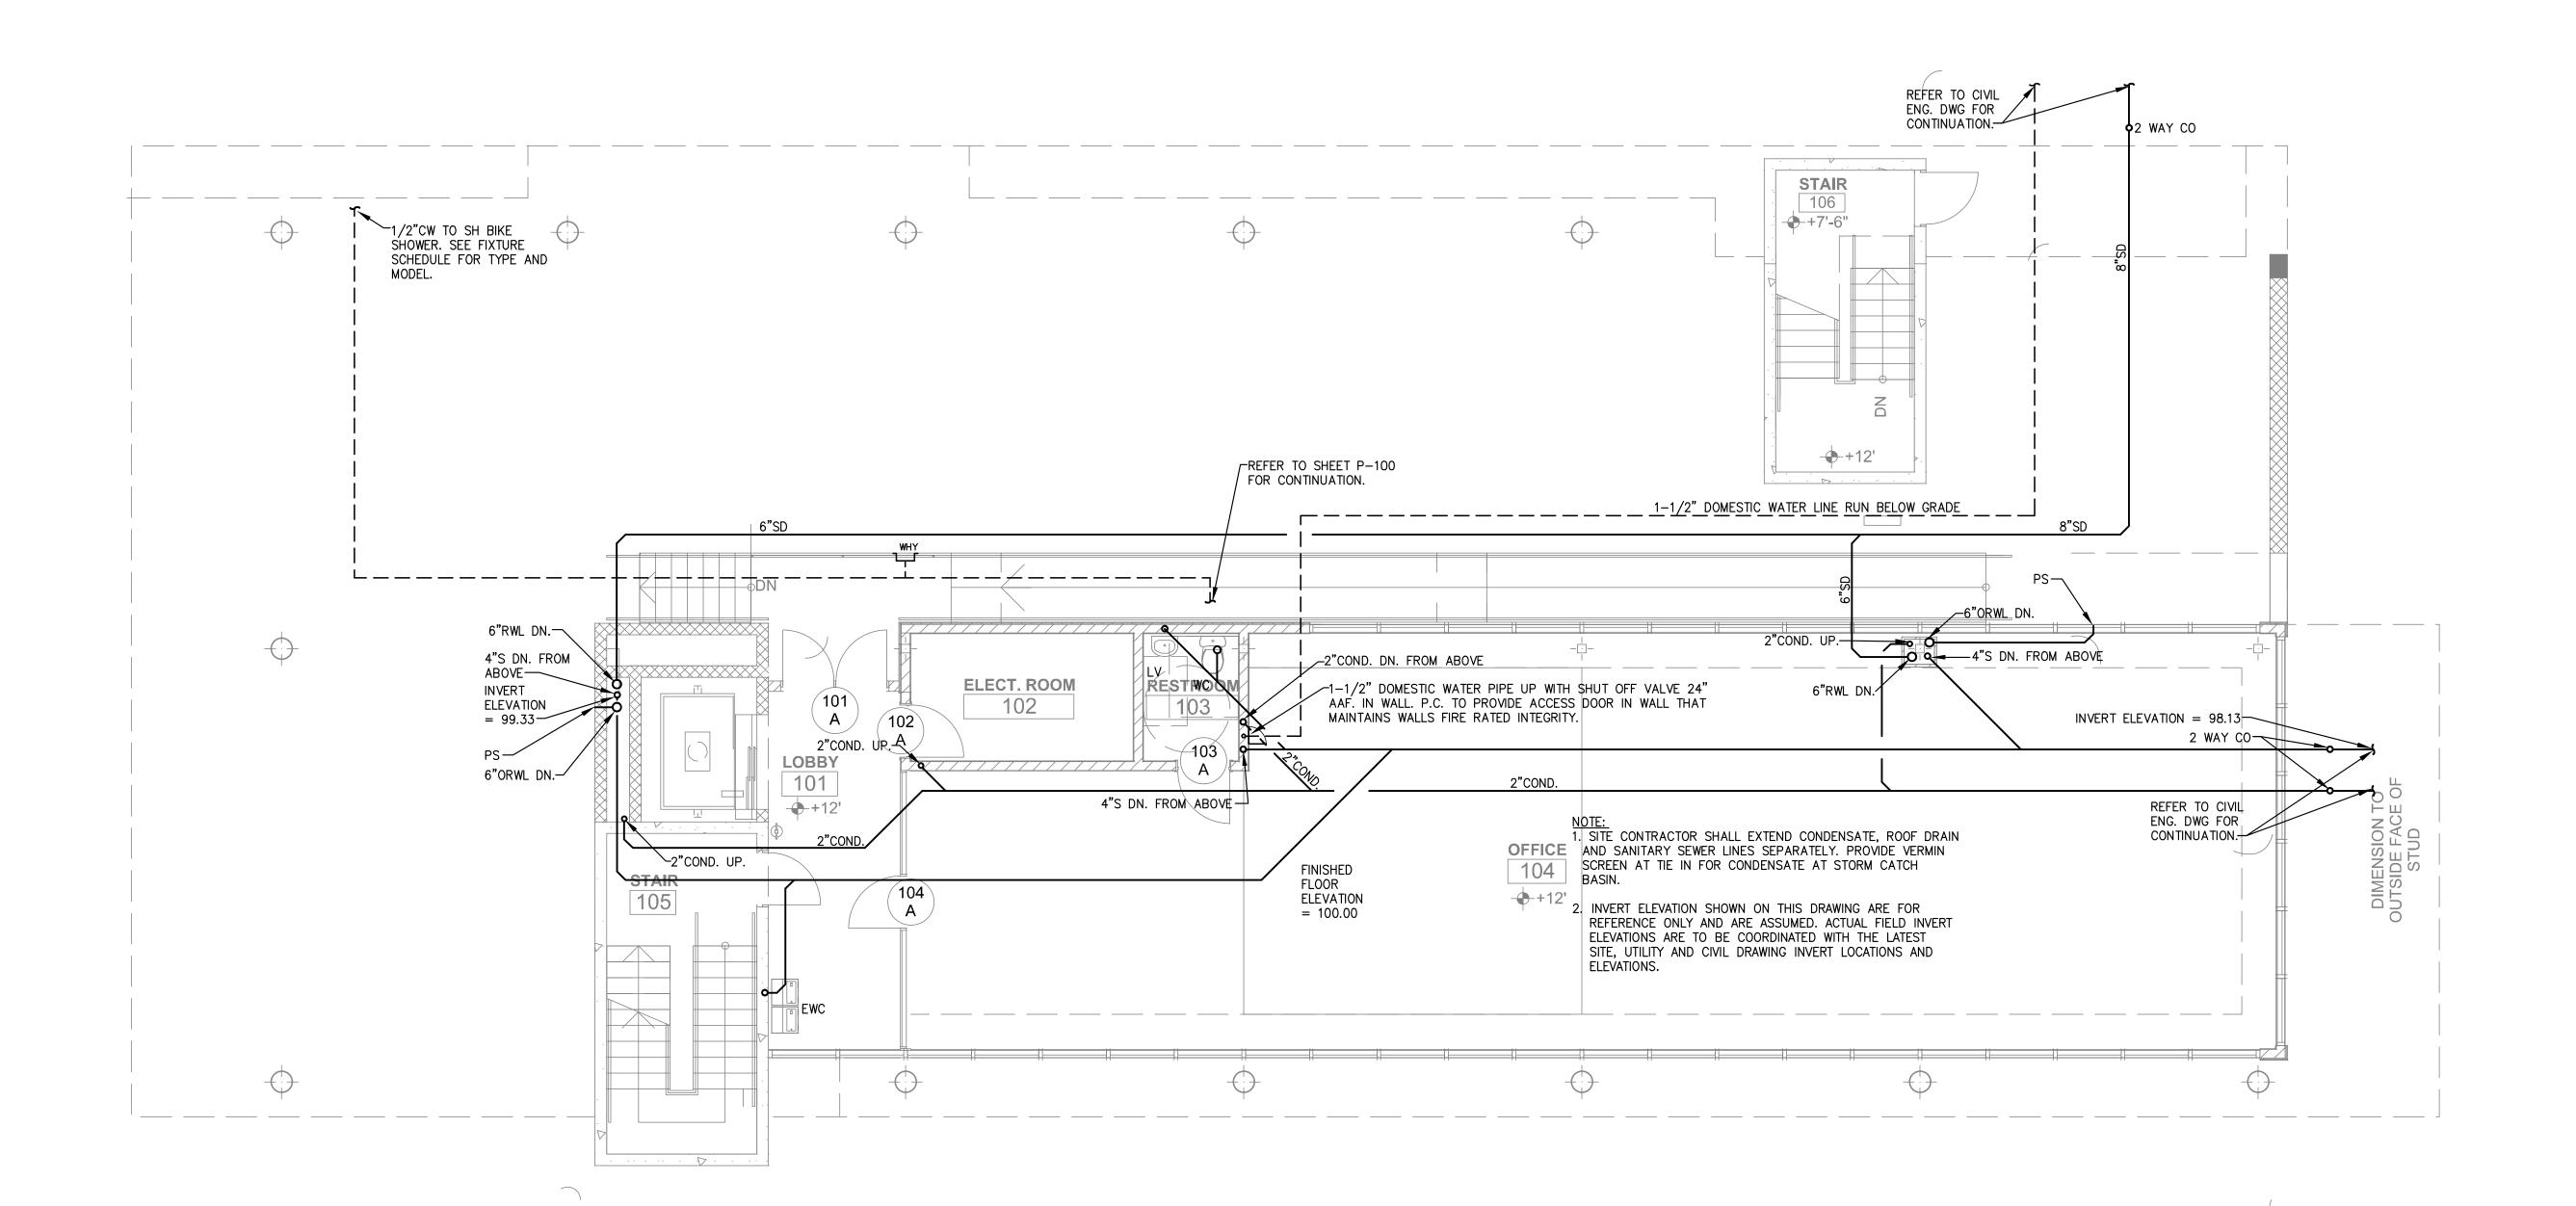
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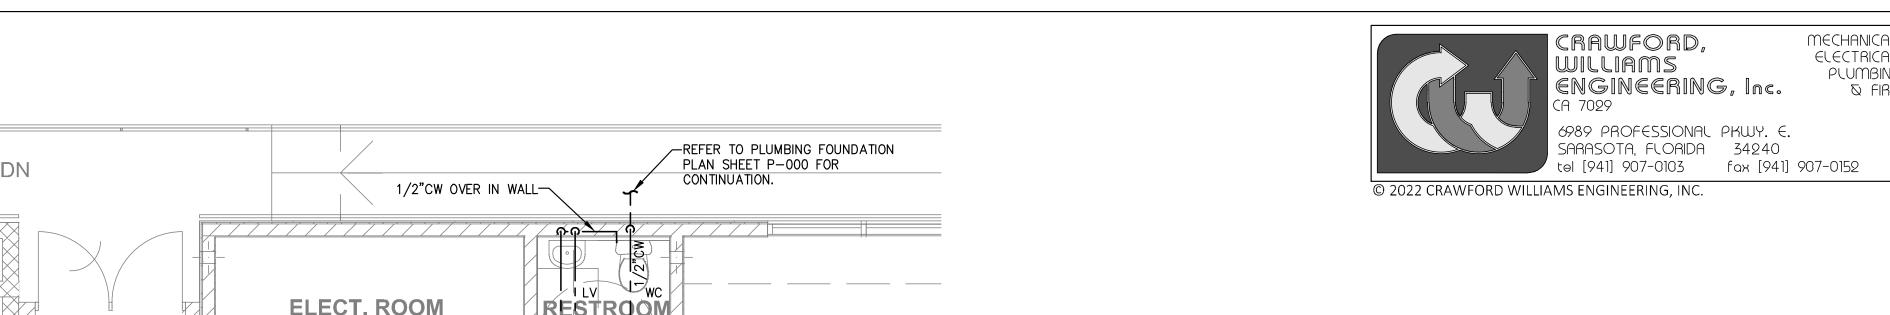
FOUNDATION PLUMBING PLAN

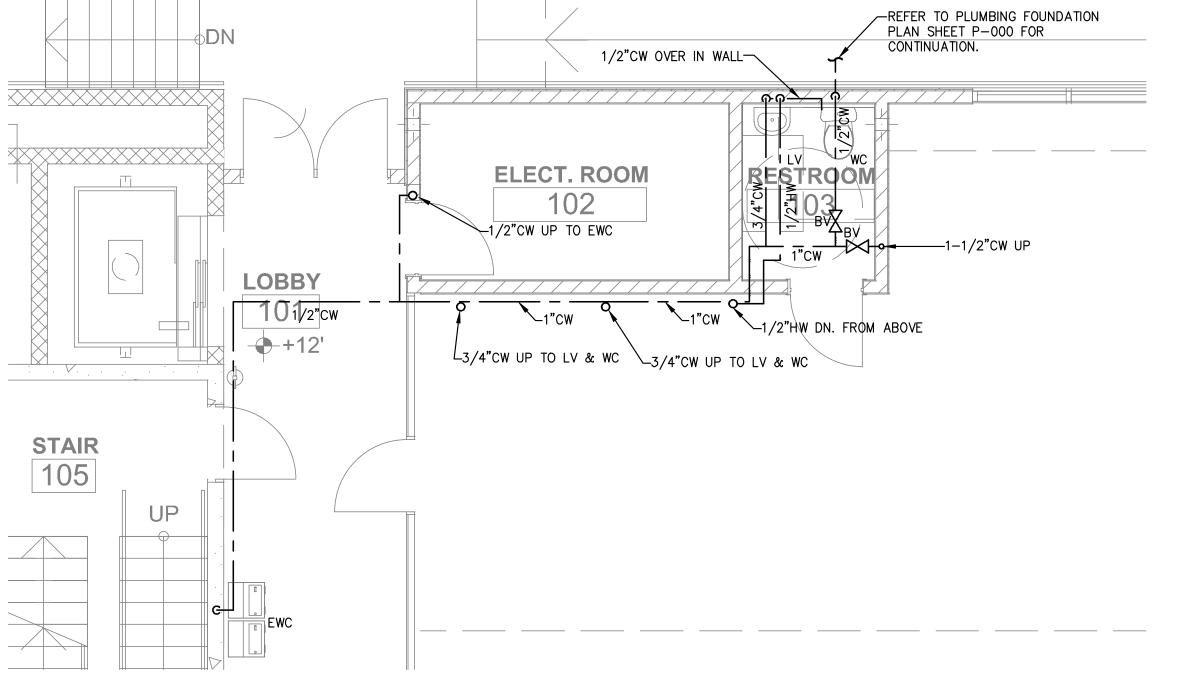
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NOKOMIS OFFICE Drawing Name: CWE Design: 08/24/2022 Issues: Job No.: 2203

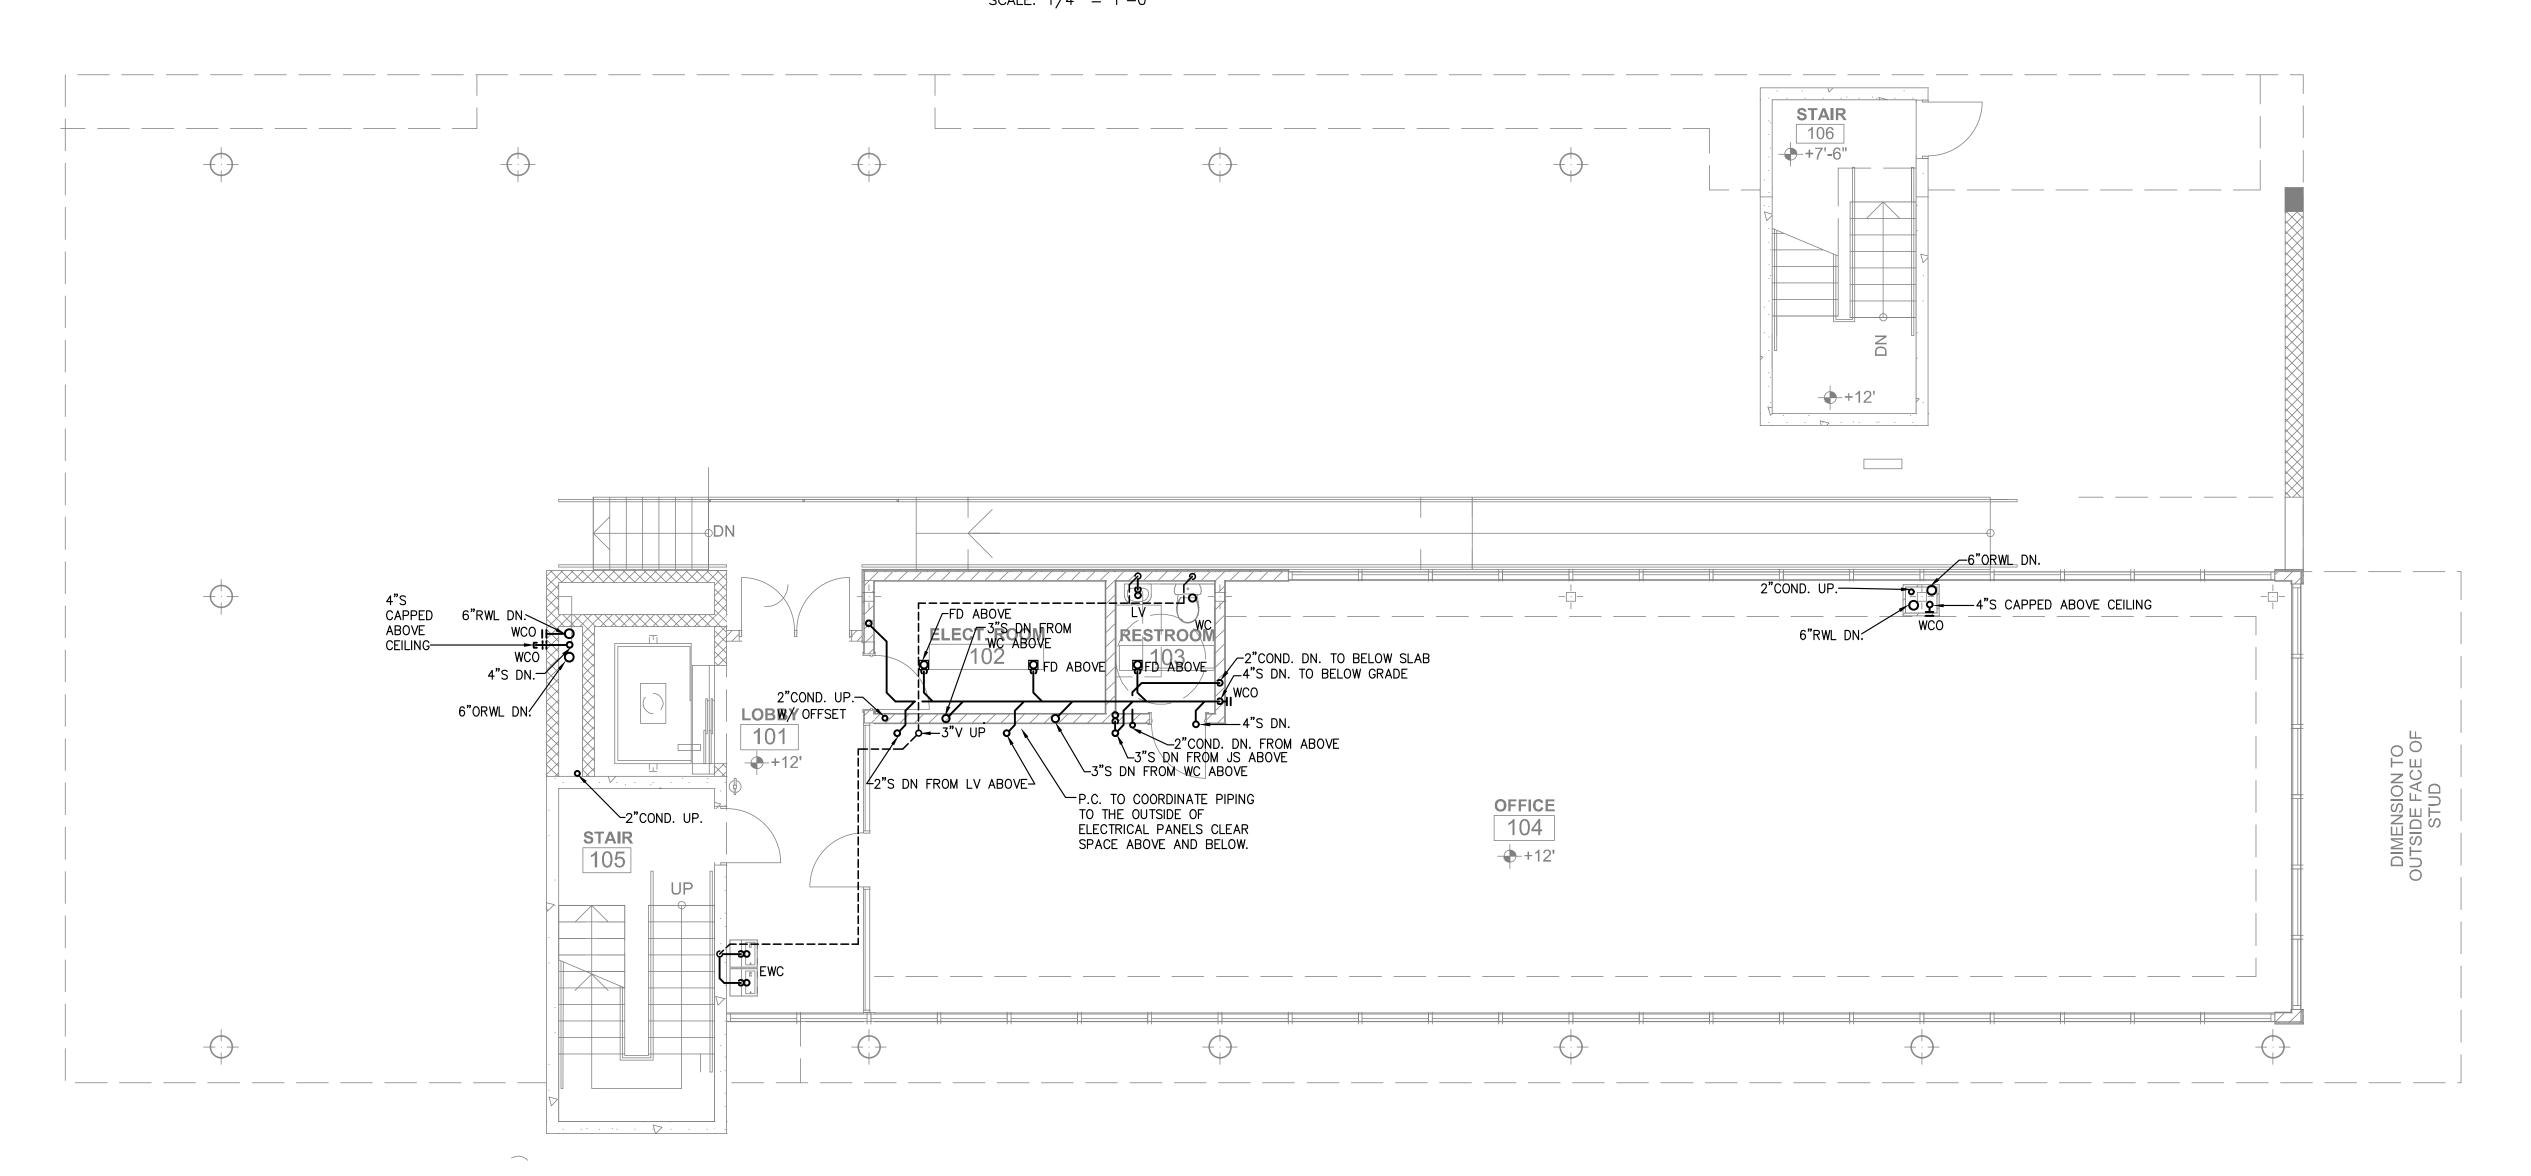
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FIRST FLOOR DOMESTIC WATER PIPING PLAN SCALE: 1/4" = 1'-0"



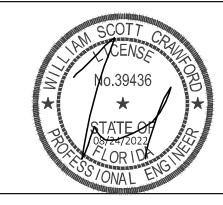
FIRST FLOOR SANITARY WASTE VENT AND STORM PIPING PLAN SCALE: 3/16" = 1'-0"



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FIRST FLOOR PLUMBING PLAN

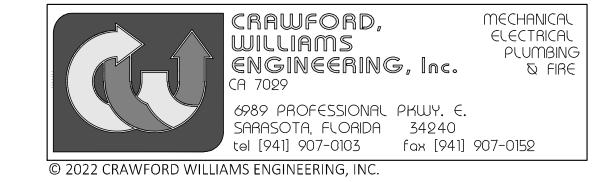
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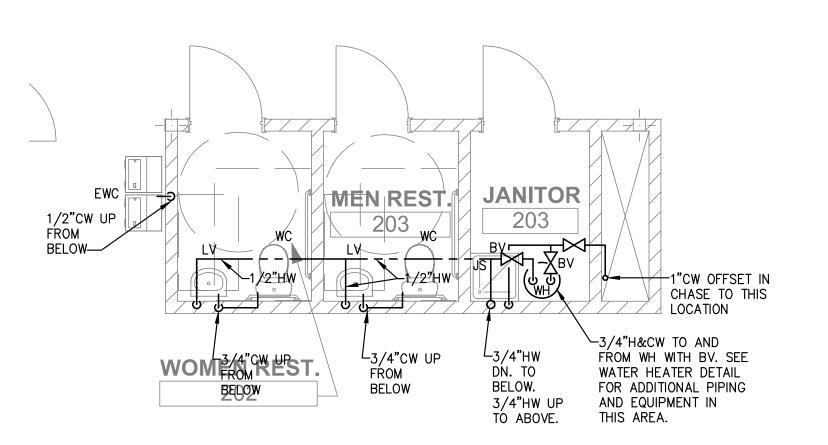
Drawing Name: NOKOMIS OFFICE CWE

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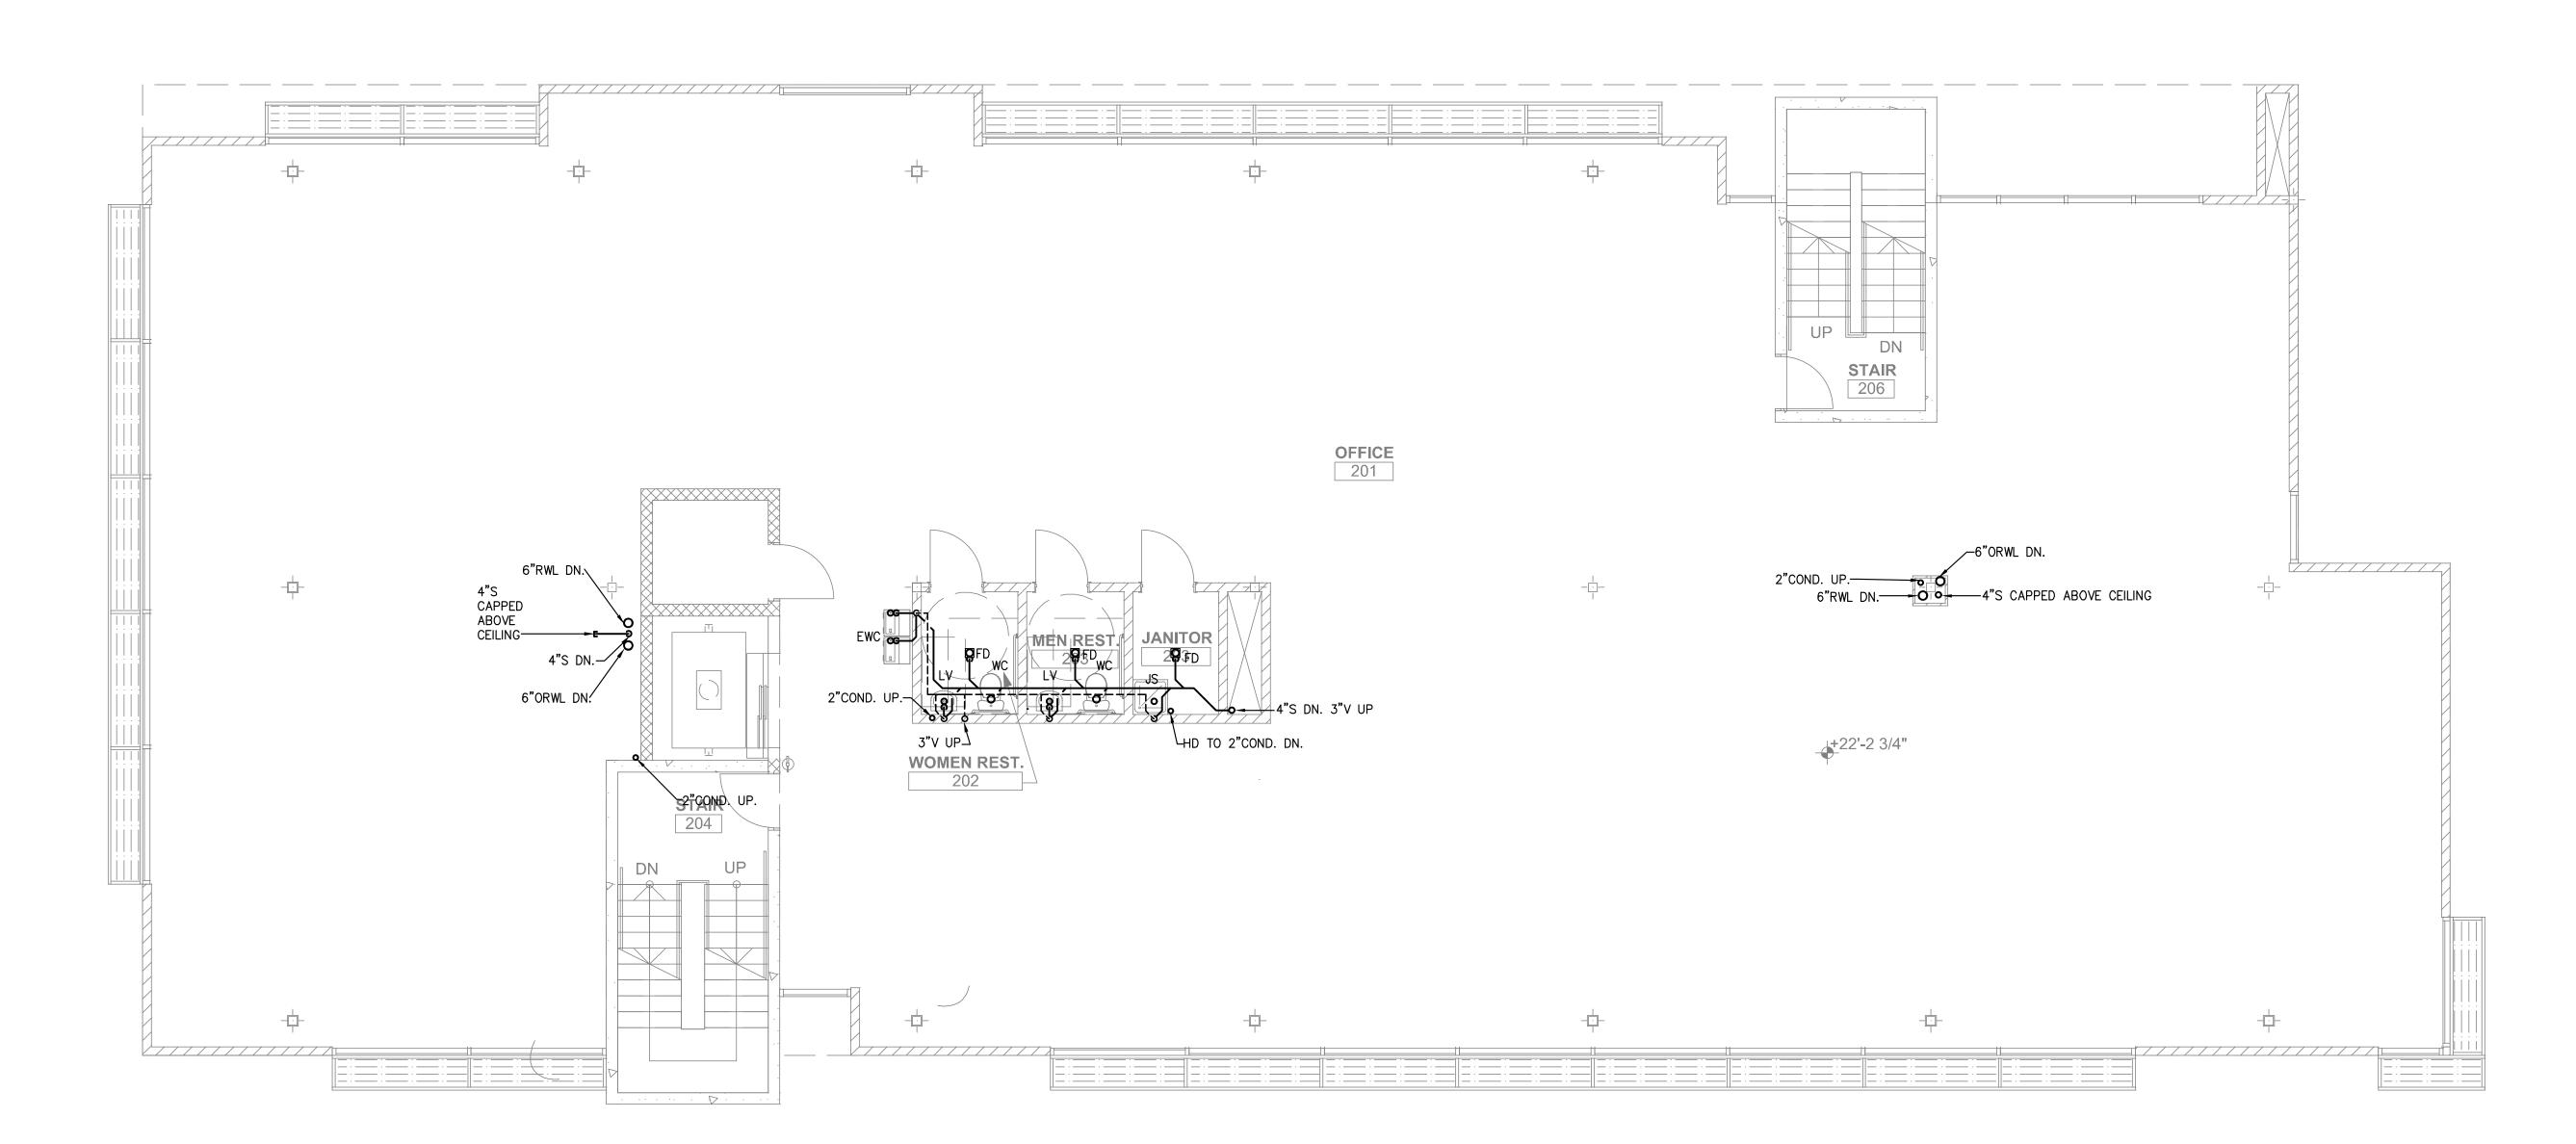
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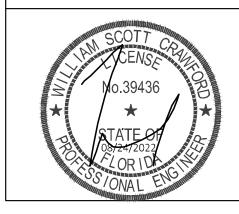
SECOND FLOOR DOMESTIC WATER PIPING PLAN SCALE: 1/4" = 1'-0"



SECOND FLOOR SANITARY WASTE VENT AND STORM PIPING PLAN SCALE: 3/16" = 1'-0"

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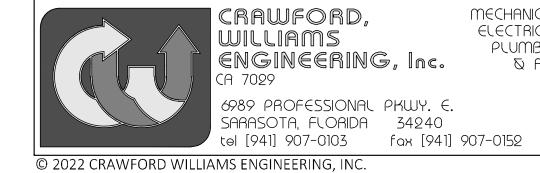
SECOND FLOOR PLUMBING PLAN

Sheet Title

Drawing Name: NOKOMIS OFFICE CWE Issues: 08/24/2022

Sheet Number:

2203

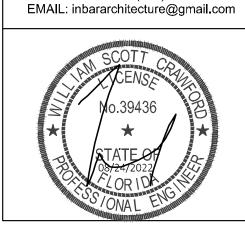


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ROOF PLUMBING PLAN

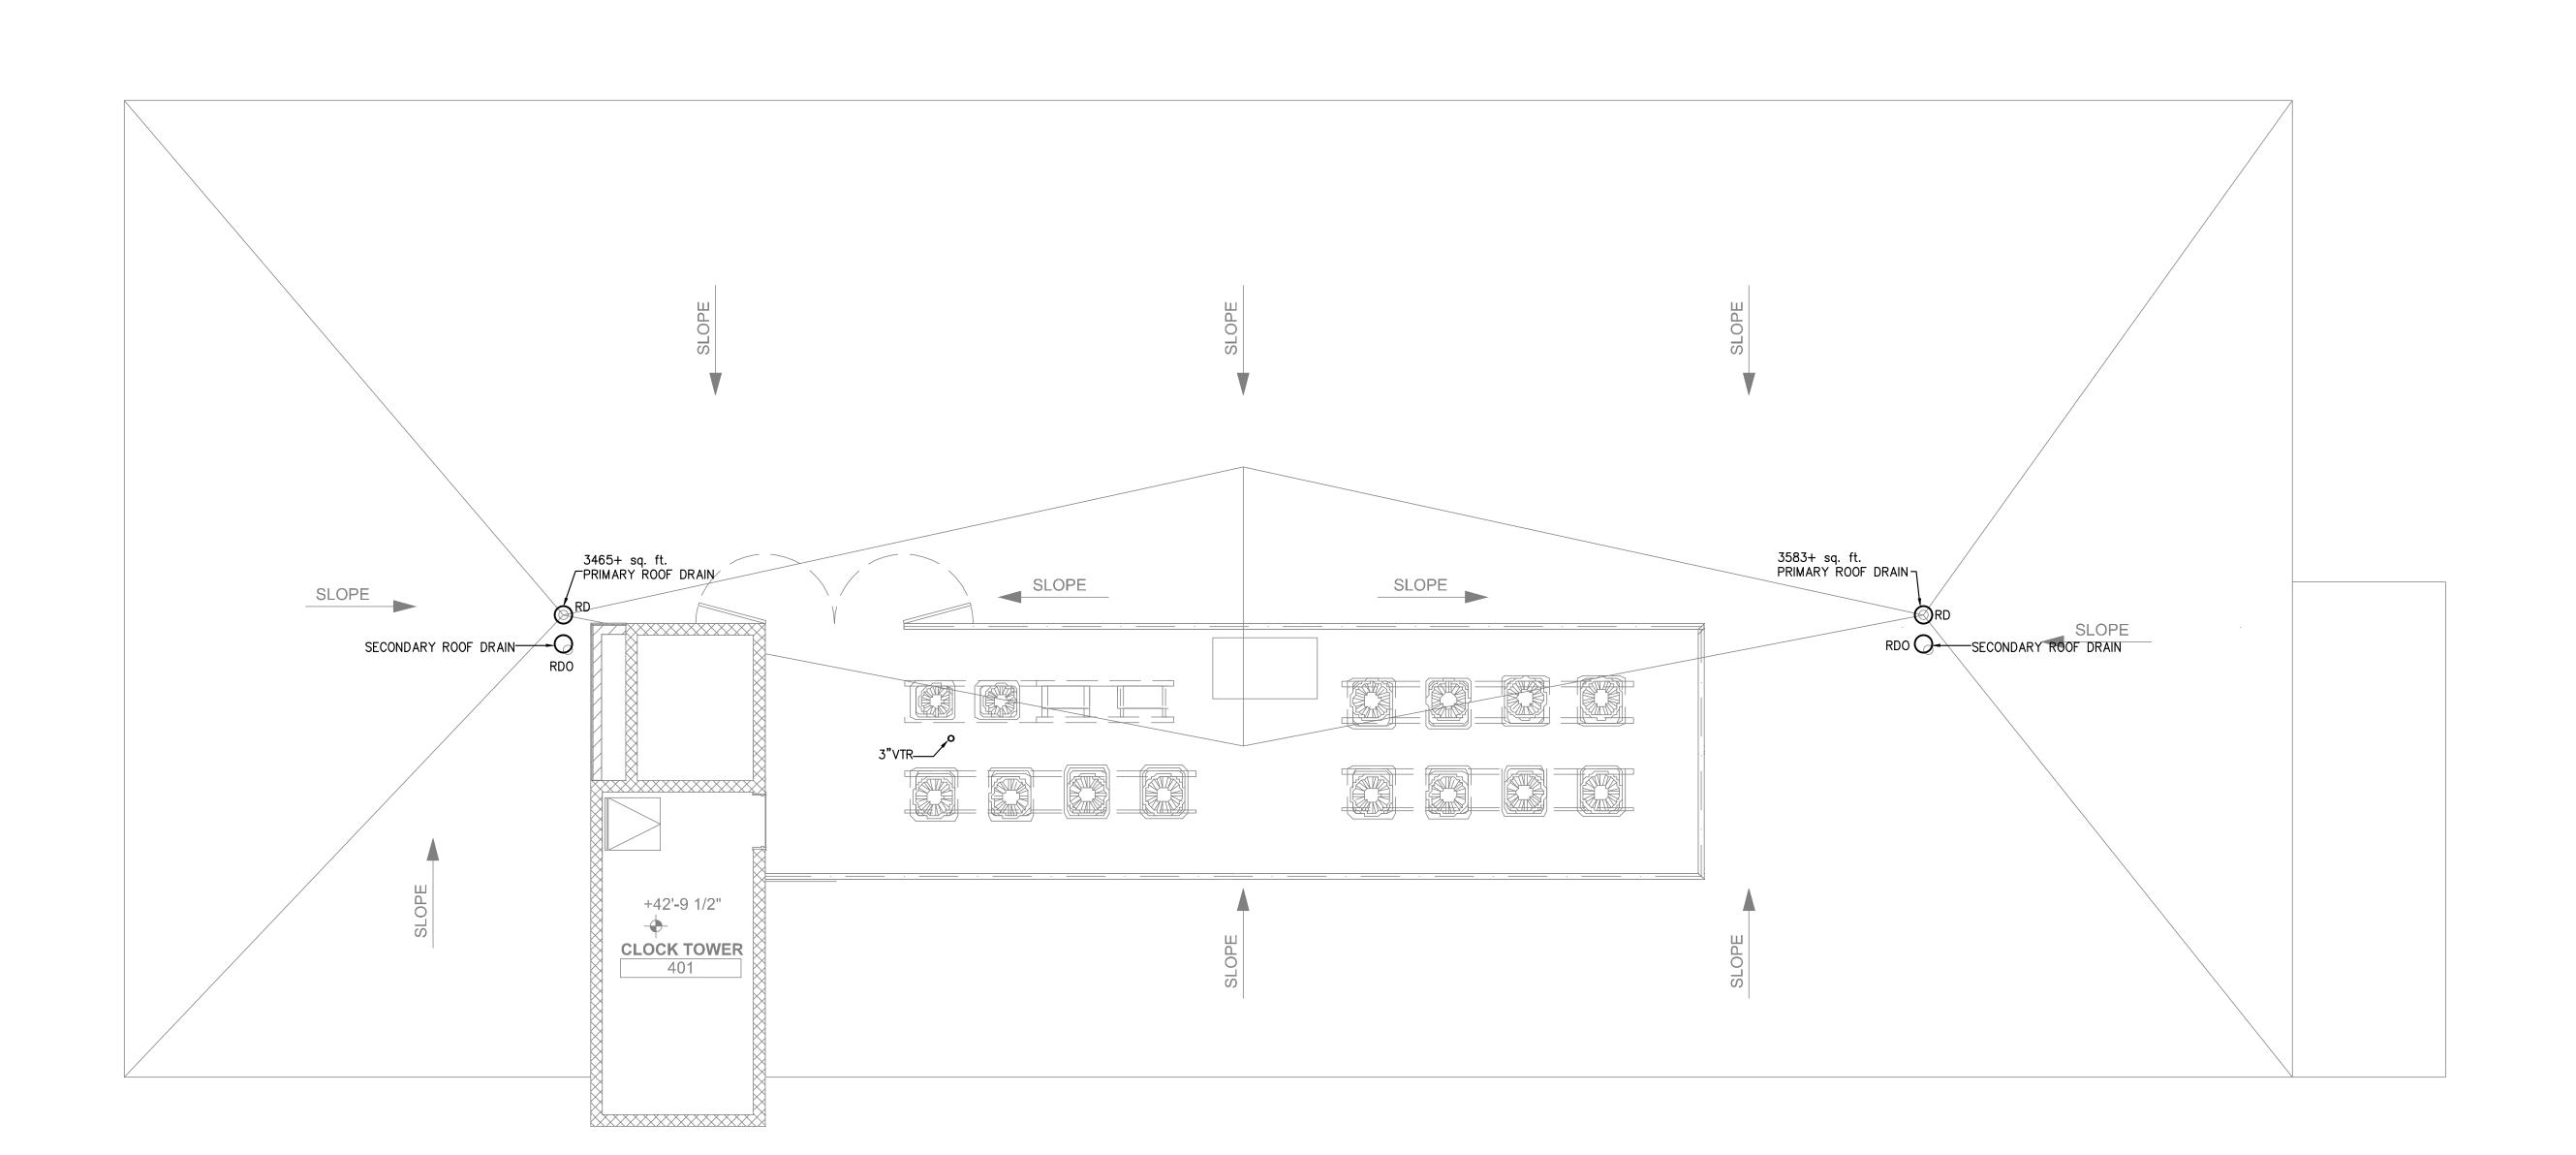
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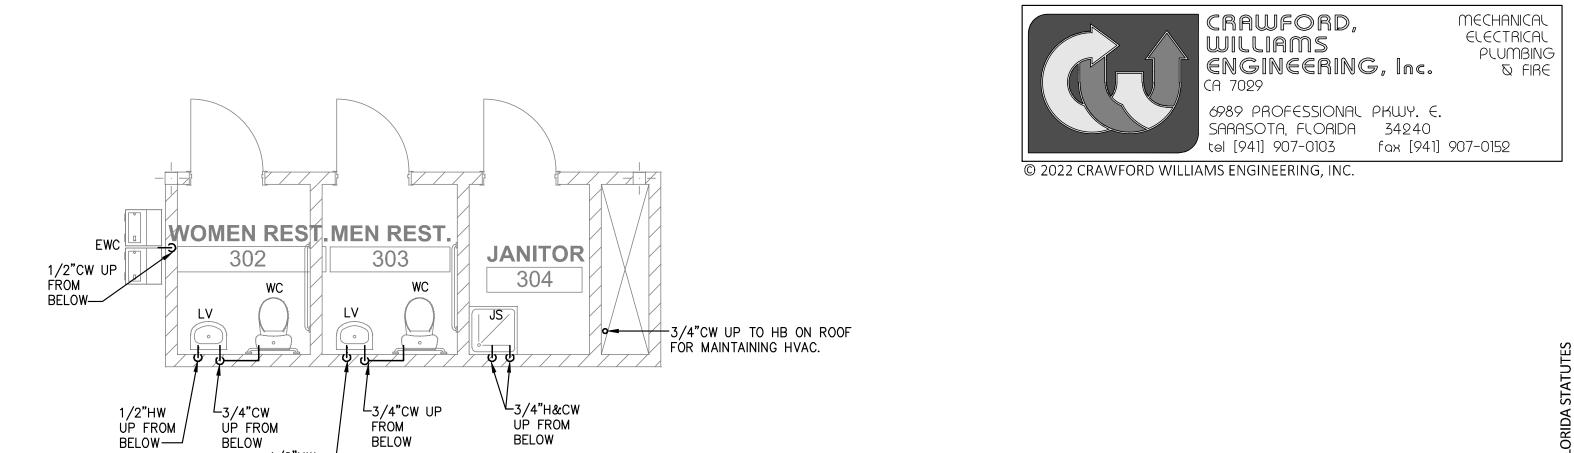
Drawing Name: NOKOMIS OFFICE CWE 08/24/2022

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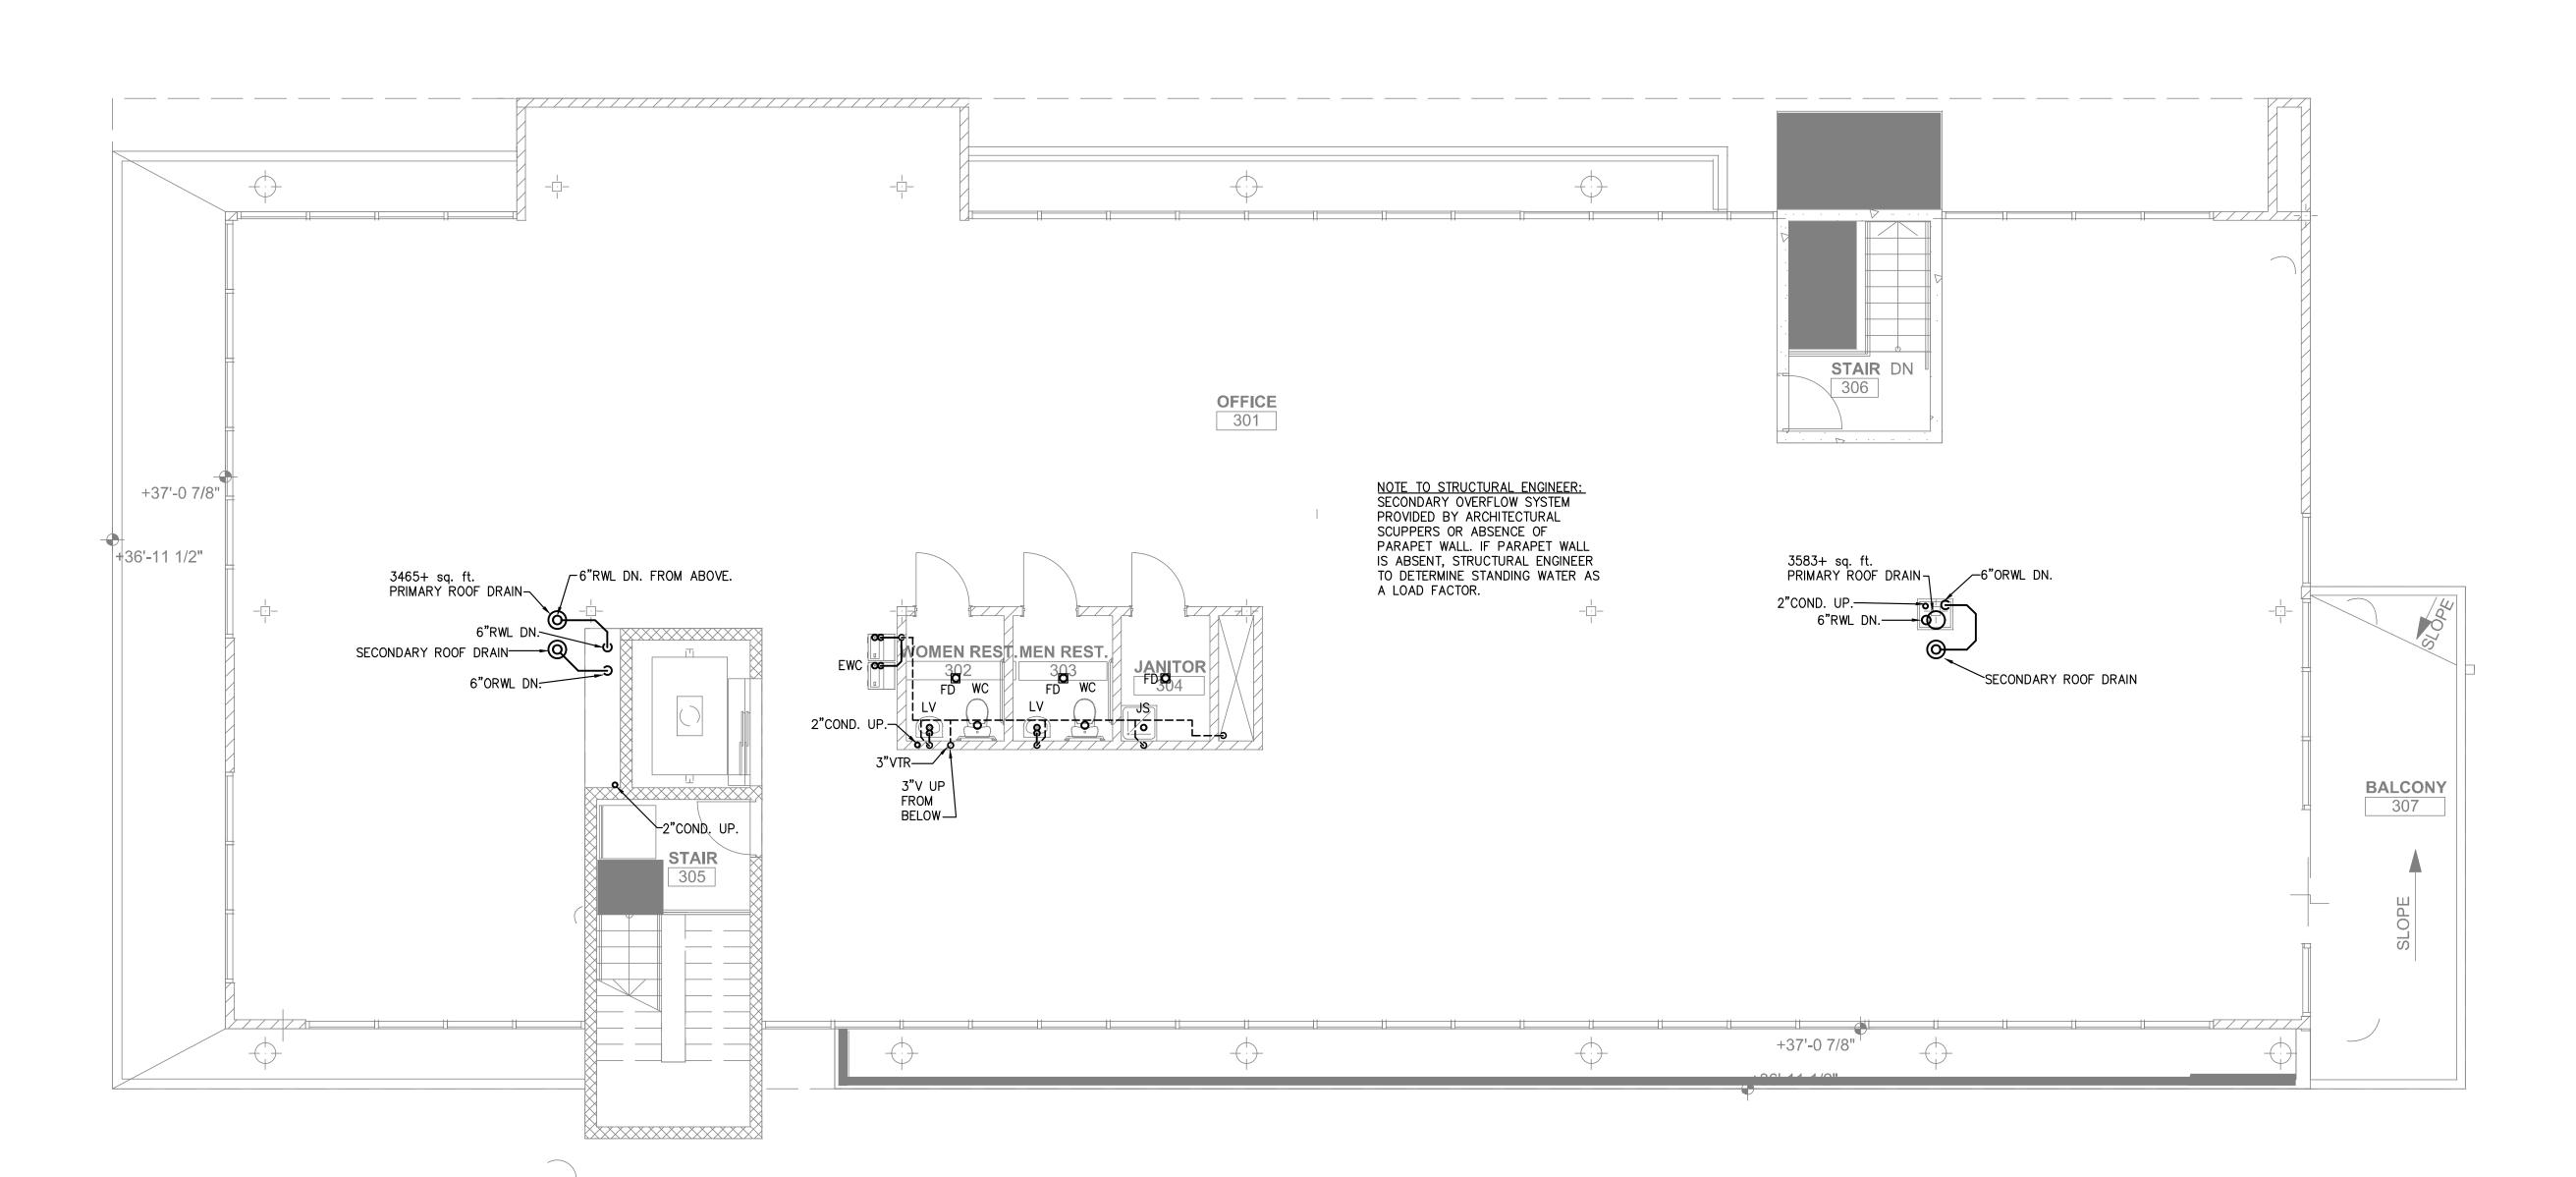




THIRD FLOOR DOMESTIC WATER PIPING PLAN SCALE: 1/4" = 1'-0"

1/2"HW UP FROM BELOW

BELOW

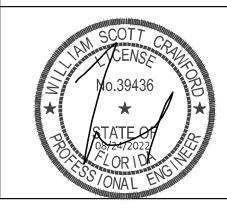


THIRD FLOOR SANITARY WASTE VENT AND STORM PIPING PLAN SCALE: 3/16" = 1'-0"

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THIRD FLOOR PLUMBING PLAN

Sheet Title

Drawing Name: NOKOMIS OFFICE CWE Design: Issues: 08/24/2022

2203

Job No**.**: Sheet Number:

	PLUMBING FIXTURE SCHEDULE																																																																																																								
LT	R DESCRIPTION	MANUFACTURER	CATALOG NO.			PIPE SIZES			E		ELEC		ELEC		OTHER
				CW	HW	TRAP	SAN*	VT	VOLT	PH	AMPS	HP																																																																																													
RI	PRIMARY ROOF DRAIN	ZURN LC	RD-2120	_	_	_	_	_	_	_	_	_	ADD ZURN W4 FOR ROOF DRAIN OVERFLOW																																																																																												
WC	WALL CLEAN OUT	ZURN LC	CO-2530-SS	_	-	-	SEE PLANS	-	-	-	_	_	MOUNT AT 24" ABOVE FINISHED FLOOR WITH ZURN "LC" CO-2411																																																																																												
C	FLOOR CLEAN OUT	ZURN LC	CO-2500	_	_	_	SEE PLANS	_	_	_	_	_	MOUNT FLUSH WITH FLOOR.																																																																																												
W	WATER CLOSET, 0.8 GAL PER FLUSH ADA	ECOTECH	ECOCLOSET	1/2"	_	-	3"	SEE PLAN	-	-	_	-	PROVIDE W/ BEMIS 1955C PLASTIC SEAT LESS COVER AND LEVER ON WIDE SIDE OF TANK																																																																																												
LV	WALL HUNG LAVATORY	AMERICAN STANDARD	0321.026	1/2"	_	1 1/2"	2"	1-1/2"	_	_	_	_	PROVIDE WITH SYMMONS S-20-2, TRUEBRO LAV GUARD 2 AND MOUNT WITH ZURN Z1231 CONCEALED ARM SYSTEMS *																																																																																												
EW	C ELECTRIC WATER COOLER	HALSEY TAYLOR	HTV8BLR-Q	1/2"	_	1 1/2"	2"	1-1/2"	120	1	FLA4.0	_																																																																																													
W	WATER HEATER	RHEEM/RUUD	MR40245	3/4"	3/4"	-	_	-	208	1	4.5KW	_	SEE DETAIL FOR ADDITIONAL EQUIPMENT AND PIPING																																																																																												
JS	JANITORS SINK	EL MUSTEE	M32	1/2"	1/2"	2"	3"	2"	-	_	_	_	PROVIDE WITH ALL POSSIBLE OPTIONS INCLUDING FAUCET*																																																																																												
HC	HUB DRAIN	ZURN	Z325	_	_	-	_	-	-	_	-	_	SEE DETAIL																																																																																												
FE	WATERLESS TRAP FLOOR DRAIN	ECHTECH	ECODRAIN	-	-	-	3"	-	-	-	-	-	- **																																																																																												
81	LOWFLOW SHOWER HEAD	ECHTECH	ECOSHOWER	1/2"	_	-	_	-	-	_	-	_	PROVIDE WITH 3305 CENTRAL BRASS PULL VALVE																																																																																												
WH	WALL MOUNTED HYDRANT	WOODFORD	B24	1/2"	_	-	_	_	-	_	_	-	-																																																																																												
FC	FLOOR DRAIN	ZURN	415S	-	-	-	_	-	-	-	-	-	-																																																																																												

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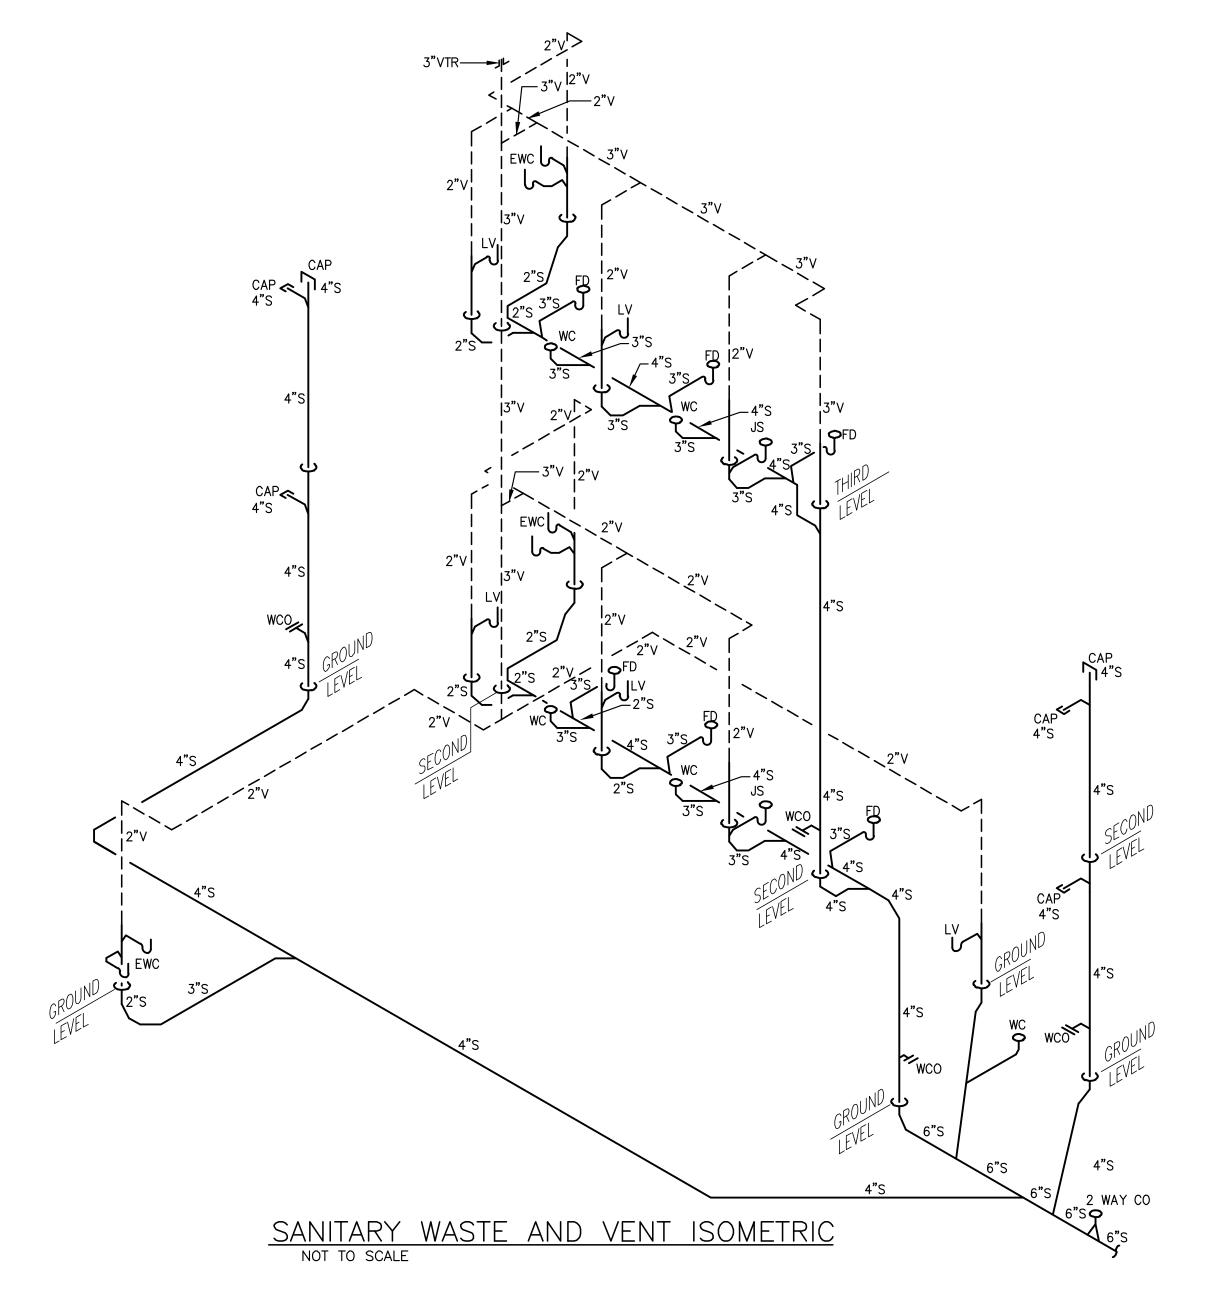
MINIMUM LINDERGROUND WASTE PIPING SIZE IS 2

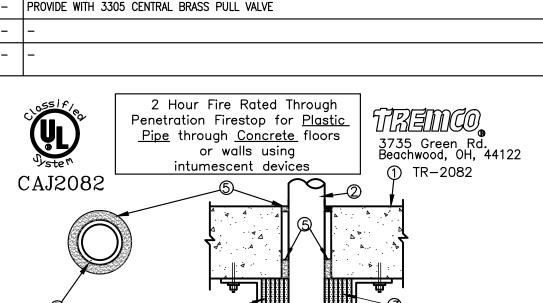
MINIMUM	UNDE	นหบบทบ	WAS		כ טאוו	IZE IS Z	
*PROVIDE	WITH	ECOTECH	LOW	FLOW	SINK	AERATORS	0.33
**ADD ALT	ERNAT	E.					

	PLUMBING FIXTURE UNIT SCHEDULE									
		WATER DEMAND SANITARY							ARY	
QUANITY	DESCRIPTION	FIXTURE UNIT (FU) (EACH)		FIXTURE UNITS (TOTAL)			TOTAL	FIXTURE UNIT (FU)		
		COLD	нот	COMB.	COLD	нот	сомв.	GPM	FU (EA.)	TOTAL FU
3	DRINKING FOUNTAIN	0.25		0.25	0.75		0.75		0.5	1.50
5	LAVATORY (PUBLIC)	1.5	1.5	2.0	7.50	7.50	10.00		2.0	10.00
2	SINK SERVICE	2.25	2.25	3.0	4.50	4.50	6.00		2.0	4.00
5	WATER CLOSET, PUBLIC FLUSH TANK	5.0		5.0	25.00		25.00		4.0	20.00
				TOTAL	37.75	13.50	41.75	27.70		35.5

(1) TOTAL OF 25.0 GPM DEMAND BASED ON SYSTEM PREDOMINANTLY FOR FLUSH TANK.

(2) SYSTEM WILL REQUIRE 1-1/2" WATER MAIN. (3) SYSTEM WILL REQUIRE 1-1/2" WATER METER.





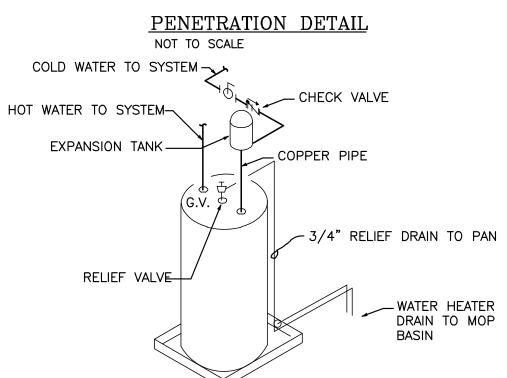
- T-rating = 2 Hr.Floor or Wall assembly = Min. 4 1/2" thick concrete 2 Plastic Pipe - 4" (or smaller) Sch. 40 PVC pipe for use in closed or vented piping systems with a max. annular space of 1/4".
- ③ TREMstop WS wrap strips, tightly wrapped 6 times
- around pipe. TREMstop MCR - steel restricting collar

F-rating = 2 Hr.

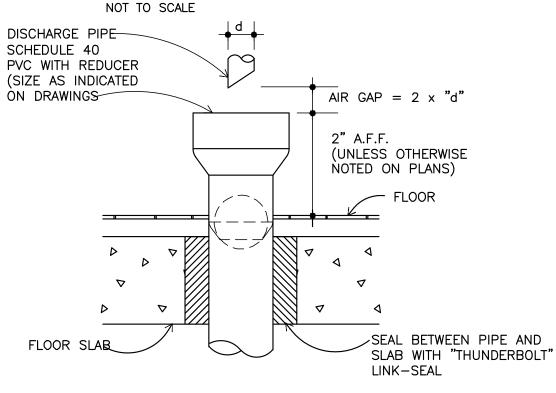
(5) FYRE-SIL - Min. 1" thick sealant applied within annulus, flush with bottom of floor or both surfaces of wall.

In floors, apply an additional 1/4" thickness sealant within annulus flush with top surface of floor.

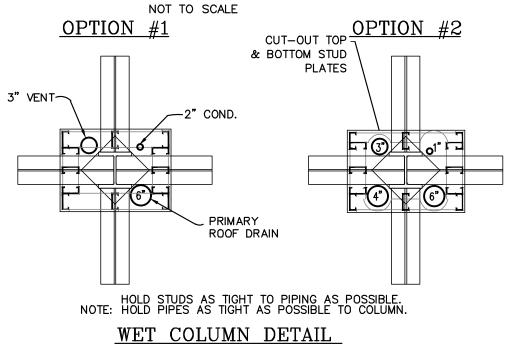
NOTE: In walls, install TREMstop WS/MCR device to both sides of wall.



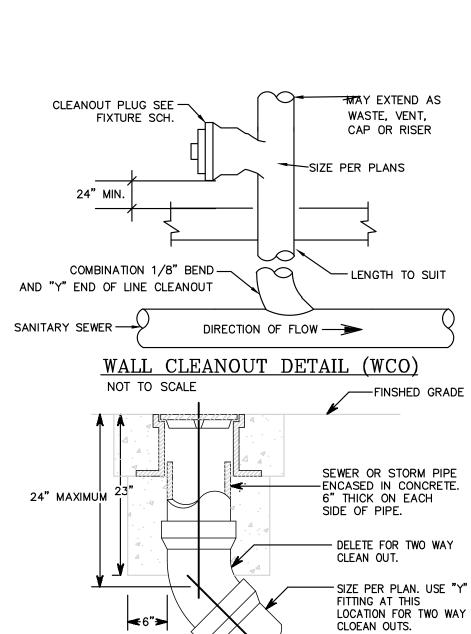
WATER HEATER DETAIL



HUB DRAIN DETAIL



NOT TO SCALE



PLUMBING LEGEND

PRESSURE REDUCING VALVE

GAS VALVE

CHECK VALVE

BALANCE VALVE

BALL VALVE

NOTE: NOT ALL MAY APPLY TO THIS PROJECT.

SYMBOL

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DESCRIPTION

FLOOR CLEANOUT DETAIL (FCO) NOT TO SCALE

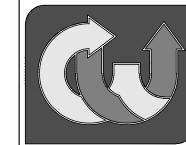
	PIPING LEGEND					
SYMBOL	DESCRIPTION					
	COLD WATER PIPING (INSIDE BLDG) — TYPE "L" COPPER. BELOW FLOOR SHALL BE SEAMLESS TUBING. (OUTSIDE BLDG) —SCH 80 CPVC					
	HOT WATER PIPING — TYPE "L" COPPER BELOW FLOOR SHALL BE SEAMLESS TUBING					
	(ABOVE FLOOR) SANITARY PIPING — SCHEDULE 40 PVC (UNDERGROUND) SANITARY PIPING — SCHEDULE 40 PVC					
	STORM DRAINAGE PIPING BELOW GRADE - PVC ASTM STORM DRAINAGE PIPING ABOVE GRADE - PVC ASTM					
—GAS—GAS—GAS—	LP GAS PIPING PAINTED BLACK STEEL					

NOTE: NOT ALL MAY APPLY TO THIS PROJECT.

BEYOND EDGE OF

CLEANOUT PLUG

	PL	UMBING NOMENO	CLATU	RE	
AFF	-	ABOVE FINISHED FLOOR	IMB	_	ICE MAKER BOX CONNECTION
AG	_	AIR GAP FITTING	JS	-	JANITOR'S SINK
BD	-	BIDET	KS	_	KITCHEN SINK
BS	_	BAR SINK	LP	-	LIQUID PETROLEUM
BT	_	BATHTUB	LS	_	LAUNDRY SINK
BV	_	BALL VALVE	LAV	-	LAVATORY
CN	_	CAN WASH	MFR	_	MANUFACTURER
CO	_	CLEANOUT	MS	_	MOP SINK
CV	_	CHECK VALVE	MW	-	MAKE-UP WATER
CW	_	COLD WATER	NG	_	NATURAL GAS
C	_	CONDENSATE	PC	_	PLUMBING CONTRACTOR
CTE	_	CONNECT TO EXISTING	PRWL	_	PRIMARY RAIN WATER LEADER
DF	_	DRINKING FOUNTAIN	RDO	_	SECONDARY ROOF DRAIN OVERFLOW
DW	_	DISHWASHER	RD	_	PRIMARY ROOF DRAIN
EC	_	ELECTRICAL CONTRACTOR	RWL	_	RAIN WATER LEADER
ET	_	EXPANSION TANK	RWLO	_	RAIN WATER LEADER OVERFLOW
FC0	_	FLOOR CLEANOUT	RTU	_	ROOF TOP UNIT
FD	_	FLOOR DRAIN	SC	_	SITE CONTRACTOR
FS	_	FLOOR SINK	SH	_	SHOWER
GC	_	GENERAL CONTRACTOR	SK	_	SINK
GD	_	GARBAGE DISPOSAL	SRWL	_	SECONDARY RAIN WATER LEADER
HB	_	HOSE BIB	TWCO	_	TWO WAY CLEANOUT
HC	_	HVAC CONTRACTOR	TPV	_	TRAP PRIMER VALVE
HCW	_	HOT & COLD WATER	TYP	_	TYPICAL
HD	_	HUB DRAIN	UR	_	URINAL
HHCW	_	140 °F HOT & COLD WATER	VT	_	VENT
HHW	_	140 °F HOT WATER	VTR	_	VENT THROUGH ROOF
HHWR	_	140 °F HOT WATER RETURN	WC	_	WATER CLOSET
HRU	_	HEAT RECOVERY UNIT	WCO	_	WALL CLEANOUT
HS	_	HANDS SINK	WH	_	WATER HEATER
HW	-	HOT WATER	WM	_	WASH MACHINE
HWR	-	HOT WATER RETURN	••••		



CRAWFORD, WILLIAMS ENGINEERING, Inc. TA 7029

6989 PROFESSIONAL PKWY. E. SARASOTA, FLORIDA 34240 tel [941] 907-0103 fax [941] 907-0152

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PIPING NOTES AND SPECIFICATIONS:

GENERAL

PIPING SHALL NOT BE PERMANENTLY CLOSED-UP, FURRED-IN, OR COVERED OVER PRIOR TO BEING TESTED AND INSPECTED. ENGINEER REQUIRES 5 DAY NOTICE PRIOR TO INSPECTION. FAILURE TO COMPLY MAY RESULT IN THE UNCOVERING OF PIPING AT THE PLUMBER'S EXPENSE.

PIPING SHALL BE ARRANGED TO MAINTAIN HEADROOM, KEEP PASSAGEWAYS AND ACCESS OPENINGS CLEAR AND WHERE NECESSARY, BE OFFSET TO MAINTAIN THE REQUIRED CLEARNESS AND COINCIDE WITH THE STRUCTURAL FEATURES OF THE

PIPING SHALL BE INSTALLED AT A HEIGHT SO AS NOT TO OBSTRUCT ANY PORTION OF A WINDOW, LIGHT FIXTURE, DOORWAY, PIPE TUNNEL, OR PASSAGEWAY. VERIFY CLEARANCES WITH ARCHITECTURAL SECTIONS PRIOR TO

INSTALL PIPING STRAIGHT, PLUMB, AND AS DIRECT AS POSSIBLE; FORM RIGHT ANGLES OR PARALLEL LINES WITH BUILDING WALLS.

LOCATE GROUPS OF PIPES PARALLEL TO EACH OTHER KEEPING PIPES CLOSE TO WALLS, PARTITIONS, CEILING; OFFSETTING ONLY WHERE NECESSARY TO FOLLOW WALLS AS DIRECTED.

INSTALL HORIZONTAL PIPING AS HIGH AS POSSIBLE WITHOUT SAGS OR HUMPS. EXPOSED AND OR EXTERIOR PVC PIPING TO BE PAINTED WITH UV PROTECTIVE COATING, COLOR TO BE CHOSEN BY ARCHITECT.

WHERE FURRED SPACES ARE INDICATED, KEEP PIPES AS CLOSE TO STRUCTURAL MEMBERS AS POSSIBLE SO AS TO REQUIRE MINIMUM FURRINGS.

ESCUTCHEONS ARE REQUIRED WHERE PIPES PASS THROUGH A FINISHED SURFACE. ESCUTCHEON SHALL FIT FLUSH WITH WALL OR FLOOR AND SHALL FIT

SNUGLY AROUND THE PIPE.

ALL PIPE FLOOR PENETRATIONS TO BE PROTECTED WITH THE APPROPRIATE "PROSET OR TREMCO" FIRESTOPPING PENETRATORS. WALLS PENETRATIONS SHALL BE PROTECTED WITH THE APPROPRIATE "SPEC-SEAL 100" FIRESTOPPING METHOD.

ANY SURFACES REQUIRED TO BE PAINTED SHALL BE CLEANED OF RUST, GREASE,

VENT THROUGH ROOF SHALL TERMINATE A MINIMUM OF 15' FROM ANY AIR INTAKES AND 12" ABOVE PARAPET WALL.

CONTRACTOR SHALL ROUGH-IN ALL WASTES AND SUPPLIES TO SPECIAL EQUIPMENT ACCORDING TO MANUFACTURER'S SHOP DRAWINGS AND MAKE FINAL CONNECTIONS. ALL SUPPLIES SHALL BE VALVED. INSTALL VACUUM BREAKERS WHERE REQUIRED BY CODE.

PROVIDE BACKFLOW PREVENTERS FOR DOMESTIC WATER SUPPLIES AS REQUIRED BY LOCAL CODES AND OR WATER PURVEYORS.

ALL WATER PIPING INSTALLED IN EXTERIOR WALLS SHALL BE PLACED ON THE INTERIOR SIDE OF THE WALL, SO THAT WALL INSULATION CAN BE PLACED ON THE EXTERIOR SIDE OF THE PIPING.

DO NOT PENETRATE WALL FOOTINGS WITH PIPING, COORDINATE WITH GENERAL CONTRACTOR TO DROP FOOTINGS AS REQUIRED TO CLEAR PLUMBING SERVICES WHERE ABSOLUTELY NECESSARY. ALL PIPING PENETRATING A BEARING WALL OR FOOTING MUST BE SLEEVED AND LOCATION APPROVED BY THE STRUCTURAL

EXPOSED HOT WATER AND DRAIN PIPES UNDER HANDICAP LAVATORIES SHALL BE PROTECTED WITH "LAV-GAURD" BY TRUEBRO. WHITE UNLESS OWNER SPECIFIES. UNIONS ARE TO BE INSTALLED ON EACH SIDE OF EACH PIECE OF EQUIPMENT AND WHEREVER NEEDED TO DISMANTLE PIPING. ALL EQUIPMENT MUST BE ABLE TO BE REMOVED, AND SERVICED WITHOUT THE CUTTING OF PIPING. UNIONS MUST BE ACCESSIBLE AND ARE NOT TO BE INSTALLED IN CONCEALED WALLS, PARTITIONS, OR CEILINGS.

WASTE STORM AND DRAINAGE

ALL SANITARY AND STORM PIPING ABOVE FINISHED GROUND FLOOR TO BE NO-HUB CAST IRON. PIPING LOCATED UNDERGROUND INCLUDING BUILDING MAIN TO BE SCHEDULE 40 PVC.

ALL CONDENSATE, WATER HEATER DRAIN, AND VENT PIPING TO BE SCHEDULE 40

FOR DRAINAGE PIPING CHANGES IN DIRECTION, USE LONG-SWEEPS. WHERE NOT POSSIBLE SHORT-SWEEPS, 1/4 BENDS OR COMBINATION Y AND 1/8 BENDS, MAY BE USED. SANITARY TEES MAY ONLY BE USED FOR HORIZONTAL BRANCHES DISCHARGING INTO STACKS.

ALL SANITARY, STORM, WATER, AND CONDENSATE PIPING PASSING UNDER A FOOTING OR THROUGH A FOUNDATION WALL SHALL BE PROVIDED WITH A PIPE SLEEVE OF SCHEDULE 40 PVC BUILT INTO THE MASONRY WALL. SLEEVE SHALL BE TWO PIPE SIZES GREATER THAN THE PIPE PASSING THROUGH.

WATER HEATER AND AIR CONDITIONING DRAINS AND RISERS SHALL BE SCHEDULE

ALL DRAINAGE PIPING SHALL BE MARKED WITH THE SEAL OF APPROVAL OF THE NATIONAL SANITATION FOUNDATION.

ALL EXPOSED PVC PIPING TO BE CLEANED WITH CLEAR CLEANER AND THEN PRIMED AND PAINTED WITH A LATEX BASE PAINT COLOR TO BE CHOSEN BY ARCHITECT. THIS INCLUDES ALL EXPOSED PVC PIPING IN GARAGE.

WATER PIPING

WATER PIPING ABOVE GRADE TO BE CPVC. NO FITTINGS ARE TO BE INSTALLED BENEATH THE FINISHED SLAB. SEE CIVIL ENGINEER'S SITE PLAN FOR BUILDING SERVICE PIPING TYPE.

PIPING RUNNING PARALLEL TO CONCRETE SHALL BE ISOLATED FROM CONCRETE STRUCTURE UTILIZING AN OFFSET HANGER OF THE APPROPRIATE MATERIAL. ALL WATER PIPING PASSING THROUGH METAL STUD WALLS SHALL BE ISOLATED FROM STUDS WITH METAL STUD INSULATOR, VERTICAL PIPING RUNS IN STUD

WALLS WILL BE SUPPORTED TO LIMIT EXCESS MOVEMENT WITHIN THE WALL WITH

CONNECTIONS BETWEEN DISSIMILAR METALS SHALL BE MADE WITH DIELECTRIC UNIONS OR DIELECTRIC ADAPTERS.

A PIPE SUPPORT BRACKET.

ALL WATER PIPING IS TO BE ISOLATED FROM METAL WALL STUDS SO THAT NO CONTACT IS MADE.

PLASTIC PIPING PASSING THROUGH STUDS SHALL BE PROTECTED FROM DRYWALL SCREWS WITH A GALVANIZED STEEL PLATE.

WATER HAMMER ARRESTORS SHALL BE MECHANICAL PISTON TYPE AS PER PDI-WH201. ARRESTORS SHALL BE RATED BY MANUFACTURER FOR CONCEALED LOCATIONS IN AREAS WHERE THERE IS NO ACCESS. AIR CHAMBERS SHALL NOT BE CONSIDERED EQUIVALENT AND WILL NOT BE ACCEPTED.

WATER HAMMER ARRESTORS SHALL BE INSTALLED AT EVERY QUICK CLOSING VALVE, INCLUDING, WASH MACHINES, DISHWASHERS, ICE MACHINES, SHOWERS AND BATHS, SINKS AND LAVATORIES WITH SINGLE LEVER FAUCETS.

PLUMBING FIR∈

MECHANICAL

ELECTRICAL

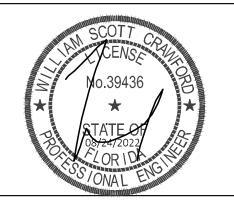
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REVISIONS

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PLUMBING NOTES AND DETAILS

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NOKOMIS OFFICE Drawing Name: CWE Design: 08/24/2022 Issues:

Job No.: Sheet Number:

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