


GENERAL INFORMATION

THANK YOU FOR CHOOSING DESIGN SERVICES FOR YOUR DESIGN NEEDS. WE ASK THAT IF YOU HAVE NOT DONE SO ALREADY, PLEASE TAKE A MOMENT TO REVIEW THESE PLANS TO INSURE THEY INCLUDE THE CORRECT NUMBER OF SHEETS. ALSO MAKE SURE YOU HAVE RECEIVED THE CORRECT NUMBER OF SETS, IN MOST CASES (5). IF YOU ARE MISSING ANY SHEETS OR SETS PLEASE NOTIFY OUR OFFICE.

THESE PLANS WERE PREPARED BY A TEAM OF DESIGN PROFESSIONALS WITH YEARS OF DESIGN AND CONSTRUCTION EXPERIENCE. IT IS OUR SINCERE GOAL TO INSURE SATISFACTION IN OUR PLANS. WE USE THE LATEST SOFTWARE AND AGE OLD SKILLS TO DESIGN AND GENERATE HIGH QUALITY PLANS. HOWEVER, MISTAKES HAPPEN AND ERRORS OCCUR. IT IS THE RESPONSIBILITY OF THE OWNER AND/OR CONTRACTOR TO REVIEW THESE PLANS FOR ANY ERRORS AND OMISSIONS. IF ANY ARE FOUND NOTIFY OUR OFFICE IMMEDIATELY BEFORE CONSTRUCTION BEGINS. DESIGN SERVICES NOR ANY OF IT'S SUBCONTRACTORS CAN BE HELD RESPONSIBLE FOR ANY PROBLEMS NOT BROUGHT TO OUR ATTENTION BEFORE CONSTRUCTION BEGINS.

CONSTRUCTION DRAWINGS CANNOT BE USED AS AN INSTRUCTIONAL OR, STEP BY STEP "HOW TO GUIDES" TO BUILD A HOME. IN THE HANDS OF A PROFESSIONAL CONTRACTOR OR SUBCONTRACTOR THEY SERVE AS TECHNICAL GUIDE THAT SHOWS THE CORRECT SIZE AND PLACEMENT OF STRUCTURAL AND/OR COSMETIC ELEMENTS, GENERALLY PREPARED BY OUR STAFF AT THE DIRECTIONOF THE OWNER OR BUILDER. IF YOU HAVE MADE THE DECISION TO BUILD YOUR OWN HOME WE SUGGEST BEFORE DOING SO YOU FIRST SEEK THE ASSISTANCE OF A CONSTRUCTION CONSULTANT.

IT IS THE SOLE RESPONSIBILITY OF THE CONTRACTOR AND/OR BUILDER TO CONFORM TO ALL STANDARDS, PROVISIONS, REQUIREMENTS, METHODS OF CONSTRUCTION AND USES OF MATERIALS PROVIDED IN BUILDINGS AND/OR STRUCTURES AS REQUIRED BY N.C. UNIFORM BUILDING CODE, LOCAL AGENCIES AND IN ACCORDANCE WITH GOOD ENGINEERING PRACTICES. VERIFY ALL DIMENSIONS PRIOR TO CONSTRUCTION.

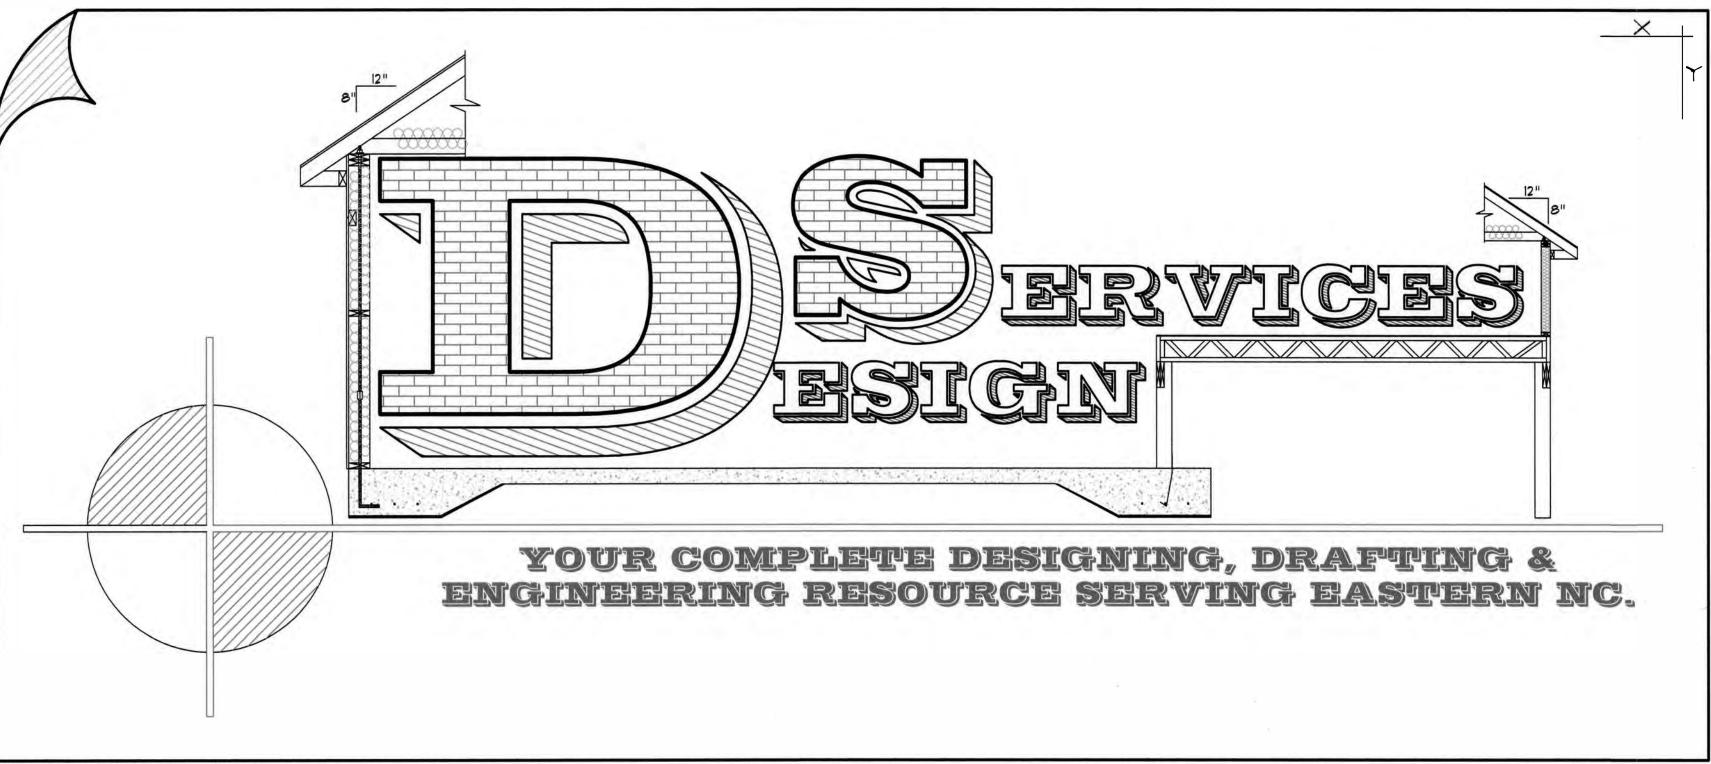

PROFESSIONAL SEALS

SOME BUILDING DEPARTMENTS MAY REQUIRE PLANS FROM A PROFESSIONAL ENGINEER OR LAND SURVEYOR.

ENGINEERING SERVICES ARE PROVIDED TO DESIGN SERVICES BY: MICHAEL C. GALLANT P.E., P.A. WHO IS LOCATED IN OUR OFFICE. ADDITIONAL ENGINEERING FEES WILL APPLY.

IN ORDER FOR AN ENGINEER TO LEGALLY AFFIX HIS SEAL TO A CONSTRUCTION DOCUMENT, IT MUST BE PREPARED UNDER HIS/HER RESPONSIBLE CHARGE & ENGINEER MUST OVERSEE THE DESIGN OF THAT DOCUMENT OR DRAWING.

PLANS WITH AN ENGINEER'S SEAL SHOULD BE FOLLOWED TO THE LETTER UNLESS THEY ARE FOUND TO BE UNSAFE BY A LICENSED CODE OFFICIAL. IF CHANGES MUST ME MADE TO COMPLY WITH STATE OR LOCAL BUILDING CODES PLEASE NOTIFY OUR OFFICE SO WE CAN REVIEW AND MAKE CHANGES ACCORDINGLY. FAILURE TO BUILD ACCORDING TO THE ENGINEERED PLANS VOIDS ALL ENGINEERING LIABILITY, SPECIFIC OR IMPLIED.

WE HAVE A PROFESSIONAL WORKING RELATIONSHIP WITH SEVERAL AREA SURVEYORS AND CAN ASSIST YOU IN FINDING ONE FOR YOUR PROJECT.

604-A N. NEW RIVER DRIVE

Surf City, NC. 23445

PHONE: 910.328-4857

FACSIMILE: 910.328-4733

E-mail: design_serv@yahoo.com WEB SITE: designservicesnc.biz

COPYRIGHT INFORMATION

HOME PLANS LIKE ALL OTHER FORMS OF MEDIA ARE PROTECTED BY FEDERAL COPYRIGHT LAWS. THEREFOR MAKING IT ILLEGAL TO REPRODUCE OR COPY THIS PLAN WITHOUT WRITTEN CONSENT OF DE/IGN/ERVICE/.

PURCHASING AN ORIGINAL "CUSTOM" PLAN FROM DE/IGN/ERVICE/
ALLOWS YOU TO BUILD A SINGLE HOME AT THE ADDRESS SPECIFIED ON
THAT PLAN. IF YOU WISH TO BUILD THIS PLAN AGAIN, AN ARRANGEMENT
CAN BE MADE WITH DE/IGN/ERVICE/ TO MAKE SUBSEQUENT SITE
SPECIFIC PLANS AVAILABLE TO THE ORIGINAL PURCHASER AT A
NOMINAL FEE. PLANS AND DRAWINGS GENERATED BY DE/IGN

/ERVICE/ REMAIN THE PROPERTY OF DE/IGN /ERVICE/.

PLEASE UNDERSTAND THAT THESE PLANS CANNOT BE REDRAWN OR REPRODUCED IN ANY WAY WITHOUT THE EXPRESS CONSENT OF DE/IGN/ERVICE/. ANY PARTY THAT TAKES PART IN DOING SO MAY BE IN VIOLATION AND COPYRIGHT LAWS AND COULD HELD ACCOUNTABLE.

ORIGINAL PLANS PRODUCED BY DE/IGN/ERVICE/ ARE AFFIXED WITH THE DE/IGN/ERVICE/ "RED SEAL OF CONFIDENCE". IF THIS SEAL DOES NOT APPEAR IN RED, THAT PLAN SHOULD BE CONSIDERED STOLEN AND OR ILLEGAL. THE PLAN SHOULD BE CONFISCATED AND DE/IGN/ERVICE/ SHOULD BE NOTIFIED IMMEDIATELY.

PURCHASER DOES HAVE THE RIGHT TO MAKE NON-STRUCTURAL FIELD CHANGES (MARK-UPS) AS DESIRED. HOWEVER, DE/IGN/ERVICE/SHALL IN NO WAY BE HELD RESPONSIBLE FOR ANY EFFECT THESE "MARK-UPS" MAY HAVE ON THE PROJECT. THIS WILL RELIEVE DE/IGN/ERVICE/ OF ANY AND ALL DESIGN RESPONSIBILITY, SPECIFIC OR IMPLIED. IF CHANGES TO YOUR PLAN ARE DESIRED PLEASE CONTACT DE/IGN/ERVICE/ AND LET US ASSIST YOU TO INSURE THE INTEGRITY OF YOUR PLAN.

CONSTRUCTION DOCUMENTS

CONSTRUCTION PLANS "BLUE PRINTS" DEPENDING UPON SIZE, COMPLEXITY, AND OR BUILDING REQUIREMENTS VARY IN SIZE AND INFORMATION. TYPICAL PLANS INCLUDE THE FOLLOWING:

- -ELEVATIONS (FRONT, REAR, LEFT, RIGHT)
 -FOUNDATION PLAN W/ DETAILS
- -FLOOR PLANS
- -FLOOR PLANS -ROOF PLAN
- -TYPICAL CONSTRUCTION DETAILS

SOME BUILDING DEPARTMENTS MAY REQUIRE ADDITIONAL DOCUMENTATION. THESE MAY INCLUDE THE FOLLOWING:
-ELECTRICAL PLAN

- -HYAC PLAN
- -SITE PLAN (SOME REQUIRE SURVEYORS SEAL)
- -STORM WATER PLAN (REQUIRES ENGINEERS SEAL)

IF SUCH PLANS ARE REQUIRED OUR OFFICE CAN PROVIDE THEM AT AN ADDITIONAL FEE.

CODE SUMMARY

NAME OF PROJECT: II BEAUCHAINE'S
ADDRESS: 211 S.TOPSAIL DR.
SURF CITY, NC. 28445
PROPOSED USE: RESTAURANT
OWNER INFORMATION:
OWNER NAME: DARREL & PATRICE BEAUCHAINE
PHONE: 910.328.1293
CODE ENFORCEMENT JURISDICTION: SURF CITY
LEAD DESIGN PROFESSIONAL: MICHAEL C. GALLANT, PE
(FOUNDATION, HVAC & WIND LOADS)
LICENSE #: 25574
PHONE: 910.328.4857

BUILDING DATA
AREA: OCCUP

AREA: OCCUPANCY: ASSEMBLY A-2
MIXED OCCUPANCY: NO
CONSTRUCTION TYPE: V B
MIXED CONSTRUCTION: NO
FIRE DISTRICT: NO
BUILDING HEIGHT: 20'-4"
NUMBER OF STORIES: 2
MEZZANINE: NO
HIGH RISE: NO
TOTAL GROSS BUILDING 3740 SQ FT

FIRE RESISTANCE RATINGS
ALL WALLS CEILING AND ROOF ASSEMBLIES REQUIRED 0 HOUR.

LIFE SAFETY SYSTEM

EMERGENCY LIGHTING AND SIGNS: YES

SMOKE DETECTION SYSTEM: YES

PANIC HARDWARE: YES

EXIT REQUIREMENTS

DEAD END MAXIMUM CONDITION: 30 FEET

TRAVEL DISTANCE TO EXIT: 54FT.—MAXIMUM ALLOWED CONDITION: 200 FEET

TOTAL SQUARE FOOTAGE: 3740 SQ FT

NET SQ FT/OCCUPANCY: 15

TOTAL NUMBER OF PEOPLE ON FLOOR: 150

NUMBER OF DOORS PROVIDED: 4

NUMBER OF DOORS REQUIRED: 2

ROOF LIVE LOAD: BY OTHERS
WIND: BY OTHERS
IMPORTANCE FACTOR: BY OTHERS
ASCE-7/EXPOSURE: BY OTHERS
FLOOR: BY OTHERS
SNOW: BY OTHERS
SEISMIC ZONE: BY OTHERS
AV: BY OTHERS
SEISMIC IMPORTANCE FACTOR: BY OTHERS
LATERAL DESIGN CONTROL: BY OTHERS
METHOD OF RESISTANCE: BY OTHERS
SOIL BEARING CAPACITIES:
PRESUMPTIVE— BY OTHERS

ENERGY REQUIREMENTS
THERMAL ENVELOPE
METHOD OF COMPLIANCE: PRESCRIPTIVE
ROOF/CEILING ASSEMBLY: R30/U.075
EXTERIOR WALLS: R19/U.160
DOORS AND WINDOWS: R2.70/U.81
FLOORS SLAB ON GRADE: R20/U.112

MECHANICAL REQUIREMENTS

METHOD OF COMPLIANCE; PRESCRIPTIVE

NUMBER AND SIZE UNITS; 2 UNITS @ 5 TONS.

MINIMUM COOLING EFFICIENCY; 10 SEER

UNITS: HP UNITS: TRANE 2TWR1060A1001 (2)

AH UNITS: TRANE TWE048C14FC (1)


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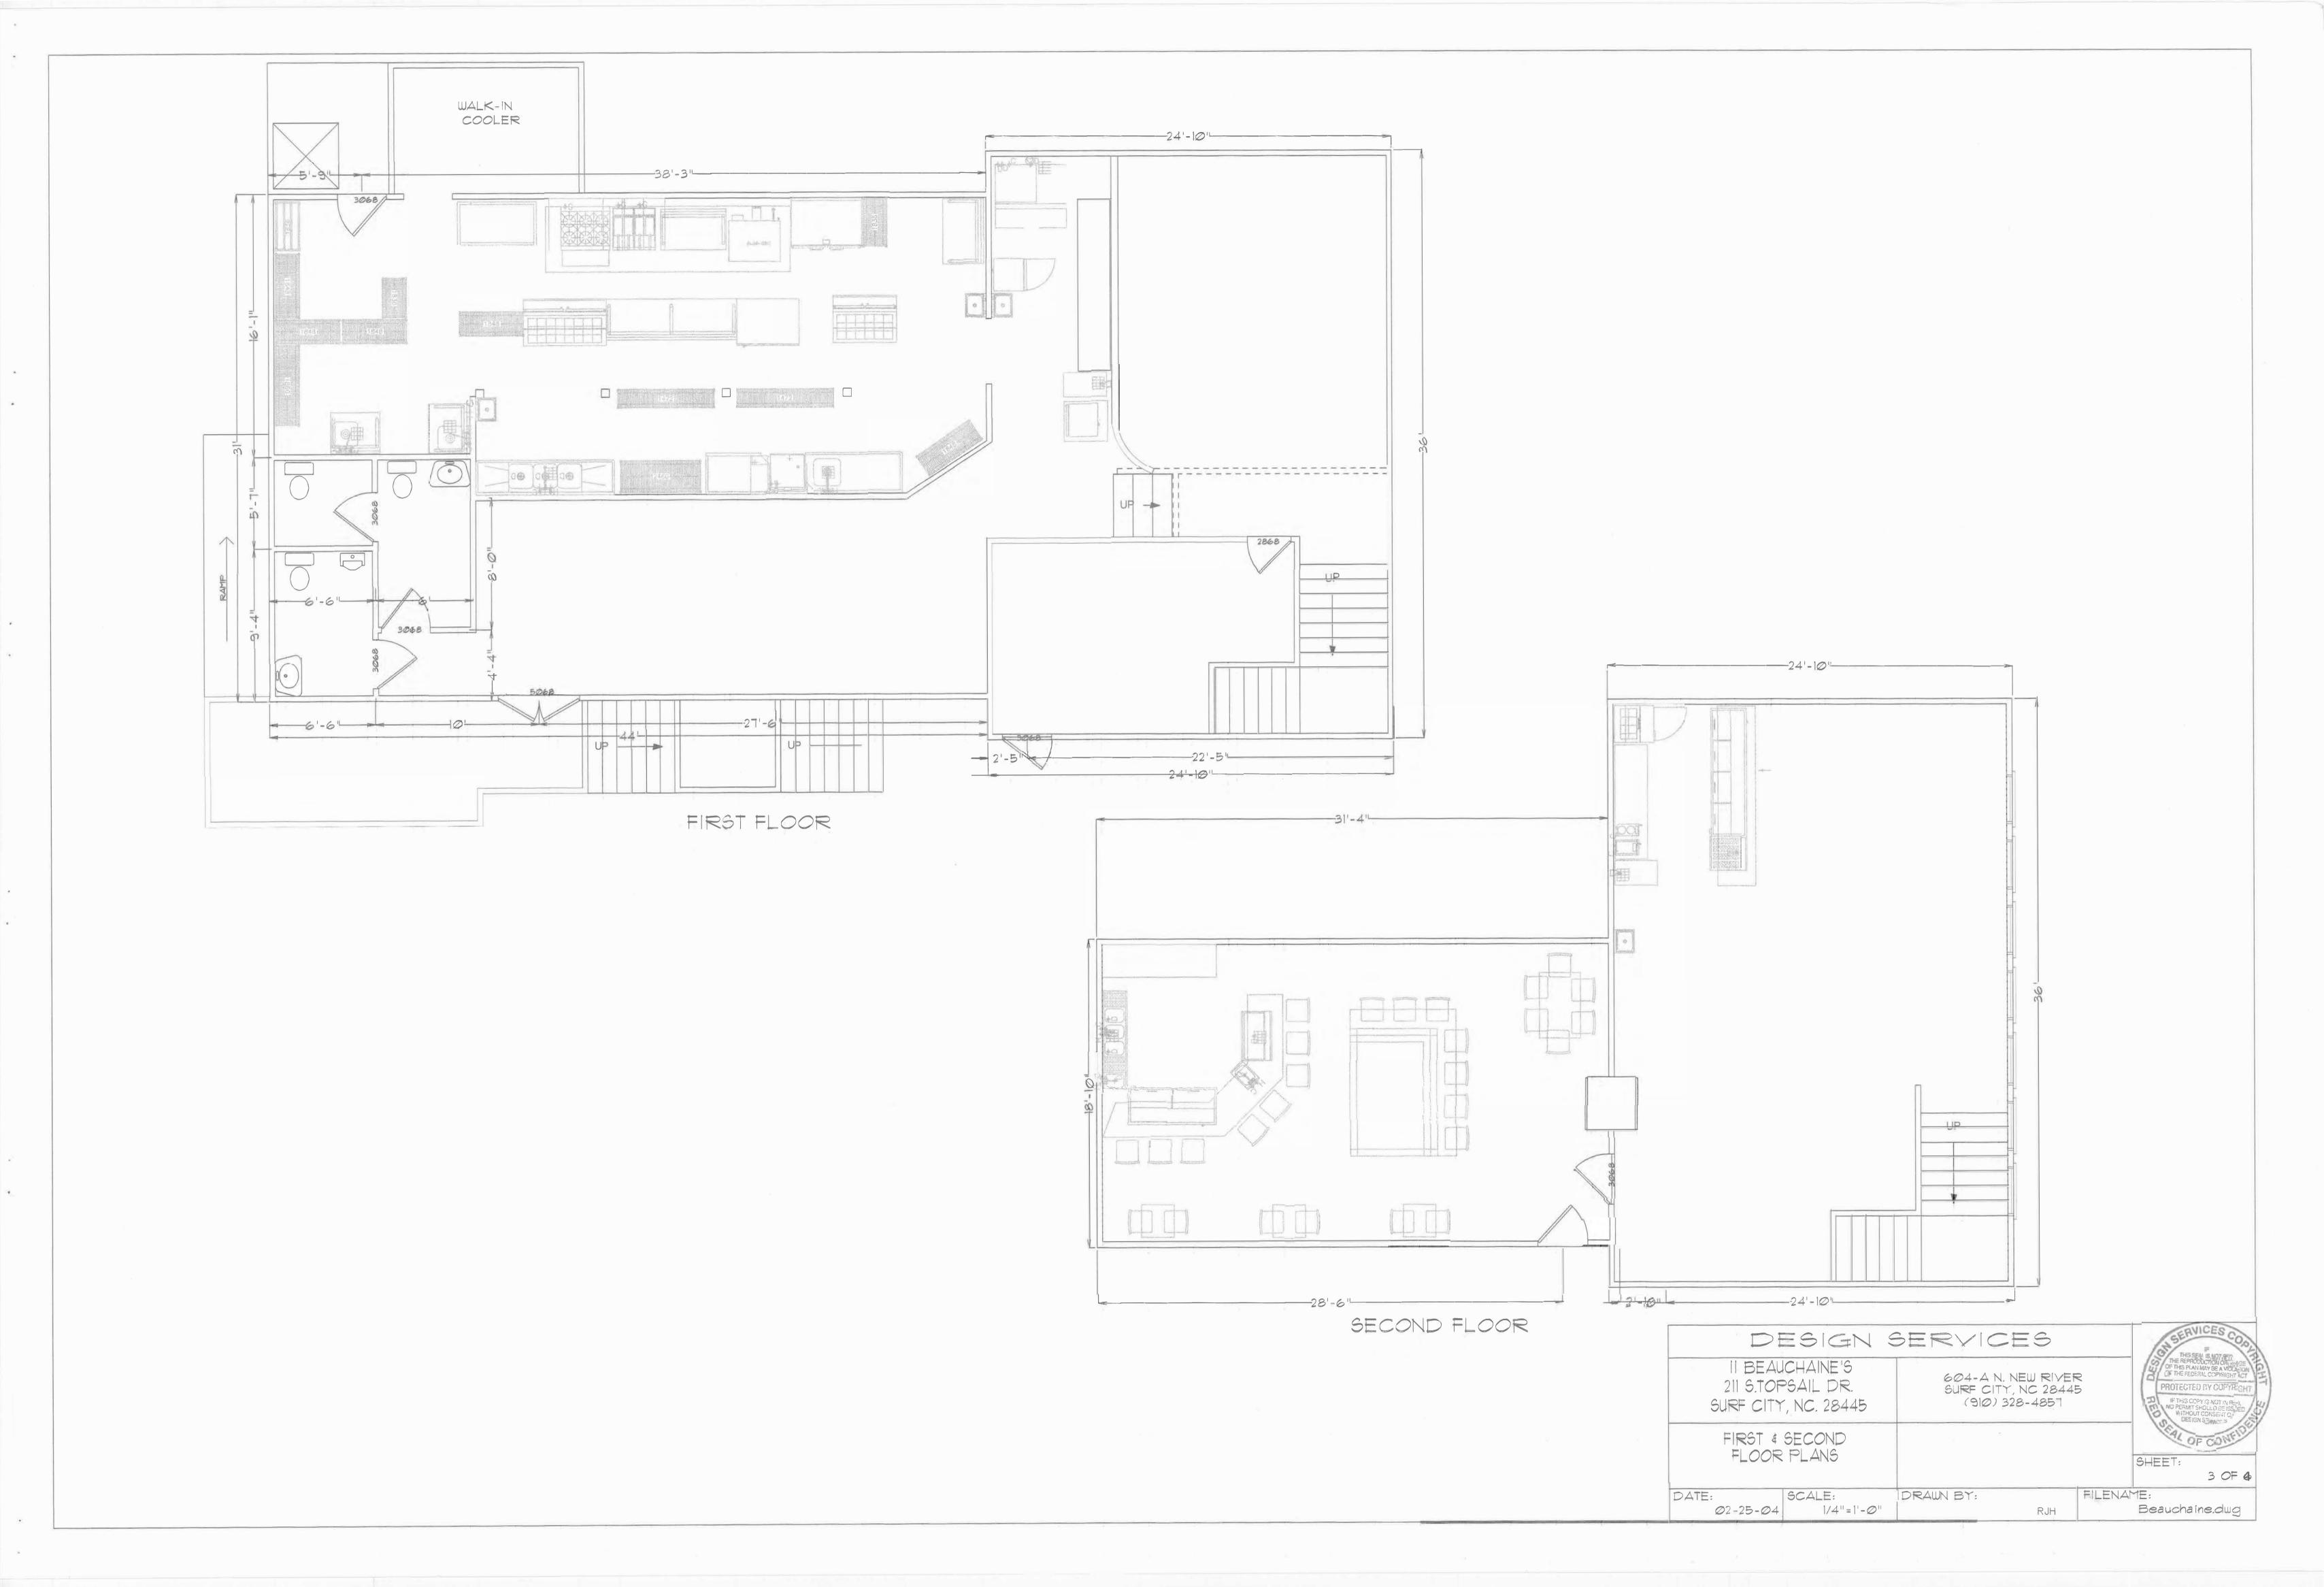
DESIGNER STATEMENT


TO THE BEST OF MY KNOWLEDGE AND BELIEF, THE DESIGN OF THIS BUILDING COMPLIES WITH THE THERMAL ENVELOPE AND MECHANICAL REQUIREMENTS OF THE NORTH CAROLINA STATE BUILDING CODE VOLUME X-ENERGY.

MICHAEL C. GALLANT, PE

MICHAEL C. GAL	LANT P.E., P.A.
II BEAUCHAINE'S 211 S.TOPSAIL DR. SURF CITY, NC. 28445	604—A NORTH NEW RIVER DR. SURF CITY, NC. 28445 PHONE: 910.328—4857 FAX: 910.328—4733 E-MAIL: GALLANTMC@AOL.COM
CODE SUMMARY	DRAFTING SERVICES BY: DESIGN SERVICES 604-A NORTH NEW RIVER DR. SURF CITY, NC. 28445 PHONE: 910.328-4857 1 OF 4
DATE: SCALE:	DRAWN BY: FILENAME:
2/25/04 $1/4" = 1'-0"$	RJH Beauchaine.dwg



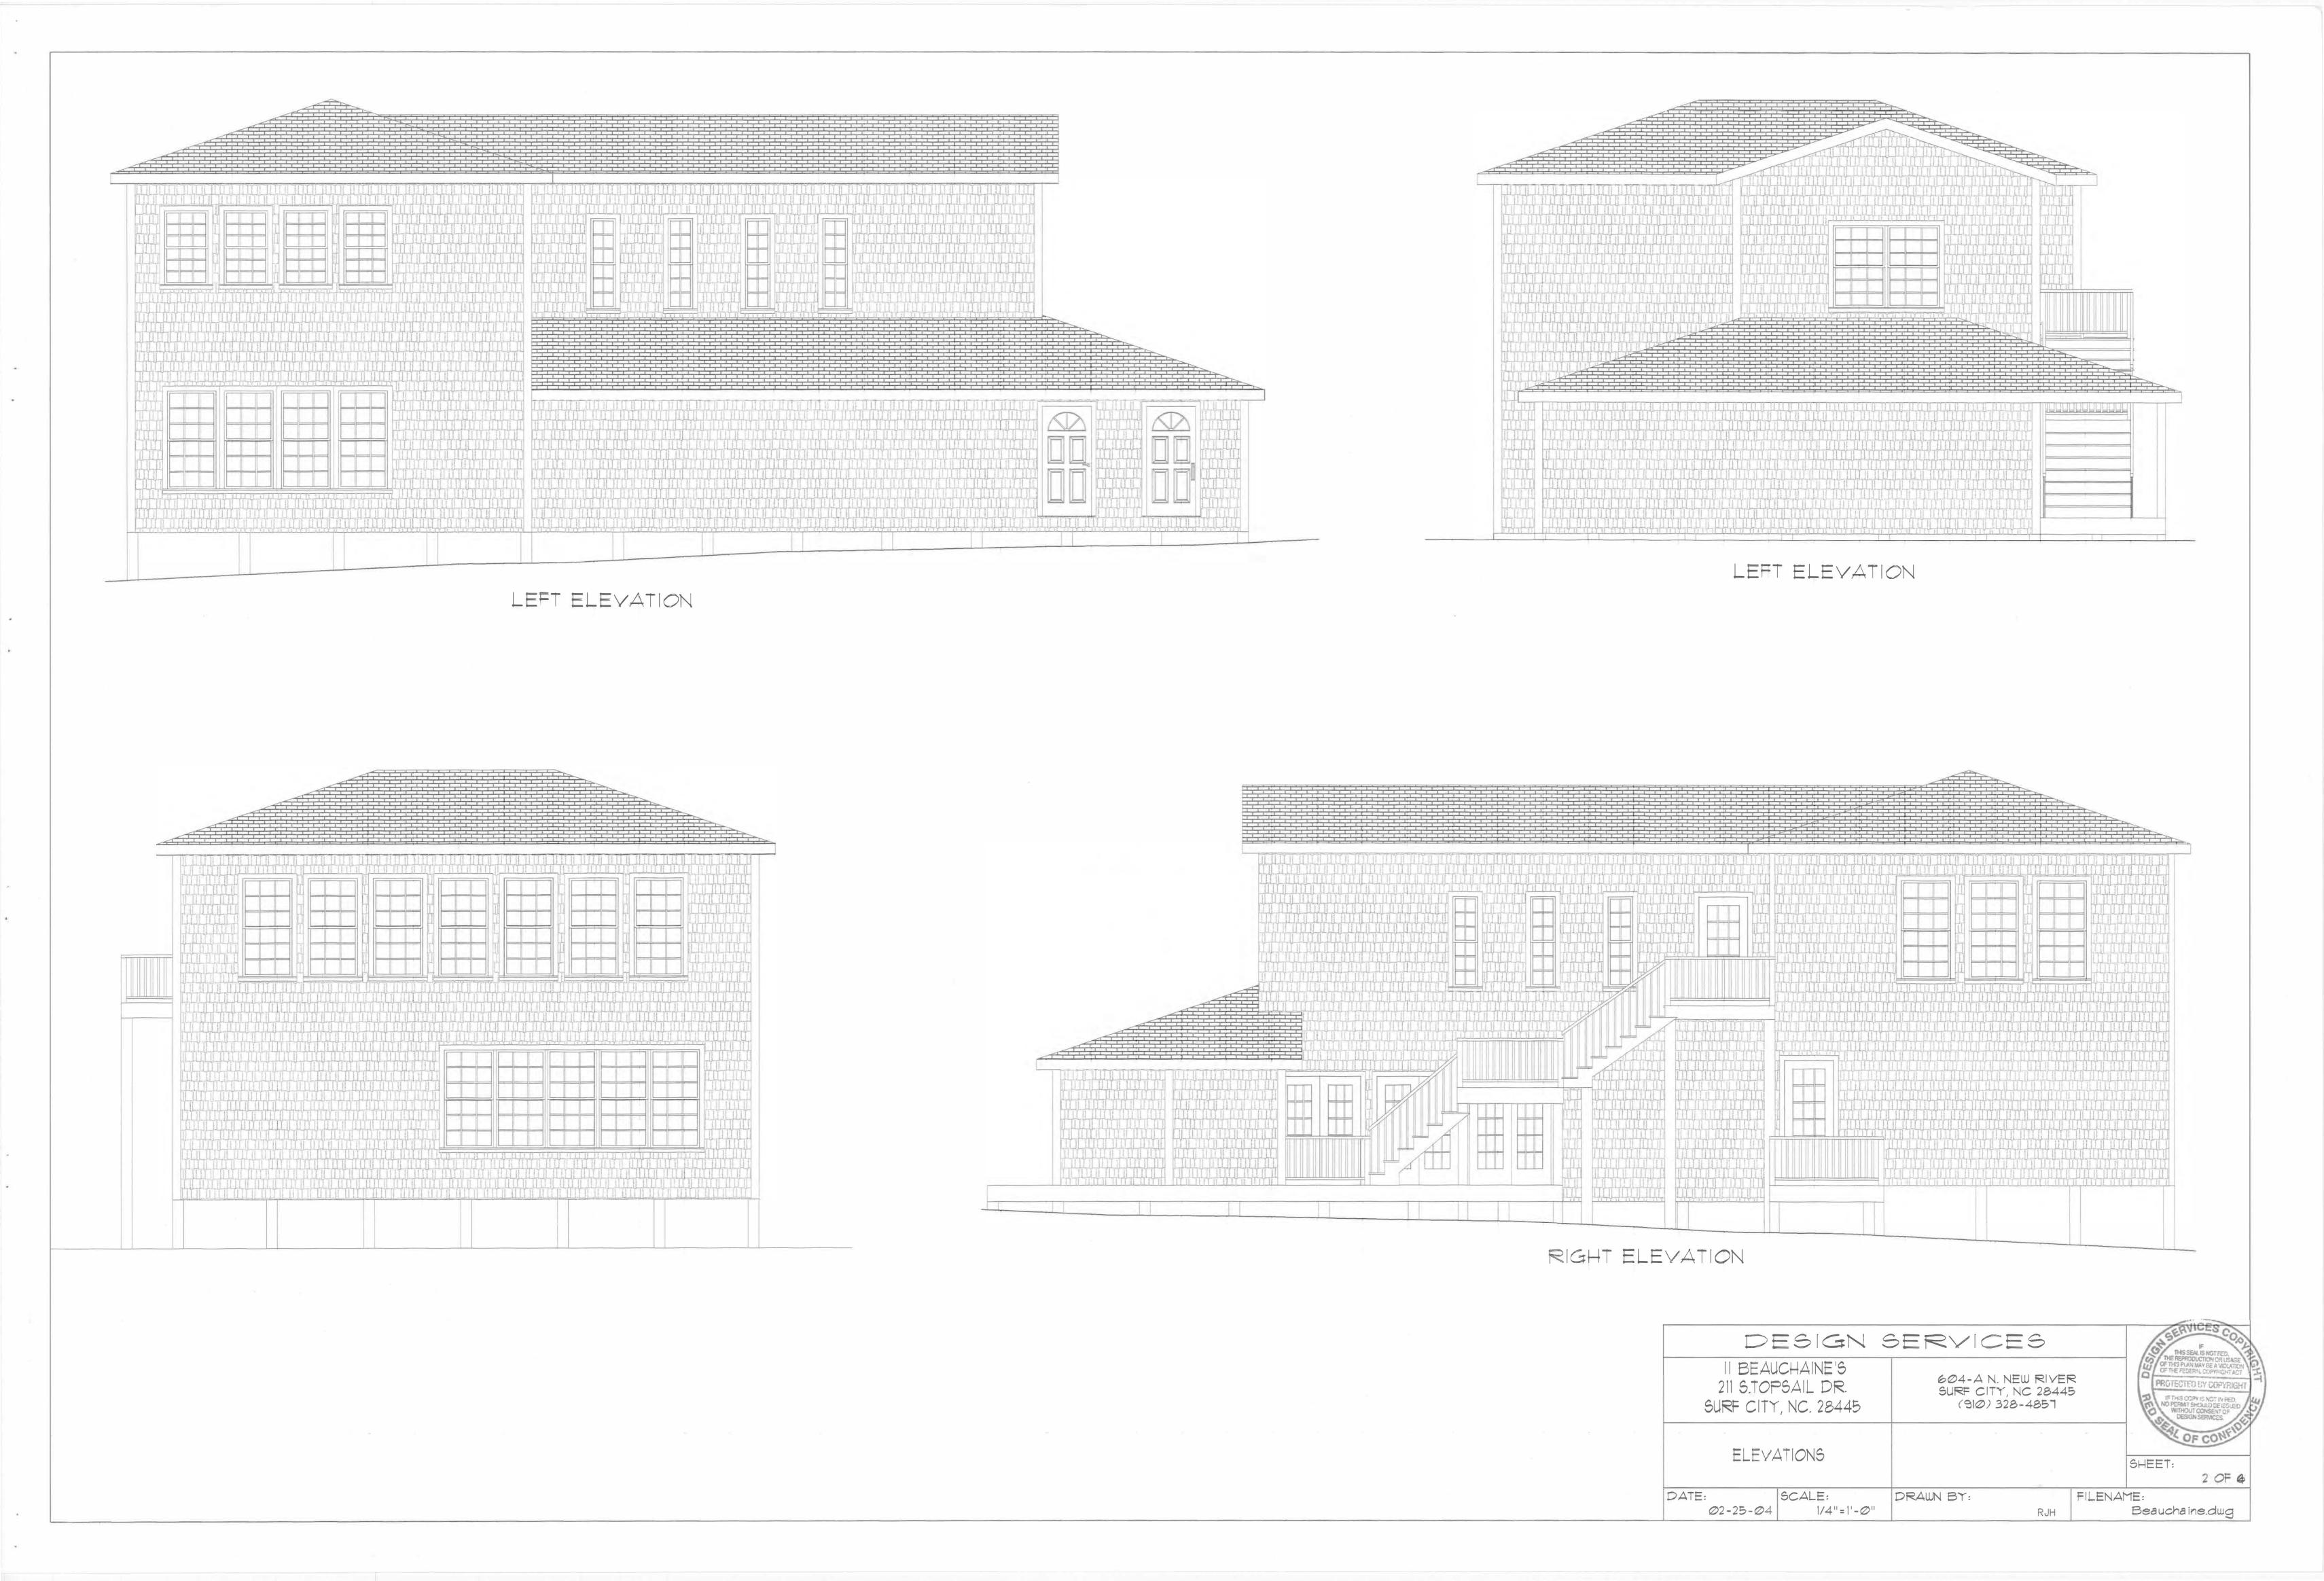

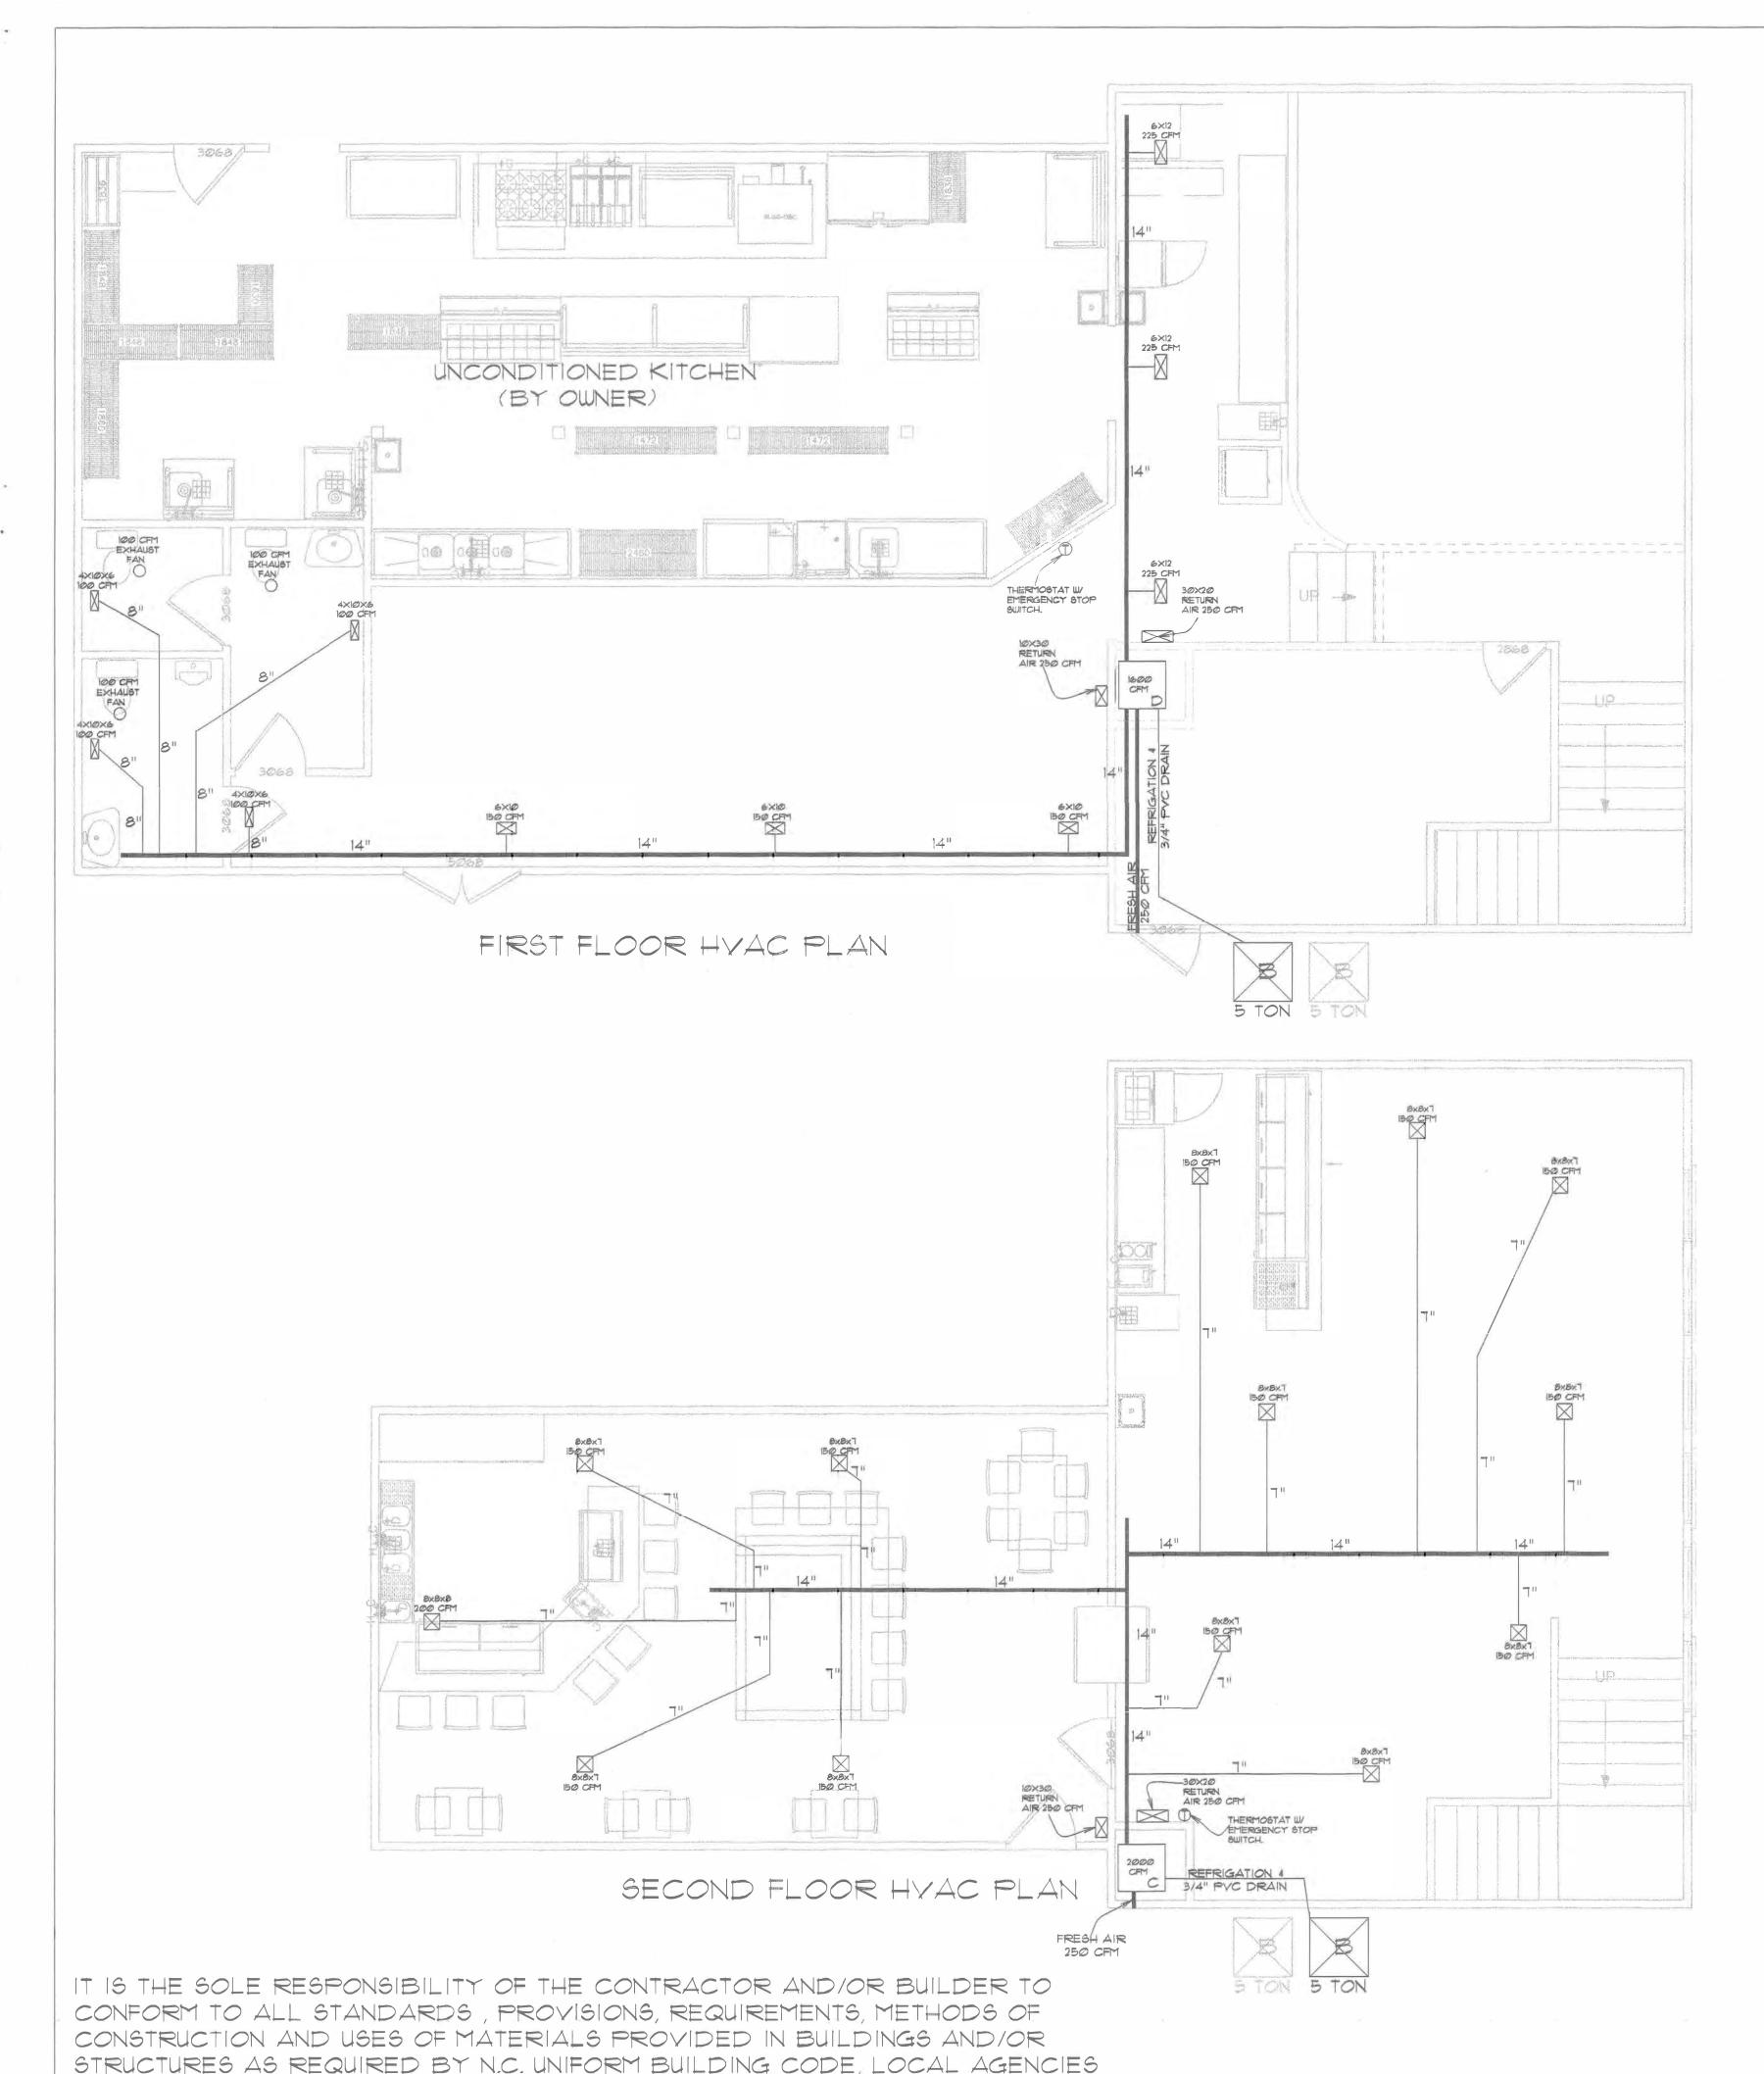

AND IN ACCORDANCE WITH GOOD ENGINEERING PRACTICES. VERIFY ALL

DIMENSIONS PRIOR TO CONSTRUCTION.

EQUIPMENT SCHEDULE

Traine S	5 TON HP	2TWR1060A1000A
C	5 TON AH	TWE048 1600CFM
D	5 TON AH	TWE060 2000CFM
	7.68 KW HEATER	BAYHTRI408
	5.76 KW HEATER	BAYHTRI408
	1 DAY THERMOSTAT	500C T DAY PROGRAMABLE

NOTE: ALL EQUIPMENT USED IS MADE BY TRANE.

HVAC MATERIALS AND INSTALLATION

1. THE WORK UNDER THIS DIVISION INCLUDES THE INSTALLATION OF COMPLETE MECHANICAL SYSTEMS CONSISTING OF BUT NOT LIMITED TO HEATING AND AIR CONDITIONING.

2. FURNISH AND INSTALL COMPLETE YEAR ROUND HEATING AND AIR CONDITIONING SYSTEMS AS SHOWN ON THE DRAWINGS. FINISHED IN ALL RESPECTS READY FOR USE.

3. THE WORK SHALL BE IN ACCORDANCE WITH THESE DRAWINGS AND THE BEST COMMERCIAL PRACTICES FOR THE WORK INVOLVED. ALL EQUIPMENT, PARTS, PIPE AND OTHER MATERIALS INCORPORATED INTO THIS INSTALLATION SHALL BE NEW, FREE OF DEFECTS AND SHALL BE DESIGNED FOR THE INTENDED SERVICE. ALL WORK SHALL BE IN ACCORDANCE WITH ALL APPLICABLE CODES AND

4. THE CONTRACTOR SHALL ARRANGE FOR INSPECTIONS, OBTAIN PERMITS AND FILE DRAWINGS AS REQUIRED AT NO ADDITIONAL COST TO THE OWNER, COMPLY WITH LOCAL INSPECTION

5. ROUND DUCTS SHALL BE CODE GAUGE GALVANIZED STEEL.


6. ALL DUCTWORK MATERIALS, INCLUDING CEMENTS AND VAPOR BARRIER SHALL CONFORM TO THE REQUIREMENTS OF UL 181 STANDARDS FOR CLASS I AIR DUCT MATERIAL, NFPA 90A AND SMACNA FGDCS.


T. ALL CUTTING AND PATCHING REQUIRED TO INSTALL THE WORK UNDER THIS DIVISION SHALL BE DONE BY PEOPLE SKILLED IN THE TRADE INVOLVED.

8. ALL SYSTEMS SHALL BE PROPERLY ADJUSTED AND BALANCED.

9. PROVIDE FILTER FRAMES ON ALL AIR HANDLERS UNITS AND PROVIDE CLEAN FILTERS AT THE COMPLETION OF THE JOB.

10. THE WORK UNDER THIS DIVISION SHALL BE WARRANTED FOR A PERIOD OF ONE YEAR FROM THE DATE OF FINAL ACCEPTANCE OR FIRST BENEFICIAL USE BY THE OWNER WHICHEVER COMES FIRST COMPRESSOR SHALL HAVE 5-YEAR WARRANTIES.

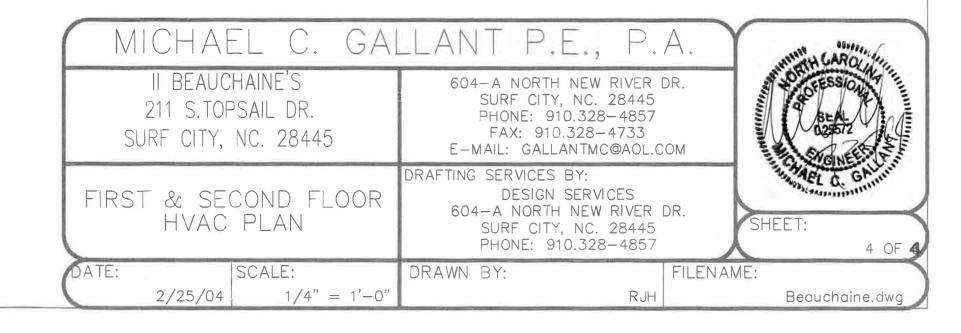

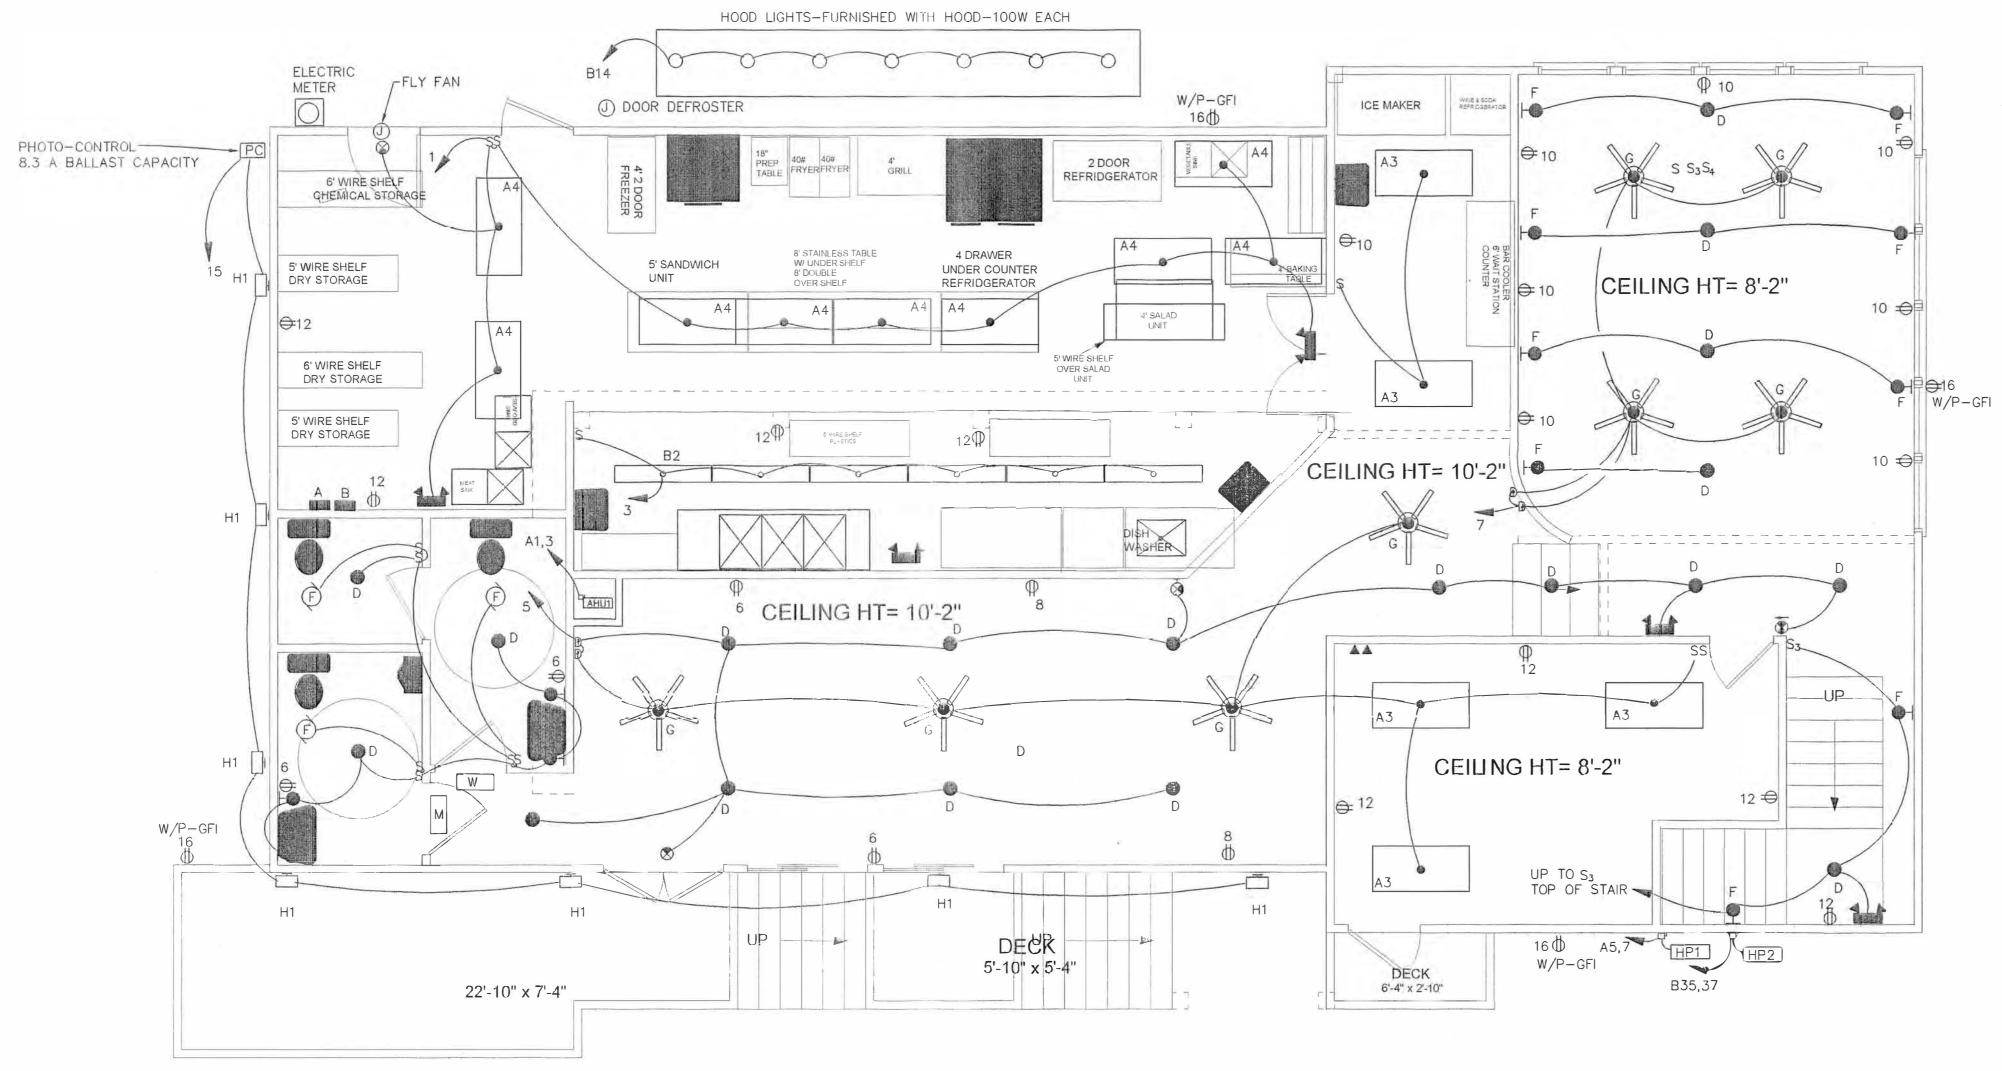

NOTES

1. ALL EXIT AND EMERGENCY FIXTURES SHALL BE CONNECTED TO SAME CIRCUIT AS GENERAL LIGHTING BUT AHEAD OF ALL SWITCHING


FIRST FLOOR 1/4"=1'0"


F. PATRICK O'CONNOR, PE CONSULTING ENGINEER 8137 BLUE HERON DRIVE EAST, APT 302 WILMINGTON, NC 28411

TEL (910) 686-4265 FAX (910) 686-4265

MICHAEL C. GAI	LANT P.E., P.	A. 3-1-04
II BEAUCHAINE'S 211 S.TOPSAIL DR. SURF CITY, NC. 28445	604-A NORTH NEW RIVER I SURF CITY, NC. 28445 PHONE: 910.328-4857 FAX: 910.328-4733 E-MAIL: GALLANTMC@AOL.C	State Ball
FIRST FLOOR ELECTRICAL PLAN	DRAFTING SERVICES BY: DESIGN SERVICES 604-A NORTH NEW RIVER I SURF CITY, NC. 28445 PHONE: 910.328-4857	SHEET: E-1 1 OF 3
DATE: SCALE:	DRAWN BY:	FILENAME:
2/27/04 $1/4" = 1'-0"$	FPO	Beauchaine.dwg

5 8 9 1 9

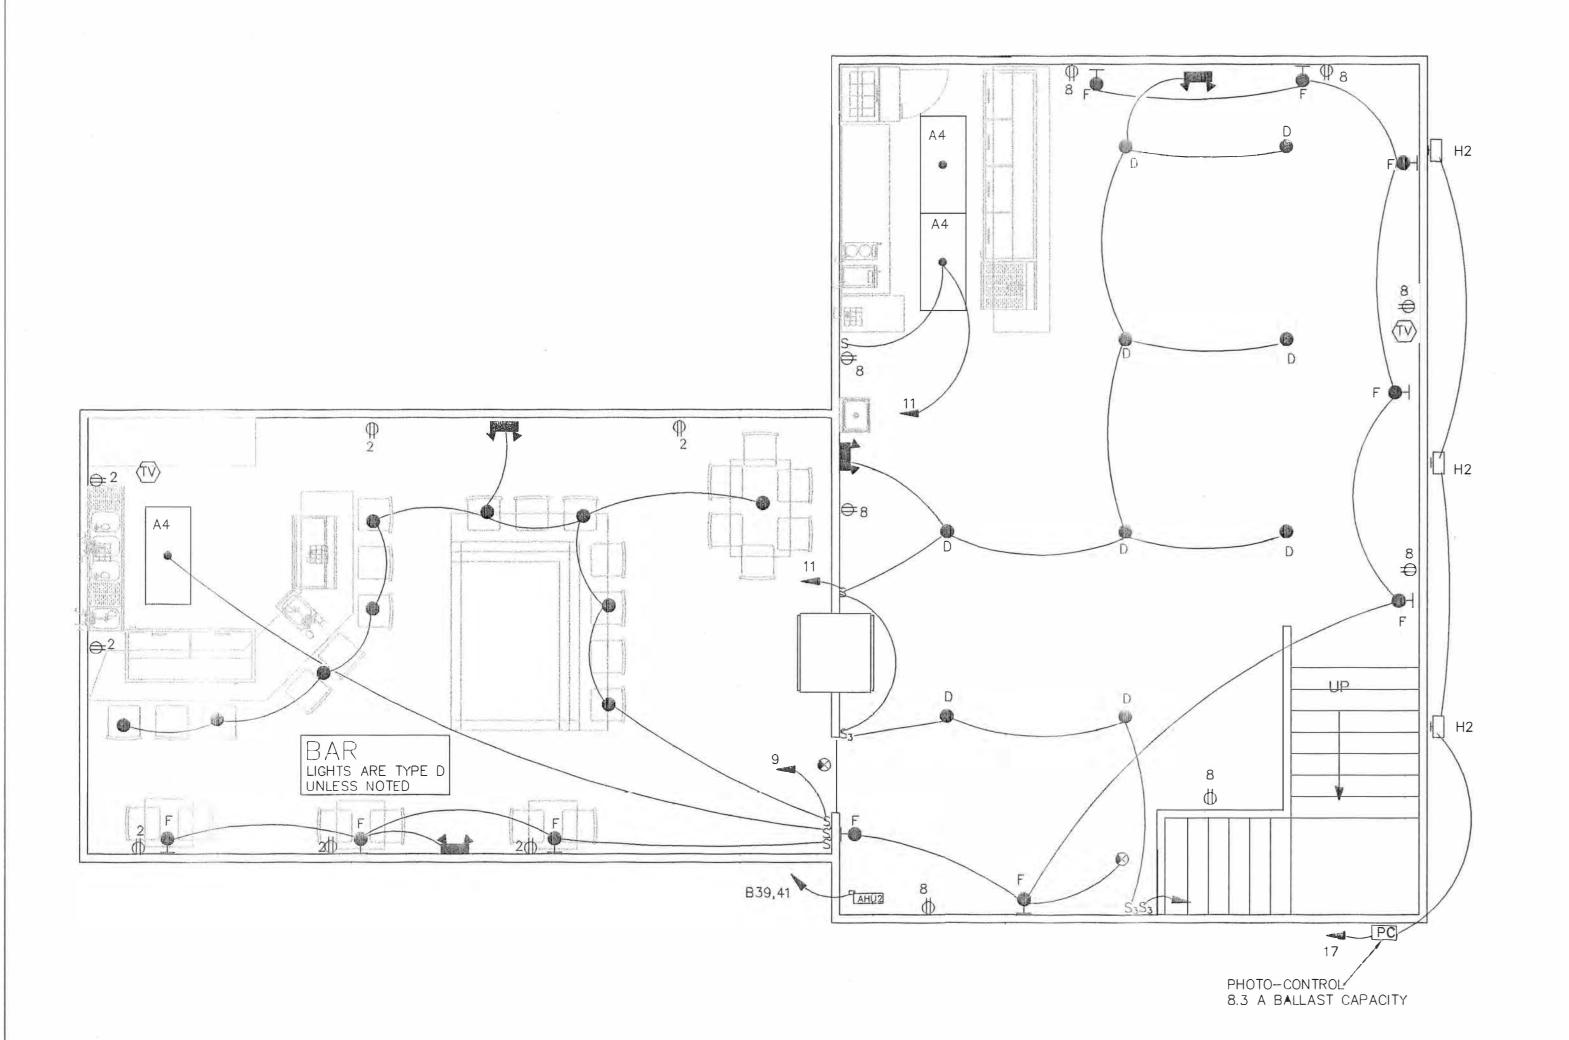

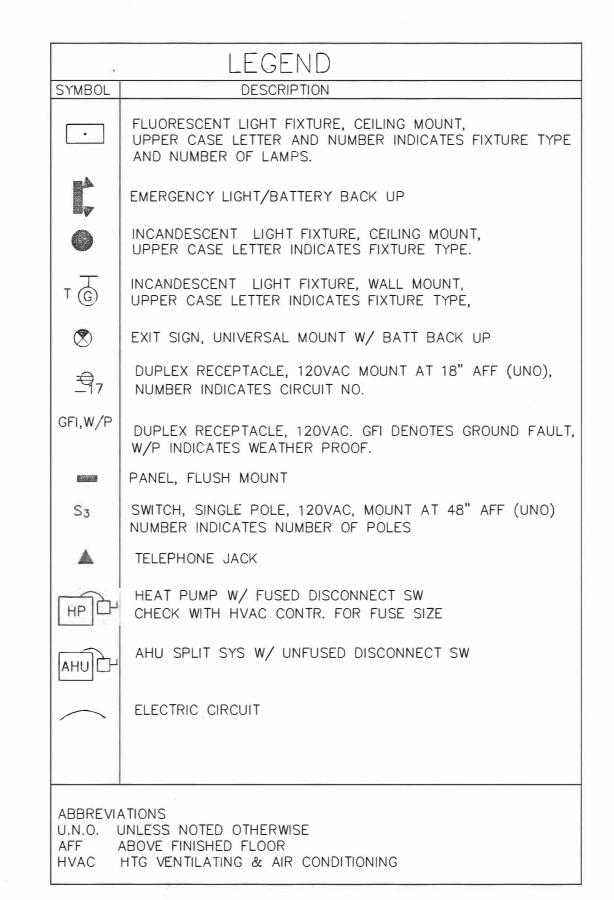

SPECIFICATION

CODES:

ALL WORK SHALL COMPLY WITH THE CURRENT EDITION OF THE NEC; THE NC BLDG CODE; AND THE LOCAL ELECTRICAL DEPT.

WIRING

EXTERIOR EXPOSED - PVC SCHED 40 WITH THHN/THWN WIRE

INTERIOR EXPOSED - EMT WITH THHN/THWN WIRE

INTERIOR CONCEALED-EMT WITH THHN/THWN WIRE OR MC CABLE/INSULATED GR.

PLACES OF ASSEMBLY AND PATIENT CARE AREAS

INTERIOR - CONCEALED AREAS NOT REQUIRING ABOVE- NM-B/G CABLE

UNDERGROUND - PVC SCHED 40 WITH THHN/THWN WIRE

DEVICES:

RECEPTACLES: STANDARD GRADE 15A. 120V.

OUTDOOR— W/P COVER GROUND FAULT 15A, 120V.

SINKS — GROUND FAULT 15A, 120V.

SPECIAL AS NOTED

SWITCHES: 15A. 120V.

ROXES.

METAL RACEWAYS OR METAL JACKETED CABLE: METAL BOXES OR NONMETALLIC BOXES WITH INTREGAL BONDING BETWEEN ALL ENTRIES.

NM CABLE OR PVC CONDUIT: NONMETALLIC BOXES.

PLATES

OUTSIDE AND UNFINISHED AREAS: STEEL, CADMIUM PLATED ALL OTHER: PLASTIC.

PANELBOARDS

COPPER OR ALUM BUS. SEPARATE NEUTRAL AND GROUND BUS. MOLDED CASE CIRCUIT BREAKERS. SEE RISER DIAG AND PANEL SCHEDULES. ALL HVAC C/B SHALL BE HACR RATED

ONDUIT

IN ALL NONMETALLIC CONDUIT INSTALL A SEPARATE INSULATED GREEN GROUND WIRE, SIZED IN ACCORDANCE WITH TABLE 250-95 OF THE NEC

F

WIRE PULLED IN CONDUIT SHALL BE THWN/THHN COPPER. 10 AWG
AND SMALLER SHALL BE SOLID AND 8 AWG AND LARGER SHALL BE

NM CABLE SHALL HAVE A BARE GROUND CONDUCTOR AS AN INTREGAL PART OF CABLE ASSEMBLY

GROUNDING

AT SERVICE, GROUND THE SYSTEM WITH A CONTINUOUS GROUND CONDUCTOR, THIS CONDUCTOR SHALL BOND THE GROUND ROD AND THE BLDG STEEL AND WATER SERVICE (IF REQUIRED), SEE THE RISER FOR ADDITIONAL INFORMATION.


COMBINATION TELEPHONE AND DATA OUTLET
INSTALL 3/4" PVC FROM OUTLET BOX TO ABOVE CEILING AND
TERMINATE.. LEAVE PULL CORD IN CONDUIT. SEE RISER

HVAC

ELECTRICAL CONTRACTOR SHALL VERIFY WITH HVAC CONTRACTOR THE FUSE REQUIREMENTS FOR HVAC DISCONNECTS. PROVIDE DUCT SMOKE DETECTORS WHERE SHOWN, MECH CONTRACTOR WILL INSTALL.

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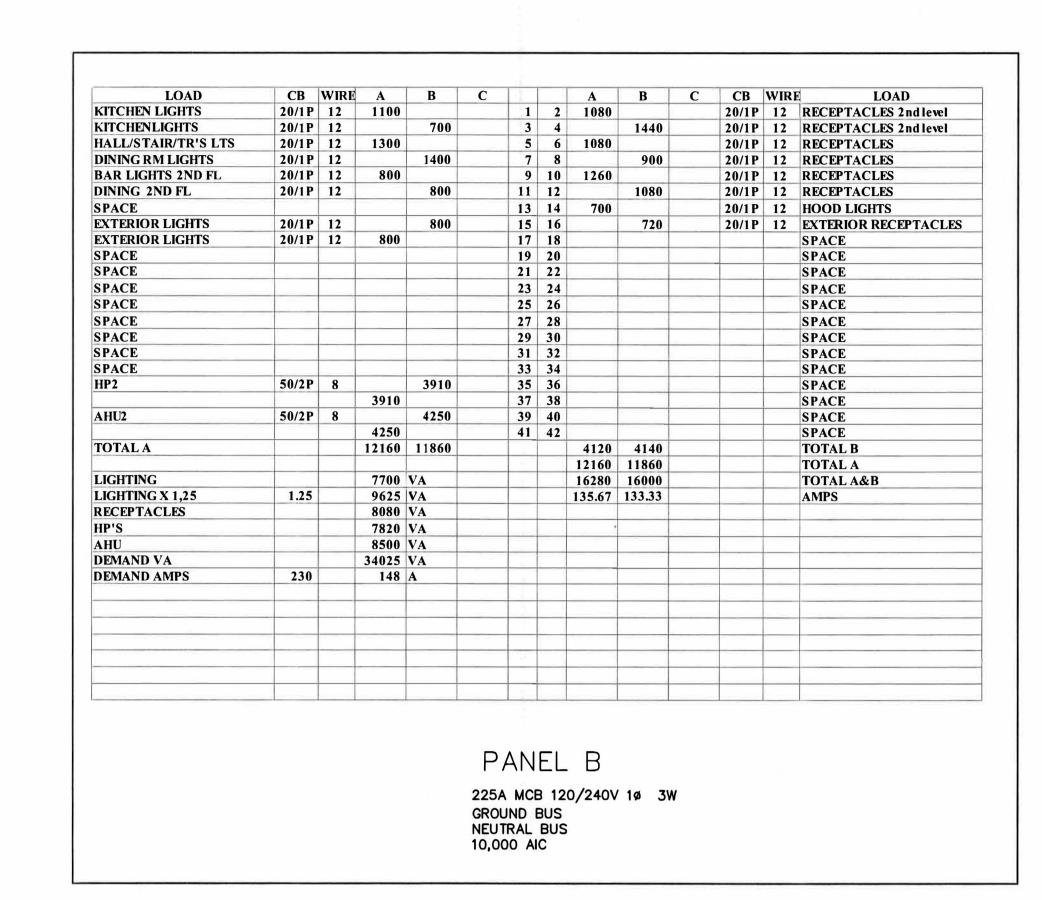



LOAD	CB	WIRE	A	В	C			A	В	C	CB	WIRE	LOAD	ID#
AHU1	50/2P	8	4250			1	2	1560			20/1P	12	2 DR FREEZER	1
				4250		3	4		948		20/1P	12	CONV OVEN	5
HP 1	50/2P	8	3910			5	6	1236			20/1P	12	REFRIGERATOR	6
				3910		7	8		816		20/1P	12	SAND WICH UNIT	7
SPACE						9	10	540			20/1P	12	BEVERAGE REFRIG	8
SPACE						11	12		1056		20/1P	12	SANDWICH UNIT	10
SPACE						13	14	1783			30/2P	10	ICEMACHINE	18
SPACE						15	16		1783				DO	
SPACE						17	18	250			20/1P	12	REFRIG/BEV UNIT	22/2
GAS HEATER	20/1P	12		1000		19	20		1500		20/1P	12	SODA FOUNTAIN	23
SPACE						21	22	1800			20/1P	12	ARTIC REFRIG	24
KIT SUPPLY FAN	15/2P	12		500		23	24		1800		20/1P	12	ICE TEA BREWER	25
			500			25	26	1140			20/1P		COFFEE BREWER	26
KIT EXHAUST FAN	15/2P	12		250		27	28		1140		20/1P	_	BEV COOLER	27
			250			29	30	756			20/1P		BEV COOLER	32
KIT EXHAUST FAN	15/2P	12		250		31	32		1500		20/1P		SODA FOUNTAIN	23
			250			33	34						SPACE	
SPACE						35	36					_	SPACE	
						37	38						SPACE	
SPACE						39	40						SPACE	
SPACE						41	42						SPACE	
TOTAL A			9160	10160	0			9065	10543	0			TOTAL B	
								9160		0			TOTALA	
CONTINUOUS LOAD			18800	VA				18225		0			TOTAL A&B	
NON-CONTINUOUS LOAD			13676					152	173	0			AMPS	
TOTAL LOAD			32476	-	-									
25% OF LARGEST MOTOR			1850	-				18108	VA	TOTAL	KITCH	ENLO	AD (NON-CONTINUOUS)	
TOTAL DEMAND LOAD			34326					0.7		DIVERS			((() () () () () () ()	
CONNECTED AMPS		230	149	1 1				12676	VA	KITCHE		AND		
								1000		GAS HE				
								13676	1			NTIN	UOUS LOAD	
								10070	1	CONTIN				
								7800	VA	HP1				-
								8500		AHU1				
								2000		FANS				
								500		LIGHTIN	VG.			
	1							18800	1	1		OAD	DEMAND	

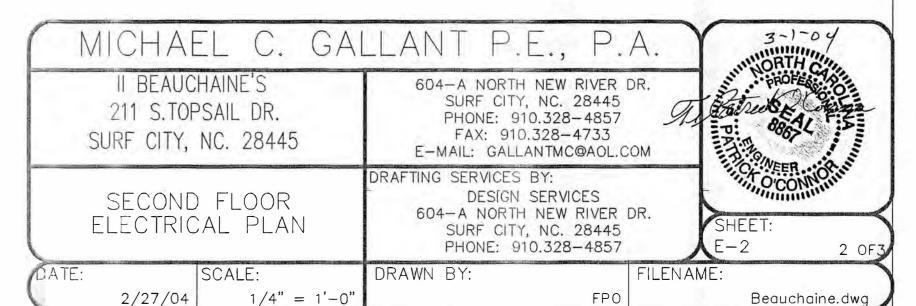PANEL A 225A MCB 120/240V 10


225A MCB 120/240V 10 3W GROUND BUS NEUTRAL BUS 10,000 AIC

.IGH	TING FIXTURE SCHEDULE	E 120V	LAMP	S	
ГҮРЕ	DESCRIPTION	MOUNTING	LAMPS	MFG	CAT NO
A	FLUORESCENT SURFACE 2X4	CEILING	F32	METALUX	WB-?32A-E8
В	FLUORES CENT SURFACE 1X4	CEILING	2 F32	METALUX	WE-232A
C					
D	RECESS ED INCANDES CENT CAN	CEILING	40W	METALLUX	BE-217-120V-EB81
F	INCANDES CENT S CONCE	WALL	40W	BYOWNER	
G	CEING FAN	CEILING	NA	BYOWNER	
H1	EXTERIOR LIGHTS-METAL HALIDE	WALL	100W	LUMARK	WYSERIES
H2	EXTERIOR LIGHTS-METAL HALIDE	WALL	250W	LUMARK	WLSERIES
	EXIT LIGHT-FLUORES CENT	UNIVERSAI	2-5W	SURE-LITE	LPX-70-RWH
	EMERGENCY LIGHT-2 HD-RECHARGEABLE	WALL	INCAN 9W	SURE-LITE	XR-LC-2984



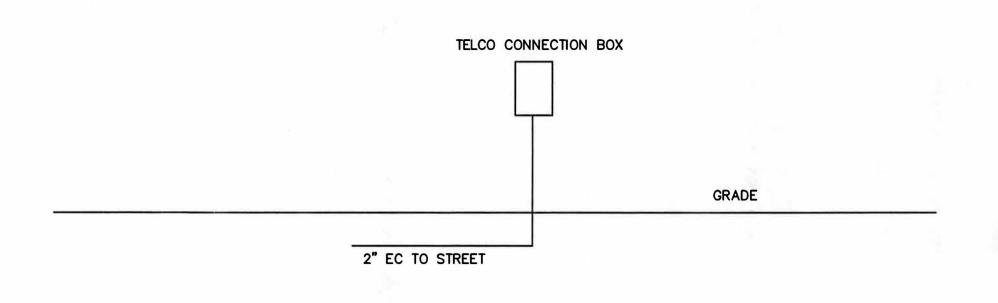



TELEPHONE RISER

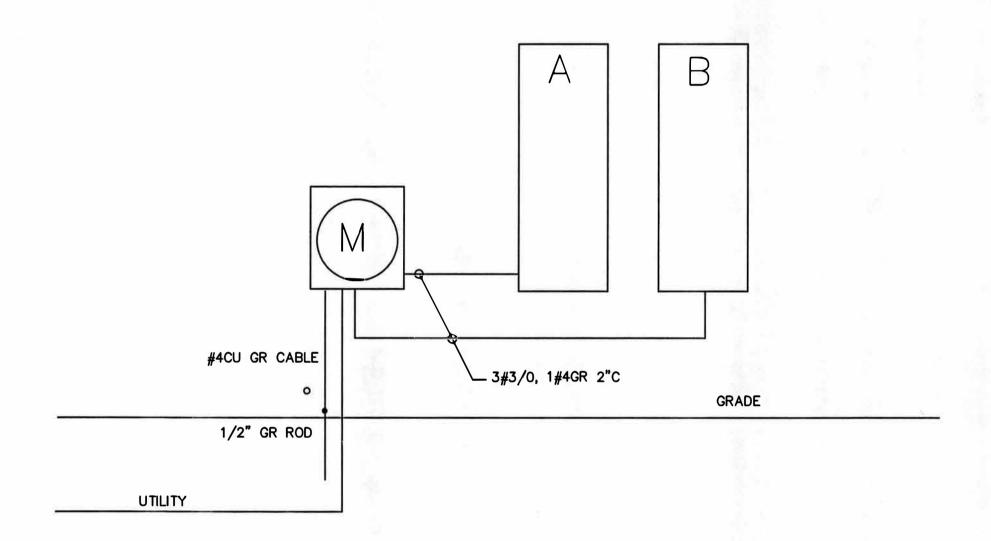

ELECTRIC RISER

F. PATRICK O'CONNOR, PE CONSULTING ENGINEER 8137 BLUE HERON DRIVE EAST, APT 302 WILMINGTON, NC 28411 TEL (910) 686-4265 FAX (910) 686-4265

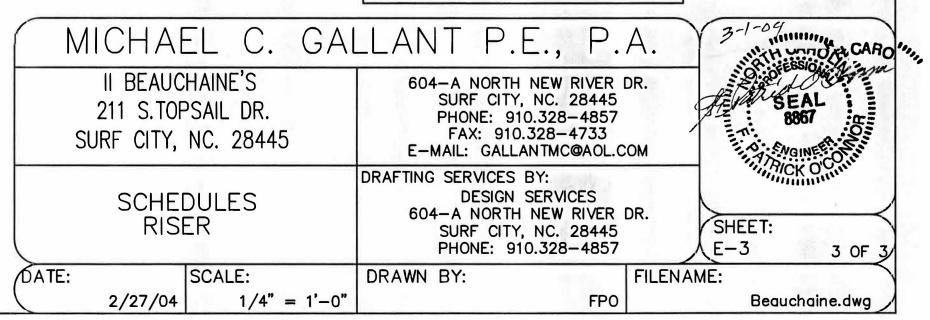

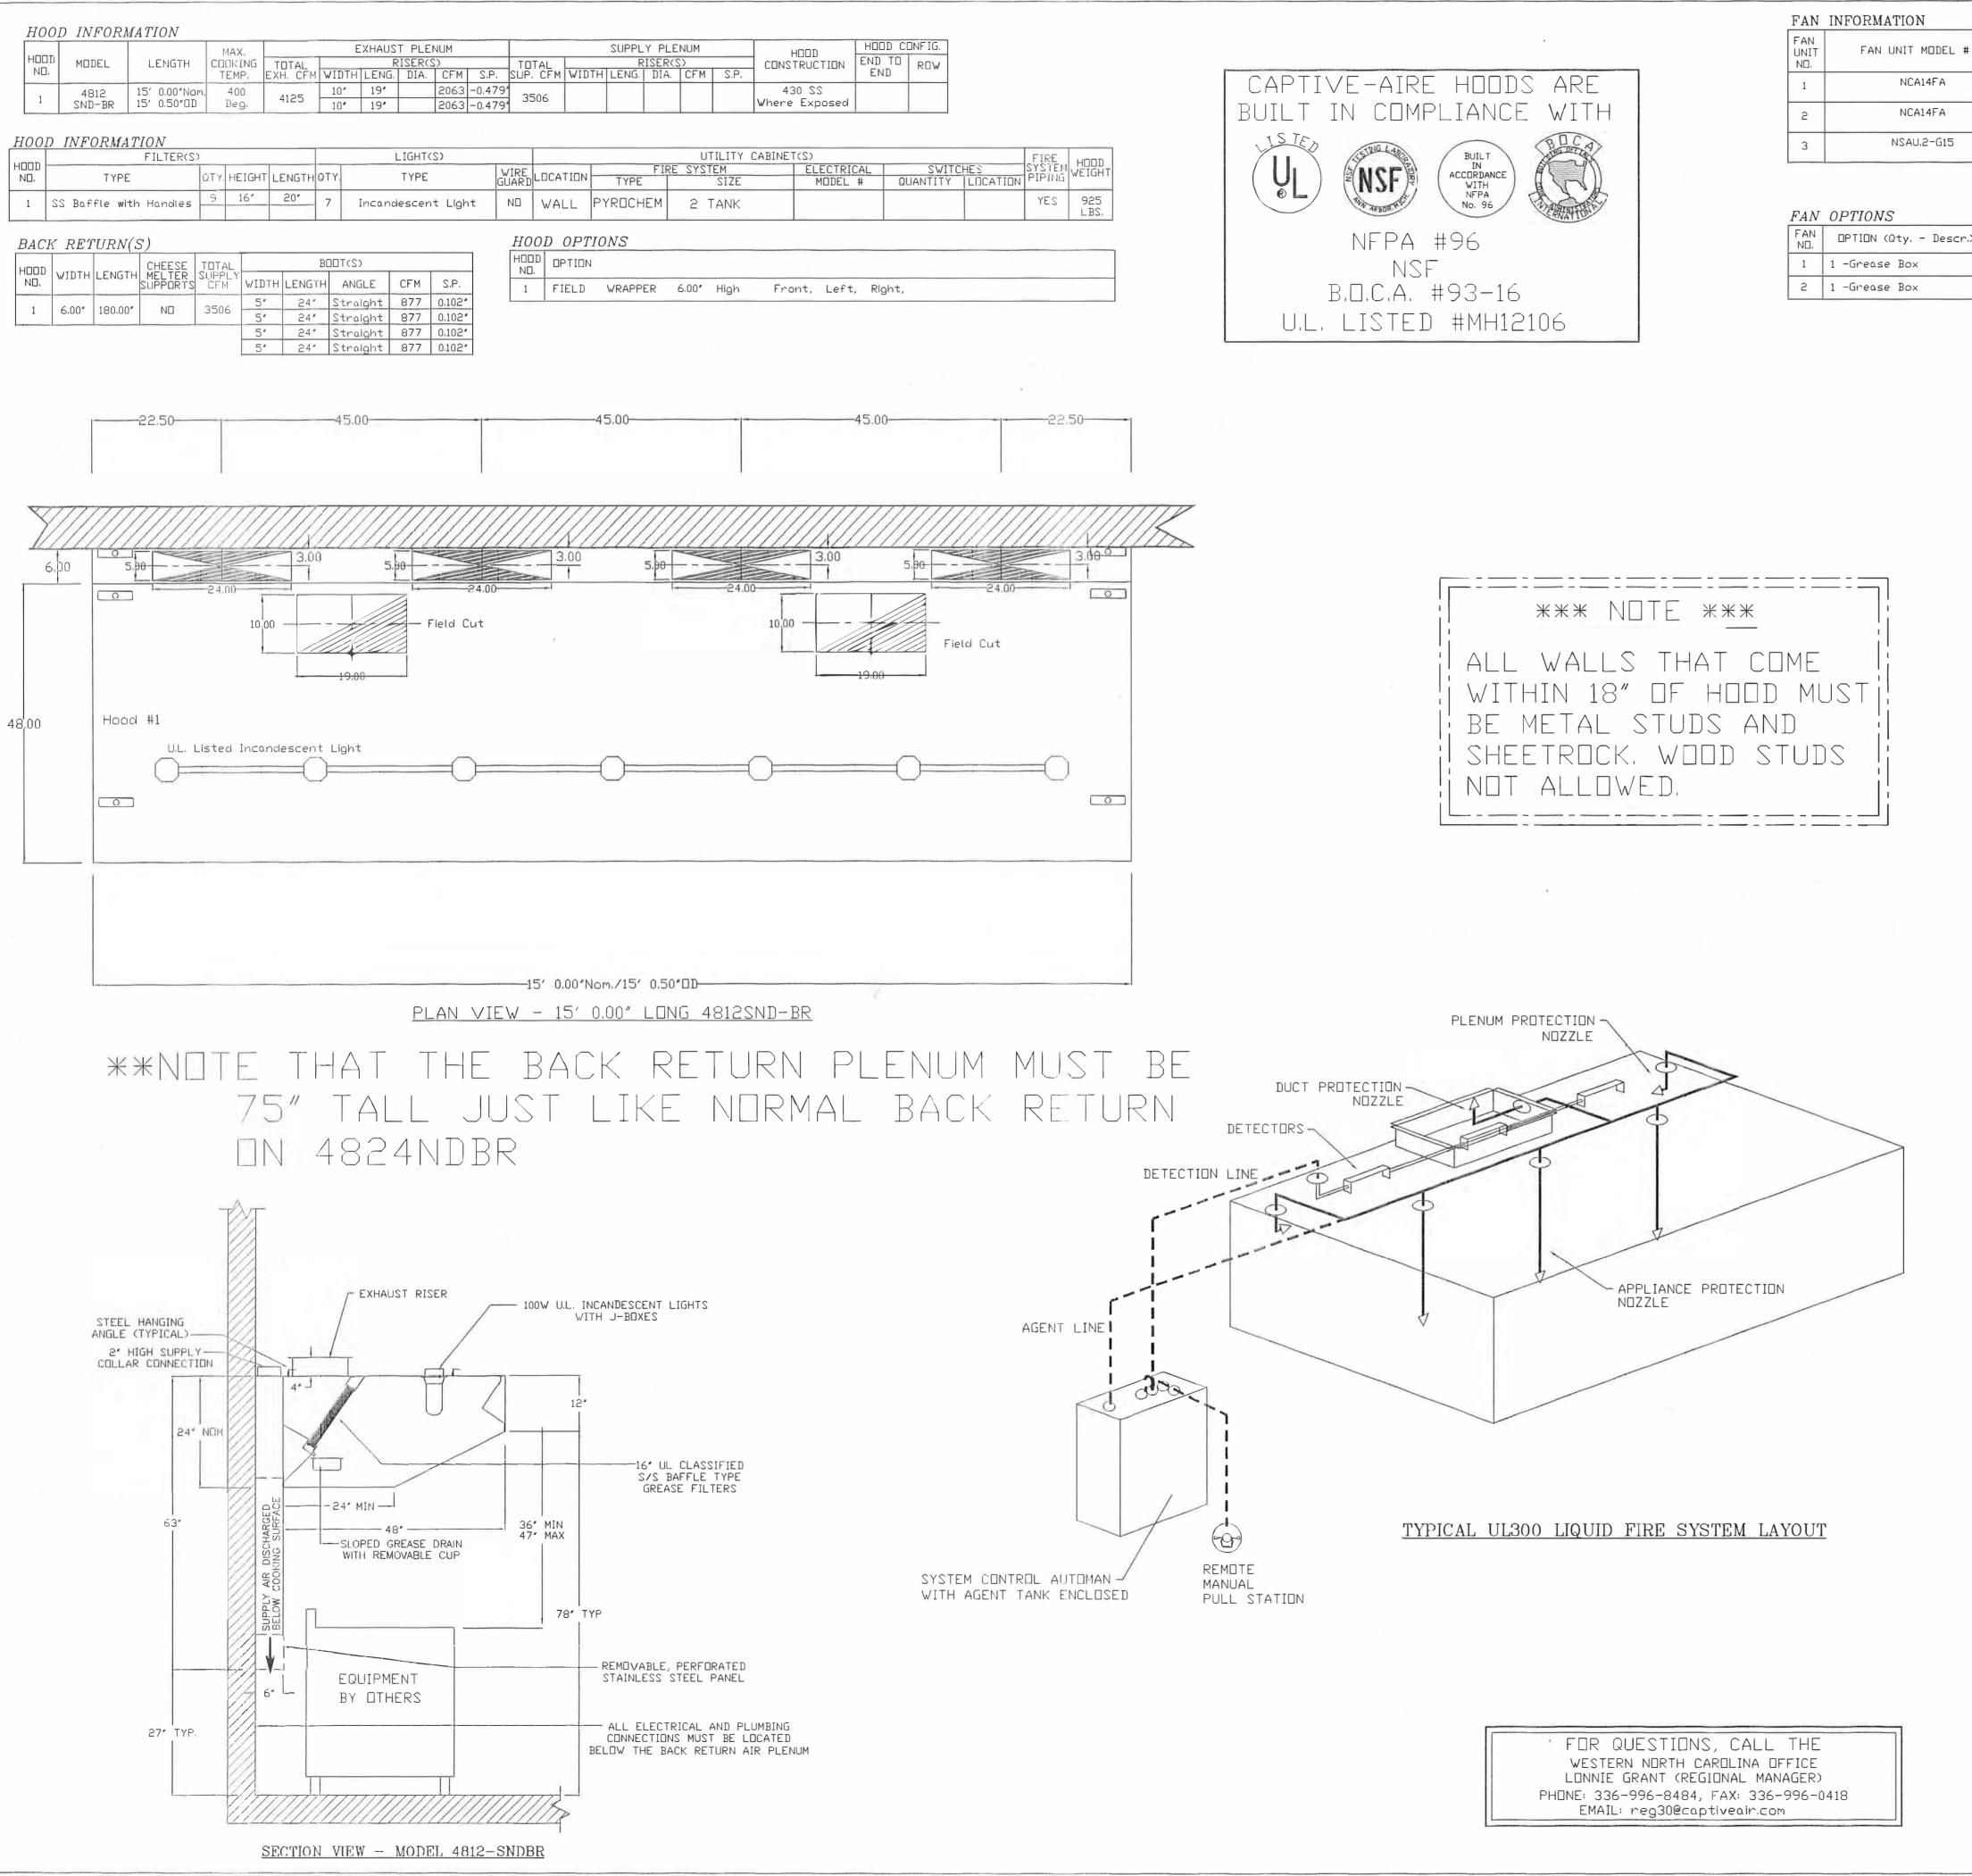

FAN				E	TZUAHX	AN								SUPF	LY FAN					
JNIT ND.	FAN UNIT MODEL #	MODEL	TAG	CFM	S.P.	RPM	H.P.	ø	VOLT	FLA	BLOWER	HDUSING	TAG	CFM	S.P.	RPM	H.P.	ø	VOLT	FLA
1	NCA14FA	NCA14FA		2063	-0.550*	1055	0.500	1	208	4.4										
2	NCA14FA	NCA14FA		2063	-0.550*	1055	0.500	1	208	4.4										
3	NSAU.2-G15										G15	NSAU.2MI		3506	0.650*	603	1.000	1	208	7.7

		$\frac{UU}{U}$	IKB	<u> </u>	
FAN	OPTIONS	ND	- DN FAN	ITEM	SIZE
FAN ND.	OPTION (Qty Descr.)	1	# 1	Curb 2	23,000°W × 23.000°L × 20,000°H 4,000:12,000 Pitch Vented Hinged
1	1 -Grease Box	2	# 2	Curb 6	3.000'W × 23.000'L × 20.000'H 4.000:12.000 Pltch Vented Hinged
2	1 -Grease Box	3	# 3	Curb	32.500"W × 32.500"L × 14.000"H 4.000:12.000 Pitch

CUSTOMER APPROVAL TO MANUFACTURE:

Approved as Noted

Approved with NO Exception Taken


Revise and Resubmit

SIGNATURE

Your Title


Date


PREWIRE PACKAGE INFORMATION

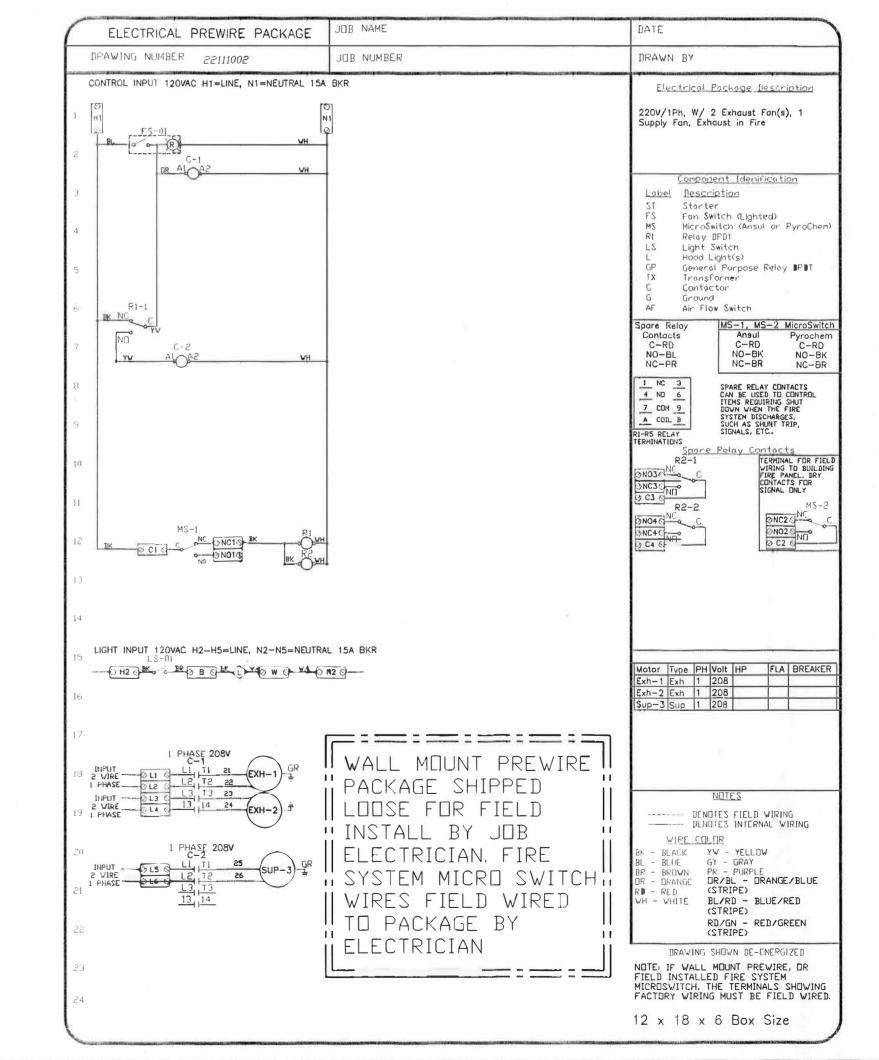



JOB BEAUCHAINES	
<i>Location</i> surf city, n	IC
<i>DATE</i> 12/10/2003	<i>JOB #</i> 231255
DWG # BESC	DRAWN BY LAG
<i>REV.</i> 1.00	SCALE NTS

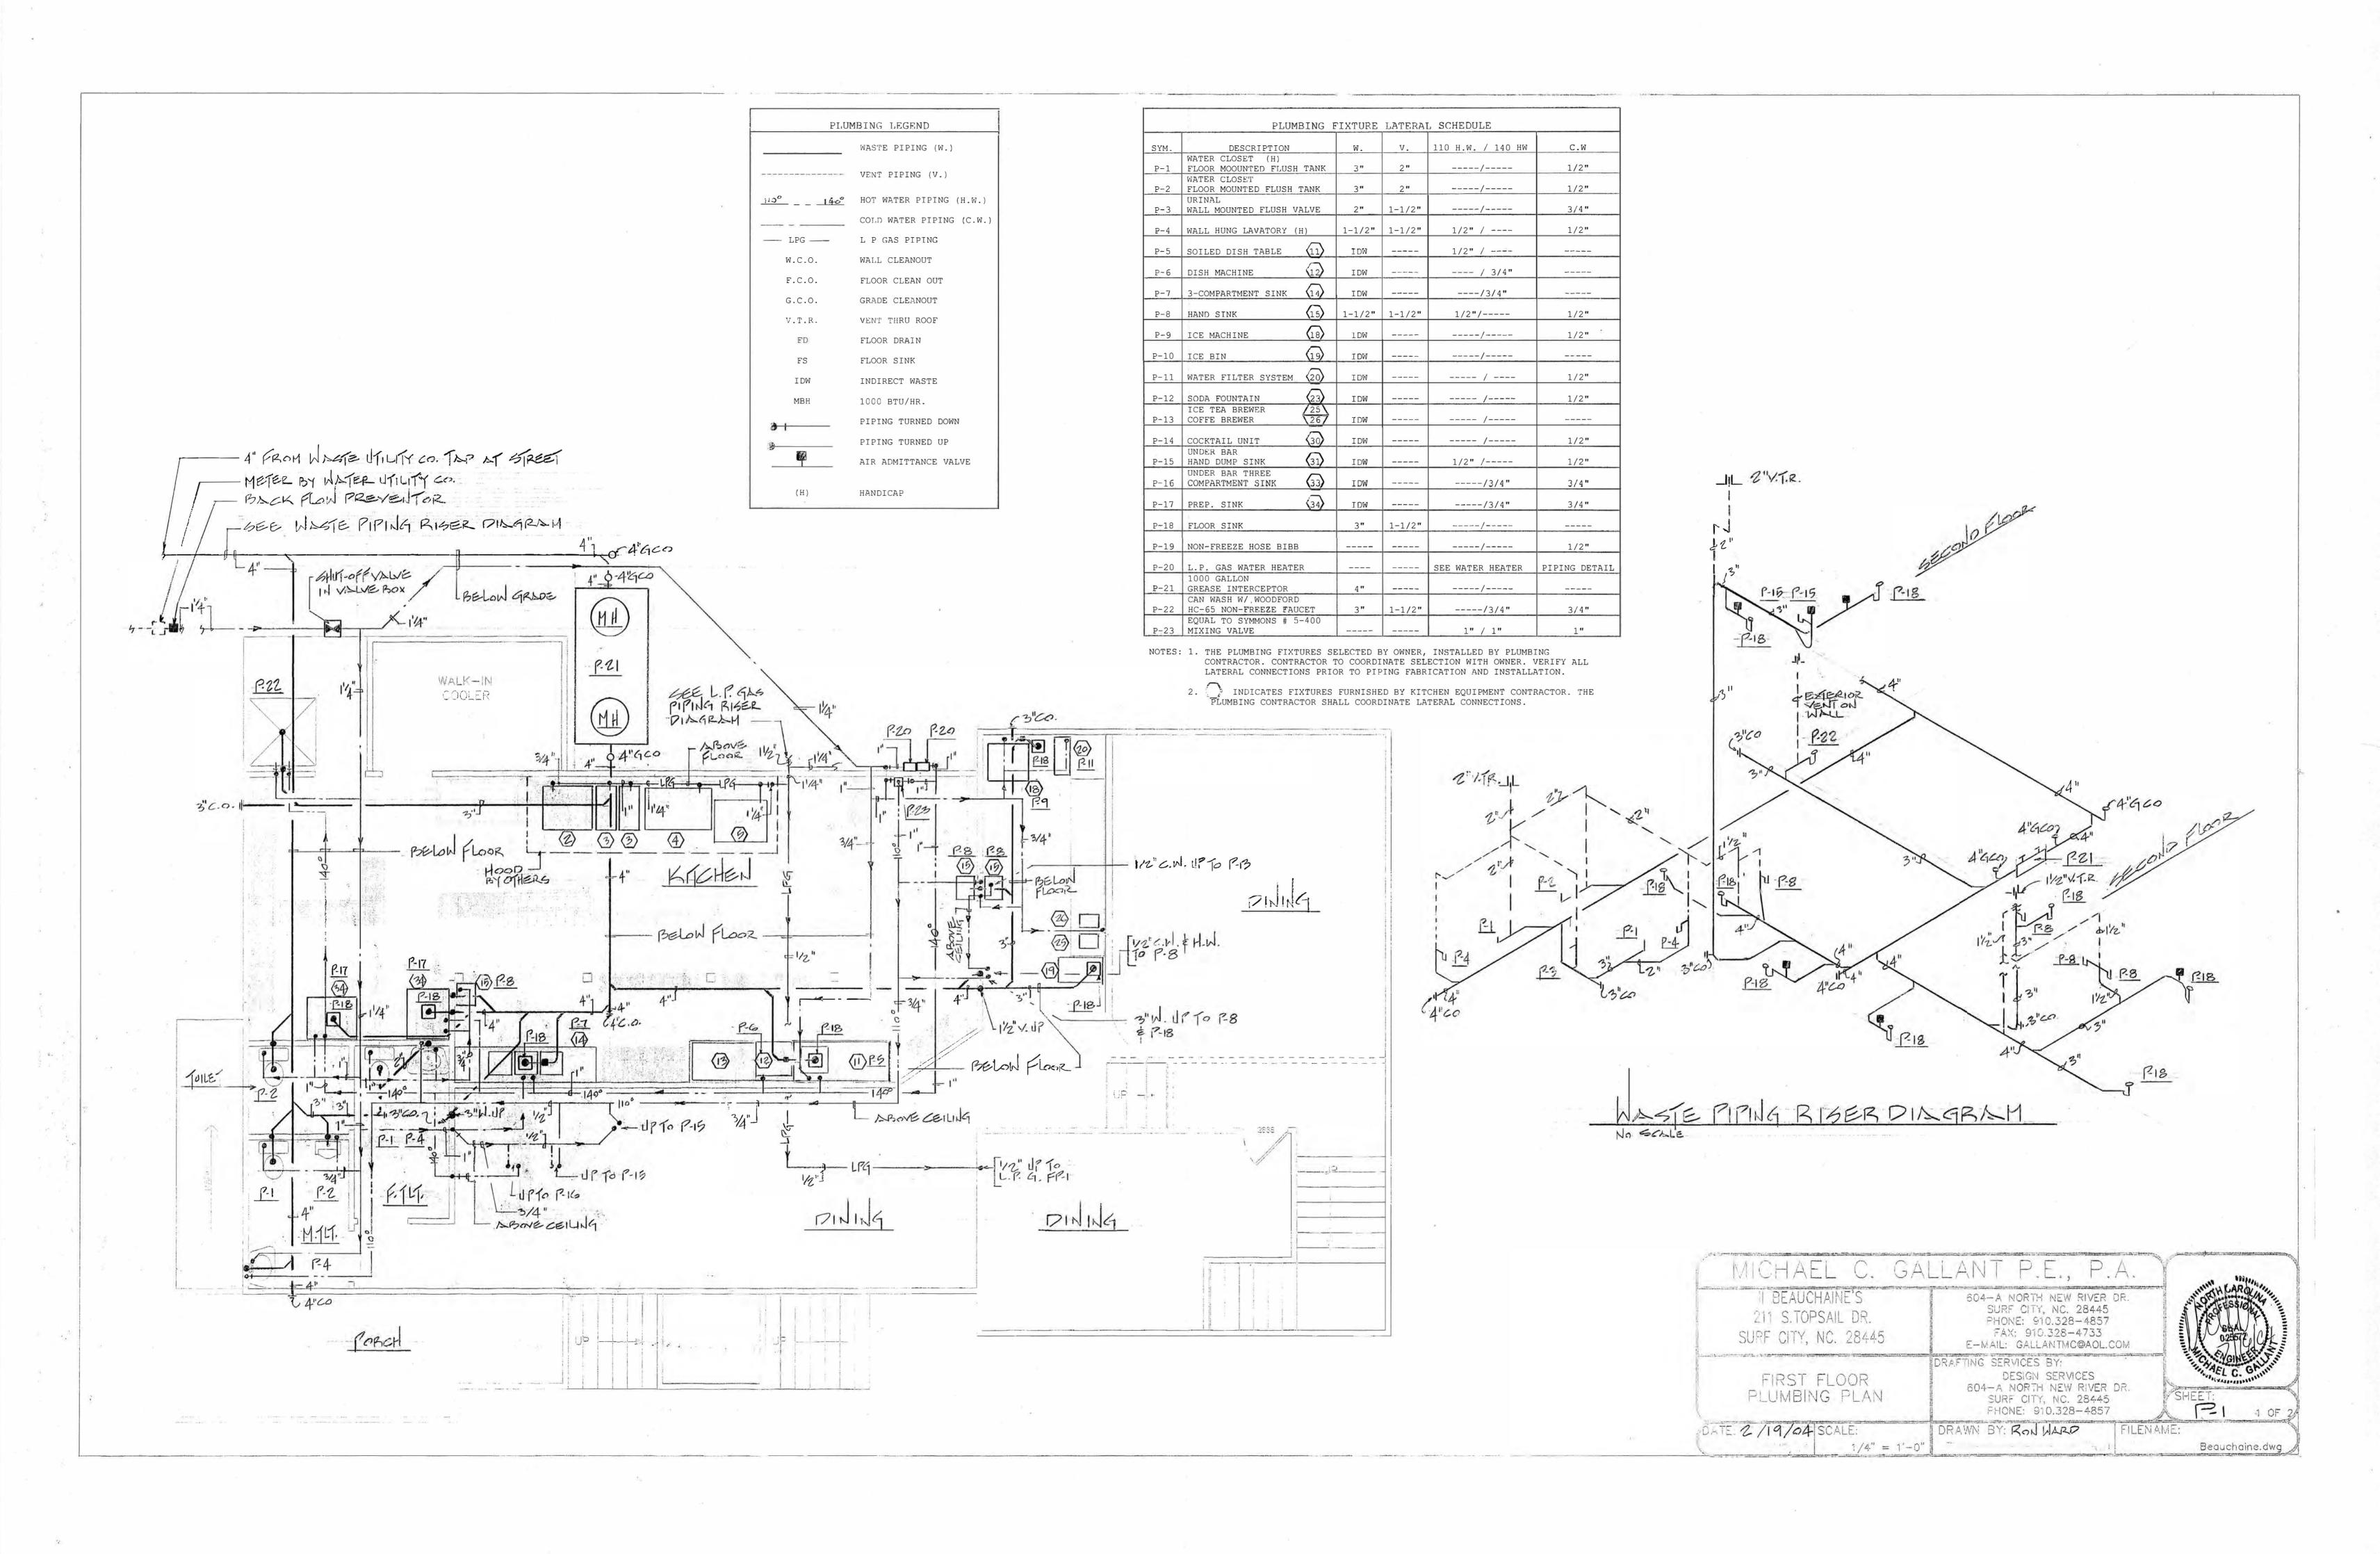

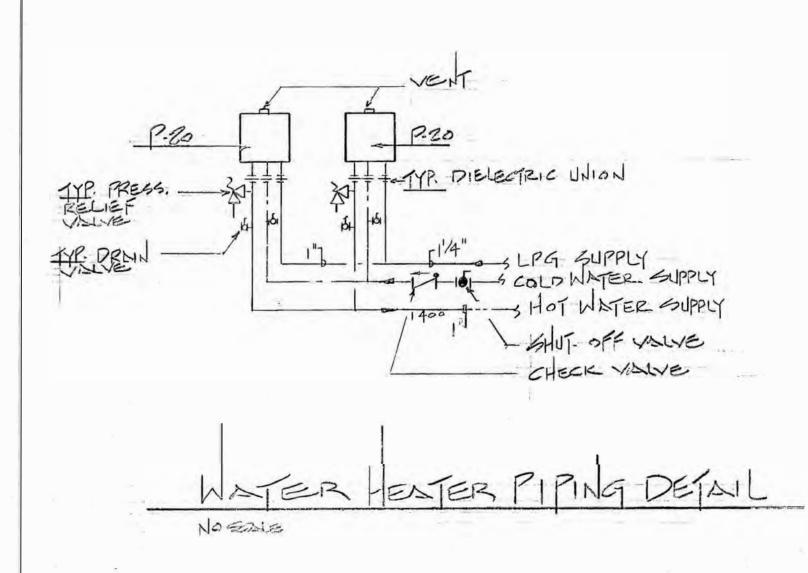


P-20: WATER HEATER (2) REQUIRED; EQUAL TO RINNAI MODEL NUMBER 2532WC EXTERNAL COMMERCIAL L.P. GAS INSTANTANEOUS WATER HEATER, 199,000 BTU/HR. INPUT, 198 GPH AT 100 DEGREE RISE EACH, MCC CONTROLLER TO 140 DEGREES WITH BC-45-4 110 DEGREE DOMESTIC HOT WATER CONTROL FOR 110 DEGREE HOT WATER FIXTURES, WATER PIPING COVER BOX, WATER PIPING INSTALLLATION KIT, FREEZE PROTECTION PACKAGE AND PRESSURE RELEIF VALVE, MANIFOLD KIT.

	GAS APPLIANCE	LATERAL SCHEDULE	
SYM.	DESCRIPTION	L.P. GAS INPUT BTU/HR	CONNECTION SIZE
2	6- BURNER RANGE	162,000	3/4"
3	(2)40 LB. SOUTHBEND FRYERS 120,000 BTU/HR. GAS INPUT EACH.	240,000	3/4" EACH
4	APW 3' CHAR GRILL	140,000	3/4"
5	SOUTHBEND CONVECTION OVEN	60,000	3/4"
P-20	(2) L.P. GAS WATER HEATER 199,000 BTU/HR. GAS INPUT EACH.	398,000	3/4" EACH
LPGFP-1	L.P. GAS FIRE PLACE	38,000	1/2"

NOTES:

- 1. L.P. GAS CONTRACTOR SHALL VERFY ALL GAS CONNECTIONS SIZES AND THE APPLIANCE GAS REGULATOR WORKING PRESSURE PRIOR TO PIPING INSTALLATION.
- 2. APPLIANCE IN SYMBOL INDICATES KITCHEN EQUIPMENT ITEMS.

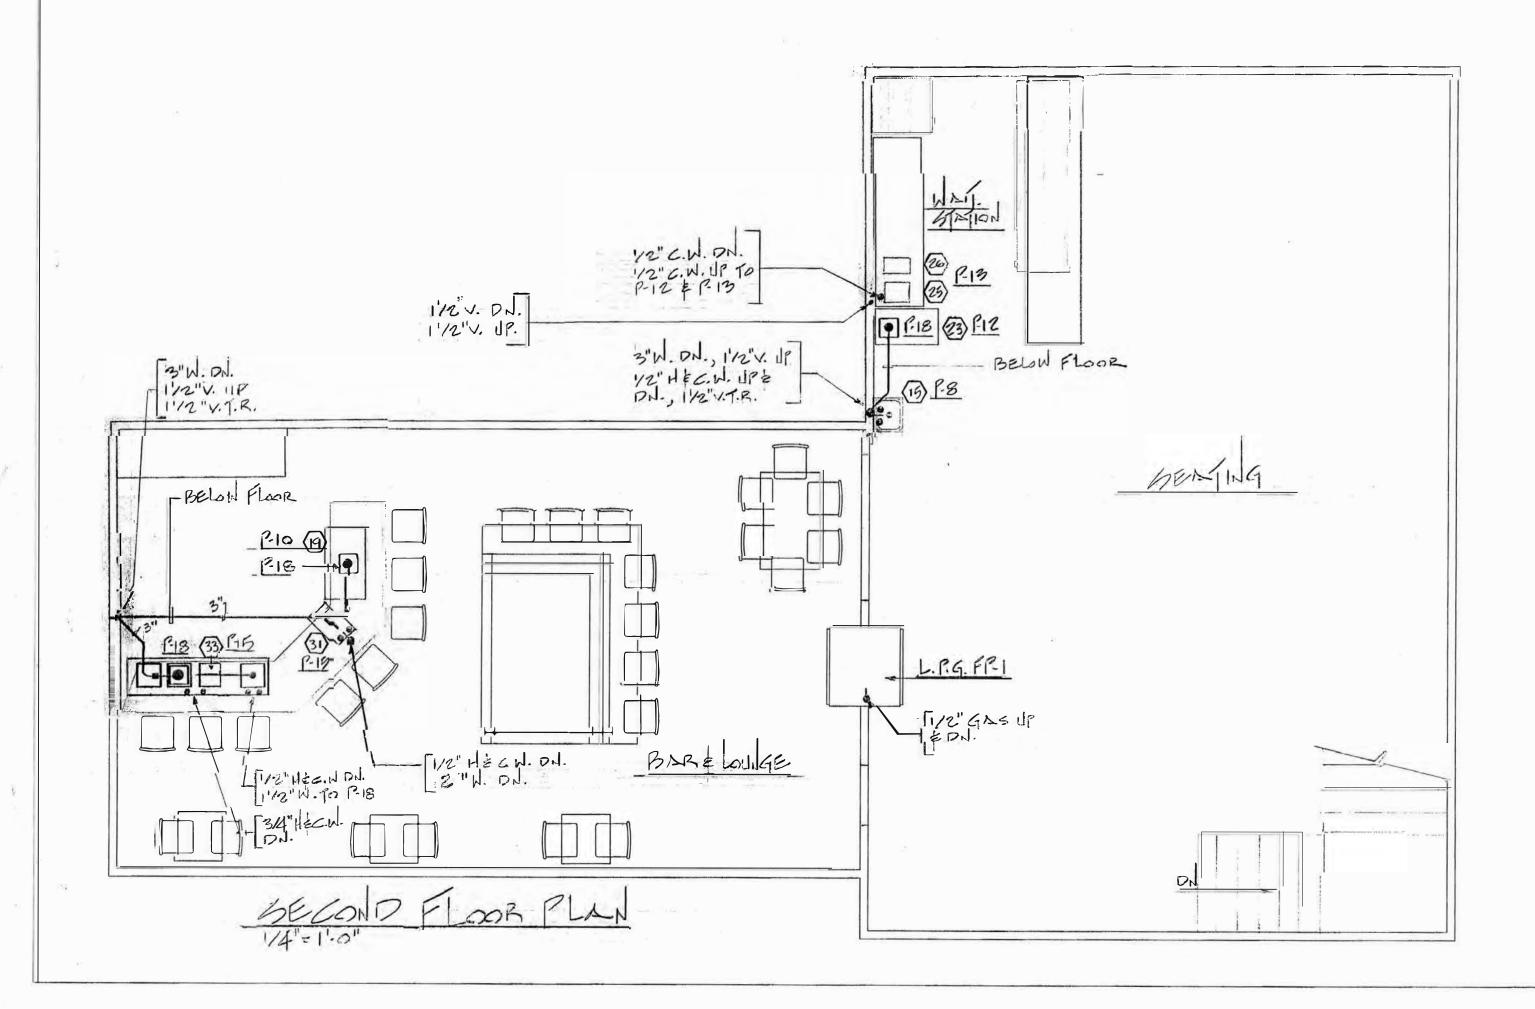

PLUMBING GENERAL SPECIFICATIONS

- THE FABRICATION AND INSTALLMENT OF THE ENTIRE PLUMBING SYSTEM SHALL BE PER CURRENT NORTH CAROLINA STATE AND LOCAL PLUMBING, GAS AND HANDICAP CODES.
 THE OWNER SHALL SELECT ALL FIXTURES AND TRIM. THE CONTRACTOR SHALL COORDINATE
- 3. THE CONTRACTOR SHALL FURNISH ALL LABOR, MATERIALS AND EQUIPMENT NECESSARY TO PROVIDE A COMPLETE OPERATING SYSTEM AS SHOWN ON PLANS. VISIT SITE PRIOR TO BIDDING PROJECT.
- THE DRAWINGS ARE SCHEMATIC AND ARE NOT INTENDED TO SHOW ALL FITTINGS, CONNECTION, OFFSETS, ETC. UNLESS DETAILED. THE DRAWINGS SHALL NOT BE SCALED. REFER TO THE ARCHITECTURAL DRAWINGS FOR FIXTURE LOCATIONS. REFER TO DRAWINGS OF OTHER TRADES AND COORDINATE WITH THE OTHER CONTRACTORS.

 WATER SERVICE: SITE AT 1/14" C.W., (32) GPM DEMAND. WASTE AND VENT PIPING SHALL BE

SCHEDULE 40 PVC-DWV CONFORMING TO ASTM D2665-6B AND C.S. 272-65 WITH NSF SEAL ALL


- PIPING ABOVE SLAB SHALL BE FLAME RETARDED AND CONFORMING TO "UL" LABORATORY 25-50 SMOKE AND FLAME RATING. ALL PIPES PENETRATIONS AT FIRE RATED FLOORS OR WALLS SHALL BE SLEEVED AND FIRE STOP PROVIDED PER RATED STRUCTURE CODE REQUIREMENTS.

 6. INTERIOR DOMESTIC COLD AND HOT WATER PIPING SHALL BE CPVC PIPE, PEX OR COPPER. CONCEAL WATER PIPING IN WALLS, ABOVE CEILING AS INDICATED IN THE PLANS. PROVIDE 3/8" ARMOFLEX INSULATION ON TRAP SIDE TO WATER HEATER COLD WATER PIPING AND ALL COLD WATER PIPING EXCEPT WALLS OR OTHER AREAS SURROUNDED ON BOTH SIDES BY HEATED SPACES. PROVIDE 3/8" ARMOFLEX INSULATION ON FIRST (8) FEET OF HOT WATER PIPING LEAVING WATER HEATER. ALL SUPPLIES TO FIXTURES TO HAVE INDIVIDUAL STOP VALVES. PROVIDE WATER HAMMER SHCOK ARRESTERS AS REQUIRED TO PREVENT WATER HAMMER.ARRESTER SHALL BE CERTIFIED, LOCATED AND SIZED IN ACCORDANCE WITH PDI.
- OPTIONAL 18" HIGH AIR CHAMBERS AT EACH FIXTURE PER CODE, IS ACCEPTABLE.
 7. CLEANOUTS ARE REQUIRED BY CODE. PROVIDE JOSAM, ZURN OR EQUAL BRONZE COVER DEPENDING ON WALL, FLOR OR EXTERIOR USE.
- 8. REDUCE LOW PRESSURE, HIGH HAZARD BACK FLOW PREVENTER SHALL BE DOUBLE CHECK VALVE AS MANUFACTURED BY BEECO OR WATTS; PROVIDE FREEZE PROOF COVER.

 9. TEST ALL SYSTEMS IN ACCORDANCE WITH THE NORTH CAROLINA STATE AND LOCAL PLUMBING CODES. THE CONTRACTOR SHALL FURNISH ALL NECESSARY EQUIPMENT, MATERIALS AND LABOR
- TO PERFORM THE TESTS.

 10. STERLIZATION: ALL WATER PIPING SHALL BE CHARGED WITH A CHLORINE SOLUTION CONTAINING NOT LESS THAN 50 PPM AVAILABLE CHLORINE. THE SOLUTION SHALL REMAIN IN THE PIPING FOR 24 HOURS, VALVES SHALL BE OPENED AND CLOSED DURING THIS TIME TO ALLOW A FLOW OF SOLUTION THRU THE SYSTEM. AFTER 24 HOURS, THE SOLUTION SHALL BE TESTED AND MST CONTAIN A RESIDUAL OF AT LEAST 5-10 PPM CHLORINE. THE SYSTEM SHALL BE DRAINED AND FLUSHED TO PROVIDE POTABLE WATER BEFORE FINAL CONNECTION IS MADE TO THE WATER UTILITY CO. MAIN IS MADE. THE CONTRACTOR SHALL NOTIFY THE LOCAL
- BOARD OF HEALTH IN WRITING SEVEN DAYS IN ADVANCE OF SYSTEM STERILIZATION.

 11. GUARANTY AND WARRANTY: THE PLUMBING CONTRACTOR SHALL GUARANTEE AND WARRANT FOR A PERIOD OF TWELVE MONTHS AGAINST FAULTY WORKMAN-SHIP OR MATERIALS AND AGREE TO MAKE GOOD ANY SUCH DEFECT DURING THIS GUARANTY PERIOD BEGINNING WITH THE DATE OF ACCEPTANCE. SUCH DATES SHALL BE STATED ON FINAL CERTIFICATE OF PAYMENT.

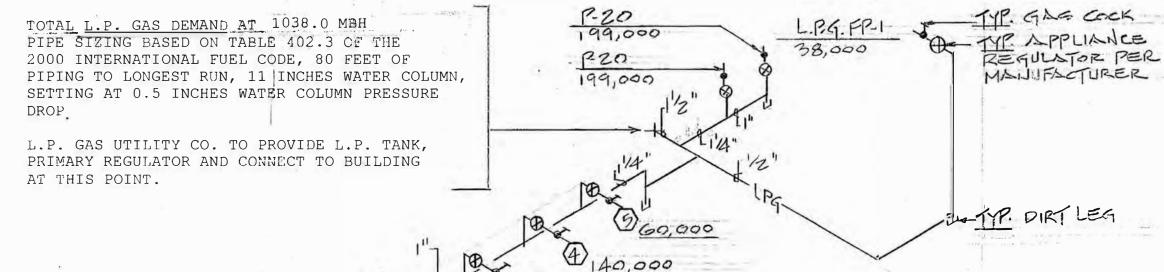

GAG PIPING RIBER DIAGRAM

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SURF CITY, NC. 28445
PHONE: 910.328-4857
OATE: 2/19/04 | SCALE:
1/4" = 1'-0"

DRAWN BY: Roll March III