





**ABBREVIATIONS**

A.B.	ANCHOR BOLT	G.	GAS	R.	RADIUS, REGULATOR
ACT.	ACOUSTIC TILE	GA.	GAUGE	R.A.	RETURN AIR
ADJ.	ADJUSTABLE	GAL.V.	GALVANIZED	RAD.	RADIUS
A.F.F.	ABOVE FINISHED FLOOR	G.B.	GRAB BAR	RCP	REINFORCED CONC. PIPE
A.M.F.	ABOVE MEZZANINE FLOOR	GL.	GLASS OR GLAZING	R.D.	ROOF DRAIN
ALT.	ALTERNATE	GR.	GRADE	REC.	RECESSED
ALUM.	ALUMINUM	GW	GYPSUM WALL BOARD	REFRIG.	REFRIGERATOR
ANCH.	ANCHOR	GV	GAS VALVE	REINFC.	REINFORCING
A.P.	ACCESS PANEL	H.B.	HOSE BIBB	REQD.	REQUIRED
APPROX.	APPROXIMATE	H.C.	HOSE CABINET	R.H.	RIGHT HAND
APVD.	APPROVED	HDW.	HARDWARE	R.L.	ROOF LEADER
APPRVD.	APPROVED	HDWD.	HARDWOOD	RM.	ROOM
B.C.	BRICK COURSE	HDWL.	HEAD WALL	RTU	ROUGH TOP UNIT
BD.	BOARD	HHW	HEATED HOT WATER	R.O.	ROUGH OPENING
B.F.E.	BOTTOM FOOTING ELEVATION	HHWR	HEATED HOT WATER RETURN	R/W	RIGHT-OF-WAY
B.L.	BUILDING LINE	H.M.	HOLLOW METAL		
BLDG.	BUILDING	HORIZ.	HORIZONTAL		
BLK.	BLOCK	HR.	HOUR		
B.M.	BENCH MARK	HD. R.	HANDRAIL		
B.O.D.	BOTTOM OF DECK	H.S.	HOSE STATION		
B.O.J.	BOTTOM OF JOIST	HT.	HEIGHT		
B.O.P.	BOTTOM OF PURLIN	HW	HOT WATER		
B.O.S.	BOTTOM OF STEEL	HYD.	FIRE HYDRANT		
BOT.	BOTTOM				
BRG.	BEARING	I.D.	INSIDE DIAMETER		
B.U.	BUILT UP	I.F.	INSIDE FACE		
C/C	CENTER TO CENTER	IN.	INCH		
C.	COURSE	INSUL.	INSULATION		
CAB.	CABINET	INT.	INTERIOR		
C.B.	CATCH BASIN	INV.	INVERT		
C.C.	CENTER TO CENTER				
CEM.	CEMENT	J.B.	JOIST BEARING ELEVATION		
C.F.M.	CUBIC FOOT/MINUTE	J.B.X.	JOINT BOX		
CHW	CHILLED WATER	JT.	JOINT		
CHWR	CHILLED WATER RETURN				
C.I.P.	CAST IRON PIPE	K.D.	KNOCK DOWN		
C.J.	CONTROL JOINT	KIP	1 KIP EQUALS 1000 POUNDS		
CIRC.	CIRCUIT	K.O.	KNOCK OUT		
C.L.	CENTER LINE	K.PL.	KICK PLATE		
CLG.	CEILING	KSF	KIPS PER SQUARE FOOT		
CLO.	CLOSET				
CLR.	CLEAR	L.	LENGTH, LONG		
CMU	CONC. MASONRY UNIT	LAB.	LABORATORY		
CMP	CORRUGATED METAL PIPE	LAM.	LAMINATED		
C.O.	CLEANOUT	LAV.	LAVATORY		
COL.	COLUMN	LF.	LINEAR FEET		
CONC.	CONCRETE	LG.	LENGTH		
CONST.	CONSTRUCTION	LGM	LIGHT GAUGE METAL		
CONT.	CONTINUOUS	L.H.	LEFT HAND		
CONTR.	CONTRACTOR	L.L.H.	LONG LEG HORIZ.		
CORR.	CORRUGATED	L.L.V.	LONG LEG VERTICAL		
CPT.	CARPET	L.W.	LIGHT WEIGHT		
C.T.	CERAMIC TILE				
CU.	CUBIC	M.	METER		
CW	COLD WATER	MATL.	MATERIAL		
D.	DEEP	MAX.	MAXIMUM		
D.C.	DRY CHEMICAL	MECH.	MECHANICAL		
DEG.	DEGREE	MEMB.	MEMBRANE		
DEPT.	DEPARTMENT	MFR.	MANUFACTURE		
DET.	DETAIL	MH.	MANHOLE		
D.F.	DRINKING FOUNTAIN	MIN.	MINIMUM		
DIA.	DIAMETER	MIR.	MIRROR		
DIM.	DIMENSION	MISC.	MISCELLANEOUS		
DISP.	DISPENSER	M.O.	MASONRY OPENING		
DIST.	DISTRIBUTION	M.P.	MOVABLE PARTITION		
DN.	DOWN	MPH	MILES PER HOUR		
DR.	DOOR	MTL.	METAL		
DS.	DOWNSPOUT	MULL.	MULLION		
D.W.	DOMESTIC WATER	MFR.	MANUFACTURER		
DWG.	DRAWING	MTL.	METAL		
DGA	DENSE GRADE AGGREGATE	MEZZ.	MEZZANINE		
DWW	DRAIN, WASTE, VENT				
EA.	EACH	N.I.C.	NOT IN CONTRACT		
E.F.	EACH FACE	NO.	NUMBER		
EF	EXHAUST FAN	NOM.	NOMINAL		
E.J.	EXPANSION JOINT	N.S.	NON-SLIP		
ELEC.	ELECTRIC	N.T.S.	NOT TO SCALE		
ELEV.	ELEVATION				
ENT.	ENTRANCE	O.A.	OVERALL		
EQ.	EQUAL	O.C.	ON CENTER		
EQUIP.	EQUIPMENT	O.D.	OUTSIDE DIAMETER		
EXH.	EXHAUST	O.F.	OUTSIDE FACE		
EXIST.	EXISTING	O.H.	OVERHEAD		
EXP.	EXPOSED	OPG.	OPENING		
EXT.	EXTENSION/EXTERIOR	OPP.	OPPOSITE		
E.W.	EACH WAY	OPZ.	OUNCE		
E.W.C.	ELECTRIC WATER COOLER				
F.A.	FRESH AIR	PART.	PARTITION		
FACP	FIRE ALARM CONTROL PANEL				
FAAP	FIRE ALARM ANNUNCIATOR PANEL				
F.B.	FACE BRICK	P.E.M.B.	PRE-ENGINEERED METAL BUILDING		
F.C.O.	FLOOR CLEANOUT	PERF.	PERFORATED		
F.D.	FLOOR DRAIN	P.I.V.	POST INDICATOR VALVE		
F.D.C.	FIRE DEPARTMENT CONNECTION	P. LAM.	PLASTIC LAMINATE		
FDN.	FOUNDATION	PLBG.	PLUMBING		
F.E.	FIRE EXTINGUISHER	PWD.	PLYWOOD		
F.F.E.	FINISHED FLOOR ELEVATION	PSF	POUNDS PER SQUARE FOOT		
F.H.	FULL HEIGHT	PSI	POUNDS PER SQUARE INCH		
FIN.	FINISH	P.T.D.	PAINTED		
FIX.	FIXTURE	P.T.D.	PAPER TOWEL DISPENSER		
FL.	FLOOR	PVC.	POLYVINYL CHLORIDE		
F.R.	FIRE RESISTANT	PVMT.	PAVEMENT		
F.S.	FULL SIZE				
FT.	FOOT or FEET	Q.T.	QUARRY TILE		


**ADA COMPLIANT RESTROOM DIMENSIONS**

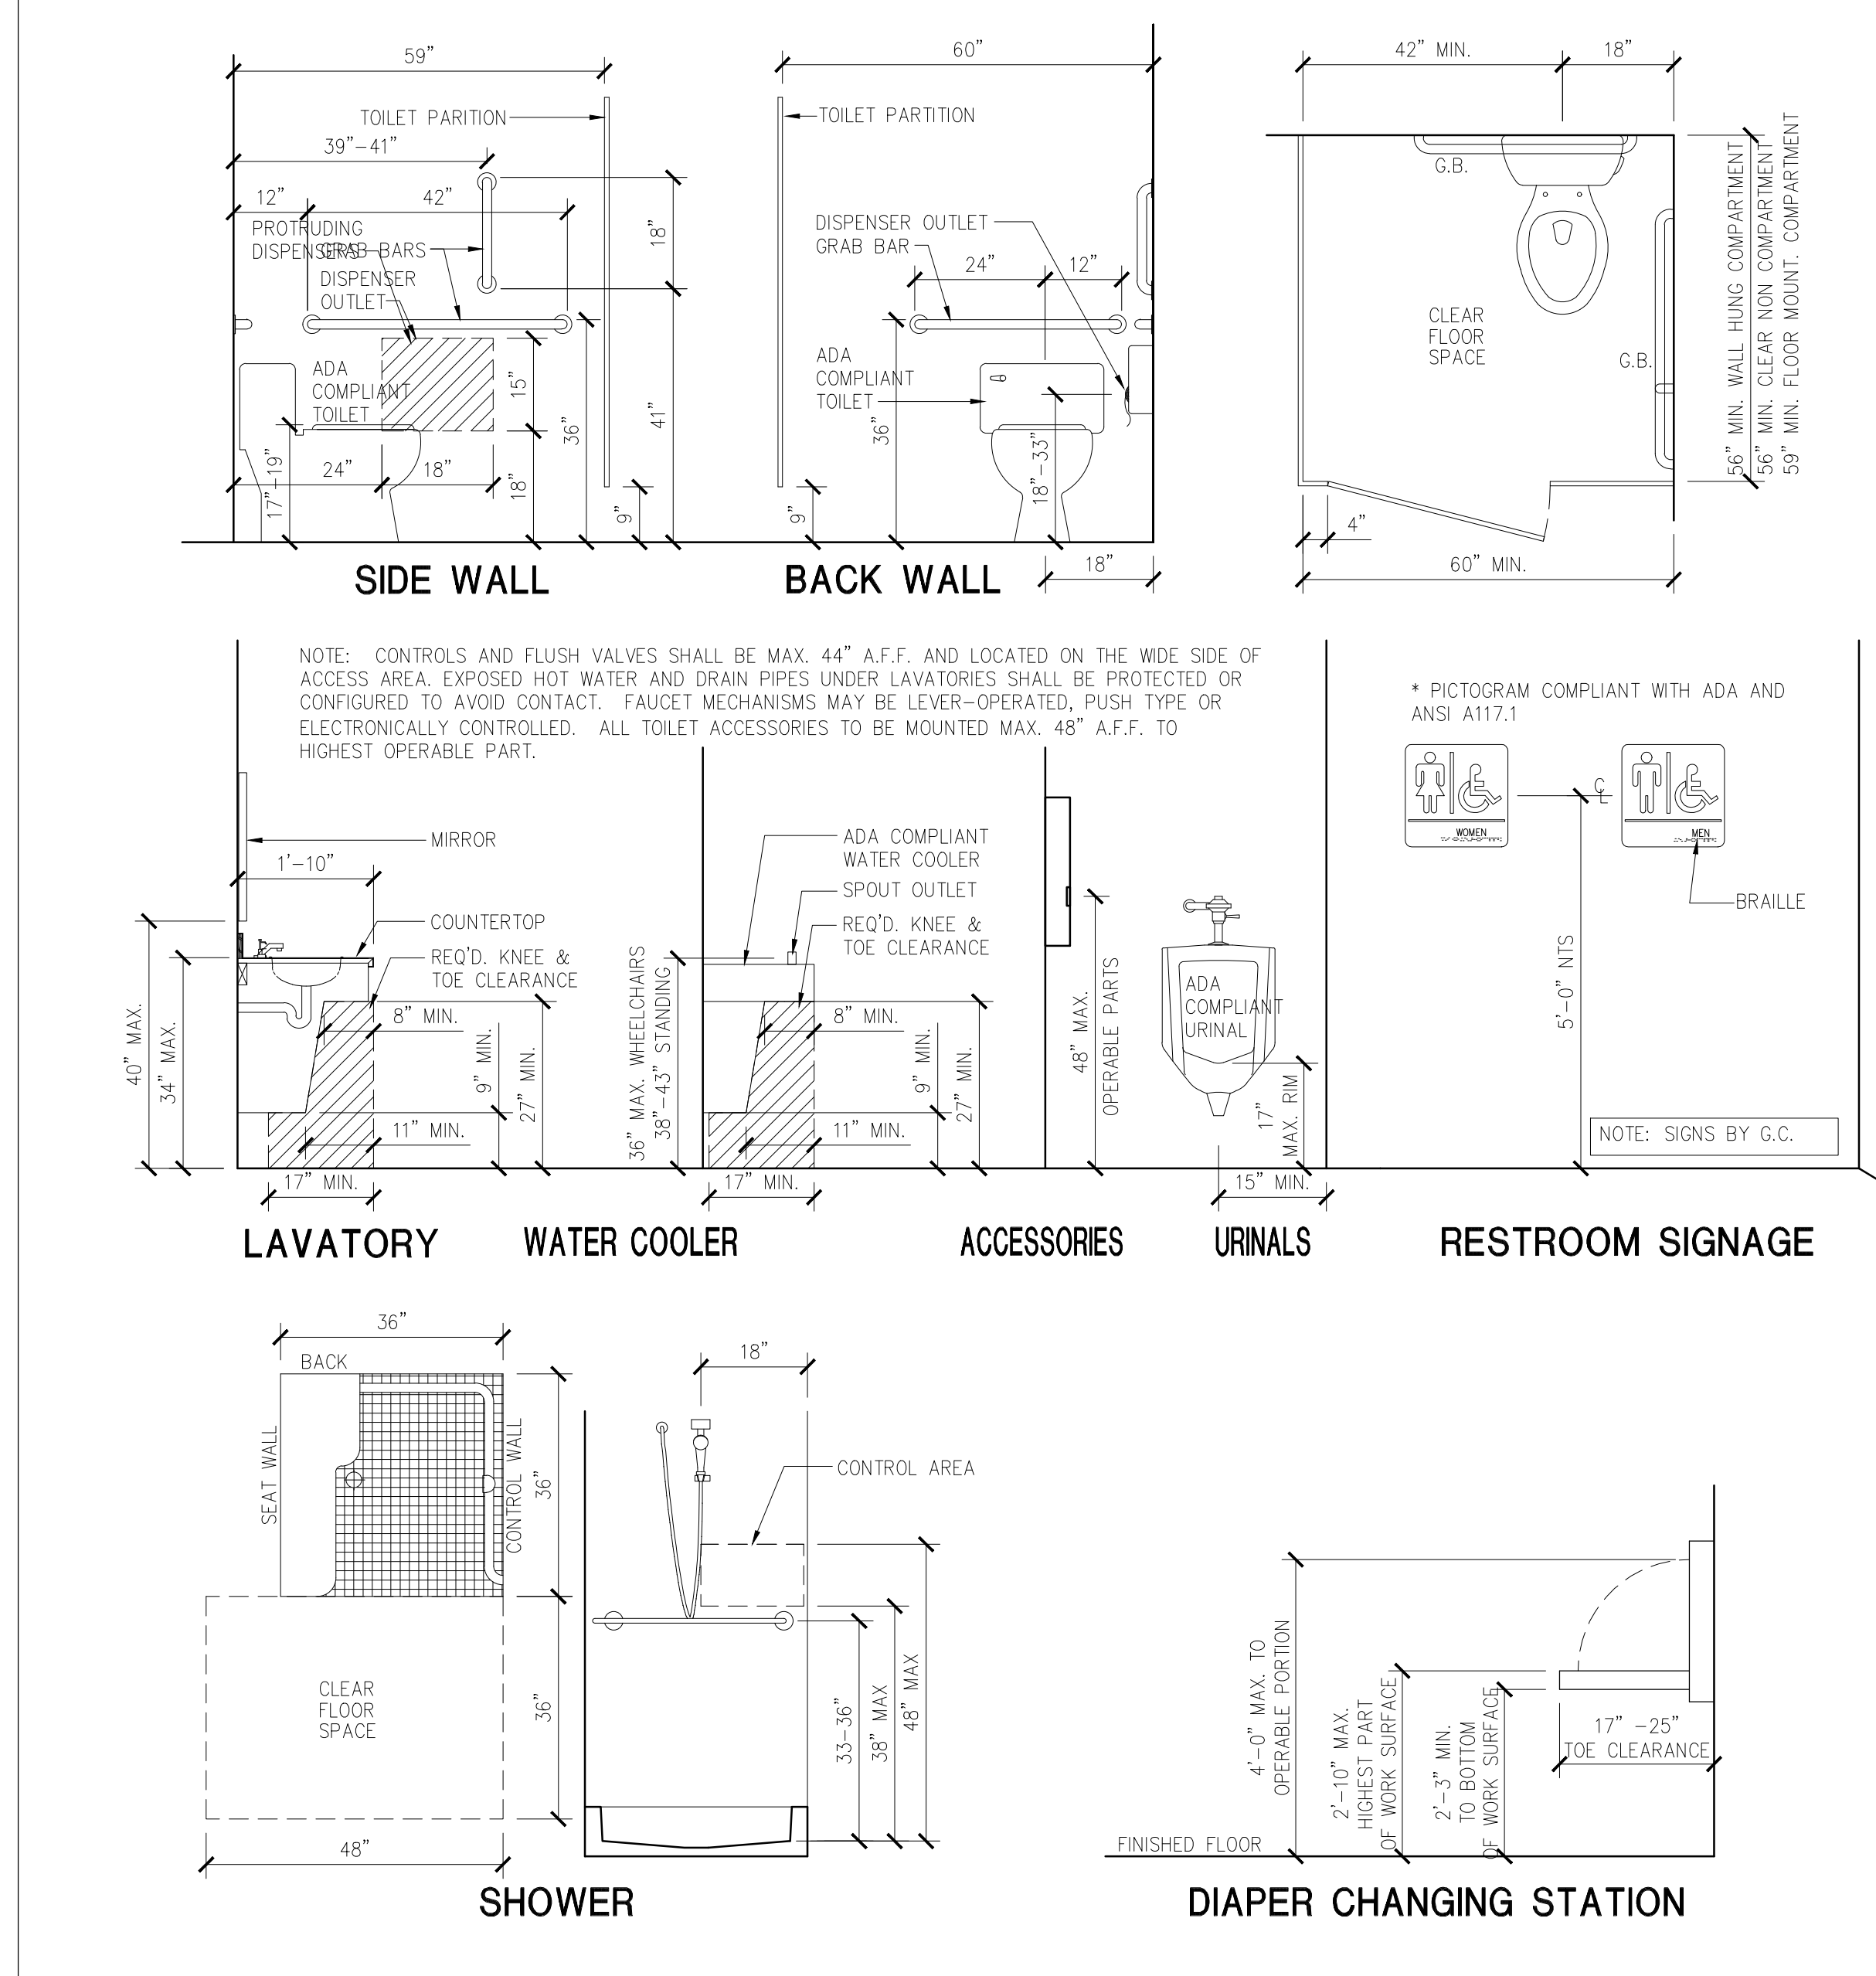

**ARCHITECTURAL SYMBOLS**

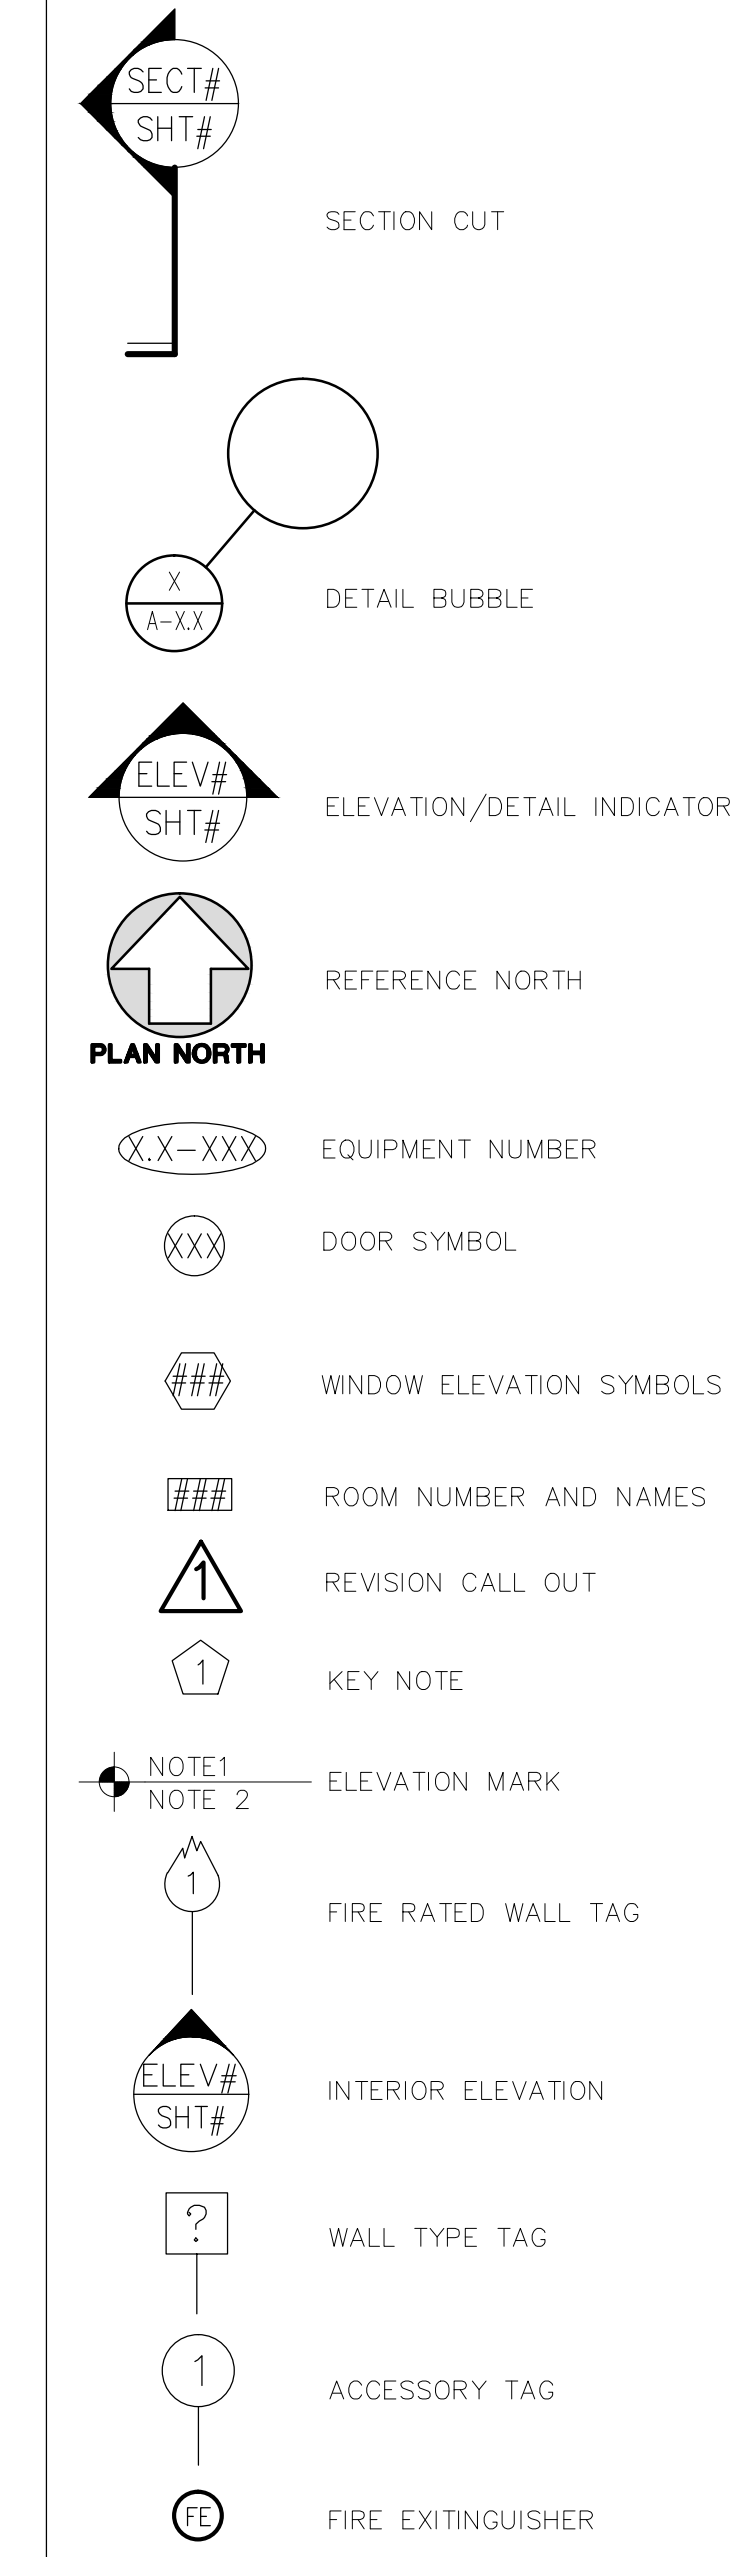

**ADA SWINGING DOOR MANEUVERING CLEARANCES**

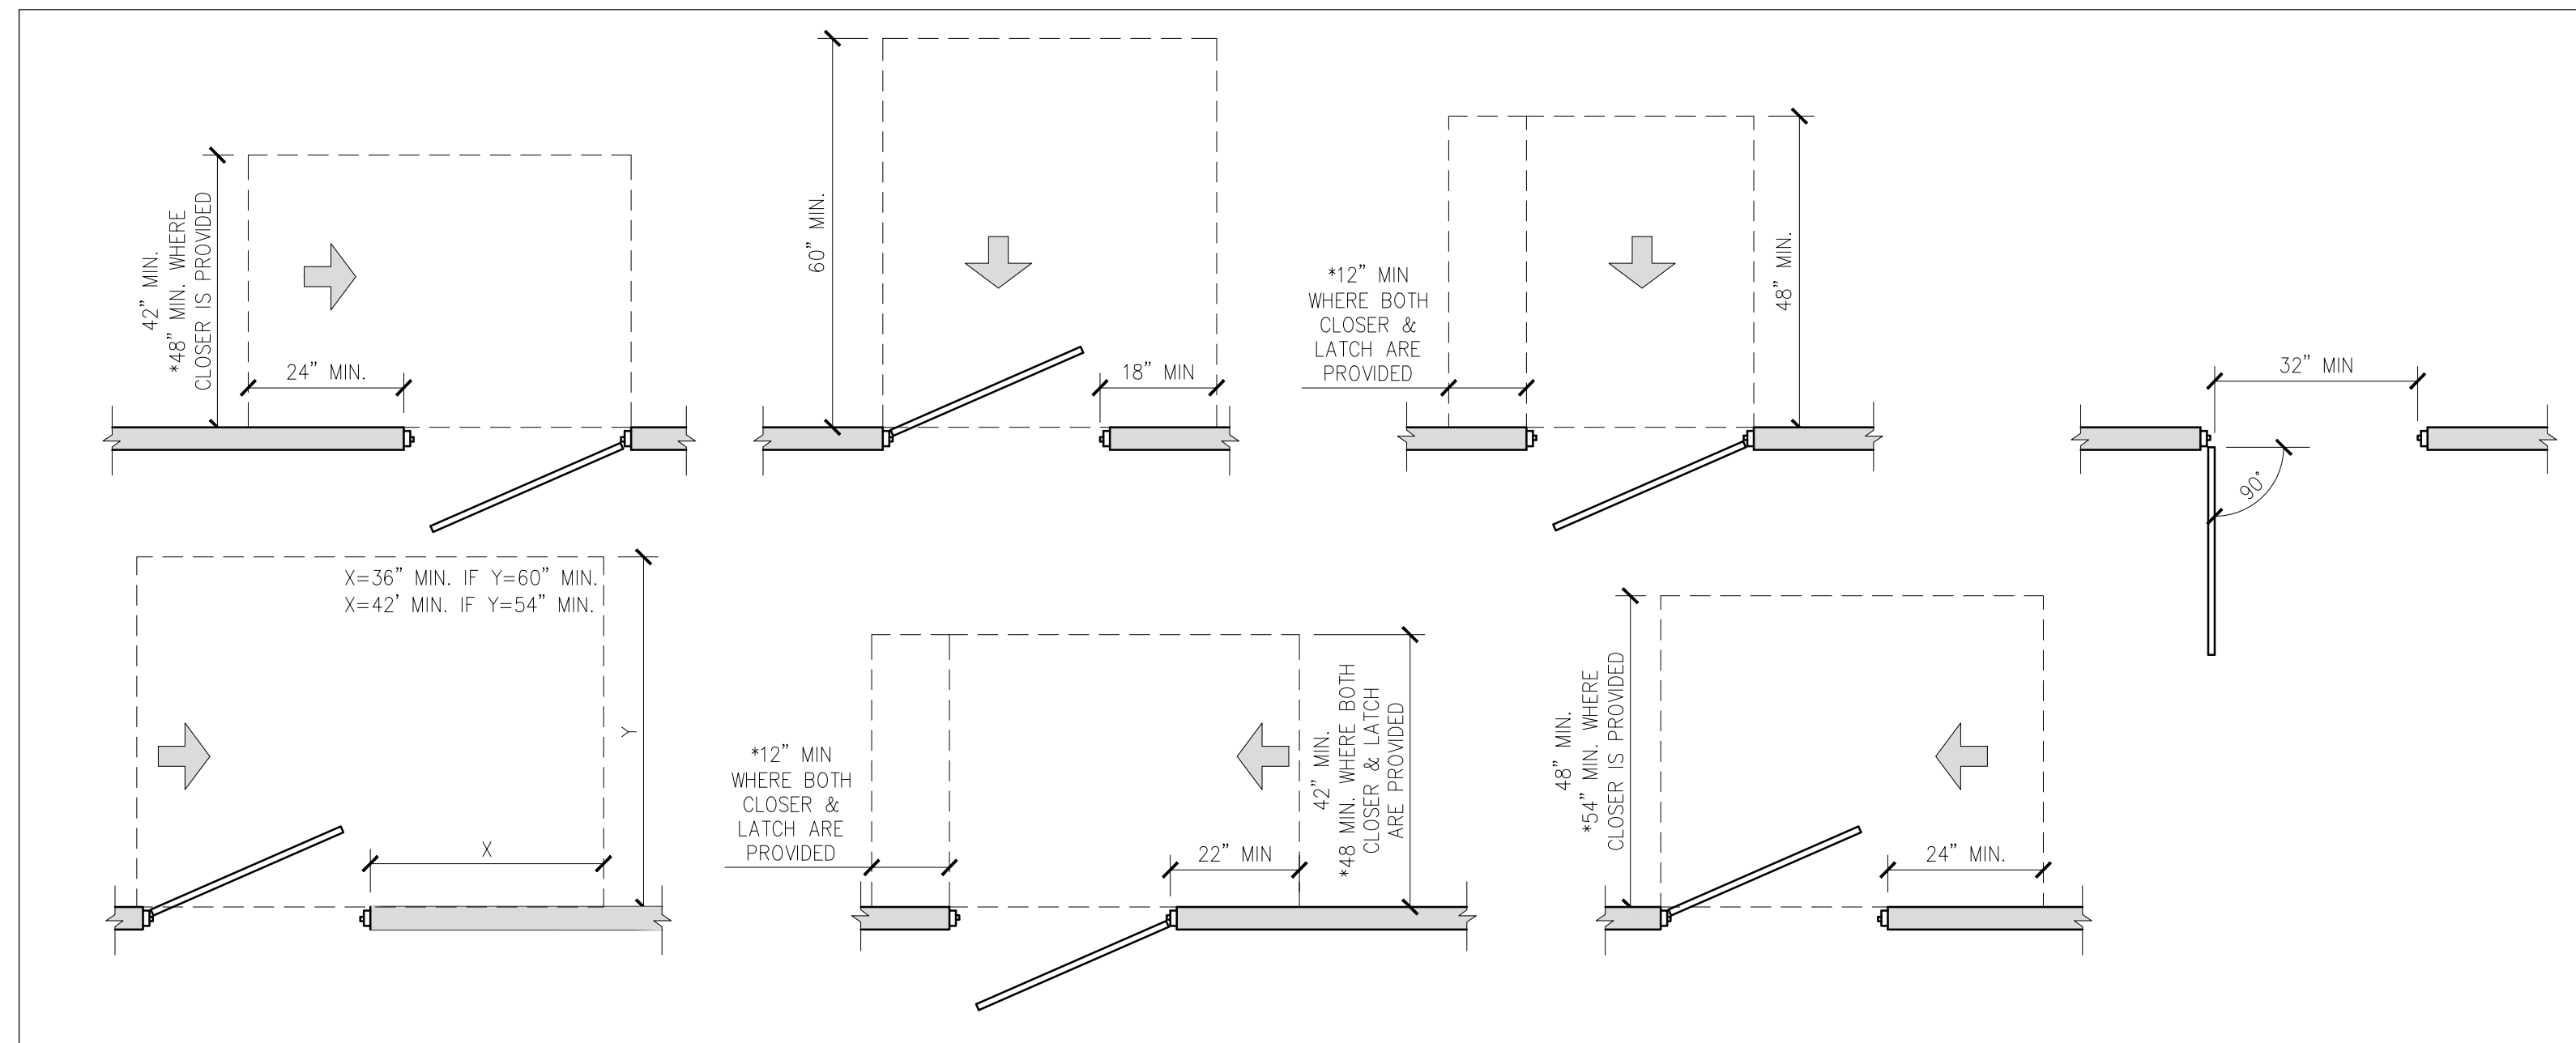

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 23DS-1048  
 FILENAME: Fit-Up for Tenant Demising Walls  
 SCALE: AS NOTED  
 PLOT DATE: Bowling Green, Kentucky  
 SHEET TITLE: Abbreviations/Symbols  
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SHEET: CS-0.1

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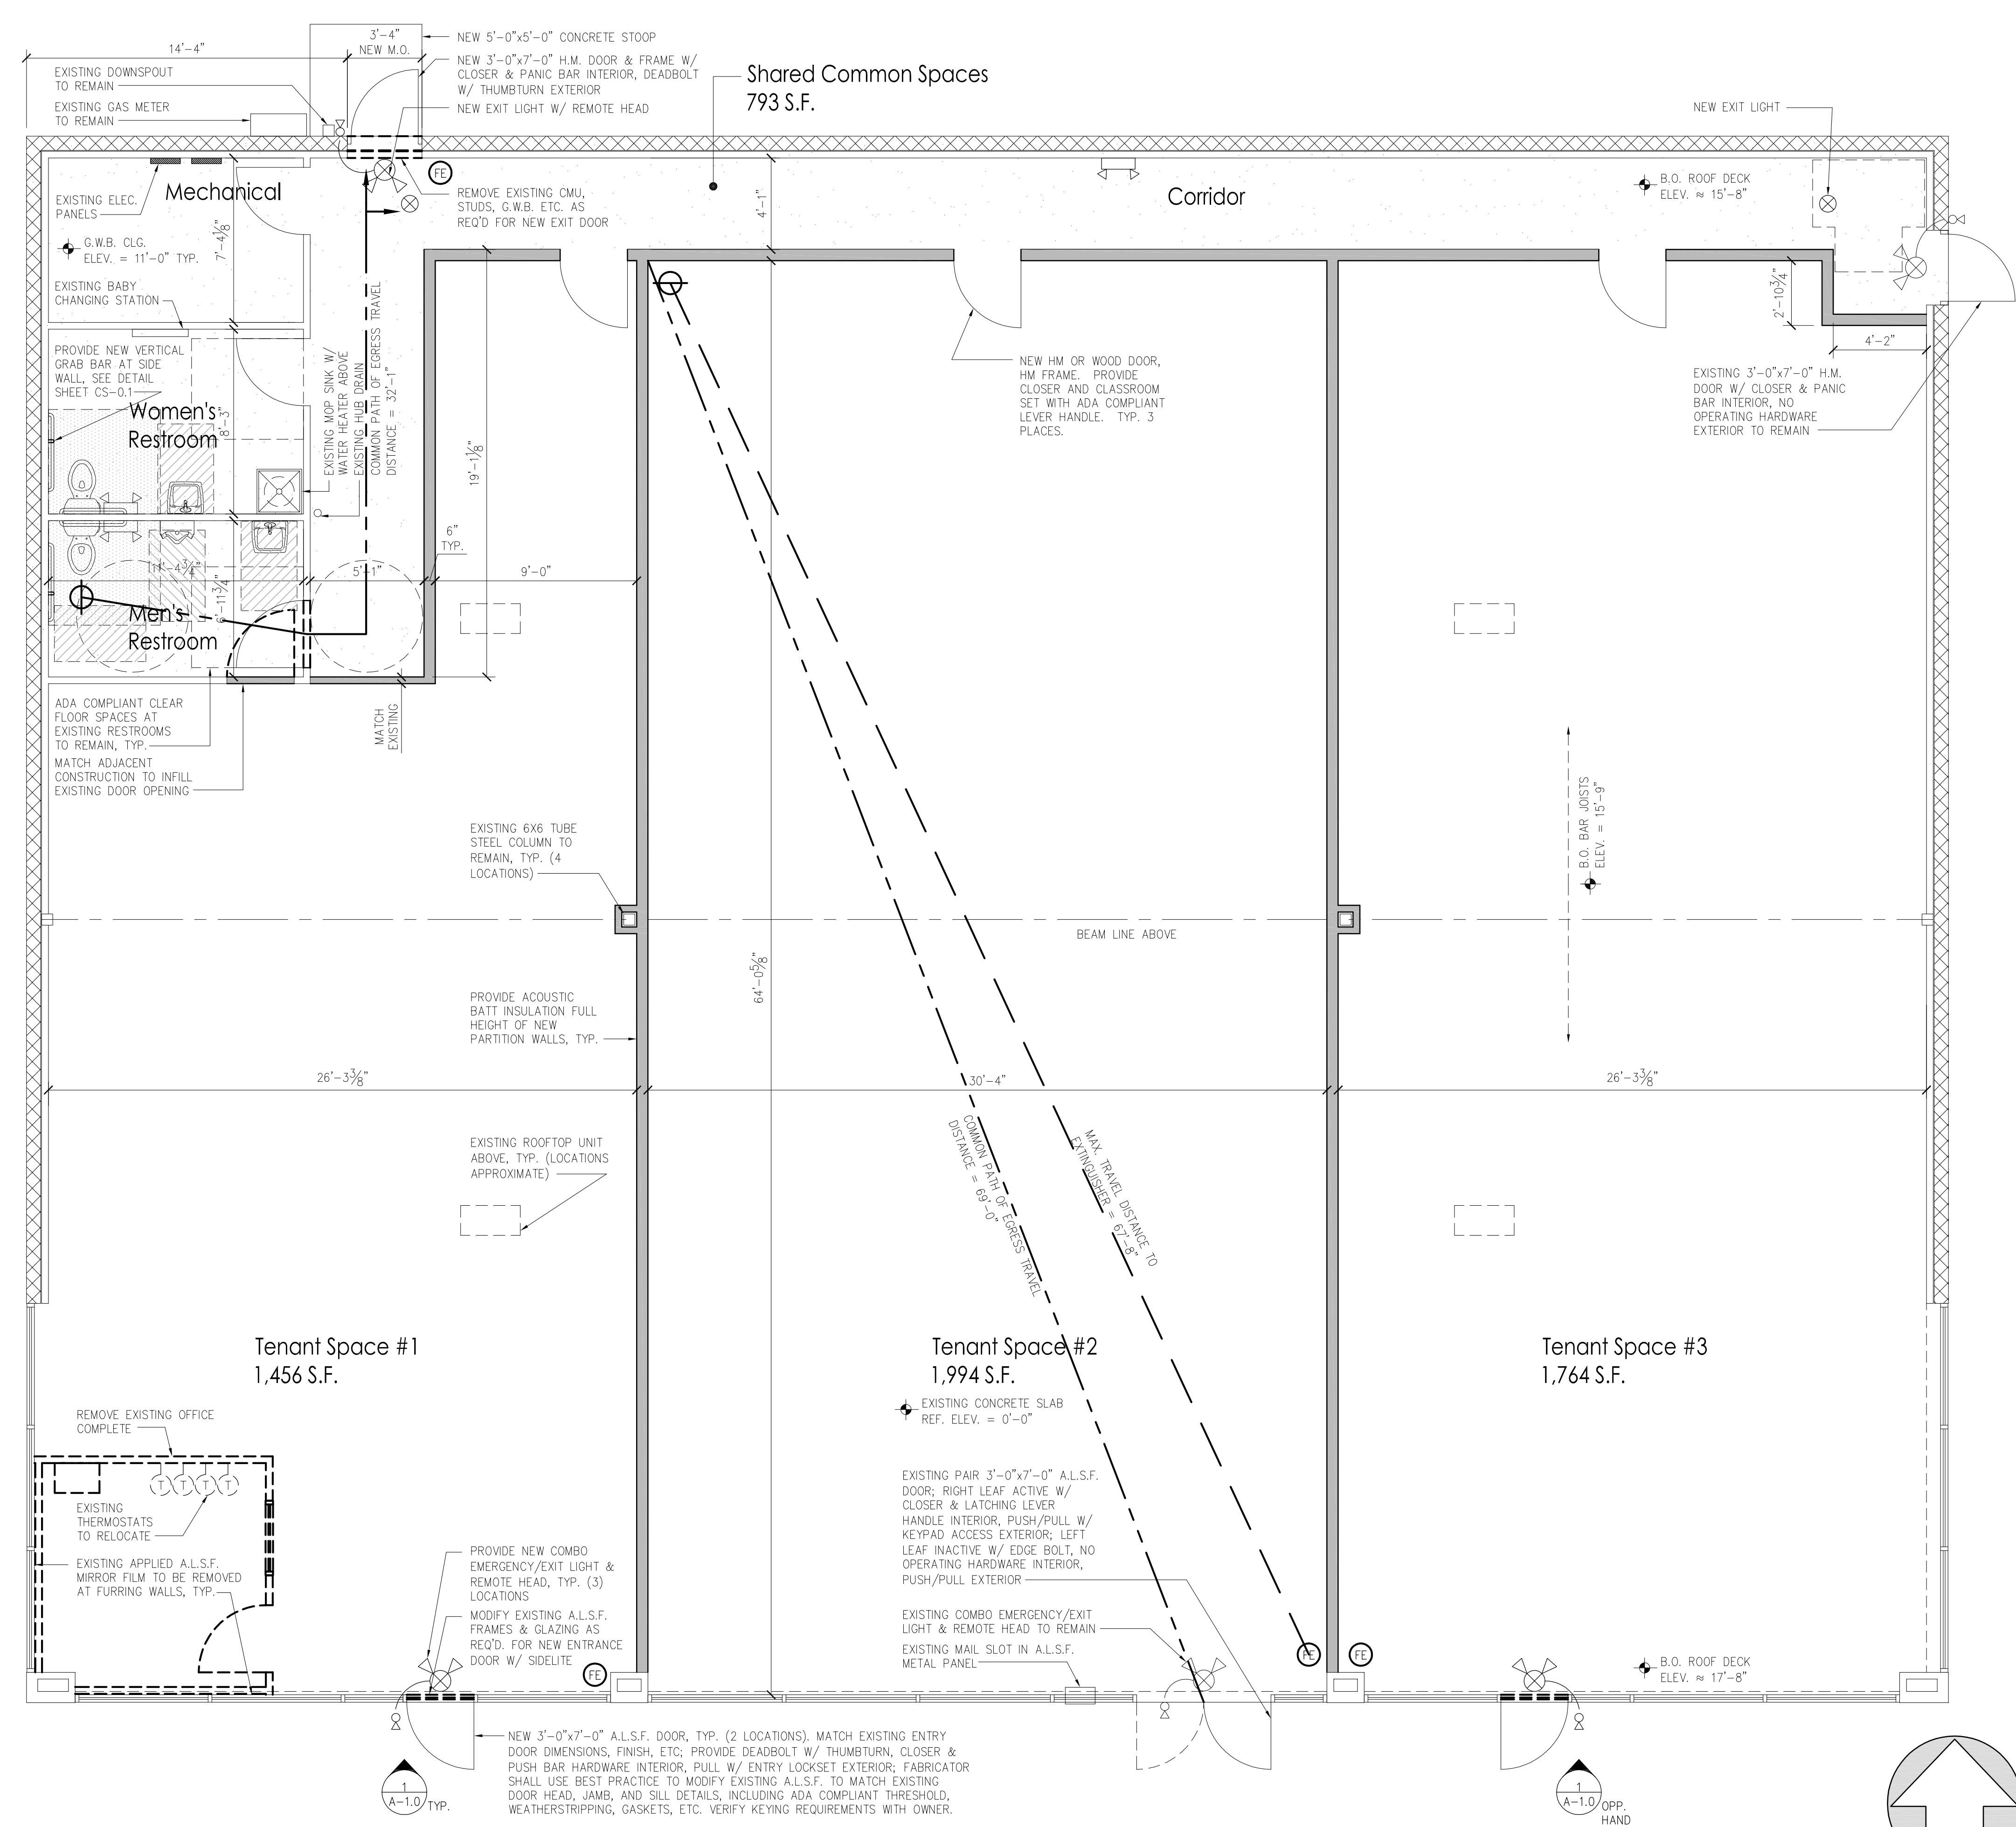
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 DRAWN BY: EAS

DRAWINGS FOR:  
**1391 Morgantown Road**  
 Fit-Up for Tenant Demising Walls  
 Bowling Green, Kentucky



SHEET TITLE:  
**Floor Plan & Details**

PROJECT NUMBER: 2305-1048  
 FILENAME:  
 SCALE: AS NOTED  
 PLOT DATE: 07-17-23  
 DRAWN BY: EAS

SHEET:  
**A-1.0**



- GENERAL NOTES:**
- DO NOT SCALE DRAWINGS. WRITTEN DIMENSIONS TAKE PRECEDENCE OVER SCALED DIMENSIONS.
  - ALL NEW INTERIOR STUD PARTITIONS ARE 6" LGM U.N.O. AND SHALL EXTEND FULL HEIGHT TO B.O. ROOF DECK, TYP. PROVIDE ACOUSTIC BATT INSULATION TO COMPLETELY FILL STUD CAVITIES.
  - ALL INTERIOR DIMENSIONS ARE FROM F.O. STUD AT NEW PARTITIONS AND F.O. EXISTING G.W.B. OR OTHER FINISHED MATERIAL AT EXISTING PERIMETER PARTITIONS U.N.O. SEE SHEET CS-0.1 FOR ACCESSIBLE CLEARANCES AND DIMENSIONS AT RESTROOM ACCESSORIES AND DOOR SWINGS.
  - CONTRACTOR SHALL PROVIDE IN-WALL BLOCKING FOR ALL WALL MOUNTED ACCESSORIES.
  - ALL EXPOSED CORNERS AND EDGES OF GYPSUM WALL BOARD SHALL BE FINISHED WITH CORNER BEAD OR J-BEAD, RESPECTIVELY.
  - CONTRACTOR SHALL VERIFY ALL ROUGH OPENING SIZES FOR NEW DOORS.
  - WHERE THE WORD "PROVIDE" IS USED, IT IS INTENDED THAT THE CONTRACTOR PROVIDE ALL NECESSARY PARTS AND ACCESSORIES AND A COMPLETE, PROPER INSTALLATION U.N.O.
  - G.C. SHALL FIELD VERIFY ALL EXISTING CONDITIONS. CONDITIONS FOUND TO BE IN CONFLICT WITH THE SCOPE DOCUMENTS SHALL BE REPORTED TO THE OWNER IMMEDIATELY.
  - ITEMS REQUIRING FINISH SELECTIONS THAT DO NOT APPEAR IN THIS DOCUMENT SHALL BE SELECTED BY OWNER OR OWNER'S REPRESENTATIVE(S) FROM SHOP DRAWINGS, SUBMITTALS, AND/OR SAMPLES AS REQUIRED.
  - ALL NEW DOOR HARDWARE SHALL BE ADA COMPLIANT.

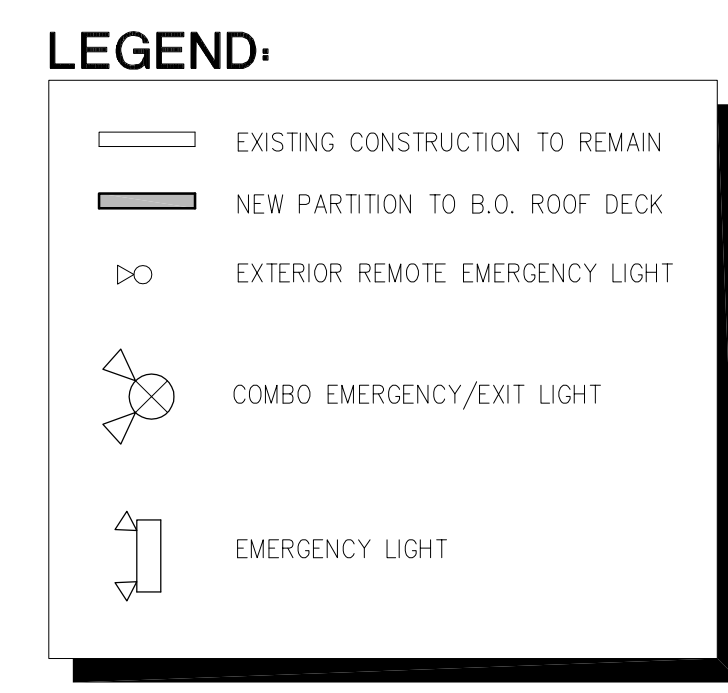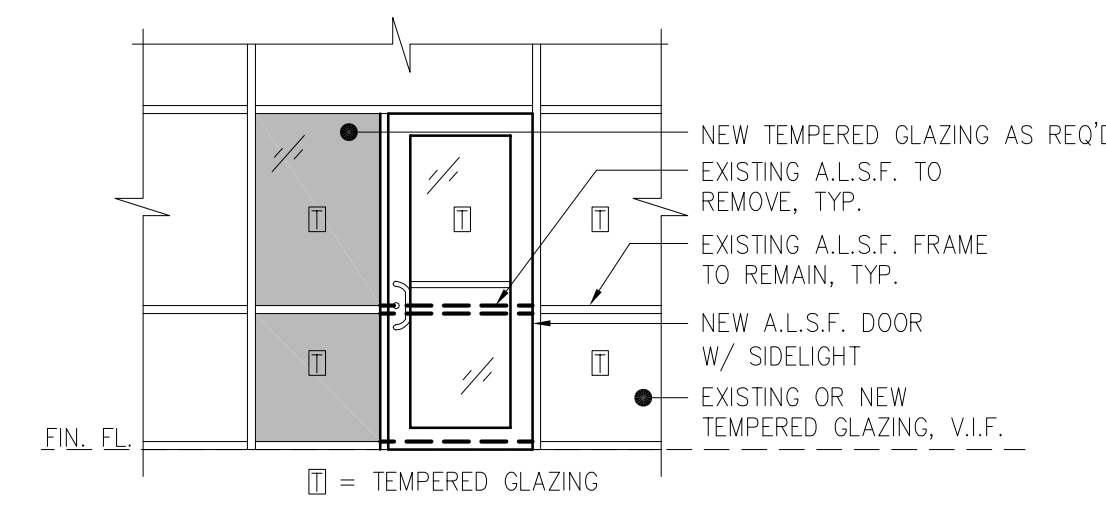

**A FLOOR PLAN**  
 A-1.0 SCALE: 1/4" = 1'-0"

