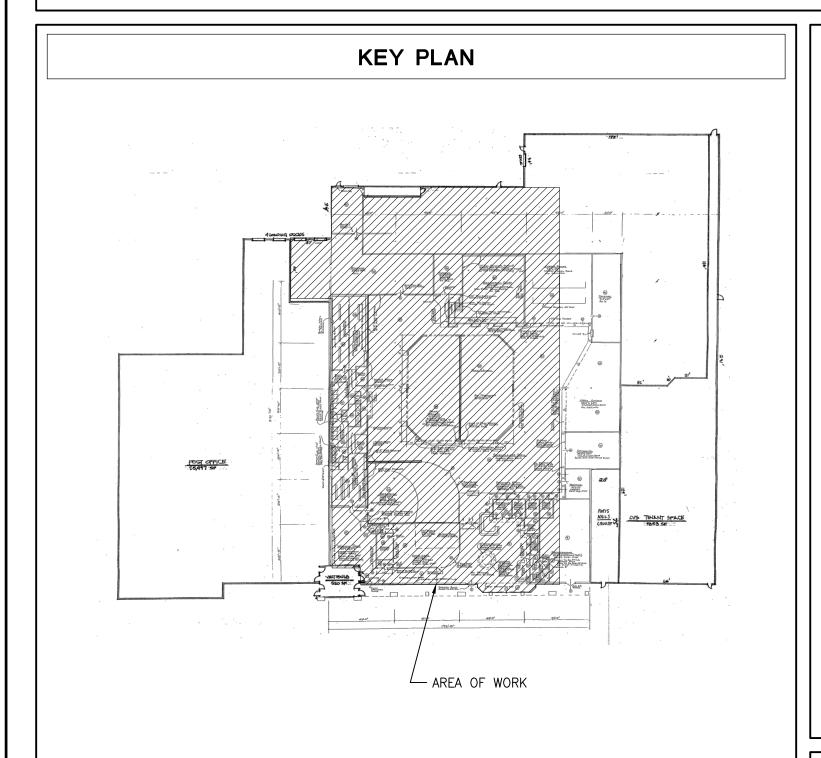
TENANT FINISH

BARGAIN HUNT

3137 DIXIE HIGHWAY

ERLANGER, KY 41018



CODE INFORMATION PROJECT DESCRIPTION **RENOVATION** PROJECT SQUARE FOOTAGE **TENANT AREA** BUILDING CODE **KENTUCKY BUILDING CODE 2013** USE CLASSIFICATION EXISTING: A-2, ASSEMBLY (GYM) PROPOSED: M, MERCANTILE CONSTRUCTION CLASSIFICATION CONSTRUCTION TYPE IIB **BUILDING IS 100% SPRINKLERED**


EXISTING CONDITIONS

G001 3/4° - 1'-0°

PROJECT TEAM ARCHITECT: HUB + WEBER ARCHITECTS, PLC 200 WEST PIKE STREET COVINGTON, KENTUCKY 41011 (859) 491-3844 FAX: (859) 655-3243 STRUCTURAL ENGINEER

GOP LIMITED 644 LINN STREET, SUITE 936 CINCINNATI, OHIO 45203 (513) 621-7073 FAX: (513) 621-0434

	DRAWING INDEX		
CURRENT <u>DATE</u>	SHEET NUMBER	SHEET DESCRIPTION	
4.11.2016 4.11.2016	G001 G002	COVER SHEET STANDARDS	
4.11.2016	A101	FLOOR PLAN	
4.11.2016	S101	FOUNDATION PLAN	

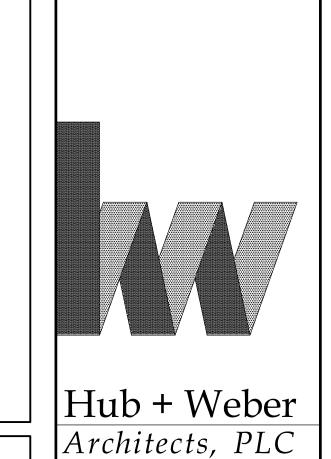

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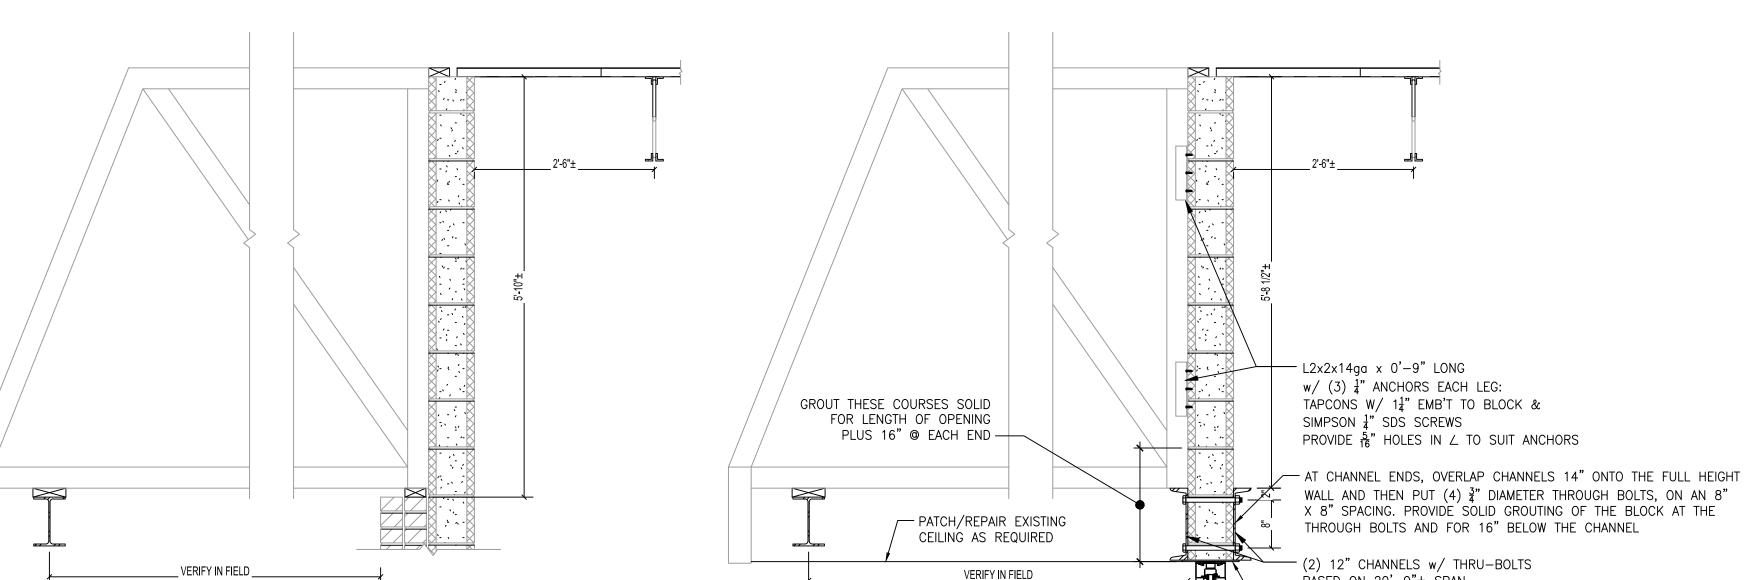
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COVER SHEET

G001

VICINITY MAP

_VERIFY IN FIELD _ BASED ON 20'-0"± SPAN PROPOSED NEW LINTEL SECTION AT NEW LINTEL

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ELEV 100'-0"

ROOM

101

DRINKING FOUNTAIN

SPOT ELEVATION

ROOM NAME

ROOM NUMBER

DOOR NUMBER

SECTION NUMBER

ELEVATION NUMBER

SHEET NUMBER

DETAIL NUMBER

SHEET NUMBER

PARTITION TYPE

REVISION

SHEET NUMBER

SYMBOLS

STANDARD

URINAL

RECESSED

PAPER TOWEL DISPENSER AND WASTE RECEPTACLE

PAPER TOWEL DISPENSER

AND WASTE RECEPTACLE

HAND DRYER

PAPER TOWEL

DISPENSER

NAPKIN/

TAMPON VEŃDORS NAPKIN DISPOSAL

SANITARY

TOILET PAPER

DISPENSER

SOAP

DISPENSER

MATERIALS

EARTH

CONCRETE

GRANULAR FILL

FACE BRICK

STONE

STEEL

PLYWOOD

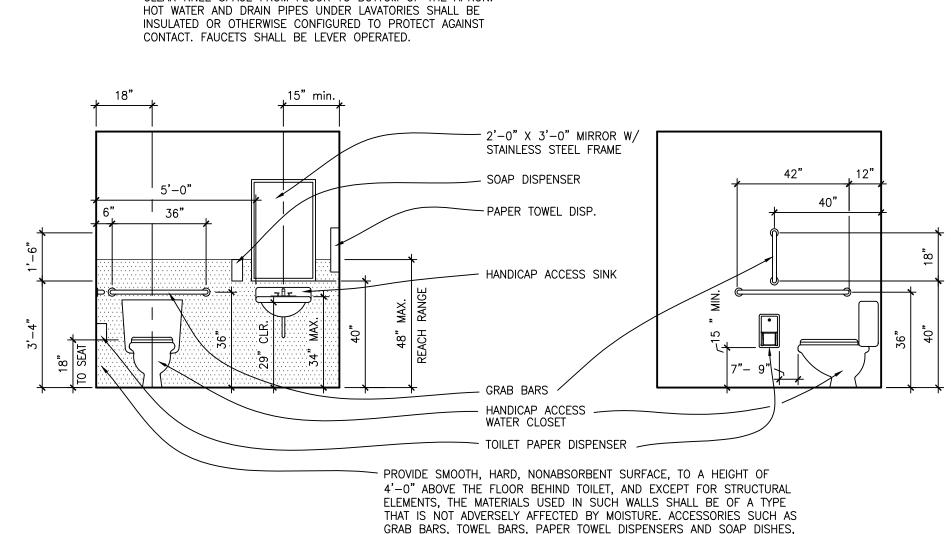
FINISH WOOD

RIGID INSULATION

BATT INSULATION

GYPSUM BOARD

CONRETE MASONRY UNITS



STRUCTURAL ELEMENTS FROM MOISTURE.

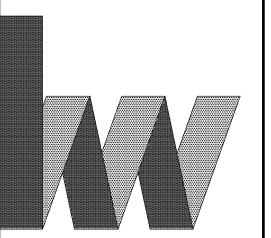
PROVIDED ON THE WALLS SHALL BE INSTALLED AND SEALED TO PROTECT

ABBREVIATIONS A/C ACT ADD MAXAIR CONDITIONING MAXIMUM ACOUSTIC CEILING TILE MANHOLE ADDENDUM MINIMUM AFF ABOVE FINISH FLOOR MASONRY OPENING ALT AP ALTERNATE ACCESS PANEL NORTH NOT IN CONTRACT BENCH MARK NO. OR # NUMBER BID PACKAGE NOM NOMINAL NOISE REDUCTION COEFFICIENT BOTH SIDES NRC BOTH WAYS BOTTOM OF OUTSIDE DIAMETER OWNER FURNISHED, CONTRACTOR INSTALLED CATCH BASIN CERAMIC TILE OPPOSITE HAND CONTROL JOINT PERCENT C/C CLG CENTER TO CENTER PLASTIC LAMINATE PLAM CEILING PLUS OR MINUS CONCRETE MASONRY UNIT CMU POUNDS PER SQUARE INCH POUNDS PER SQUARE FOOT CONC CONCRETE CONT CPT CONTINUOUS CARPET QUARRY TILE RADIUS OR RISER DRINKING FOUNTAIN ROOF DRAIN DN DOWN REQUIRED EACH SANITARY SEWER EXTERIOR INSULATION FINISH SYSTEM EIFS SOLID CORE WOOD DOOR EACH FACE SQUARE FEET EXPANSION JOINT SIM EL ELEC ELEVATION SOUND TRANSMISSION COEFFICIENT **ELECTRIC** STORM SEWER ELEV ELEVATOR SHEET VINYL EQUAL EACH WAY ELECTRIC WATER COOLER TOP OF EXP EXPOSED TOP OF MASONRY TOP OF CONCRETE **EXISTING** EXTG TOP OF FOOTING FLOOR DRAIN TUBE STEEL TOP OF STEEL FIRE EXTINGUISHER FIRE EXTINGUISHER CABINET FURNITURE, FIXTURES, & EQUIPMENT TYPICAL TOP SET VINYL WALL BASE FIRE HYDRANT FΗ UNDERCOUNTER UNIT HEATER GAGE OR GAUGE UNLESS OTHERWISE INDICATED UNO GROUND FAULT INTERRUPTOR GFI VINYL COMPOSITION TILE GLASS MASONRY UNIT VINYL WALL COVERING GYP BD GYPSUM BOARD WEST, WIDE HOSE BIBB WOOD BASE HDW HARDWARE WOOD HOLLOW METAL W/O WITHOUT HOLLOW CORE WOOD DOOR HCWD WORKING POINT HIGH POINT WELDED WIRE FABRIC YARD DRAIN HEATING, VENTILATION, AND AIR CONDITIONING HOSE VALVE CABINET HVEC HOSE VALVE AND EXTINGUISHER CABINET INSIDE DIAMETER INV INVERT LBS POUNDS LIVE LOAD LONG LEG HORIZONTAL LONG LEG VERTICAL LLV L/P LOW POINT

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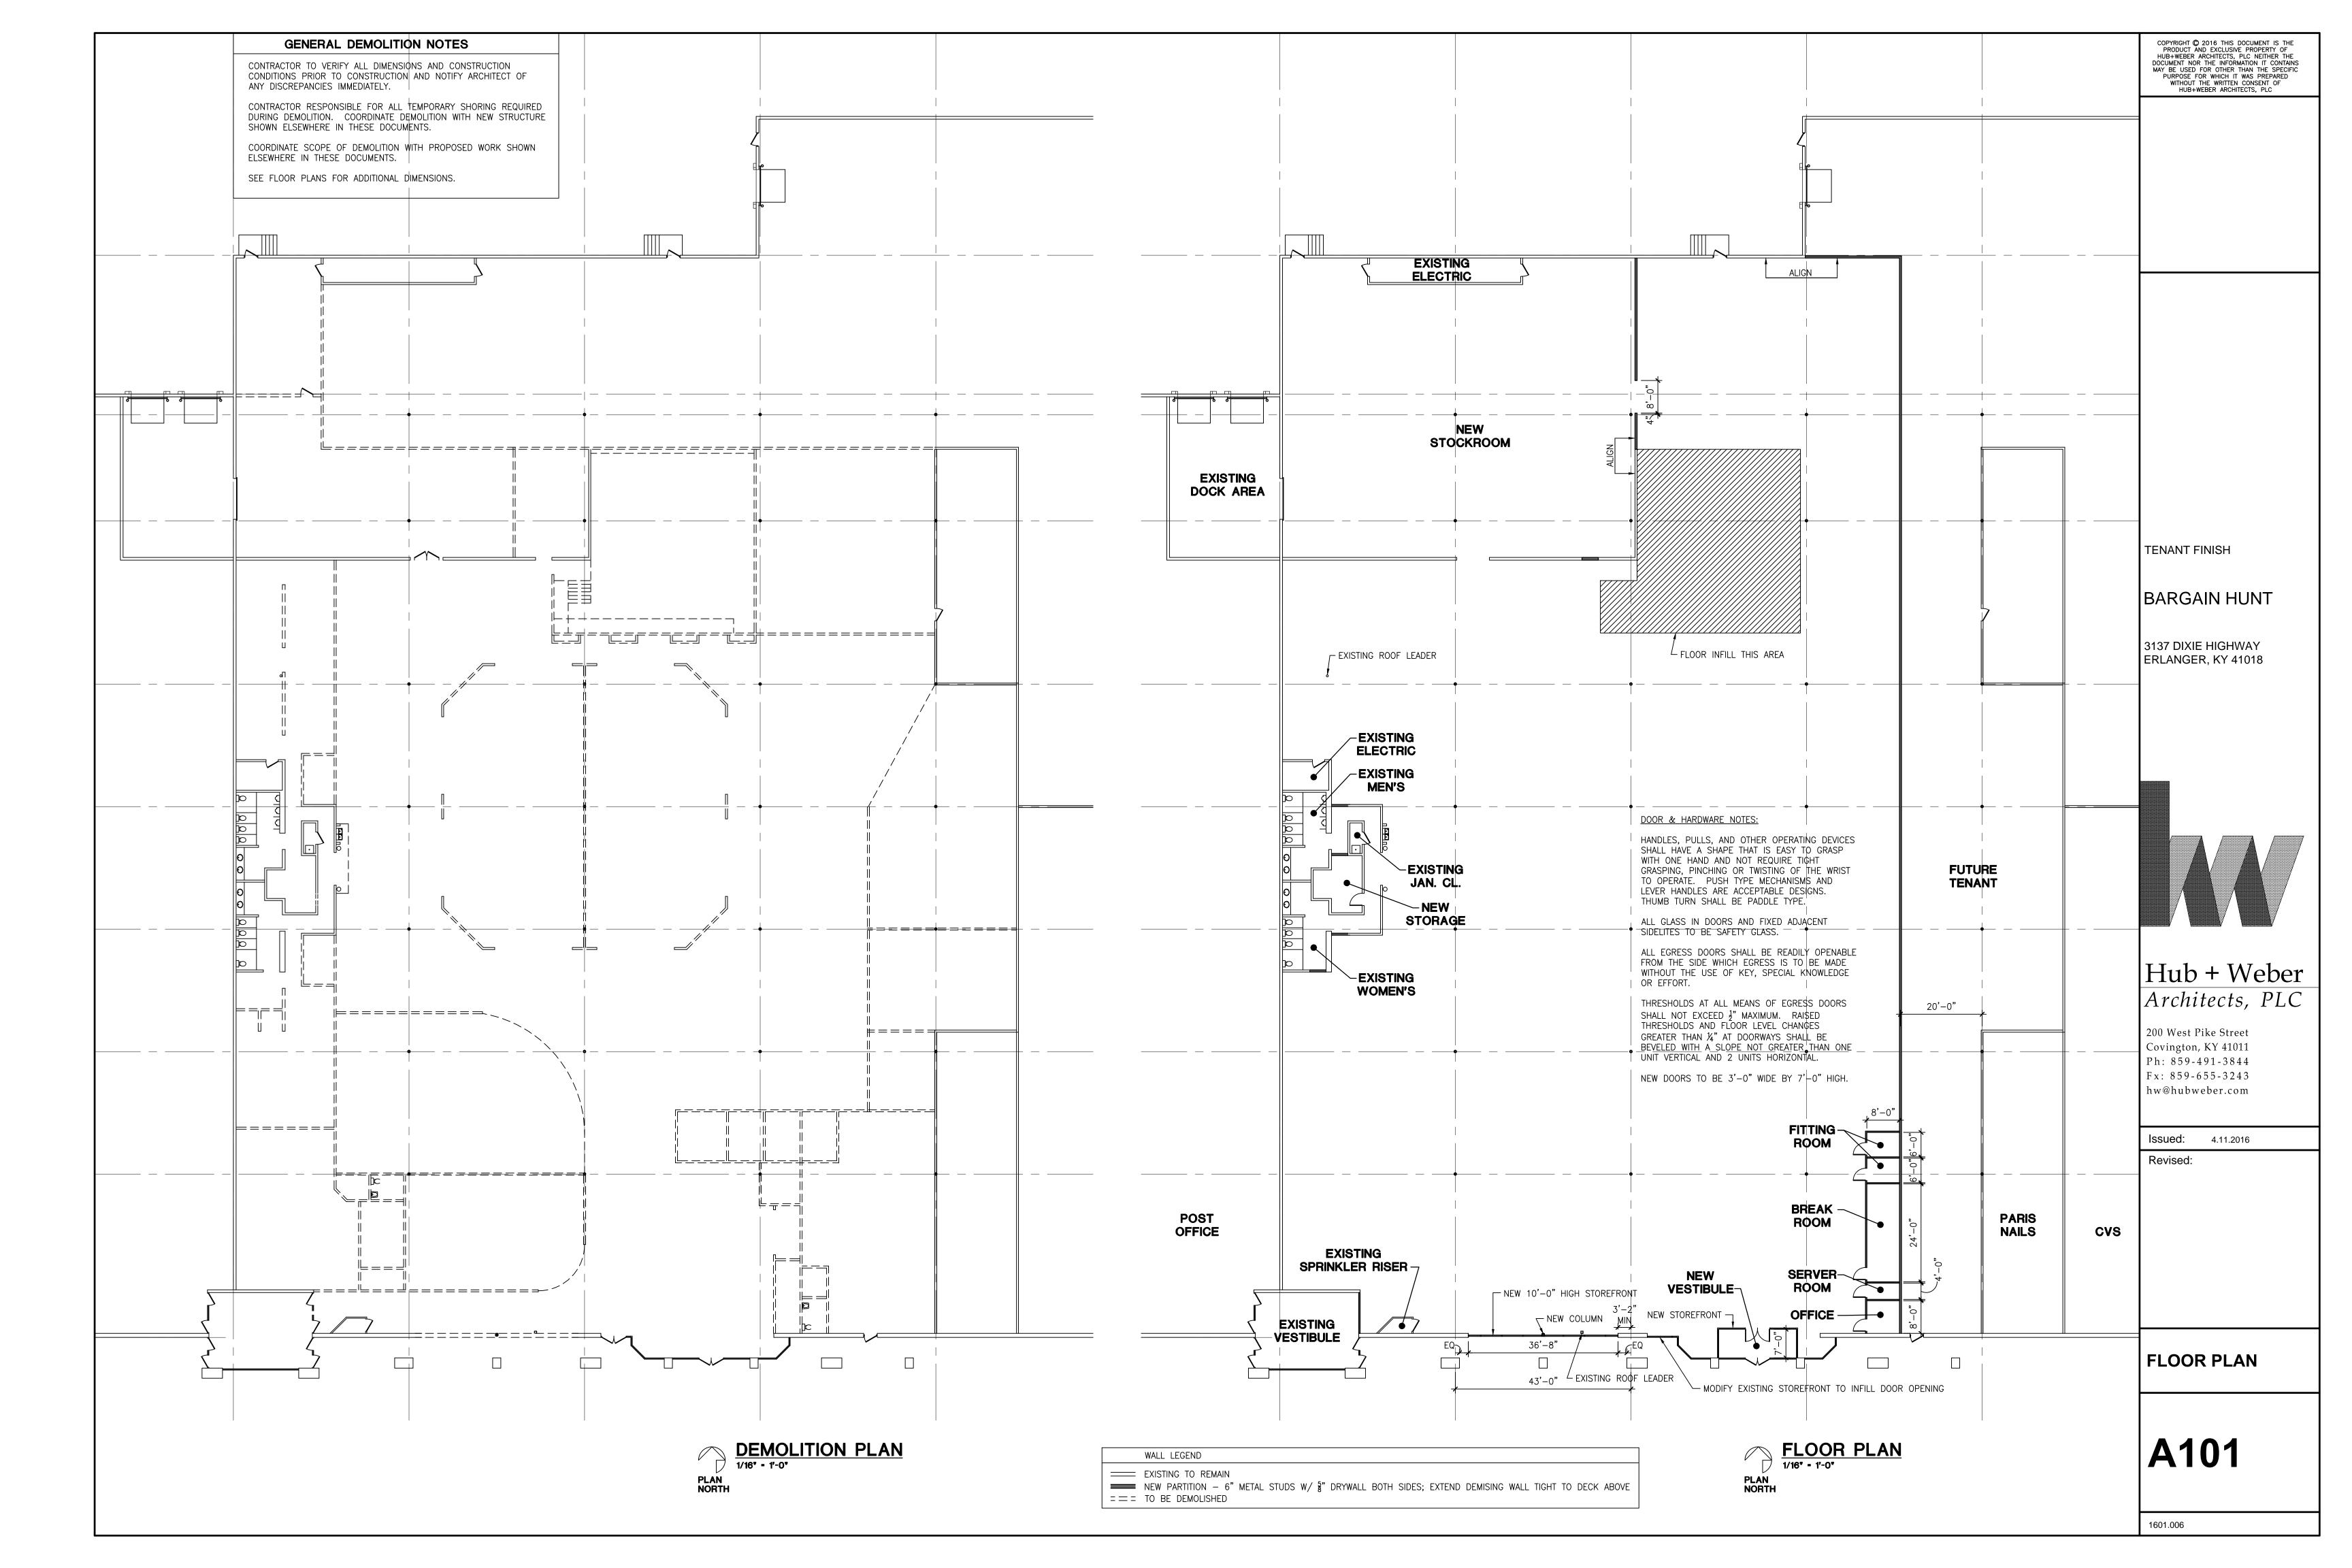
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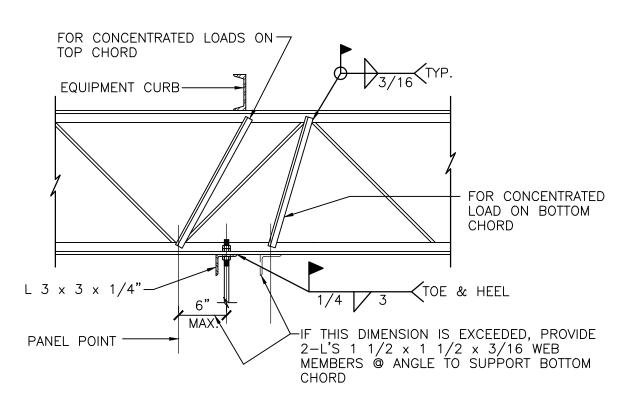
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STANDARDS


G002

1601.006





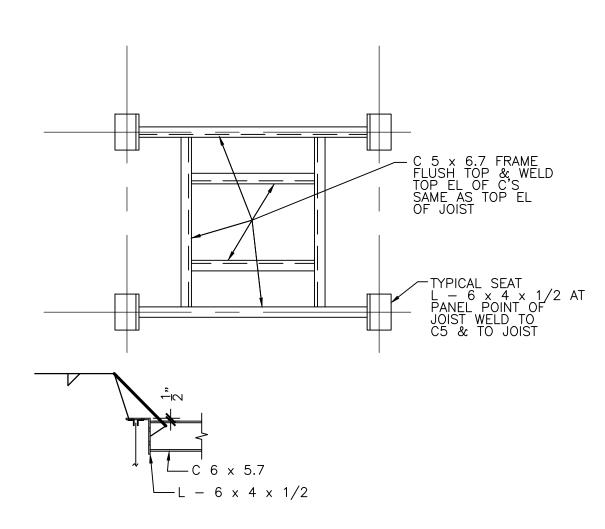TYPICAL REINFORCEMENT OF JOIST FOR CONCENTRATED LOAD NOT AT PANEL POINT SCALE: 3/4"=1'-0"




TYPICAL ROOF FRAMING OPENING DETAIL

ROOF OPENING NOTES:


1. REINFORCE DECK AROUND OPENINGS LESS THAN 15 INCHES IN ANY DIMENSION WITH MINIMUM TWENTY (20) GAUGE GALV STEEL SHEET AT LEAST 12 INCHES WIDER AND LONGER THAN THE OPENING PLACED OVER THE OPENING AND FASTEN TO THE TOP OF THE DECK AT EACH CORNER AND 6 INCHES C/C ALONG EACH SIDE.

2. WHERE DECK OPENINGS ARE FROM 15 INCHES WIDE TO 30 INCHES WIDE AND ARE NOT SUPPORTED BY STRUCTURAL MEMBERS, PROVIDE AND WELD 1x1x1/4 INCH STEEL ANGLE TO THE UNDERSIDE OF THE DECK AT RIGHT ANGLES TO RIBS. EXTEND ANGLE TO THREE (3) RIBS BEYOND EACH SIDE OF THE OPENINGS, WELD TO THE BOTTOM OF EACH RIB. REINFORCE THE OPENING SIDE PARALLEL TO RIBS WITH MINIMUM TWENTY (20) GAUGE GALV STEEL SHEET 12 INCHES WIDE, WELDED AT EACH CORNER AND 6 INCHES C/C ALONG EACH SIDE. SIDE REINFORCING MAY BE OMITTED WHEN A ROOF SUMP PAN IS TO BE INSTALLED OVER THE OPENING.

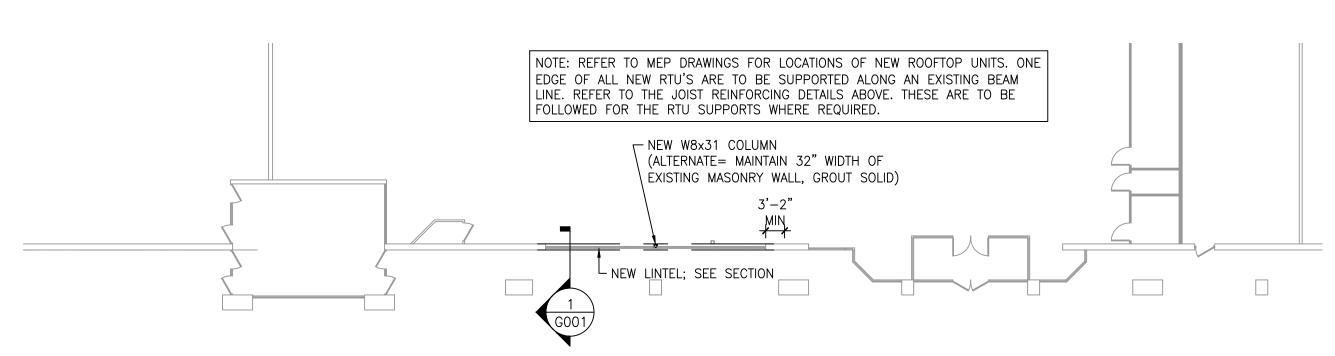ALL OTHER ROOF OPENINGS SHALL BE FRAMED AS SHOWN ON THIS SHEET.



PLAN NORTH

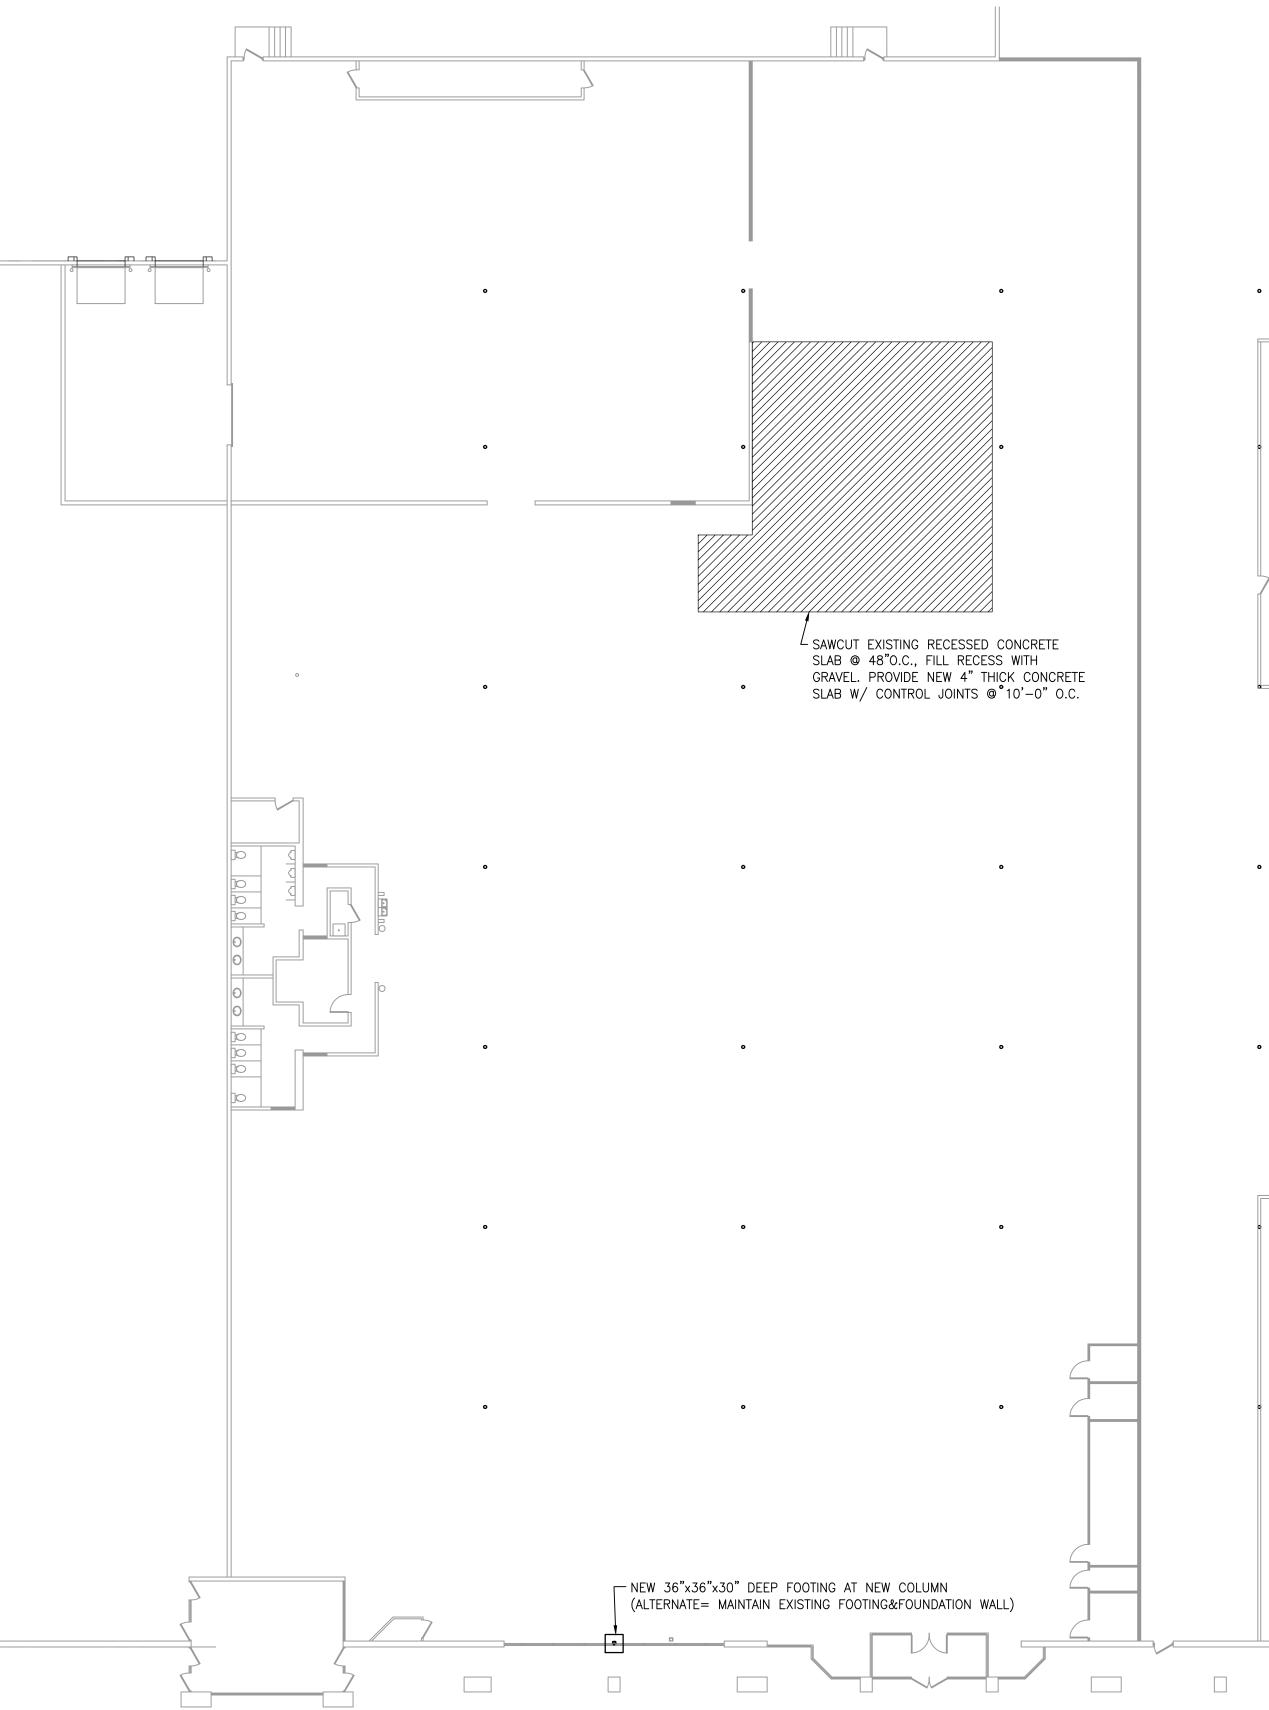


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STRUCTURAL PLANS

S101

1601.006

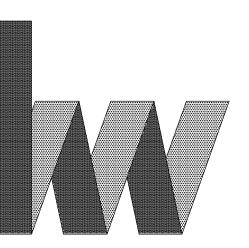FOUNDATION PLAN
1/16* - 1'-0*

PLAN NORTH