



KEYNOTES	
A	PIPE BOLLARD, TYPICAL, SEE DETAIL SHEET A102.
B	DESIGNATES EDGE OF ROOF CANOPY OR ROOF OVERHANGS, TYPICAL.
C	DOOR NUMBER TYPICAL, SEE DOOR SCHEDULE, SHEET A601.
D	WINDOW NUMBER TYPICAL, SEE WINDOW SCHEDULE, SHEET A601.
E	STEEL LINER PANEL WALL - SEE METAL BUILDING MANUFACTURERS SHOP DRAWINGS.

FLOOR PLAN
 SCALE: 1/16"=1'-0"


REV	DESCRIPTION	BY	DATE				
							
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CRUISER LAMINATION	HOME IN. 46746						
GDR CONSTRUCTION	GOSSEN IN. 46528						
FLOOR PLAN							
DESIGNED BY:	RJT						
REVIEWED BY:	JLM						
DRAWN BY:	JAA						
DATE:	FEBRUARY 2018						
JOB NUMBER:	2017-0374						
SCALE:	AS NOTED						
A101							

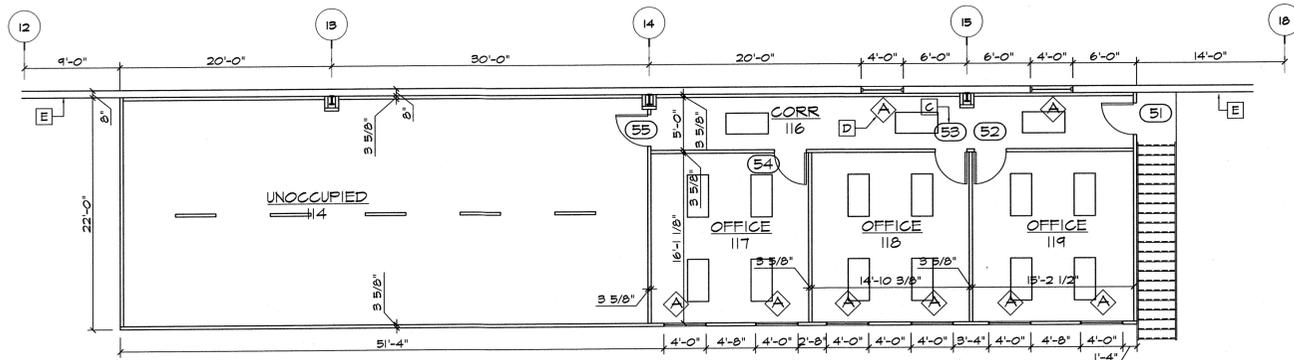


SECOND FLOOR OFFICE PLAN
SCALE: 1/8"=1'-0"

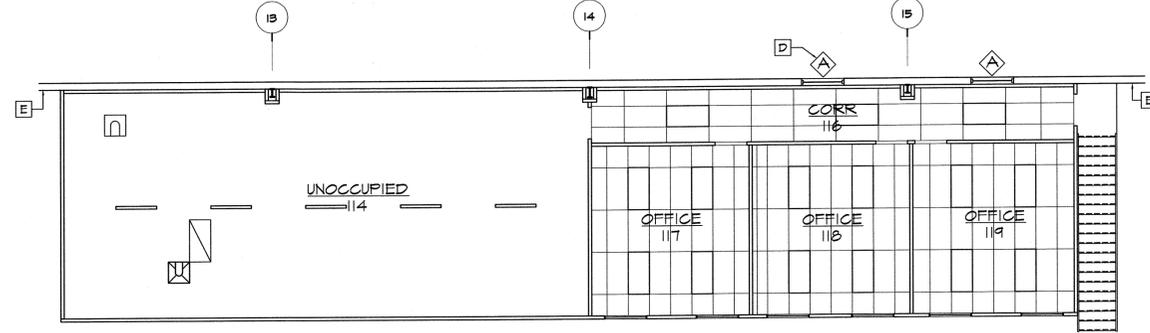


SECOND FLOOR OFFICE REFLECTIVE CEILING
SCALE: 1/8"=1'-0"

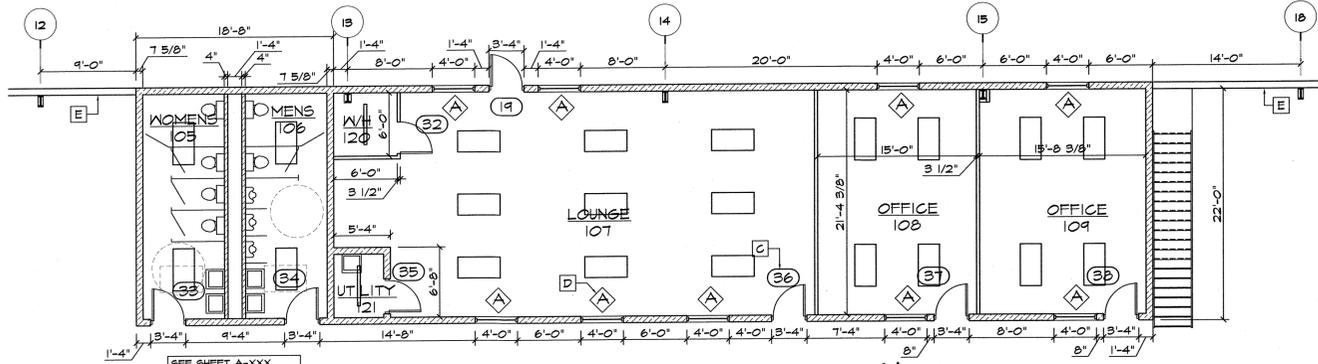


FIRST FLOOR OFFICE PLAN
SCALE: 1/8"=1'-0"

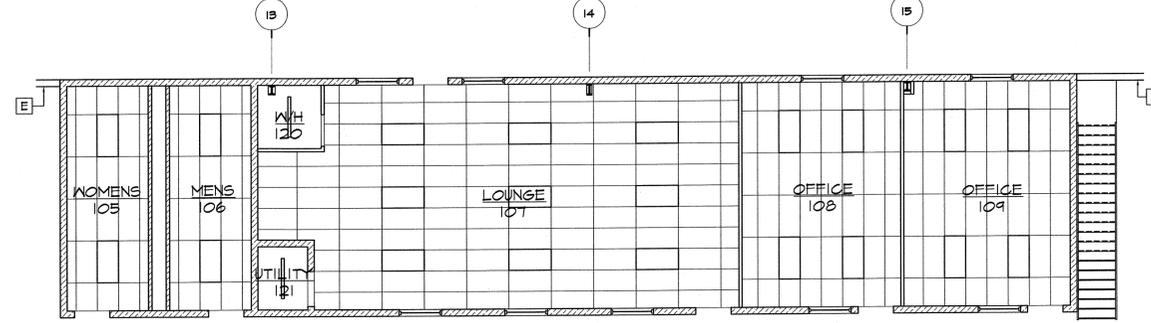

FIRST FLOOR OFFICE REFLECTIVE CEILING
SCALE: 1/8"=1'-0"

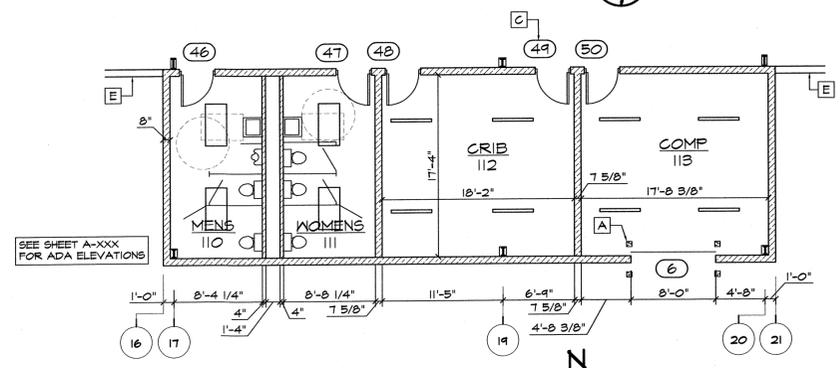

WEST RESTROOM PLAN
SCALE: 1/8"=1'-0"

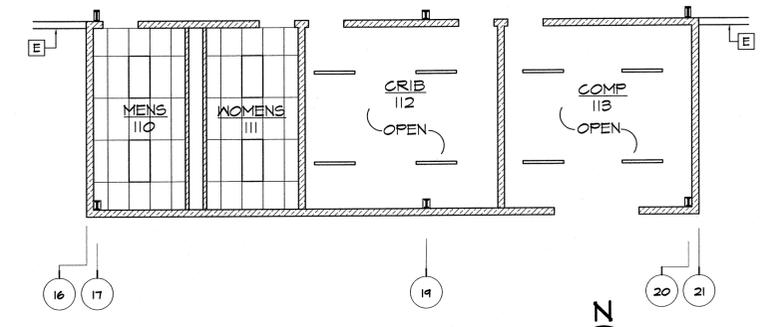

WEST RESTROOM REFLECTIVE CEILING
SCALE: 1/8"=1'-0"

KEYNOTES

- A PIPE BOLLARD, TYPICAL; SEE DETAIL SHEET A501.
- B DESIGNATES EDGE OF ROOF CANOPY OR ROOF OVERHANG, TYPICAL.
- C DOOR NUMBER TYPICAL, SEE DOOR SCHEDULE, SHEET A601.
- D WINDOW NUMBER TYPICAL, SEE WINDOW SCHEDULE, SHEET A601.
- E STEEL LINER PANEL WALL - SEE METAL BUILDING MANUFACTURERS SHOP DRAWINGS.

REV	DESCRIPTION	BY	DATE




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P. 302.742.321




DESIGNED BY: RJT
REVIEWED BY: JLM
DRAWN BY: JAA
DATE: FEBRUARY 2018
JOB NUMBER: 2017-0374
SCALE: AS NOTED


CRUISER LAMINATION
GDR CONSTRUCTION
ENLARGED FLOOR PLANS
A103

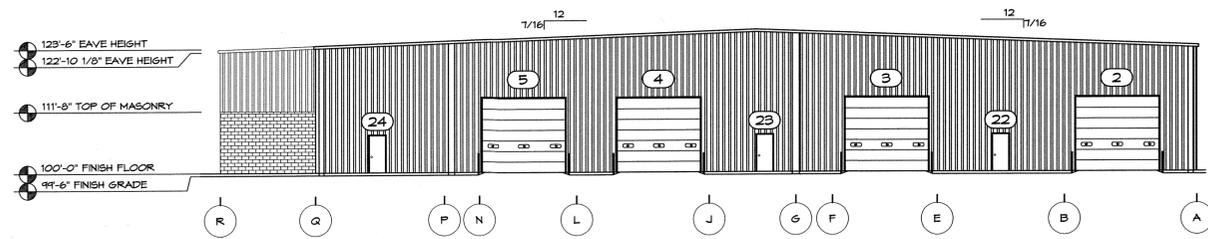


1 EAST ELEVATION
A201 SCALE: 1/16"=1'-0"

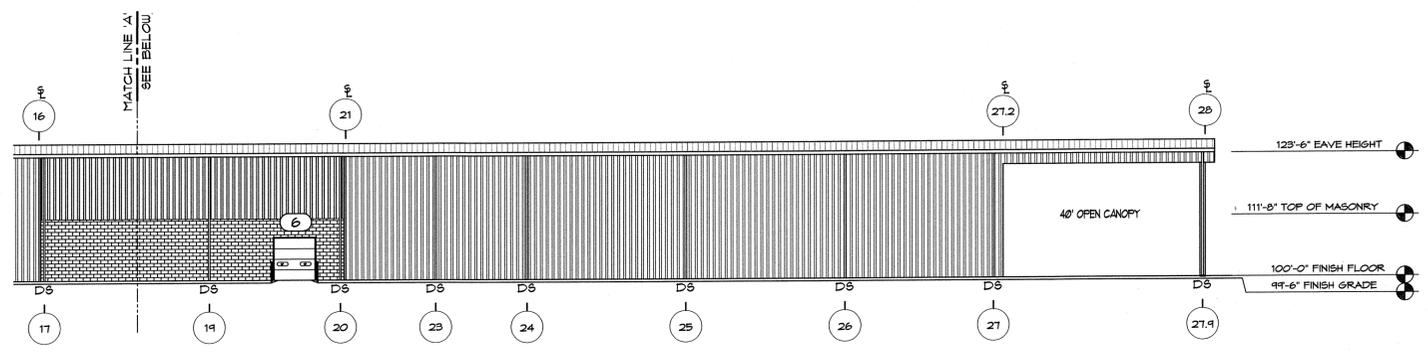


2 NORTH ELEVATION
A201 SCALE: 1/16"=1'-0"

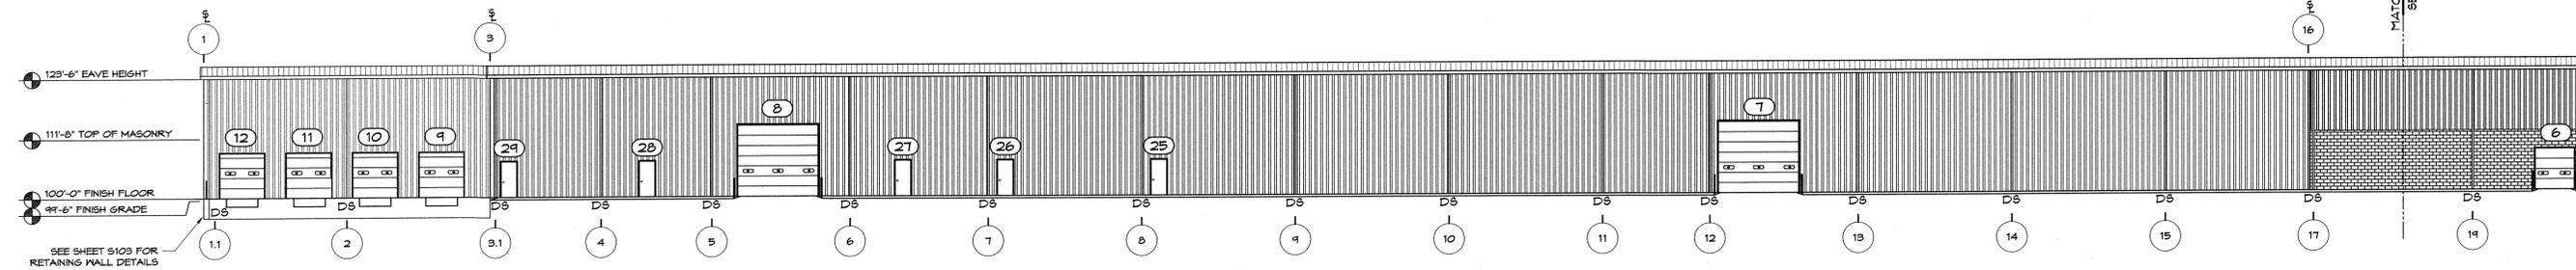

3 WEST ELEVATION
A201 SCALE: 1/16"=1'-0"

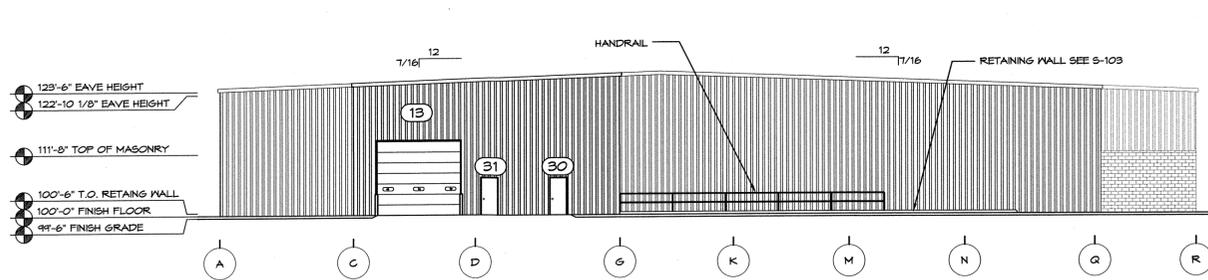

4 SOUTH ELEVATION
A201 SCALE: 1/16"=1'-0"

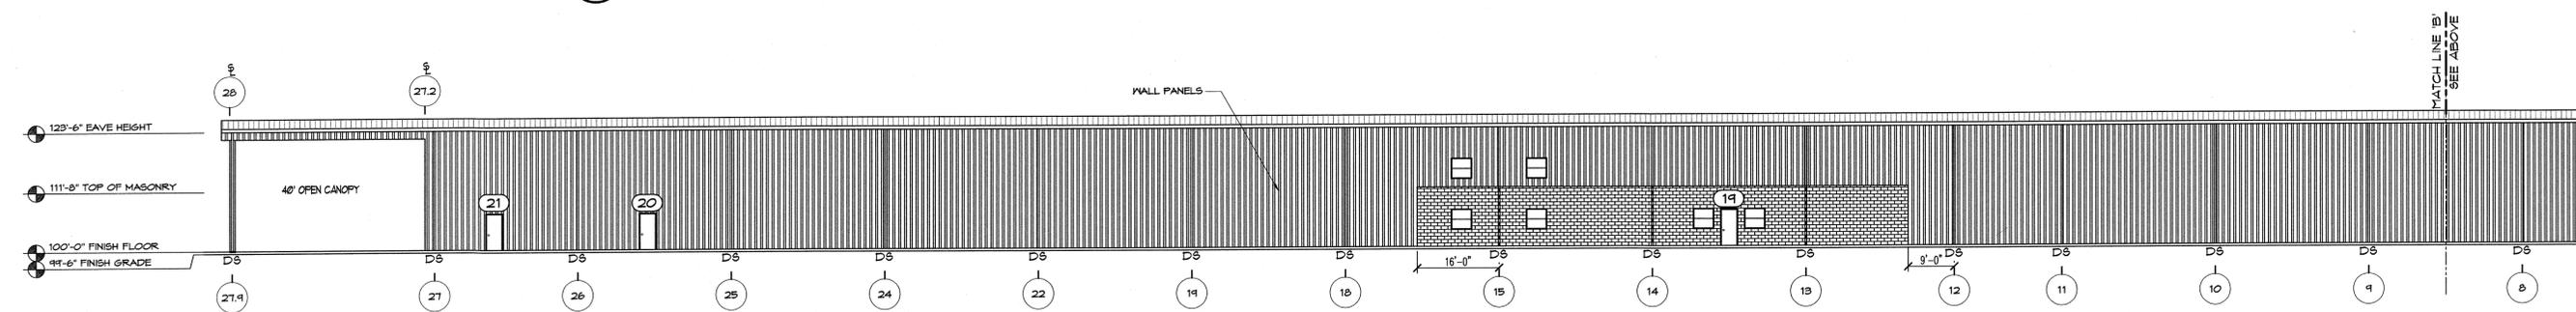

REV	DESCRIPTION	BY	DATE




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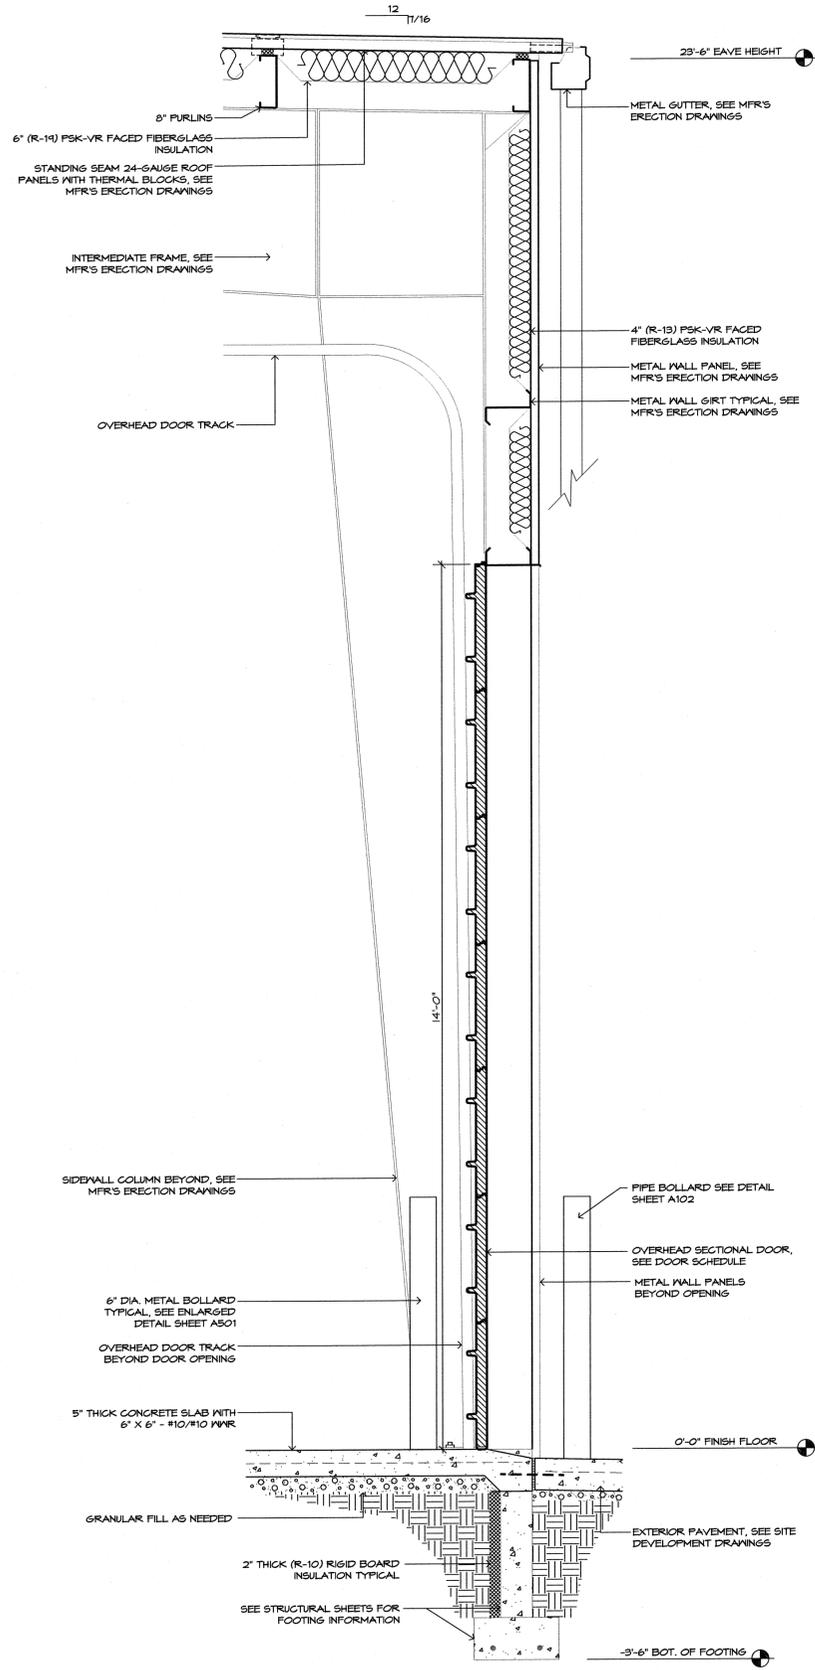
DESIGNED BY: HOVE IN 467146
 REVIEWED BY: RJT
 DRAWN BY: JLL
 DATE: FEBRUARY 2018
 JOB NUMBER: 2017-0374
 SCALE: AS NOTED

CRUISER LAMINATION
CDR CONSTRUCTION
 EXTERIOR ELEVATIONS


A201



1 WALL SECTION TYP.
SCALE: 3/4"=1'-0"

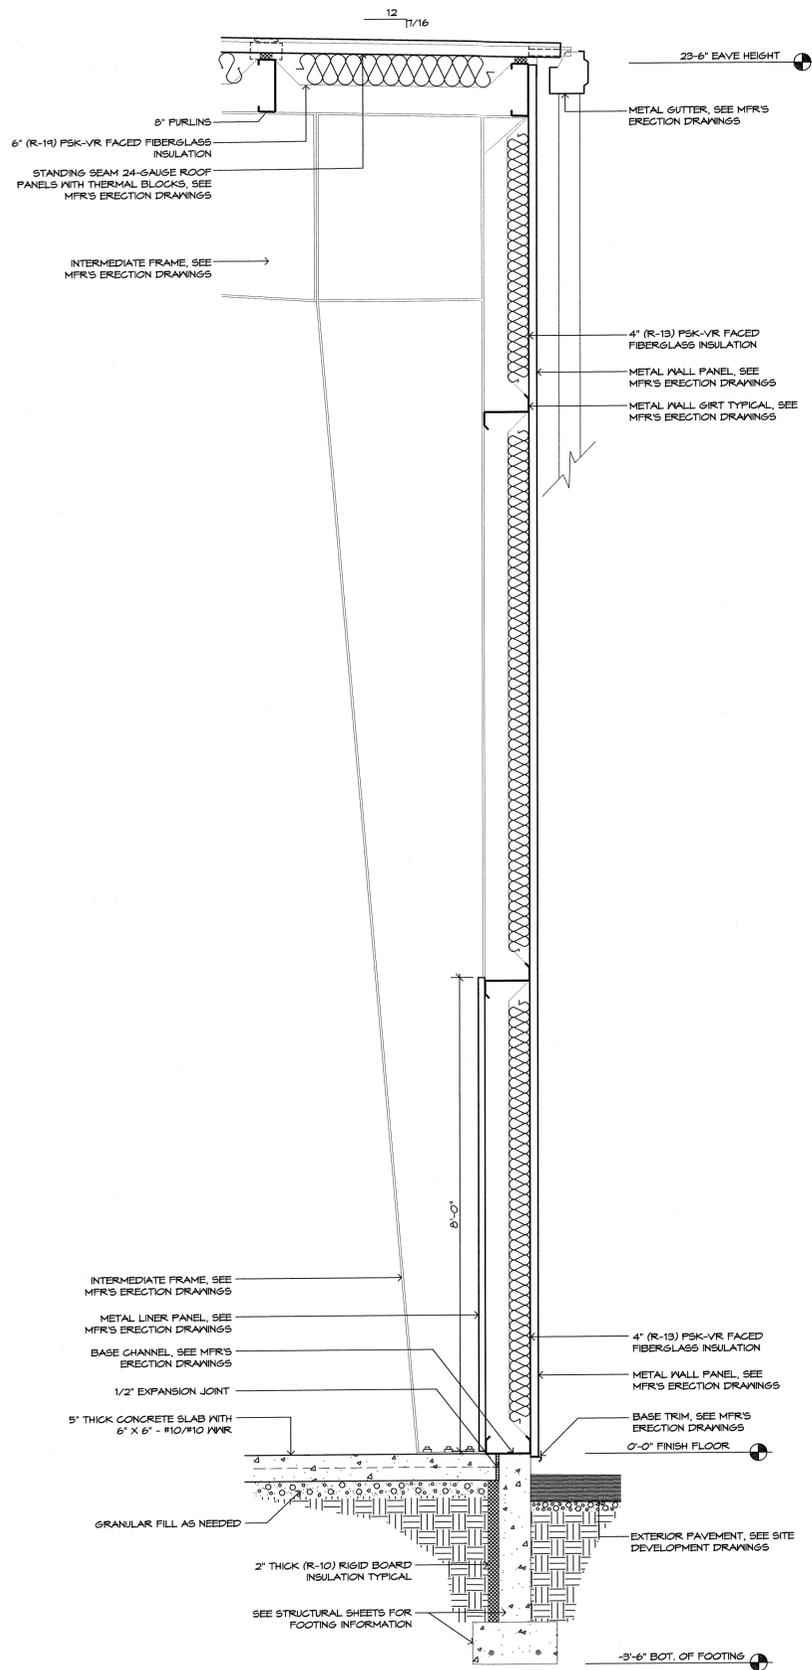


2 WALL SECTION @ O.H. DOOR
SCALE: 3/4"=1'-0"

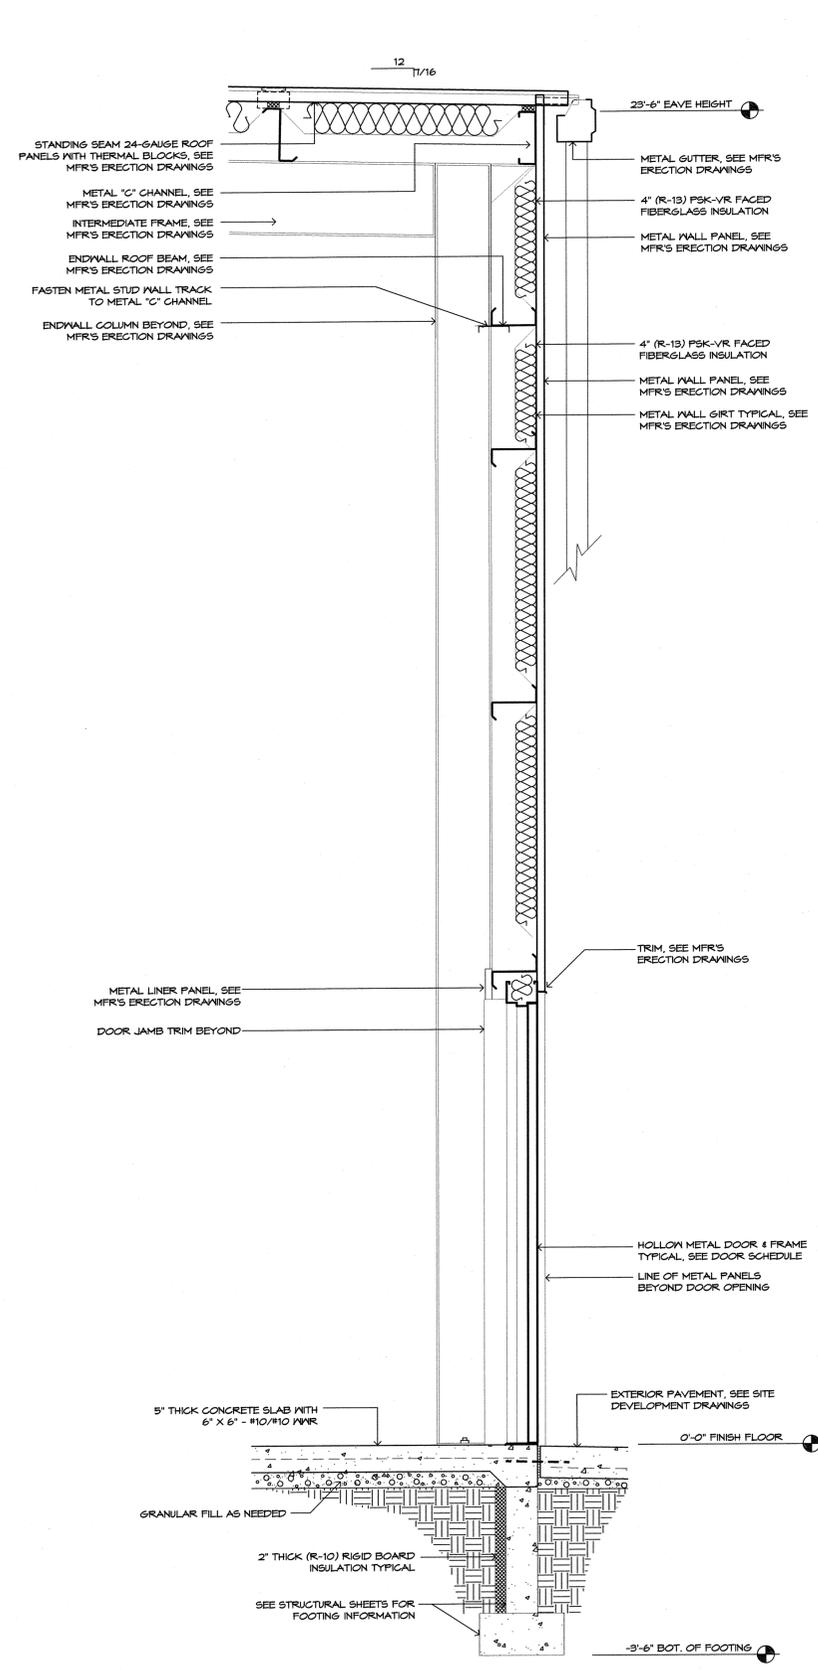

3 WALL SECTION @ MAN DOOR
SCALE: 3/4"=1'-0"

REV	DESCRIPTION	BY	DATE

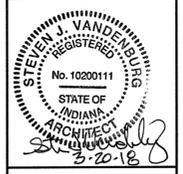

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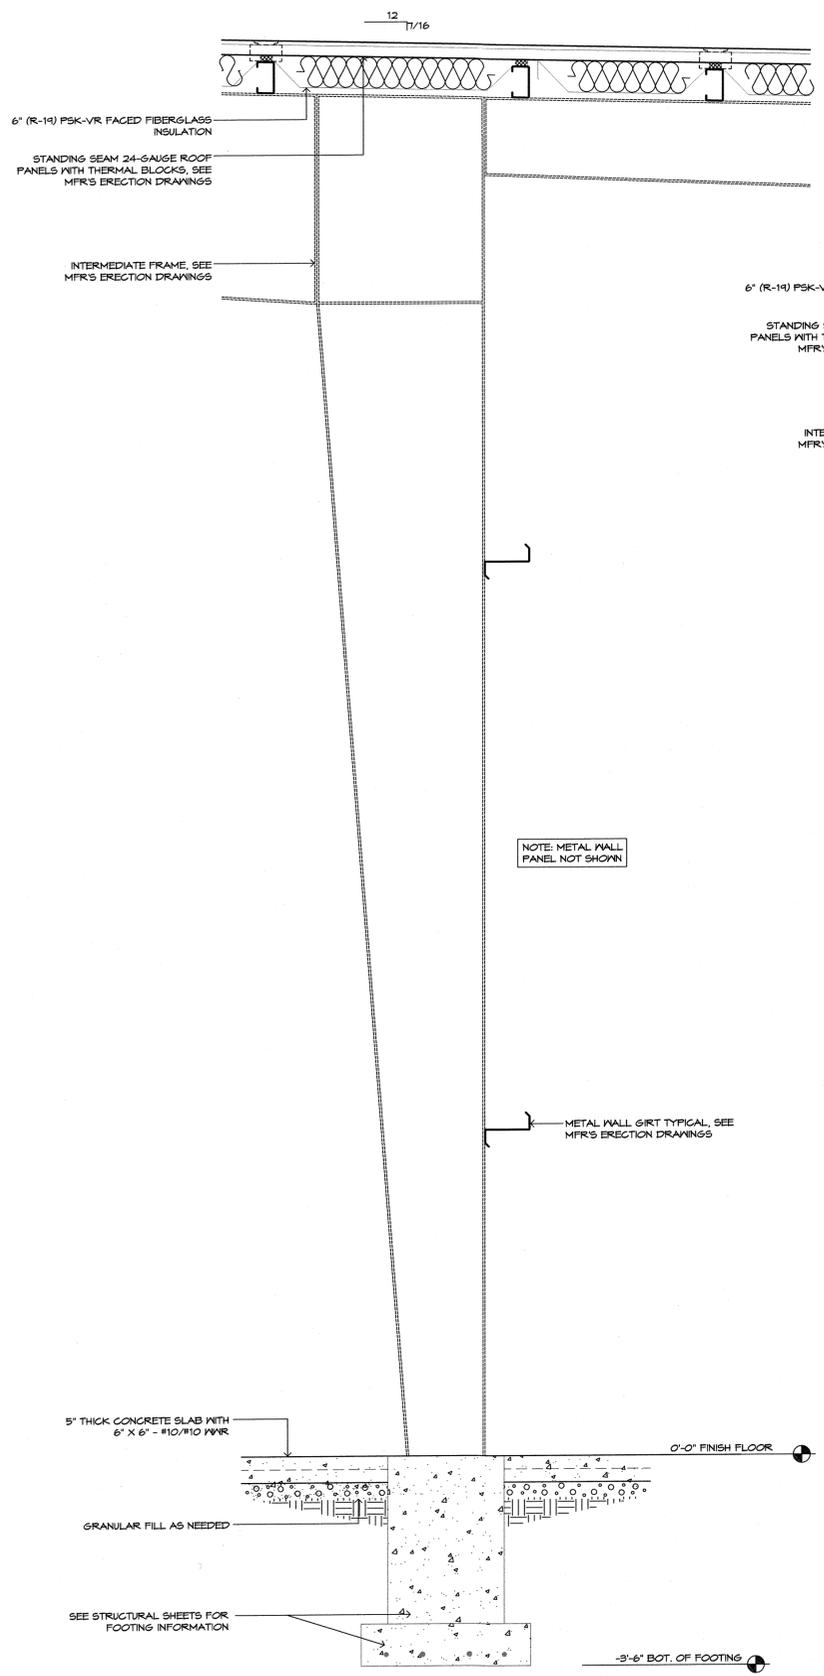
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p. 574.232.4888
p. 574.232.7762


CRUISER LAMINATION
GDR CONSTRUCTION
WALL SECTION VIEWS

HOME, IN. 46746
605EEN, IN. 46528
104 E. CLINTON ST.
TBO5 SR. 9


DESIGNED BY:	RJT
REVIEWED BY:	SJV
DRAWN BY:	JAA
DATE:	FEBRUARY 2018
JOB NUMBER:	2017-0314
SCALE:	AS NOTED
A301	




1 WALL SECTION
 A302 SCALE: 3/4"=1'-0"

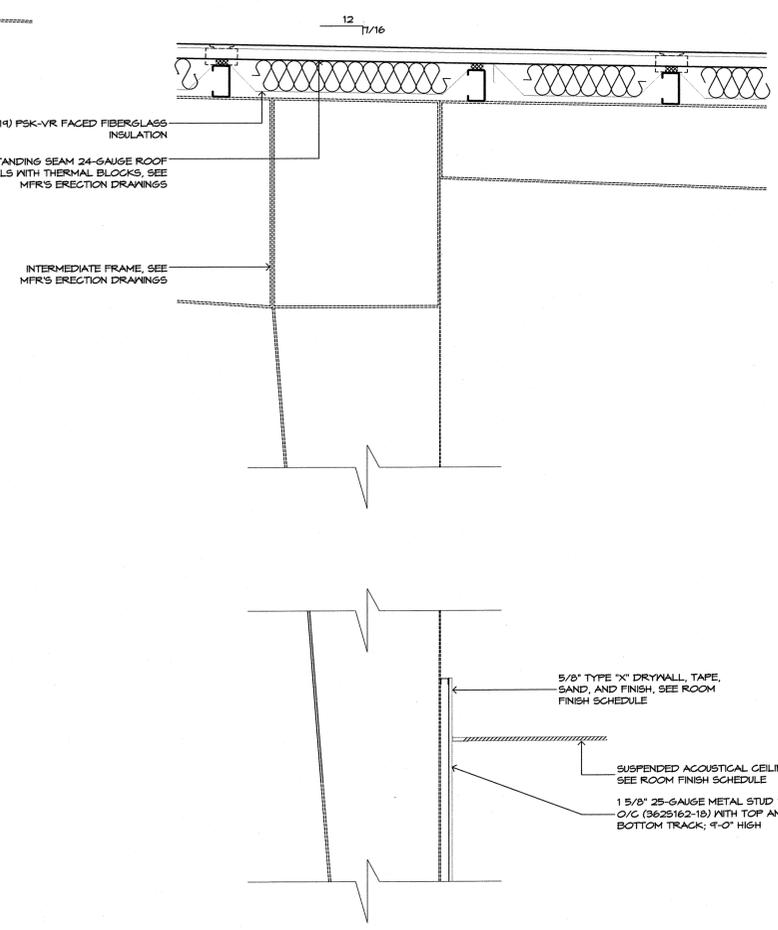


2 WALL SECTION
 A302 SCALE: 3/4"=1'-0"

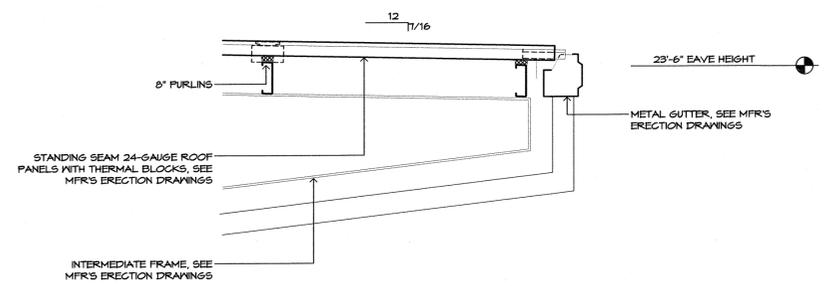

3 WALL SECTION
 A302 SCALE: 3/4"=1'-0"

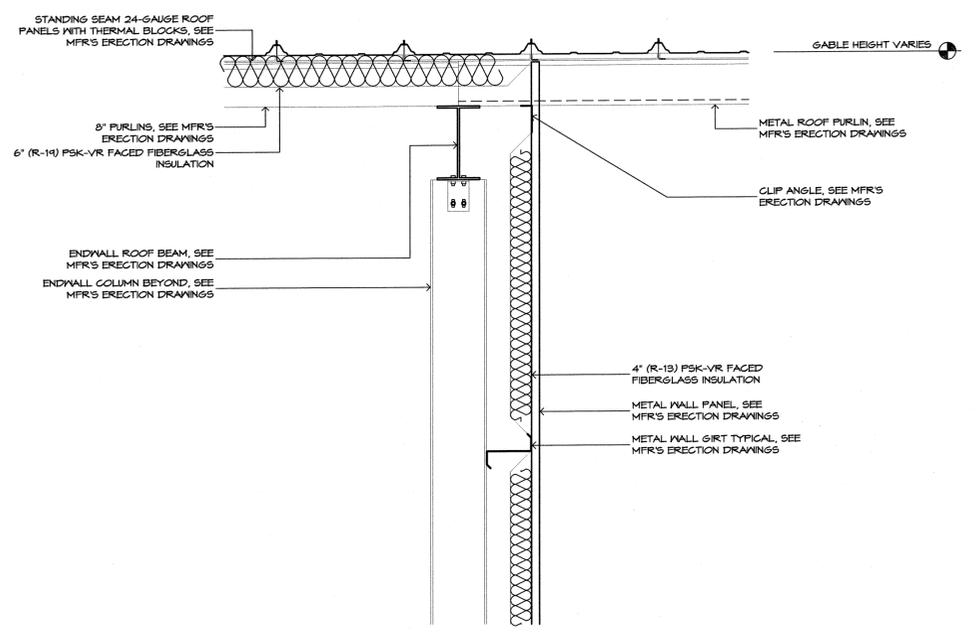


4 WALL SECTION
 A302 SCALE: 3/4"=1'-0"

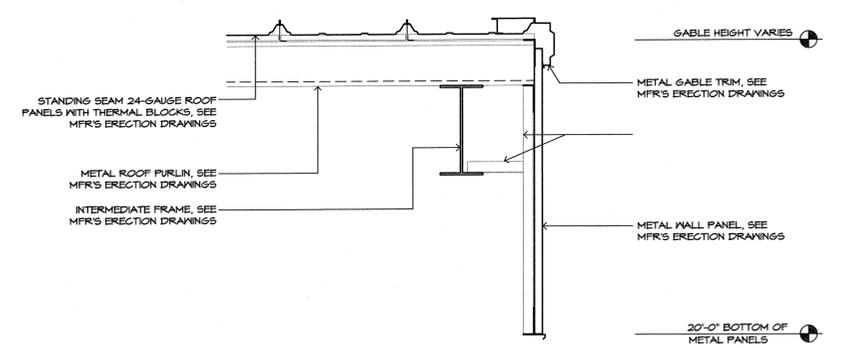

5 WALL SECTION
 A302 SCALE: 3/4"=1'-0"

NOTE: METAL WALL PANEL NOT SHOWN

REV	DESCRIPTION	BY	DATE

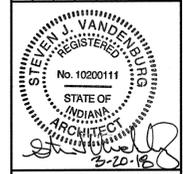


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CRUISER LAMINATION
 GDR CONSTRUCTION
 WALL SECTION VIEWS
 1005 S.R. 9 HOVE, IN 46746
 LOI E. CLINTON ST. GOSHEN, IN 46526


DESIGNED BY: RJT
 REVIEWED BY: SJV
 DRAWN BY: JAA
 DATE: FEBRUARY 2010
 JOB NUMBER: 2011-0319
 SCALE: AS NOTED

A302


1 NOT USED
A303 SCALE: 3/4"=1'-0"

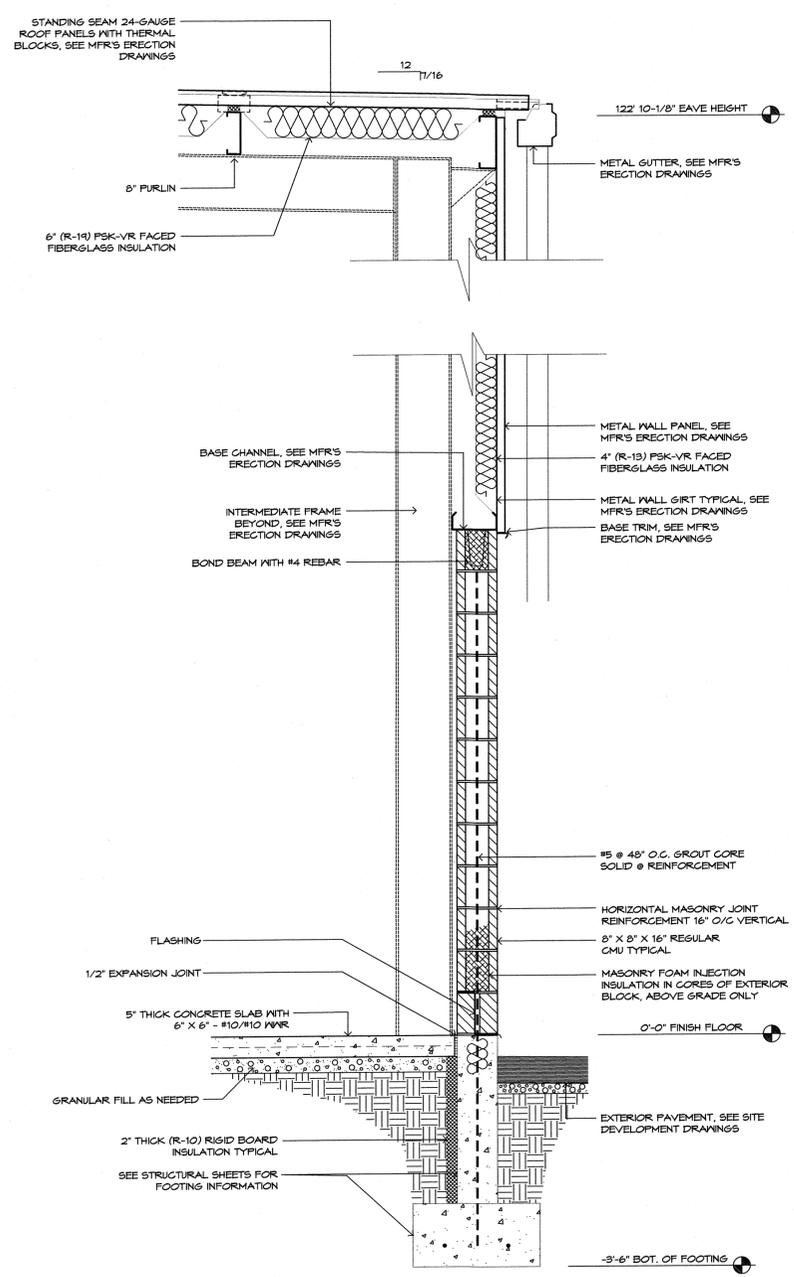

2 WALL SECTION
A303 SCALE: 3/4"=1'-0"

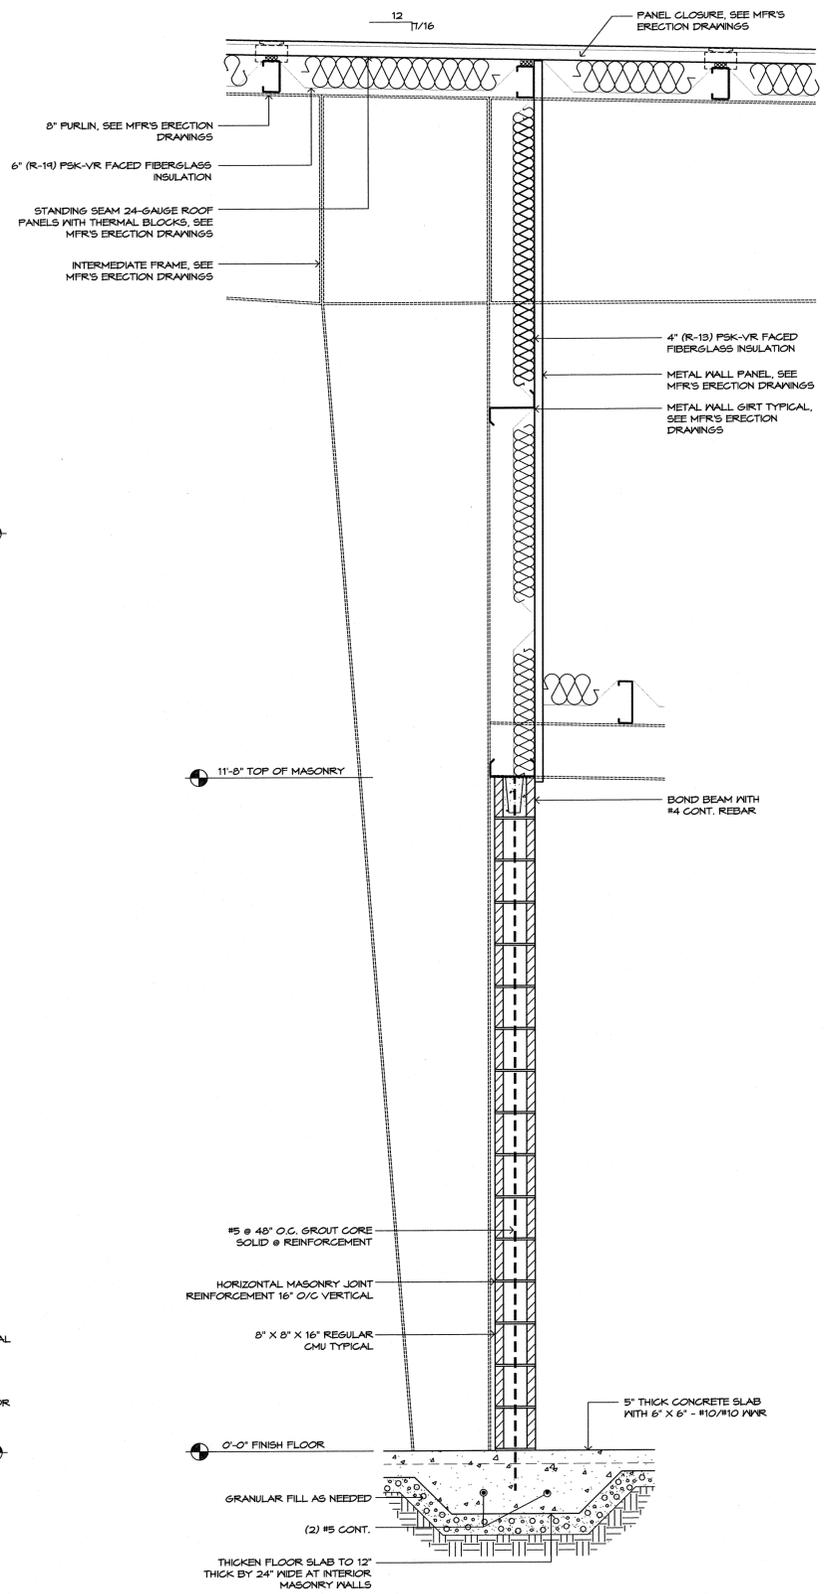

3 WALL SECTION
A303 SCALE: 3/4"=1'-0"

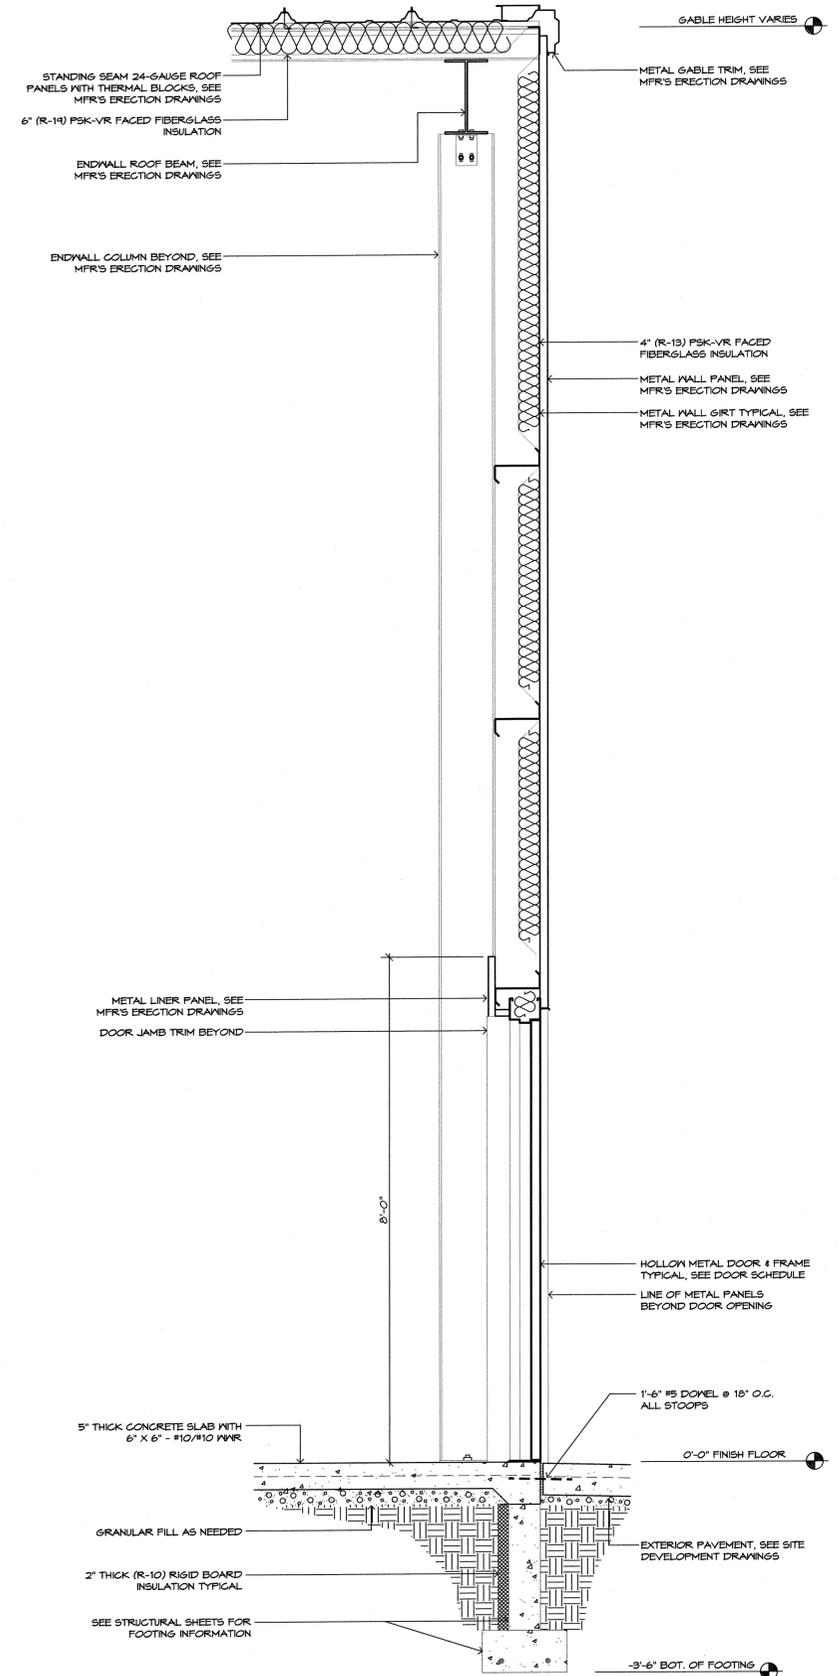

4 WALL SECTION @ MAN DOOR
A303 SCALE: 3/4"=1'-0"


REV	DESCRIPTION	BY	DATE




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CRUISER LAMINATION
GDR CONSTRUCTION
WALL SECTION VIEWS
TR03 SR. 1
HOVE, IN. 467146
GOSHEN, IN. 46528
104 E. CLINTON ST.


DESIGNED BY: RJT
REVIEWED BY: SJV
DRAWN BY: JAA
DATE: FEBRUARY 2018
JOB NUMBER: 2011-0314
SCALE: AS NOTED
A303

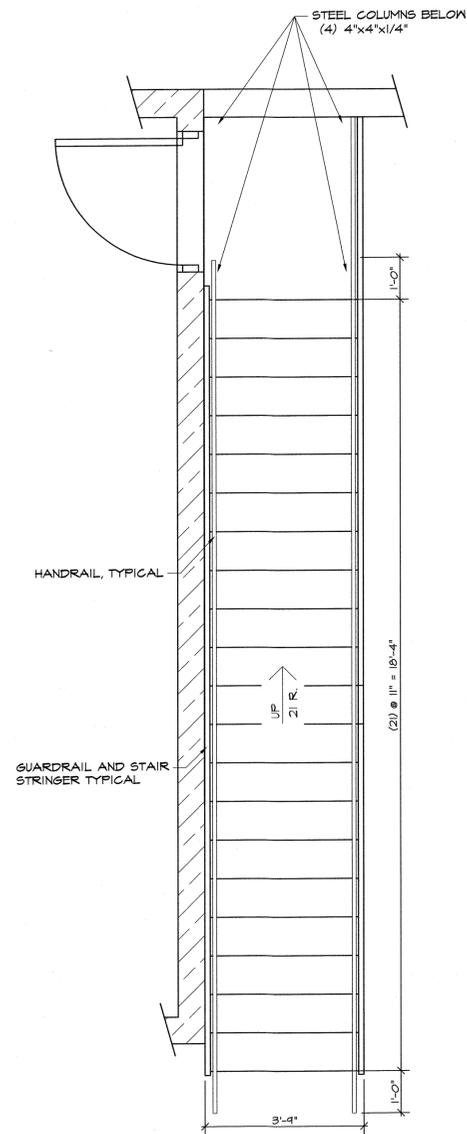

1 STAIR WAY PLAN VIEW
A501 1/2" = 1'-0"

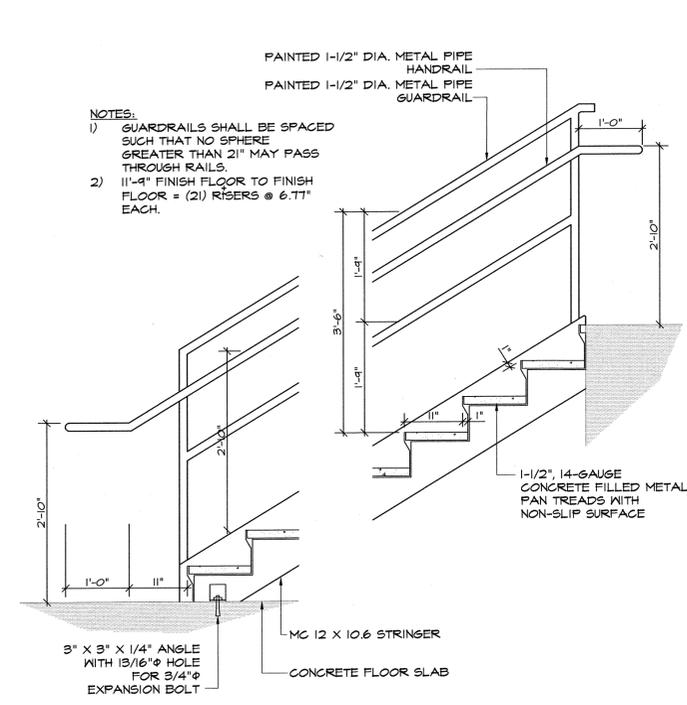


2 STAIR SECTION
A501 3/4" = 1'-0"

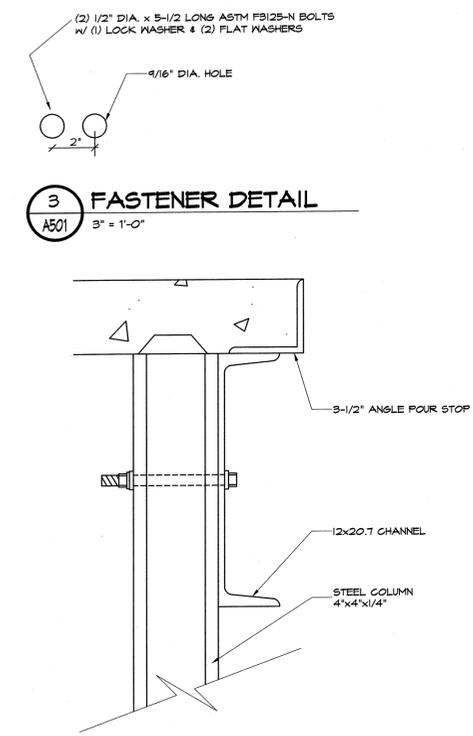

3 FASTENER DETAIL
A501 3" = 1'-0"

4 CONNECTION DETAIL
A501 3" = 1'-0"

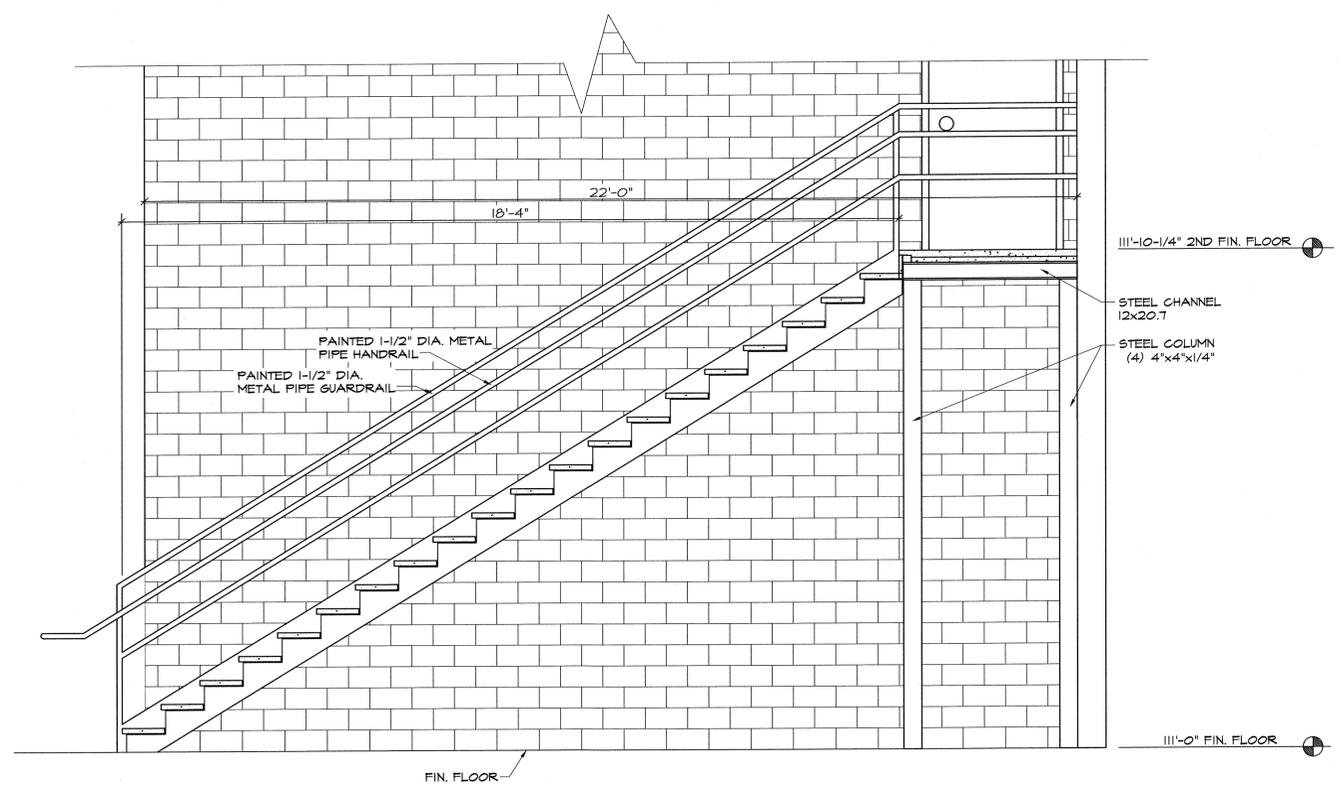

5 STAIR SECTION
A501 1/2" = 1'-0"

DESIGNED BY:	RJT
REVIEWED BY:	JLM
DRAWN BY:	JIL
DATE:	FEBRUARY 2018
JOB NUMBER:	2017-0374
SCALE:	AS NOTED
A501	

TRCOS SR. 1	10VE IN. 46746
LOP E. CLINTON ST.	609EEN IN. 46528
CRUISER LAMINATION	
GDR CONSTRUCTION	
STAIRWAY PLAN & DETAILS	

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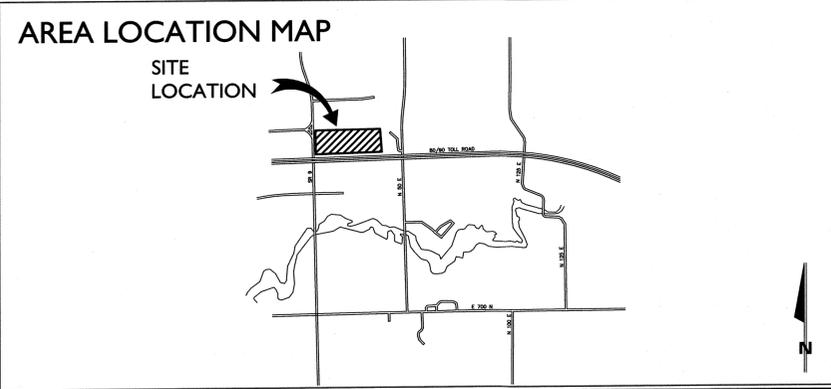
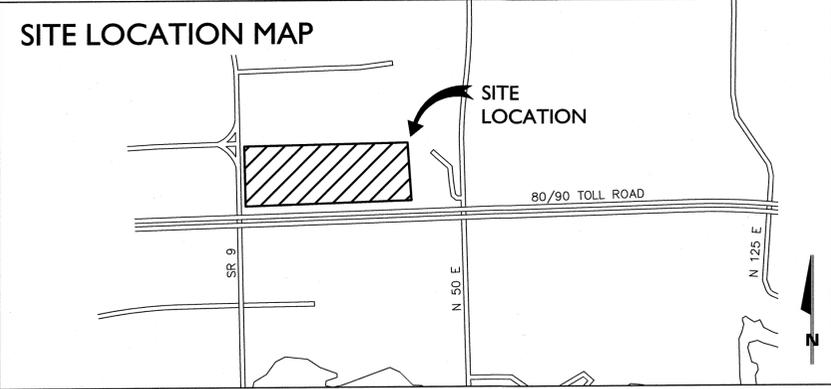
STATE OF INDIANA ARCHITECTS
No. 10200111
S. J. VAN DER BEEK
REGISTERED ARCHITECT

A DESIGN/BUILD NEW FACILITY FOR: CRUISER LAMINATION

7805 STATE ROAD 9
HOWE, IN 46746

2014 INDIANA BUILDING CODE

USE GROUP:	ALLOWABLE	ACTUAL	TYPE OF CONSTRUCTION (AS PER CHAPTER 6)
B/F-1 NON-SEPARATED (AS PER SECTIONS 304 & 306.2)			V-B
AREA LIMITATIONS PER TABLE 503			FIRE SUPPRESSION SYSTEM
B (AND SECTION 507.3)	UNLIMITED	4,288 SF	AUTOMATIC FIRE SUPPRESSION SYSTEM THROUGHOUT AS PER NFPA 13
F-1 (AND SECTION 507.3)	UNLIMITED	81,842 SF	
ENCLOSED BUILDING		42,180 SF	
CANOPIES		6,341 SF	
TOTALS	UNLIMITED	102,809 SF	
HEIGHT LIMITATIONS PER TABLE 503			MISCELLANEOUS
F-1 (PER SECTION 504.2)	1 STORY UP TO 60'	1 STORY, 27'	MAXIMUM LENGTH OF EXIT TRAVEL (TABLE 1016.1)
			MAXIMUM OCCUPANCY (TABLE 1004.1.1)
			B (1 PER 100 SF)
			F-1 (1 PER 100 SF)
			MINIMUM CORRIDOR FIRE RESISTANCE RATING (TABLE 1017.1)
			MINIMUM NUMBER OF EXITS
			MINIMUM FLOOR LIVE LOADS (SEC. 1604 & 1607)
			SLAB ON GRADE - S-1 AREAS:
			MEZZANINE AREAS
			RISK CATEGORY (TABLE 1604.5)
			MINIMUM ROOF LIVE LOAD (SEC. 1607)
			GROUND SNOW LOAD, P _g (AC TABLE 1608.2, LAGRANGE)
			SNOW LOAD EXPOSURE FACTOR, C _e (SEC. 1608.1)
			SNOW LOAD IMPORTANCE FACTOR, I _s (SEC. 1608.1)
			SNOW LOAD THERMAL FACTOR, C _t (SEC. 1608.1)
			COLLATERAL LOADS
			ULTIMATE DESIGN WIND SPEED (SEC. 1609)
			WIND EXPOSURE FACTOR, K _e (SEC. 1609.4.3)
			WIND IMPORTANCE FACTOR, I _w
			SEISMIC LOAD ANALYSIS PROCEDURE (SEC. 1613)
			LOAD BEARING VALUE OF SOILS (SEC. 1804), PRESUMPTIVE
			WITH SAFETY FACTOR OF 3.0
			NOTES:
			1) SOIL IS TO BE TESTED AFTER EXCAVATION. NOTIFY ENGINEER IMMEDIATELY OF ANY READINGS BELOW 2,000 PSF ALLOWABLE BEARING.
			2) FIRE PROTECTION SYSTEMS WILL BE DESIGNED BY A LICENSED FIRE PROTECTION DESIGNER AND WILL BE SUBMITTED FOR PERMIT UNDER SEPARATE COVER.
			3) ALL HAZARDOUS MATERIALS LOCATED IN AREAS OTHER THAN "H" OCCUPANCIES ARE WITHIN THE EXEMPT AMOUNTS AS PER TABLE 307.1.
			PRE-ENGINEERED STRUCTURES:
			1) AMERICAN BUILDING SYSTEMS
INTERIOR FINISHES			
WALLS & CEILING	REQUIRED AS PER TABLE 803.5	ACTUAL	
VERTICAL EXITS & PASSAGEWAYS	CLASS A	N/A	
EXIT ACCESS CORRIDORS & OTHER EXITWAYS	CLASS B	CLASS A	
ROOMS & ENCLOSED SPACES	CLASS C	CLASS B	



NOTES:

ADA REGULATIONS

THE OWNER AND CONTRACTOR SHALL FURNISH AND INSTALL ALL SITE AND BUILDING ACCESSORIES AND MISCELLANEOUS DESIGN DETAILS IN THE FIELD FOR FULL COMPLIANCE WITH THE AMERICAN DISABILITIES ACT INCLUDING BUT NOT LIMITED TO THE FOLLOWING:

- 1) SITE AND BUILDING ACCESS: WALKS, SURFACE TEXTURES, CURB CUTS, RAMPS, PARKING SPACES, ETC.
- 2) INTERIOR ACCESS: CORRIDORS, DOORS, FLOORING, HANDRAILS, STAIRS, ETC.
- 3) DOOR HARDWARE: THRESHOLDS, CLOSERS, DOOR KNOBS, PULLS, HINGES, ETC.
- 4) PLUMBING AND ELECTRICAL FIXTURES: WATER CLOSETS, LAVATORIES, DRINKING FOUNTAINS, MIRRORS, GRAB BARS, PUBLIC PHONES, ELEVATOR CONTROLS, SWITCH DEVICES, EMERGENCY WARNING SYSTEMS, ETC.

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METAL BUILDING STRUCTURE
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901 W. MAIN STREET
EL PASO, IL 61738
PH: 309-527-1500
FAX: 309-527-1522
EMAIL:

CONTACTS:
RONALD R. WENGER, PE

SHEET	DESCRIPTION
G101	COVER SHEET, CONTACTS & INDEX
G201	LEGENDS AND NOTES
C201	SITE DIMENSIONAL PLAN
S101	STRUCTURAL PARTIAL FOUNDATION PLAN & SCHEDULE
S102	PARTIAL FOUNDATION PLAN & DETAILS
S103	FOUNDATION DETAILS & STRUCTURAL NOTES
S104	MASONRY WALL AND FLOOR PLANS
A101	ARCHITECTURAL PARTIAL FLOOR PLAN
A102	PARTIAL FLOOR PLANS & DETAILS
A103	ENLARGED DETAIL FLOOR PLANS
A201	EXTERIOR BUILDING ELEVATIONS
A301	WALL SECTIONS
A302	WALL SECTIONS
A303	WALL SECTIONS
A501	STAIRWAY PLAN & DETAILS
A601	DOOR & WINDOW SCHEDULES
M101	MECHANICAL MECHANICAL PLAN - OVERALL
M102	MECHANICAL PLAN - ENLARGED
P101	PLUMBING PLUMBING PLAN - OVERALL
P102	ENLARGED PLUMBING PLANS & ISOMETRICS
E101	ELECTRICAL PARTIAL OVERALL LIGHTING PLAN
E102	PARTIAL OVERALL LIGHTING PLAN
E103	POWER AND LIGHTING PLAN - ENLARGED

MRK	DATE	ISSUED FOR
	02-19-18	FOUNDATION RELEASE SUBMITTAL
	03-20-18	BUILDING RELEASE SUBMITTAL

INDEX TO DRAWINGS:

DESIGNED BY: RJT
REVIEWED BY: JLM
DRAWN BY: JAA
DATE: FEBRUARY 2018
JOB NUMBER: 2017-0374
SCALE: AS NOTED

METAL BUILDING DRAWINGS BY ABC MIDWEST DIVISION
C-1
AB-1 - AB-3
PE-01 - PE-12

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CRUISER LAMINATION
18025 S.R. 9
HOWE, IN 46746

CDR CONSTRUCTION
104 E. CLINTON ST.
GOSHEN, IN 46526

COVER SHEET, CONTACTS & INDEX

DATE: 02-19-18
BY: RJT
REV: 1
DESCRIPTION: INDEX TO DRAWINGS

A - TERMS AND ABBREVIATIONS	
ABV	ABOVE
AF	ABOVE FINISHED FLOOR
ACC	ACCESS
ACFL	ACCESS FLOOR
AP	ACCESS PANEL
AC	ACOUSTICAL
ACPL	ACOUSTICAL PLASTER
ACT	ACTUAL TILE
AGR	ACRYLIC PLASTIC
ADH	ADHESIVE
ADJ	ADJACENT
ADUT	ADJUSTABLE
AG	AGGREGATE
A/C	AIR CONDITIONING
ALT	ALTERNATE
AL	ALUMINUM
ANC	ANCHOR, ANCHORAGE
AB	ANCHORBOLT
AND	AND
ARCH	ARCHITECT, ARCHITECTURAL
AD	AREA DRAIN
ASPH	ASPHALT
AT	ASPHALT TILE
AUTO	AUTOMATIC
AWN	AWNING

B - TERMS AND ABBREVIATIONS	
BKR	BACKER
BSMT	BASEMENT
BL	BASE LINE
BM	BEAM
BRG	BEARING
BRPL	BEARING PLATE
BEL	BELOW
BM	BENCH MARK
BET	BETWEEN
BFL	BEVELED FLOOR ELEVATION
BEY	BEYOND
BLK	BLOCK
BLG	BLOCKING
BOAR	BOARD
BS	BOTH SIDES
BOT	BOTTOM
BRKT	BRACKET
BRS	BRASS
BRK	BRICK
BRZ	BRONZE
BLDC	BUILDING
BUR	BUILT UP ROOFING
BRGL	BULLETPROOF RESISTANT GLASS
BO	BY OWNER

C - TERMS AND ABBREVIATIONS	
CAB	CABINET
CAN	CANVAS
CPT	CARPET
CSMT	CASSETT
CI	CAST IRON
CST	CAST STONE
CLG	CATCH BASIN
CHT	CEILING HEIGHT
CEM	CEMENT
CM	CENTIMETER (S)
CCR	CERAMIC
CT	CERAMIC TILE
CHBD	CHALKBOARD
CHAMF	CHAMFER
CHM	CHIMNEY
CR	CHROMIUM
CIR	CIRCLE
CIRC	CIRCUMFERENCE
CLR	CLEAR, CLEARANCE
CLS	CLOSURE
COL	COLUMN
COMB	COMBINATION
COM	COMMON
COMP	COMPARTMENT
COMPO	COMPOSITION, COMPOSITE
COMP	COMPRESS, (ED), (ON), (IBLE)
CONC	CONCRETE
CMU	CONCRETE MASONRY UNIT
CONN	CONNECTION
CONST	CONSTRUCTION
CONT	CONTINUE, CONTINUOUS
CONTR	CONTRACT, CONTRACTOR
CJT	CONTROL JOINT
CPR	COPPER
CG	CORNER GUARD
COOR	CORROGATED
CTR	COUNTER
CS	COUNTERSINK
CRS	COURSE
CFT	CUBIC FOOT
CYD	CUBIC YARD

D - TERMS AND ABBREVIATIONS	
DPR	DAMPER
DP	DAMP-PROOFING
DL	DEAD LOAD
DEM	DEMOLISH, DEMOLITION
DMT	DEMOUNTABLE
DTL	DETAIL
DNAG	DIAGONAL
DN	DIMETER
DM	DIMENSION
DIR	DIRECTION
DSP	DISPENSER
DIV	DIVISION
DR	DOOR
DIA	DOVETAIL ANCHOR
DTS	DOVETAIL ANCHOR SLOT
DN	DOWN
DS	DOWNSPOUT
DT	DRAIN TILE
DWR	DRAWER
DWG	DRAWING
DF	DRINKING FOUNTAIN
DW	DRAINWATER

E - TERMS AND ABBREVIATIONS	
EA	EACH
EF	EACH FACE
EW	EACH WAY
ESMT	EASEMENT
E	EAST
ELAS	ELASTIC
ELEC	ELECTRIC, (AL)
EP	ELECTRICAL PANELBOARD
EW	ELECTRIC WATER COOLER
EL	ELEVATION (VERTICAL HEIGHT)
ELE	ELEVATION (VIEW)
ELEV	ELEVATOR
EMER	EMERGENCY
ENC	ENCLOSE, (URE)
EQ	EQUAL
EOP	EQUIPMENT
ESC	ESCALATOR
EST	ESTIMATE
EXH	EXHAUST
EXG	EXISTING
EMP	EXPANDED METAL PLATE
EB	EXPANSION JOINT
EJT	EXPANSION JOINT
EXP	EXPOSED
EXT	EXTERIOR

F - TERMS AND ABBREVIATIONS	
FOC	FACE OF CONCRETE
FOF	FACE OF FINISH
FOM	FACE OF MASONRY
FOS	FACE OF STUDS
FAS	FASTER, FASTENER
FN	FENCE
FBD	FIBERBOARD
FGL	FIBERGLASS
FIN	FINISH, (ED)
FTE	FINISHED FLOOR ELEVATION
FFL	FINISHED FLOOR LINE
FA	FIRE ALARM
FE	FIRE EXTINGUISHER
FEC	FIRE EXTINGUISHER CABINET
FHS	FIRE HOSE STATION
FPL	FIREPLACE
FRT	FIRE-RETARDANT
FXT	FIXTURE
FLG	FLASHING
FLX	FLEXIBLE
FG	FLOAT GLASS
FLR	FLOOR, (ING)
FD	FLOOR DRAIN
FL	FLOOR LINE
FLUR	FLOURESCENT
FJT	FLOUSH JOINT
FTG	FOOTING
FND	FOUNDATION
FR	FRAME, (D), (ING)
FS	FULL SIZE
FUR	FURRED, (ING)
FUT	FUTURE

G - TERMS AND ABBREVIATIONS	
GA	GAGE, GAUGE
GV	GALVANIZED
GKT	GASKET, (ED)
GC	GENERAL CONTRACT, (OR)
GL	GLASS, GLAZING
GLB	GLASS BLOCK
GMU	GLAZED CONCRETE MASONRY UNITS
GLAM	GLUED LAMINATE
GB	GRAB BAR
GD	GRADE, GRADING
GRN	GRANITE
GRT	GRATE, (ING)
GVL	GRAVEL
GRHS	GREENHOUSE
GT	GROUT
GRO	GROUPE
GUT	GUTTER
GPDW	GYPSPUM DRY WALL
GPL	GYPSPUM LATH
GPLR	GYPSPUM PLASTER
GPT	GYPSPUM TILE
GPW	GYPSPUM WALLBOARD

H - TERMS AND ABBREVIATIONS	
HC	HANDICAP
HRL	HANDRAIL
HBD	HARDBOARD
HDW	HARDWARE
HWD	HARDWOOD
HDR	HEADER
HTR	HEATING
HVAC	HEATING/VENTILATING/AIR CONDITIONING
HD	HEAVY DUTY
HT	HEIGHT
HPT	HIGH POINT
HCR	HOLLOW CORE
HM	HOLLOW METAL
HOR	HORIZONTAL
HB	HOSC, BBBB

I - TERMS AND ABBREVIATIONS	
INCAN	INCANDESCENT
INCIN	INCINERATOR
INCL	INCLUDE, (ED), (ING)
ID	INSIDE DIAMETER
INS	INSULATE, (ED), (ING)
INSC	INSULATING CONCRETE
IGL	INSULATING GLASS
INT	INTERIOR
INTM	INTERMEDIATE
INV	INVERT

J - TERMS AND ABBREVIATIONS	
JC	JANITOR'S CLOSET
JT	JOINT
JF	JOINT FILLER
J	JOIST

K - TERMS AND ABBREVIATIONS	
KPL	KICKPLATE
KIT	KITCHEN
KES	KITCHEN EQUIPMENT SUPPLIER
KO	KNOCKOUT

L - TERMS AND ABBREVIATIONS	
LBL	LABEL
LAB	LABORATORY
LAD	LADDER
LB	LAG BOLT
LAM	LAMINATE, (ED)
LGL	LAMINATED GLASS
LAW	LAWATORY
LD	LAYOUT
LH	LEFT HAND
L	LENGTH
LT	LIGHT
LW	LIGHTWEIGHT
LMS	LIMESTONE
LTL	LINTEL
LL	LIVE LOAD
LOC	LOCATE
LDD	LOOSE LAD
LVR	LOUVER
LPT	LOW POINT

M - TERMS AND ABBREVIATIONS	
MB	MACHINE BOLT
MH	MANHOLE
MFR	MANUFACTURE, (ER) (ED)
MRB	MARBLE
MAS	MASONRY
MAT	MATERIAL
MAX	MAXIMUM
MECH	MECHANIC, (AL)
MC	MEDICINE CABINET
MED	MEDIUM
MDO	MEDIUM DENSITY OVERLAY
MER	MEMBER
MMB	MEMBRANE
MET	METAL
M	METER, (S)
MW	MICROWAVE
MM	MILLIMETER, (S)
MIN	MINIMUM
MIR	MIRROR
MGL	MIRROR GLASS (FRAMED)
MISC	MISCELLANEOUS
MOD	MODULAR
MED	MOLDING, MOULDING
MFR	MOP RECEPTOR
MT	MOUNT, (ED), (ING)
MOV	MOVABLE
MULL	MULLION

N - TERMS AND ABBREVIATIONS	
NL	NAILABLE
NAT	NATURAL
NI	NICKEL
NR	NOISE REDUCTION
NOM	NOMINAL
N	NORTH
NIC	NOT IN CONTRACT
NTS	NOT TO SCALE
NO	NUMBER

O - TERMS AND ABBREVIATIONS	
OC	ON CENTER, (S)
OP	OPENING
OPG	OPENING
OPH	OPPOSITE HAND
ORN	ORNAMENTAL
OD	OUTSIDE DIAMETER
OA	OVERALL
OH	OVERHEAD

P - TERMS AND ABBREVIATIONS	
PNT	PAINT, (ED)
PNL	PANEL, (ING)
PB	PANIC BAR
PTD	PAPER TOWEL DISPENSER
PTR	PAPER TOWEL RECEPTOR
PAR	PARALLEL
PRFT	PAPER
PK	PARKING
PBD	PARTICLE BOARD
PTN	PARTITION
PV	PANE, (D), (ING)
PVMT	PAVEMENT
PERF	PERFORATE, (ED)
PER	PERMETER
PLTR	PLASTER
PLTG	PLANTING
PLAS	PLASTER
PLA	PLASTIC
PLAM	PLASTIC LAMINATE
PLT	PLATE
PG	PLATE GLASS
PWD	PLYWOOD
PT	POINT
PVC	POLYVINYL CHLORIDE
PE	PAVEMENT
PCPL	PORTLAND CEMENT PLASTER
PD	POUND(S)
PCF	POUNDS PER CUBIC FOOT
PLF	POUNDS PER LINEAR FOOT
PSF	POUNDS PER SQUARE FOOT
PSI	POUNDS PER SQUARE INCH
PPC	PREFABRICATED CONCRETE
PPB	PREFABRICATE, (ED)
PFN	PREFINISHED
PRF	PREFORMED
PRM	PREFORMED
PRTD	PRESSURE TREATED
PROJ	PROJECT, (ED), (ING)
PL	PROPERTY LINE

Q - TERMS AND ABBREVIATIONS	
QT	QUARRY TILE

R - TERMS AND ABBREVIATIONS	
RBT	RABBET, REBATE
RAD	RADIUS
RFT	RAFTER
RL	RAIL, (ING)
REC	RECESS, (ED)
REF	REFER, (ENCE)
RFL	REFLECT, (ED), (ING), (OR)
REFR	REFRIGERATOR
REG	REGISTER
REIN	REINFORCE, (ED), (ING), (MENT)
RECP	REINFORCED CONCRETE PIPE
REMO	REMOVE, (ABLE)
REQ'D	REQUIRED
RES	RESILIENT
RET	RETURN
RA	RETURN AIR
RVS	REVERSE (SIDE)
REV	REVISE, (S), (ED)
RH	RIGHT HAND
ROW	RIGHT OF WAY
R	RISER
RVT	RIVET
RAS	ROD AND SHELF
RD	ROOF DRAIN
RHT	ROOF HATCH
RFC	ROOFING
RM	ROOM
RO	ROUGH OPENING
RCP	ROUND CONCRETE PIPE
RDK	ROULOCK
RB	RUBBER BASE
RBT	RUBBER TILE
RBL	RUBBLE STONE

S - TERMS AND ABBREVIATIONS	
SGL	SAFETY GLASS
SGH	SCHEDULE
SCN	SCREEN, (ED)
SCUP	SCUPPER
SLANT	SLANT
SG	SEATING
SECT	SECTION
SEC	SECURITY
SHD	SERVICE YARD
SK	SERVICE SINK
SHTH	SHEATH, (ING)
SHT	SHEET
SG	SHEET GLASS
SH	SHEET SHELVING
SHNG	SHINGLE, (S)
SHU	SHUTTER, (S)
SIDG	SIDING
SIM	SIMILAR
SKL	SKYLIGHT
SL	SLEEVE
SLO	SLOPE
SOL	SOLDER
SC	SOLID CORE
SS	SOLID SURFACE
SP	SOUNDPROOF
S	SOUTH
SPC	SPANDREL, (R)
SGL	SPANDREL GLASS
SPK	SPEAKER
SPL	SPECIAL
SPEC	SPECIFICATION
SPH	SPLASH
SQ	SQUARE
SQ FT	SQUARE FOOT (FEET)
SST	STAINLESS STEEL
STGL	STAINED GLASS
STD	STANDARD
STA	STATION
ST	STEEL
STO	STORAGE
SF	STOREFRONT
SD	STORM DRAIN
STR	STRUCTURAL
STOD	STOOD
SFLR	SUBFLOOR
SA	SUPPLY AIR
SUS	SUSPENDED
SYD	SIDE YARD
SYM	SYMMETRY, (ETRICAL)
SYN	SYNTHETIC
SYS	SYSTEM

T - TERMS AND ABBREVIATIONS	
TKBD	TACKBOARD
TEL	TELEPHONE
TV	TELEVISION
TC	TEMPERED GLASS
TIG	TEMPERED, INSULATED GLASS
TZ	TERRAZZO
TK	THICK, (NESS)
THR	THRESHOLD
TBR	TO BE RELOCATED
TOBR	TO BE REMOVED
TPD	TOILET PAPER DISPENSER
TPIN	TOILET PARTITION
TOL	TOLERANCE
T&G	TONGUE AND GROOVE
TSL	TOP OF CONCRETE SLAB
TC	TOP OF CURB
TJ	TOP OF JOIST
TP	TOP OF PLATE
TST	TOP OF STEEL
TSF	TOP OF SUBFLOOR
TW	TOP OF WALL
TPC	TOPPING
TOR	TO REMAIN
TBB	TOWEL BAR
TR	TRANSOM
T	TREAD
TRNB	TURNBUCKLE
TP	TYPICAL

U - TERMS AND ABBREVIATIONS	
UC	UNDERCUT
UNF	UNFINISHED
UNO	UNLESS NOTED OTHERWISE
UR	URINAL
UTL	UTILITY

V - TERMS AND ABBREVIATIONS	
VJ	V-JOINT
VB	VAPOR BARRIER
VBR	VARNISH
VNR	VENEER
VERT	VERTICAL
VG	VERTICAL GRAIN
VIN	VINYL
VB	VINYL BASE
VCT	VINYL COMPOSITION TILE
VF	VINYL FABRIC
VTL	VINYL TILE
VCP	VITREOUS CLAY PIPE
VCT	VITREOUS CLAY TILE

W - TERMS AND ABBREVIATIONS	
WSCOT	WAINSCOT
WH	WALL HUNG
WC	WATER CLOSET
WHTR	WATER HEATER
WP	WATERPROOFING
WR	WATER RESISTANT
WS	WATERSTOP
WST	WEATHERSTRIP, (ING)
WNF	WELDED WIRE FABRIC
W	WEST
WHS	WHEEL STOP
WD	WIDTH, WIDE
WN	WINDOW
WG	WIRED GLASS
WM	WIRE MESH
WO	WITHOUT
WD	WOOD
WI	WROUGHT IRON

X - TERMS AND ABBREVIATIONS	
XX/XXX	INTERIOR ELEVATION VIEW KEY REFER SECTION KEY FOR DESIGNATION INFORMATION

Y - TERMS AND ABBREVIATIONS	
Y	FINISH KEY REFER SECTION KEY FOR DESIGNATION INFORMATION

Z - TERMS AND ABBREVIATIONS	
Z	REVISION TO DRAWING

A - TERMS AND ABBREVIATIONS	
A	ROOM NAME / SPACE NUMBER

B - TERMS AND ABBREVIATIONS	
B	WINDOW DESIGNATION

C - TERMS AND ABBREVIATIONS	
C	DOOR DESIGNATION

D - TERMS AND ABBREVIATIONS	
D	COLUMN REFERENCE DESIGNATION

DRAWING SYMBOLS LEGEND:

DIRECTION INDICATOR: BUILDING ELEVATION KEY

DETAIL NO SHEET NO: WALL SECTION KEY FOR DESIGNATION INFORMATION

INTERIOR ELEVATION VIEW KEY REFER SECTION KEY FOR DESIGNATION INFORMATION

FINISH KEY

DIMENSION TO FACE OF FRAMING OR EDGE OF SLAB UNLESS OTHERWISE NOTED

DIMENSION TO CENTERLINE OF COLUMN OR CENTERLINE OF DIMENSIONED ITEM

ROOM NAME / SPACE NUMBER

WINDOW DESIGNATION

DOOR DESIGNATION