
WILLOW CREEK PLAZA: BUIDLING 4 WILLOW CREEK RD. LEWES, DE 19958

ARCHITECT	URAL SYMB	BOLS			LIST O	FABBRE	VIATIONS		
$(1 \times C + 11 \times C + 1$	BUILDING SE SHEET NUME WALL SECTION SHEET NUME ROOM NUM DETAIL REFEN DOOR NUM WINDOW NU REVISION NU REVISION NU COLUMN G WALL TYPE N FLOOR ELEV	ECTION NUMBER BER ON NUMBER BER BER UMBER UMBER RID DELINEATIO	Ν		A.B. A.F.F. ABV. AL./GL. ALUM. B.S. BLDG. BLK. BM. CFM CFMF C.M.U. CONC. CONC. CONC. CONC. CONT. DK. DR. DVG(S). DTL. EA. ELEV. EXT. FIN. FLR. F.R. FRP. GD. GYP. H.M. HT. INSUL. INT. LLH LLV HB	ANCHOR BOLT ABOVE FINISHE ABOVE ALUMINUM AN ALUMINUM BOTH SIDES BUILDING BLOCK BEAM COLD FORM N COLD FORM N COLD FORM N CONCRETE M CASED OPENII COLUMN CONCRETE CONTINUOUS DARK DOOR DOWN SPOUT DRAWING (S) DETAIL EACH ELEVATION EXTERIOR FINISH FLOOR FIRE RETARDAN	AETAL METAL FRAMING ASONRY UNIT NG	LT. MECH. MEZZ. MTL. N.T.S. O.C. O.H. O.H.D. OPNG. PTD. PLYWD. REIN. RD. SC. SCWD SECT. SHT. STRUCT. T.O.(S) T.O.W. TYP. U.N.O. VEST. V.I.F. W/ SLP. N.I.C. L Ø Q P L	LIGH MEC MET NOT OPP OVE OPE PAIN PLYV REIN ROC SOLI SECT STEE STRU TOP TYPIC VERI WITH SLOF NOT ANC DIA <i>I</i>
MATERIAL S								ſ	XXXXX
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	STEEL	STRUCTURAL CC		NCR	ETE		FINISHED WOOD		
	ALUMINUM	\bigotimes	CONCRETE MAS	ONR	y units		PLYWOOD	I	
	GLASS		BRICK				STONE FILL		

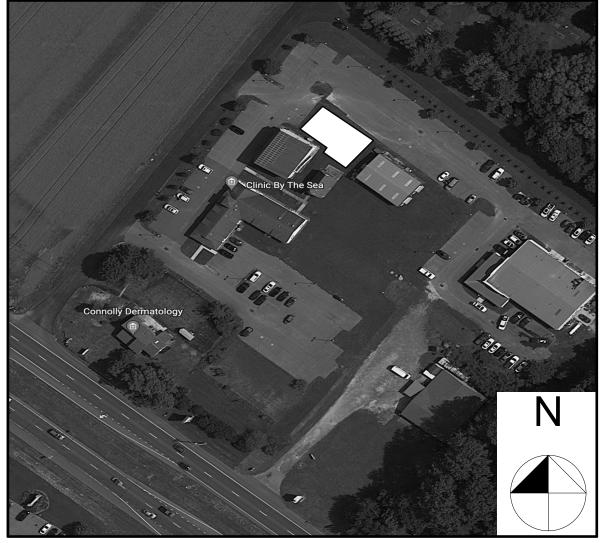

DESIGN TEAM

ARCHITECT:	STRUCTURAL EN
ARCHITECTURAL ALLIANCE, INC. 1309 VEALE RD SUITE 22 WILMINGTON, DE 19810	MACINTOSH 2 M SUIT WILMINGTO
MEP ENGINEER:	CONTRACTOR
BLAKE & VAUGHAN ENGINEERING, INC. 800 WOODLAWN AVE. WILMINGTON, DE 19803	DISABATINO 1 SOUT CL WILMINGT

LOCATION MAP

GENERAL	NOTES

ALL WORK SHALL CONFORM TO THE REQUIREMENTS OF ALL LOCAL LAWS, CODES 8. AND REGULATIONS OF ALL AUTHORITIES HAVING JURISDICTION. IN CASE OF CONFLICT BETWEEN REQUIREMENTS, THE MOST RESTRICTIVE SHALL APPLY. GENERAL CONTRACTOR SHALL ADHERE TO THE CONSTRUCTION DOCUMENTS AND SHALL COORDINATE THE REQUIREMENTS OF ANY AND ALL DRAWINGS INCLUDING BUT NOT LIMITED TO: ARCHITECTURAL, MECHANICAL, ELECTRICAL, PLUMBING, AND MILLWORK (CABINET) SKETCHES/DETAILS. A THOROUGH REVIEW OF THE DRAWINGS BY THE GENERAL CONTRACTOR IS CRITICAL TO ENSURE ACCURATE BID PRICING. ANY CONFLICTS OR INCONSISTENCIES REGARDING THE MEANING OR INTENT OF THE CONSTRUCTION DOCUMENTS SHALL IMMEDIATELY BE BROUGHT TO THE ATTENTION OF THE OWNER AND ARCHITECT PRIOR TO BID SUBMITTAL IN ORDER FOR CLARIFICATION. SUPPLEMENTAL INFORMATION CAN BE PROVIDED FOR SUBCONTRACTOR TO ACCURATELY SUPLY A BASE PRICE. UPON NOTIFICATION TO THE OWNER AND ARCHITECT, THE ARCHITECT WILL MAKE NECESSARY CLARIFICATION, OR REVISIONS AS REQUIRED. NO WORK SHALL BE

- PERFORMED PRIOR TO NOTIFYING OWNER AND ARCHITECT. THE GENERAL CONTRACTOR AND GENERAL CONTRACTOR'S SUBCONTRACTORS AND AGENTS SHALL HOLD ALL APPLICABLE AND REQUIRED LICENSES FOR THE JURISDICTION WHERE THE WORK WILL BE PERFORMED.
- THE CONTRACTOR IS RESPONSIBLE FOR TEMPORARY FACILITIES: WATER, ELECTRIC, 14. TOILET, DUMPSTER, JOB TRAILER, ETC.
- THE CONTRACTOR SHALL VERIFY ALL DRAWINGS FOR COORDINATION BETWEEN DIFFERENT TRADES. LOCATE BOLTS, SLEEVES, AND TRENCHES AS REQUIRED FOR MECHANICAL & ELECTRICAL TRADES AND PRVIDE AND/OR INSTALL ALL ITEMS NOT 15. SHOWN ON THESE DRAWINGS BUT REQUIRED FOR VARIOUS TRADES.
- MAINTAIN SAFE EXITING AND APPROPRIATE FIRE PREVENTION PROCEDURES, FOR 16. THE EXISTING BUILDING, AT ALL TIMES DURING THE CONSTRUCTION PROCESS. ALL WORK LISTED, SHOWN OR IMPLIED IN THE CONSTRUCTION DOCUMENTS, INCLUDING ALL COMPONENTS AND ACCESSORIES NOT SHOWN ON DRAWINGS, BUT THOSE REQUIRED TO COMPLETE PROJECT, SHALL BE SUPPLIED AND INSTALLED BY THE GENERAL CONTRACTOR EXCEPT WHERE OTHERWISE NOTED. THE GENERAL 17. CONTRACTOR SHALL COORDINATE THIS WITH ALL OTHER CONTRACTORS AND
- VENDORS FURNISHING LABOR, MATERIAL, ETC. ON THE PROJECT TO ENSURE THE WORK AS A WHOLE SHALL BE EXECUTED AND COMPLETED WITHOUT CONFLICT OR 18. DELAY. FOR ITEMS PROVIDED AND INSTALLED BY OTHERS OR GENERAL CONTRACTOR, IT IS THE RESPONSIBILITY OF THE GENERAL CONTRACTOR TO COMPLETELY COORDINATE ON MATTERS THAT AFFECT CRITICAL DATES OF THE CONSTRUCTION SCHEDULE.

GENERAL CONTRACTOR WILL ASSURE THAT ALL WORK IS DONE IN CONFORMANCE 20. WITH THE MANUFACTURER'S REQUIREMENTS.

GENERAL CONTRACTOR SHALL PROVIDE ADEQUATE PROTECTION OF WORK, MATERIALS, FIXTURES, ETC. FROM LOSS, DAMAGE, FIRE, THEFT, ETC. THIS SHALL INCLUDE PROTECTING THE EXISTING CONSTRUCTION AND REPAIRING ANY DAMAGE THAT OCCURS AS A RESULT OF THEIR OPERATIONS AT NO COST TO THE OWNER. BARRIERS TO NOISE, DUST, AND SECURITY BETWEEN CONSTRUCTION AREAS SHALL BE ERECTED, MAINTAINED AND REMOVED BY THE GENERAL CONTRACTOR. SUB CONTRACTOR SHALL BE RESPONSIBLE FOR ALL CUTTING, PATCHING AND

9.

10.

- 11. GENERAL CONTRACTOR SHALL NEVER SCALE DRAWINGS. LOCATIONS FOR ALL PARTITIONS, WALLS, CEILINGS, ETC. WILL BE DETERMINED BY DIMENSIONS ON THE DRAWINGS. ANY AREA OF THE PLANS REQUIRING ADDITIONAL DIMENSIONS MUST BE 24. REPORTED TO THE ARCHITECT IMMEDIATELY.
- DIMENSIONS ARE TO FACE OF ROUGH MATERIAL UNLESS NOTED OTHERWISE. 12. GENERAL CONTRACTOR SHALL VERIFY THE LOCATION OF ALL EXISTING UTILITIES IN 25. 13. THE FIELD, TO AVOID DAMAGING THEM DURING EXCAVATION. PROVIDE ADDITIONAL UTILITY SERVICE(S) AS REQUIRED TO MEET THE SCOPE AND INTENT OF THE WORK.
- SUB CONTRACTOR SHALL PROVIDE DRAFT/FIRE STOPS, AS REQ'D BY GOVERNING CODES AND JURISDICTIONS. NEW AND EXISTING PENETRATIONS IN FIRE-RATED PARTITIONS OR DRAFT STOPS SHALL BE PROTECTED BY A SYSTEM LISTED BY A RECOGNIZED TESTING AGENCY.
- PROVIDE FIRE EXTINGUISHERS PER APPLICABLE CODES. VERIFY FINAL LOCATION WITH THE FIRE MARSHAL.
- GENERAL CONTRACTOR SHALL REVIEW THE DIMENSIONS OF ALL EQUIPMENT IN THE PROJECT REGARDLESS OF THE SOURCE AND COORDINATE ACCESS TO THE SPACE, PROVIDE APPROPRIATE CLEARANCES TO ENSURE EASE OF INSTALLATION, VERIFY APPROPRIATE CLEARANCES FOR MAINTENANCE IS PROVIDED, AND ADDRESS ISSUES THAT INVOLVE CONFLICTING UTILITIES.
- PROVIDE AND INSTALL ALL NECESSARY IN-WALL FRAMING / WOOD BLOCKING REQUIRED TO CARRY SHELF, HANGING, AND VALANCE LOADS, RAILINGS, PER plans.
- PROVIDE CLEAR SILICONE SEALANT AT ALL JOINTS AND INTERFACES OF ALL COUNTERTOPS.
- ALL JOINTS AND OTHER OPENINGS IN THE BUILDING ENVELOPE SHALL BE SEALED IN 19. ACCORDANCE WITH THE BUILDING CODE AND ENERGY CODE.


ARCHITECT		AWINGS		APPLICABLE BUILDING CODE	SECTIC
DWG NO.	DATE	REV. NO. REV. DATE	DRAWING TITLE	TYPE OF OCCUPANCY	309/3
T0.01	04.11.22		TITLE SHEET	TYPE OF CONSTRUCTION	IBC 60
T0.02			LIFE SAFETY PLAN	ALLOWABLE BUILDING HT	T504.3
D0.01			DEMO PLAN	ALLOWABLE S.F. / FLOOR	T506.2
A1.01			PROPOSED FLOOR PLAN	·	
A1.02			ROOF PLAN	SPRINKLER SYSTEM	T506.2
A1.03			REFLECTED CEILING PLAN	ACCESSIBILITY CODE	1101.:
A2.01			ENLARGED PLANS	ROOF SLOPE	1507.
A3.01			EXTERIOR ELEVATIONS	OCCUPANCY LOAD:	T1004
A4.01			WINDOW & DOOR SCHEDULES	PLUMBING FIXTURES	T2902
A4.02			FINISH PLAN & FINISH SCHEDULE		
A4.03					
A5.01			BUILDING SECTION		
A5.02 A6.01			BUILDING SECTION WALL SECTIONS		
A6.01 A6.02			WALL SECTIONS WALL SECTIONS		
A7.01			DETAILS		
STRUCTURA		NGS		EGRESS WIDTH	1005.1
				TRAVEL DISTANCE:	T1017
				EXIT SEPARATION DISTANCE:	1007.1
				DEAD-END COORIDORS:	1020.4
				EXPOSED INSULATION:	720.3
				BEARING WALLS EXT. & INT. RATING	TABLE
MECHANIC	AL DRAW	lings		STRUCTURAL FRAME	TABLE
				FLOOR CONSTRUCTION	TABLE
				ROOF CONSTRUCTION	TABLE
				FIRE RESISTANCE RATING	TABLE
PLUMBING		GS			
				ACCESSIBILITY ENTRANCES	1105.1
ELECTRICA	L DRAWIN	IGS			
	1				

CHANICAL ZZANINE TAL DT TO SCALE I CENTER POSITE HAND ERHEAD DOOR ENING NTED WOOD NFORCING OF DRAIN UPPER DRAIN LID CORE WOOD DOOR CTION EET UCTURAL P OF (STEEL/ SLAB) P OF WALL ICAL LESS NOTED OTHERWISE STIBULE RIFY IN FIELD DPING DT IN CONTRACT IGLE

AMETER

NTERLINE

ATE

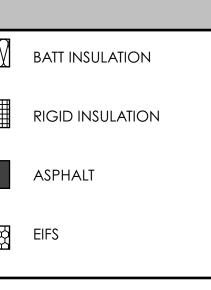

NGINEER:

H ENGINEERING MILL RD. JITE #10 TON, DE 19806

R:

) CONSTRUCTION CLEVELAND AVE GTON, DE 19805

21. 22. 23. FITTING NECESSARY TO ACHIEVE THE INTENT OF THE CONSTRUCTION DOCUMENTS.

27.

26.

ALL WOOD IN CONTACT WITH CONCRETE MASONRY SHALL BE PRESSURE TREATED, MOISTURE RESISTANT WOOD. ALL WOOD TRIM OR OTHER PRE-FINISHED TRIM ITEMS SHALL BE

CUT TO FIT AND RAW, EXPOSED SURFACES SHALL BE FINISHED TO MATCH ADJACENT FINISH MATERIALS. SUB CONTRACTOR TO PROVIDE ATTIC STOCK OF FINISH MATERIALS 3% OF TOTAL INSTALLATION OR MINIMUM OF 1 BOX. ALL SURFACES WHICH ARE INDICATED TO BE FINISHED OR

PAINTED SHALL BE PREPARED, SANDED, TREATED, AND PRIMED IN STRICT ACCORDANCE WITH COMMERCIAL QUALITY STANDARDS, AND IN STRICT ACCORDANCE WITH FINISH MATERIAL MANUFACTURER'S INSTRUCTIONS. ALL FINISH SURFACES PENETRATED SUCH AS CEILING TILES AND MILLWORK COUNTERS FOR ANY REASON MUST HAVE AN ASSOCIATED GROMMET APPROVED FOR THAT USE. PROVIDE OCCUPANCY SIGNS IN A CONSPICUOUS LOCATION IN ACCORDANCE WITH STATE & LOCAL CODES. DESIGN TO BE

APPROVED BY ARCHITECT. PROVIDE PERMANENT SIGNAGE ON ALL HABITABLE ROOMS, TOILETS, AND EXITS. SIGNAGE SHALL COMPLY WITH ANSI STANDARDS AND PROVIDE BOTH TEXT AND BRAILLE. PROVIDE PICTOGRAMS ON TOILET ROOM SIGNAGE. GENERAL CONTRACTOR SHALL PROVIDE ALL NECESSARY

BRACING TO STRUCTURE FOR INTERIOR PARTITIONS, SOFFITS, CEILINGS, PLATFORMS, ETC. WHETHER SHOWN ON THE DRAWINGS OR NOT.

GENERAL CONTRACTOR TO COVER AND PROTECT ALL EQUIPMENT AND SYSTEMS INSTALLED PRIOR TO FINAL CLEAN WITH PLASTIC SHEATHING


28. ALL REQUESTS FOR INFORMATION OR CLARIFICATION MUST BE SUBMITTED IN WRITING (VIA EMAIL) TO THE OWNER. THE OWNER WILL NOT RESPOND TO REQUEST FOR INFORMATION OR CLARIFICATIONS DURING CONSTRUCTION COMING DIRECTLY FROM

SUBCONTRACTORS, VENDORS, ETC. THESE ITEMS MUST BE ROUTED THROUGH GENERAL CONTRACTOR TO THE PROJECT MANAGER TO ENSURE A COMPLETE REVIEW WITH ALL TRADES.


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SEAL DATE- 4/11/22 **REGISTRATION EXPIRES- 1/31/24** The professional services of the architect are undertaken for and are performed in the interest of the owner. No contractual obligation is assumed by the architect for the benefit of any other person involved in the project. ARCHITECTURAL ALLIANCE ARCHITECTURE • PLANNING INTERIOR DESIGN • GRAPHIC ART 1309 VEALE ROAD SUITE 22 WILMINGTON, DE 19810 302.478.3777 256 EAGLEVIEW BLVD SUITE 194 EXTON, PA 19341 610.640.9000 **ISSUED FOR REVIEW** PROJECT NAME WILLOW CREEK PLAZA BUILDING 4 U.S. Route 40 New Castle County, DE MARK DATE DESCRIPTION REVISIONS PROJECT NO: 2021-184 DRAWN BY: RLR CHK'D BY: KWW DATE: 04.06.22 © COPYRIGHT 2021 TITLE SHEET DRAWING NUMBER T1.01


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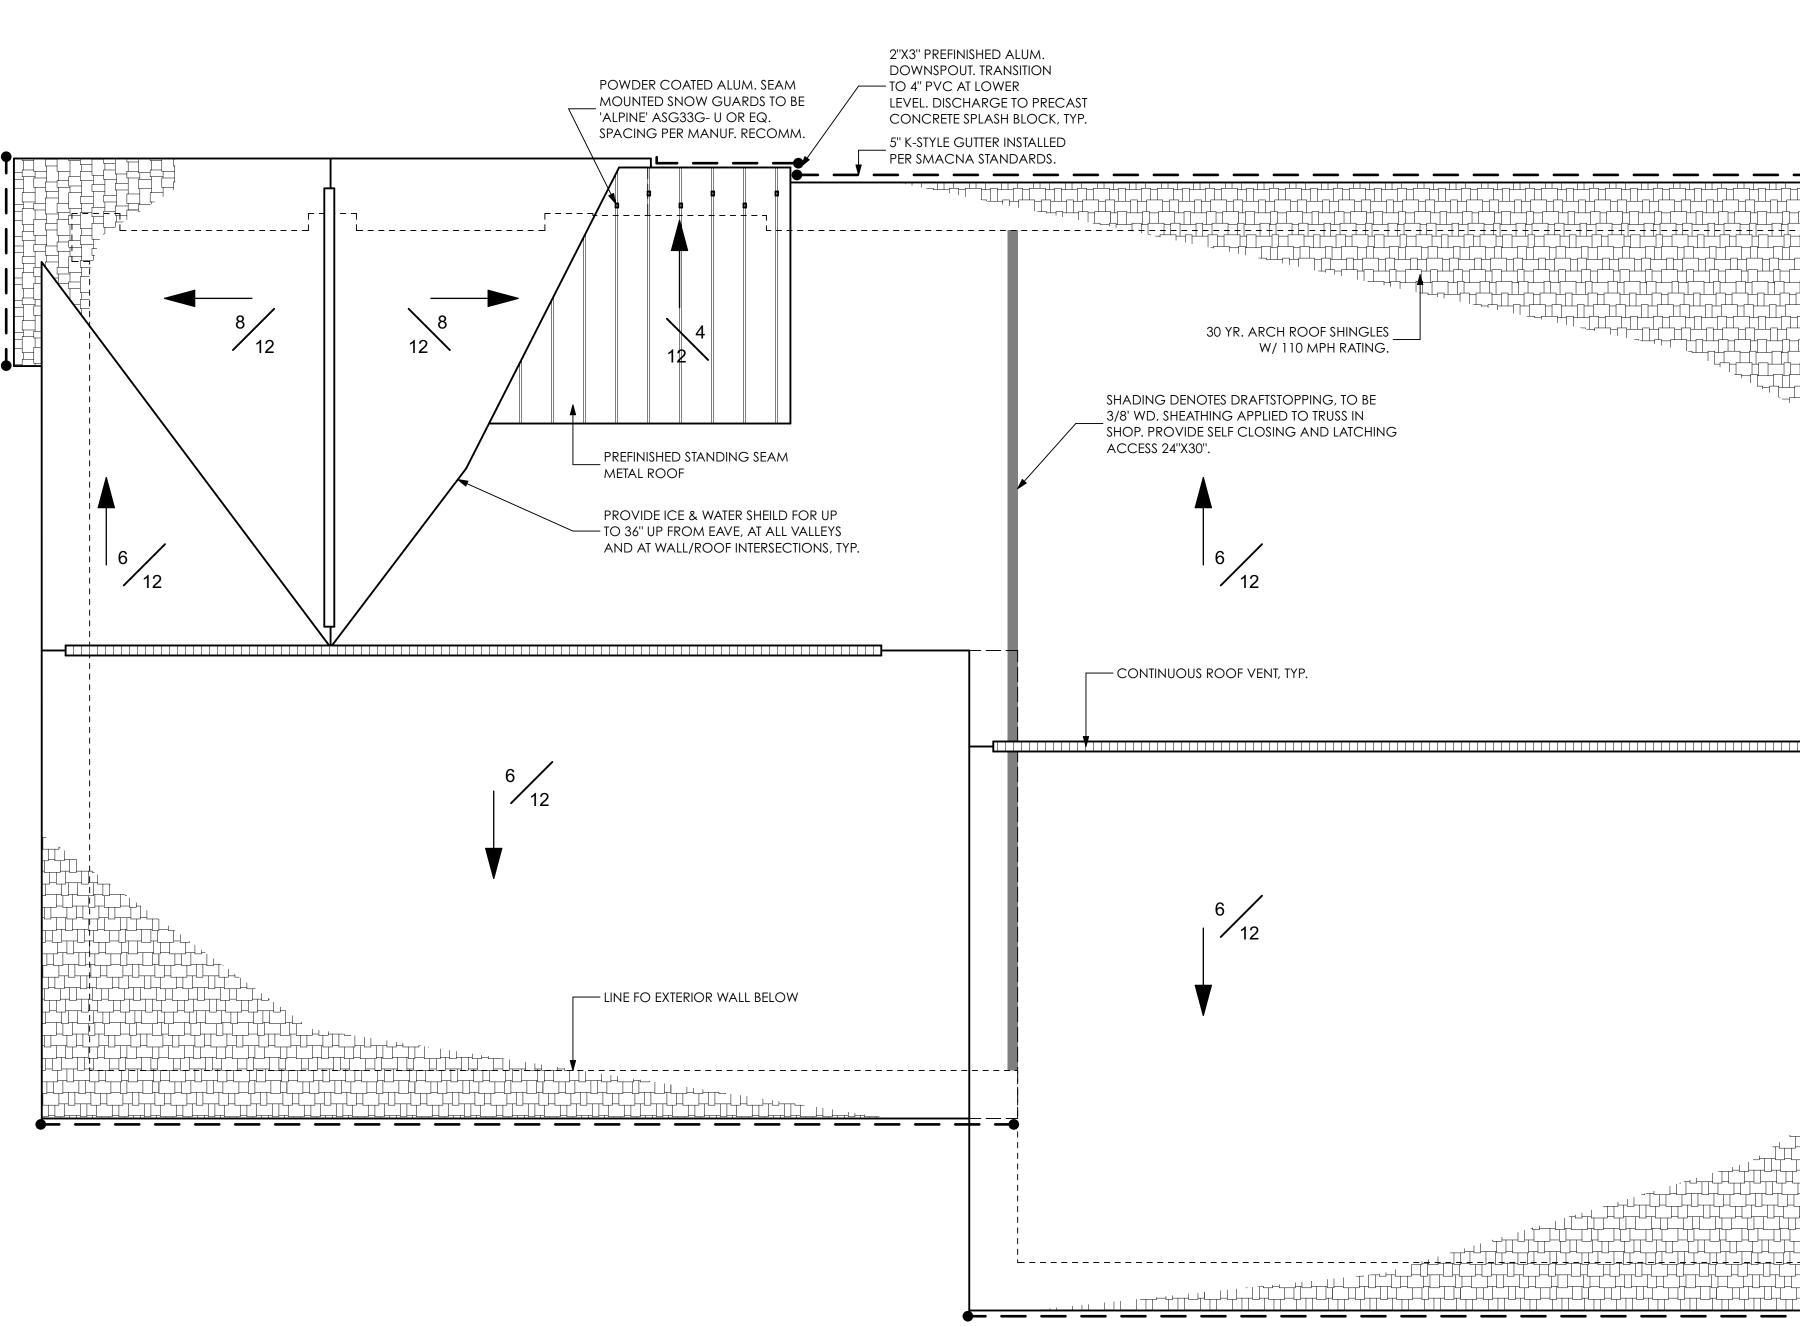


EGRESS PLAN L	EGEND	SEAL
()►	EGRESS PATH	
		SEAL DATE- 4/11/22 REGISTRATION EXPIRES- 1/31/24
		The professional services of the architect are undertaken for and are performed in the interest of the owner.
		No contractual obligation is assumed by the architect for the benefit of any other person involved in the project.
		ARCHITECTURAL Alliance
		ARCHITECTURE • PLANNING
		INTERIOR DESIGN · GRAPHIC ARTS
		SUITE 22 WILMINGTON, DE 19810 302.478.3777
		256 EAGLEVIEW BLVD
		SUITE 194 EXTON, PA 19341 610.640.9000
		ISSUED FOR REVIEW
		PROJECT NAME
		WILLOW CREEK
		PLAZA BUILDING 4
		U.S. Route 40
		New Castle County, DE
		MARK DATE DESCRIPTION
		REVISIONS
		PROJECT NO: 2021-184 DRAWN BY: RLR
		CHK'D BY: KWW DATE: 04.06.22
		© COPYRIGHT 2021
		TITLE SHEET DRAWING NUMBER
		T1.02

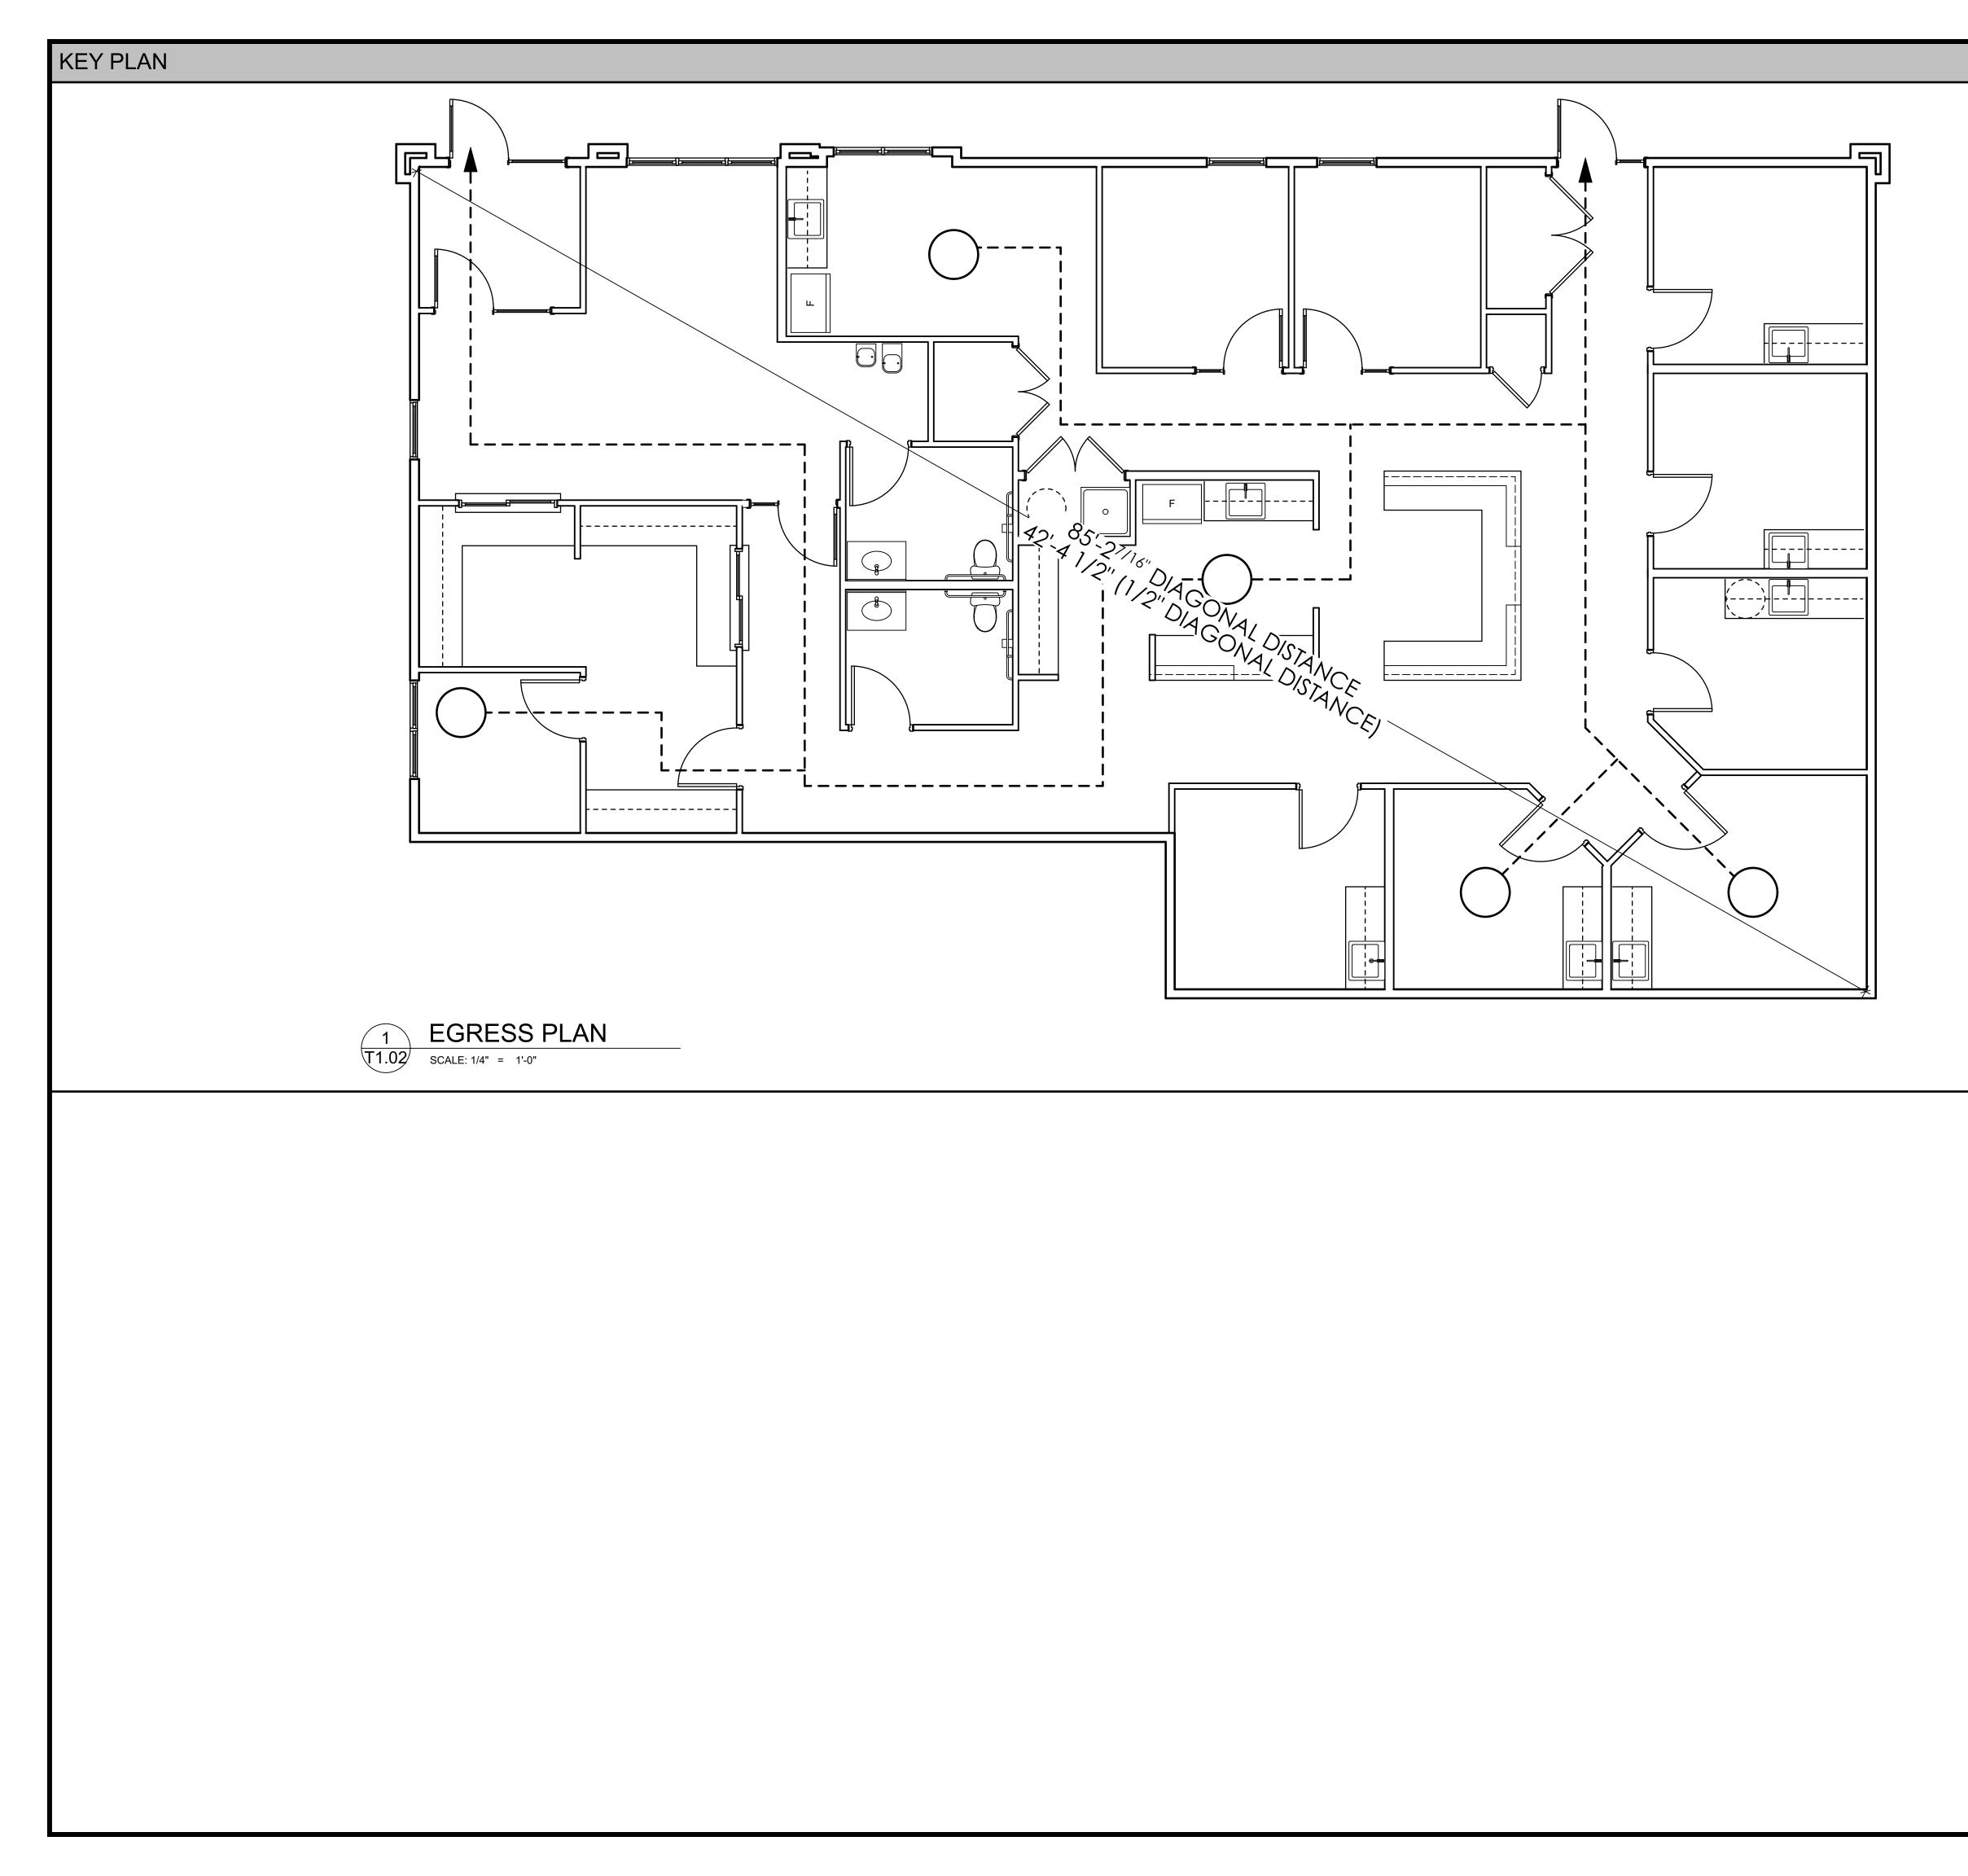



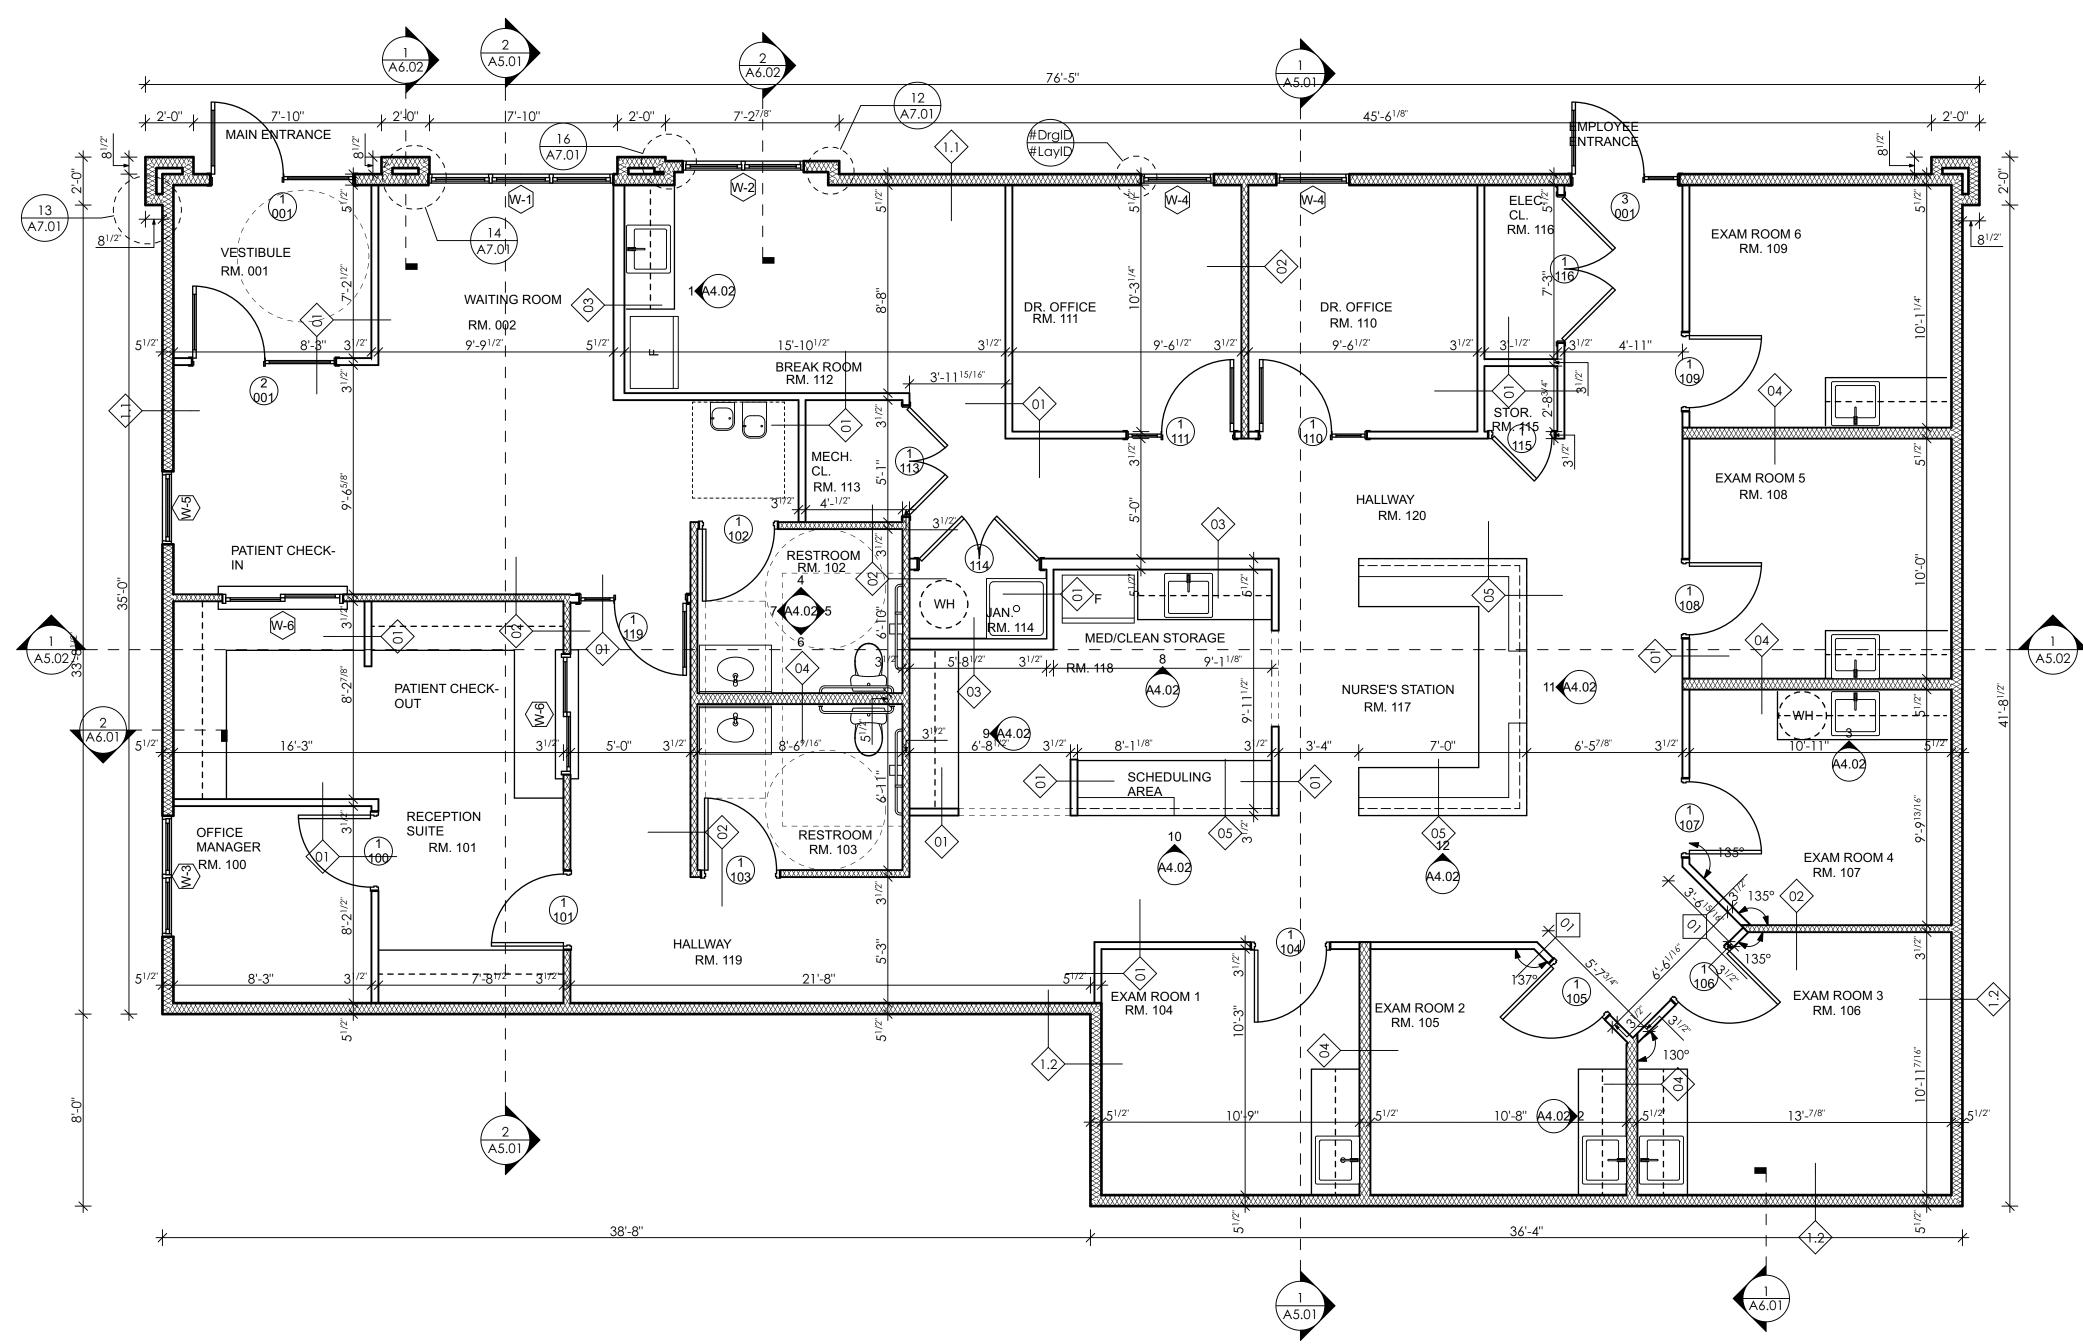


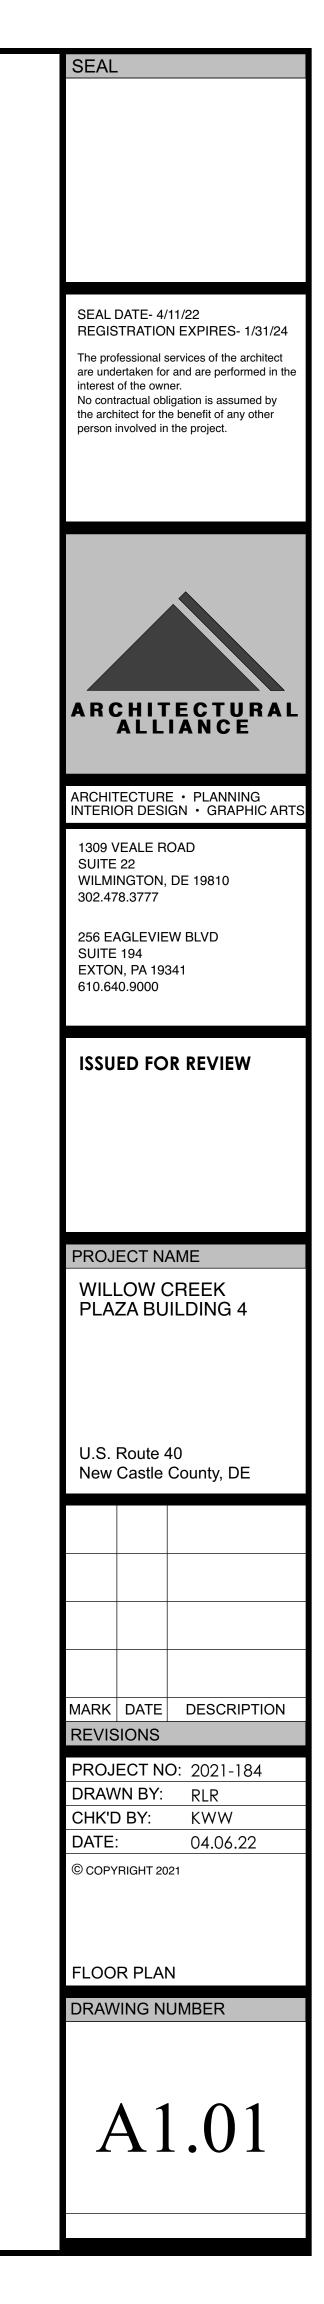




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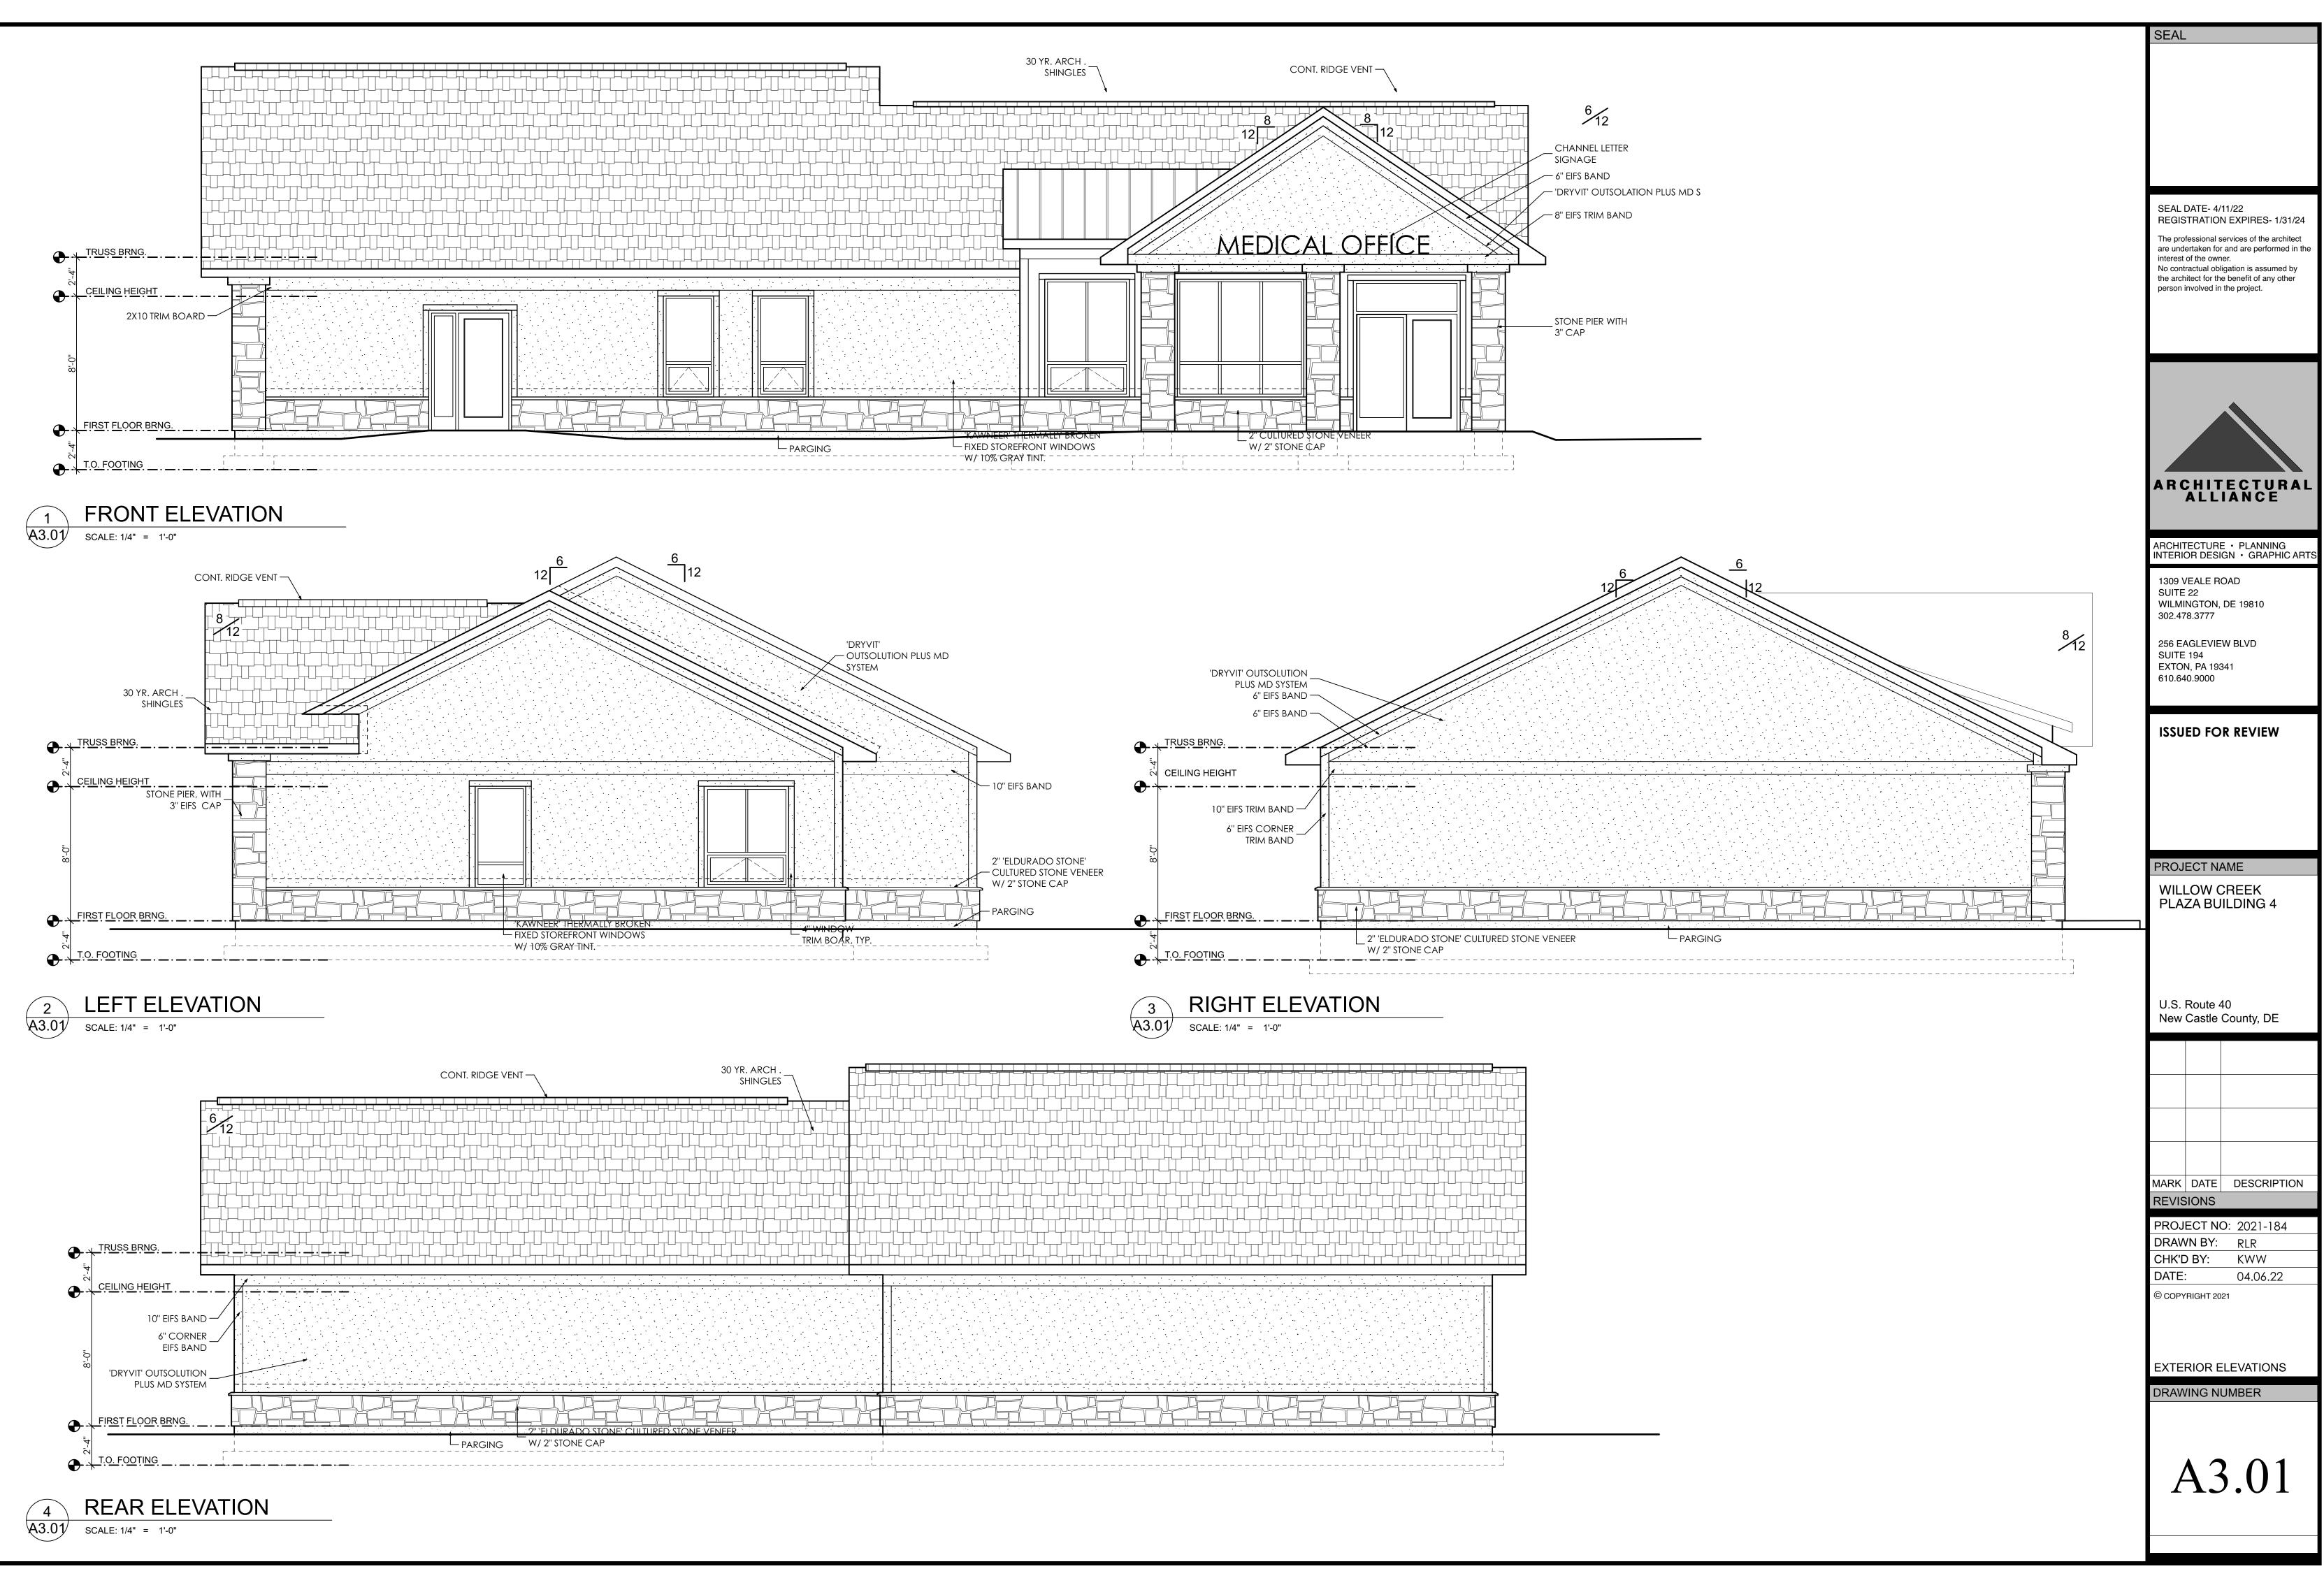



1 CEILING PLAN A1.03 SCALE: 1/4" = 1'-0"

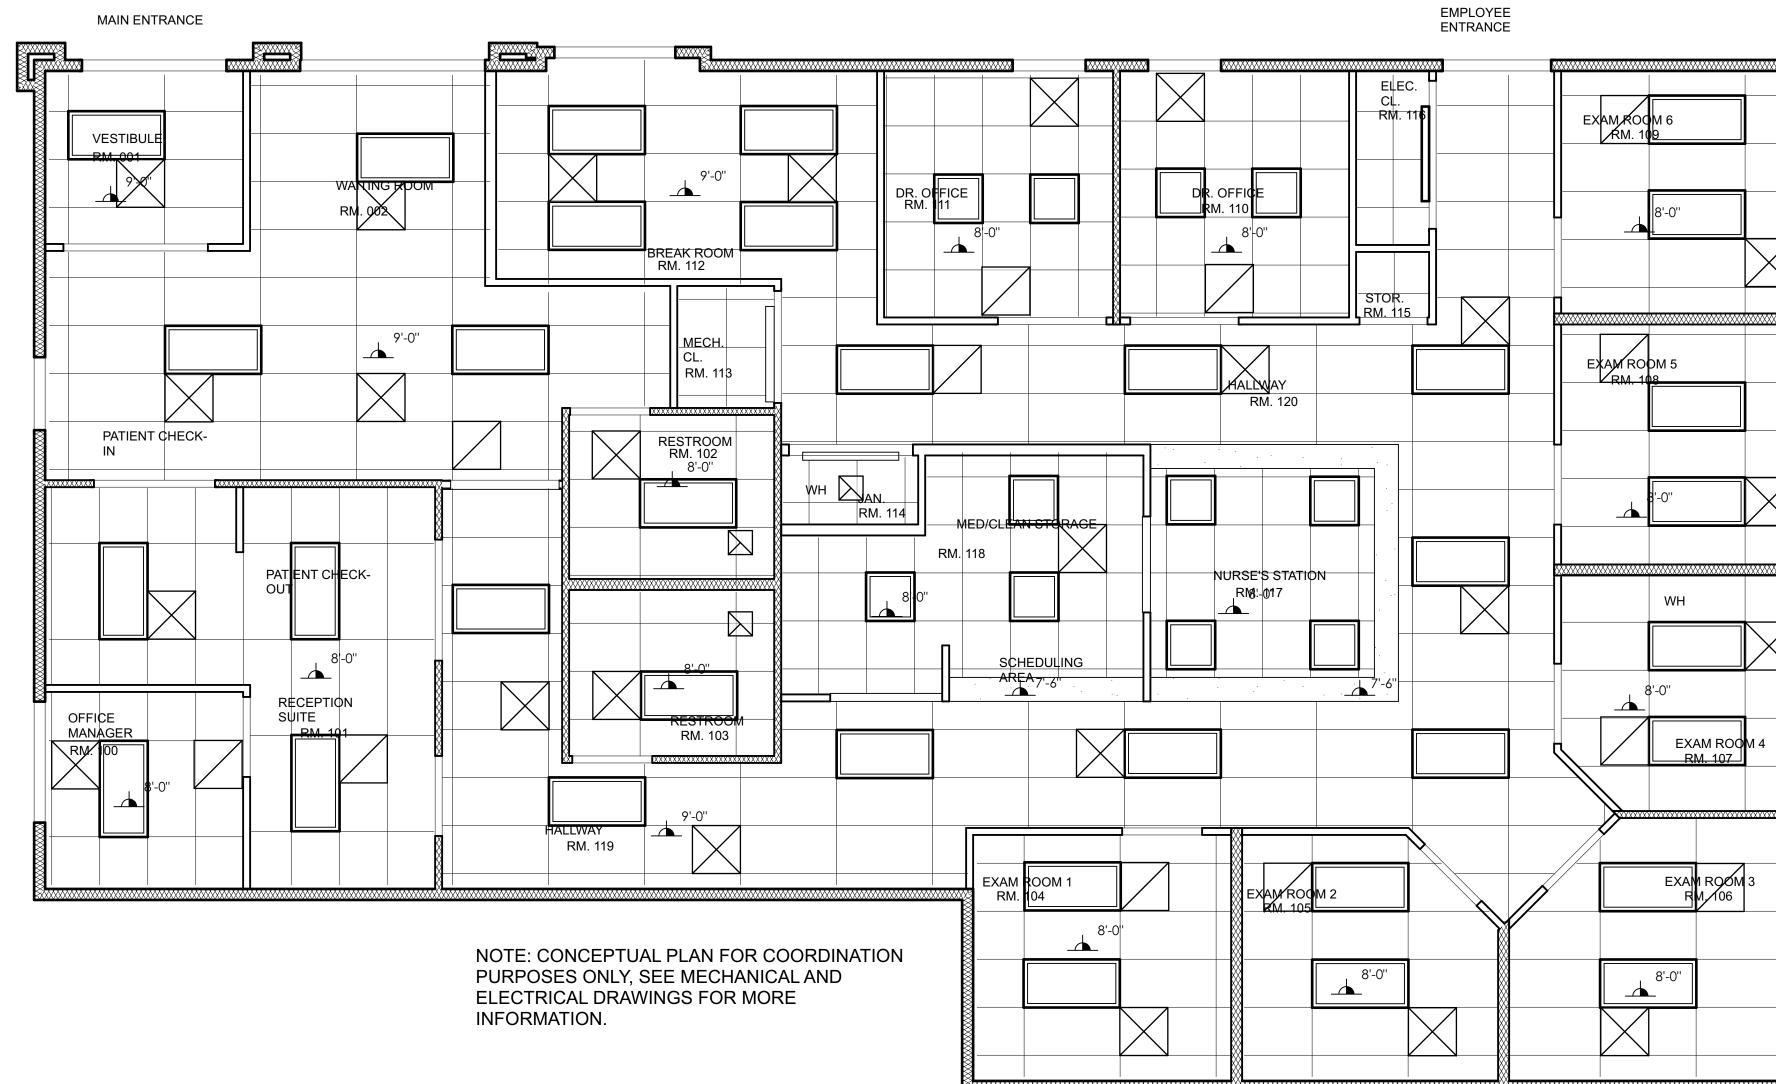


REFLECTED CEILING PLAN LEGEND		
	2'X4' LED CEILING FIXTURE	
	2'X2' LED CEILING FIXTURE	
0	6" RECESSED CAN FIXTURE	
0	4" RECESSED CAN FIXTURE	
	LED WALL FIXTURE	
	MECH. SUPPLY DIFFUSER	
	MECH. SUPPLY DIFFUSER	
	MECH. RETURN DIFFUSER	


SEAL
SEAL DATE- 4/11/22 REGISTRATION EXPIRES- 1/31/24 The professional services of the architect are undertaken for and are performed in the interest of the owner. No contractual obligation is assumed by the architect for the benefit of any other person involved in the project.
ARCHITECTURAL ALLIANCE
ARCHITECTURE • PLANNING INTERIOR DESIGN • GRAPHIC ARTS
1309 VEALE ROAD SUITE 22 WILMINGTON, DE 19810 302.478.3777 256 EAGLEVIEW BLVD
SUITE 194 EXTON, PA 19341 610.640.9000
ISSUED FOR REVIEW
WILLOW CREEK PLAZA BUILDING 4
U.S. Route 40 New Castle County, DE
MARK DATE DESCRIPTION REVISIONS
PROJECT NO: 2021-184
DRAWN BY: RLR CHK'D BY: KWW
DATE: 04.06.22 © COPYRIGHT 2021
CEILING PLAN
DRAWING NUMBER
A1.03

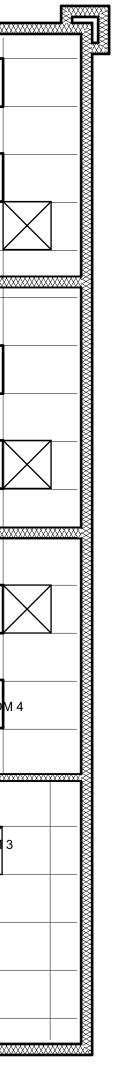


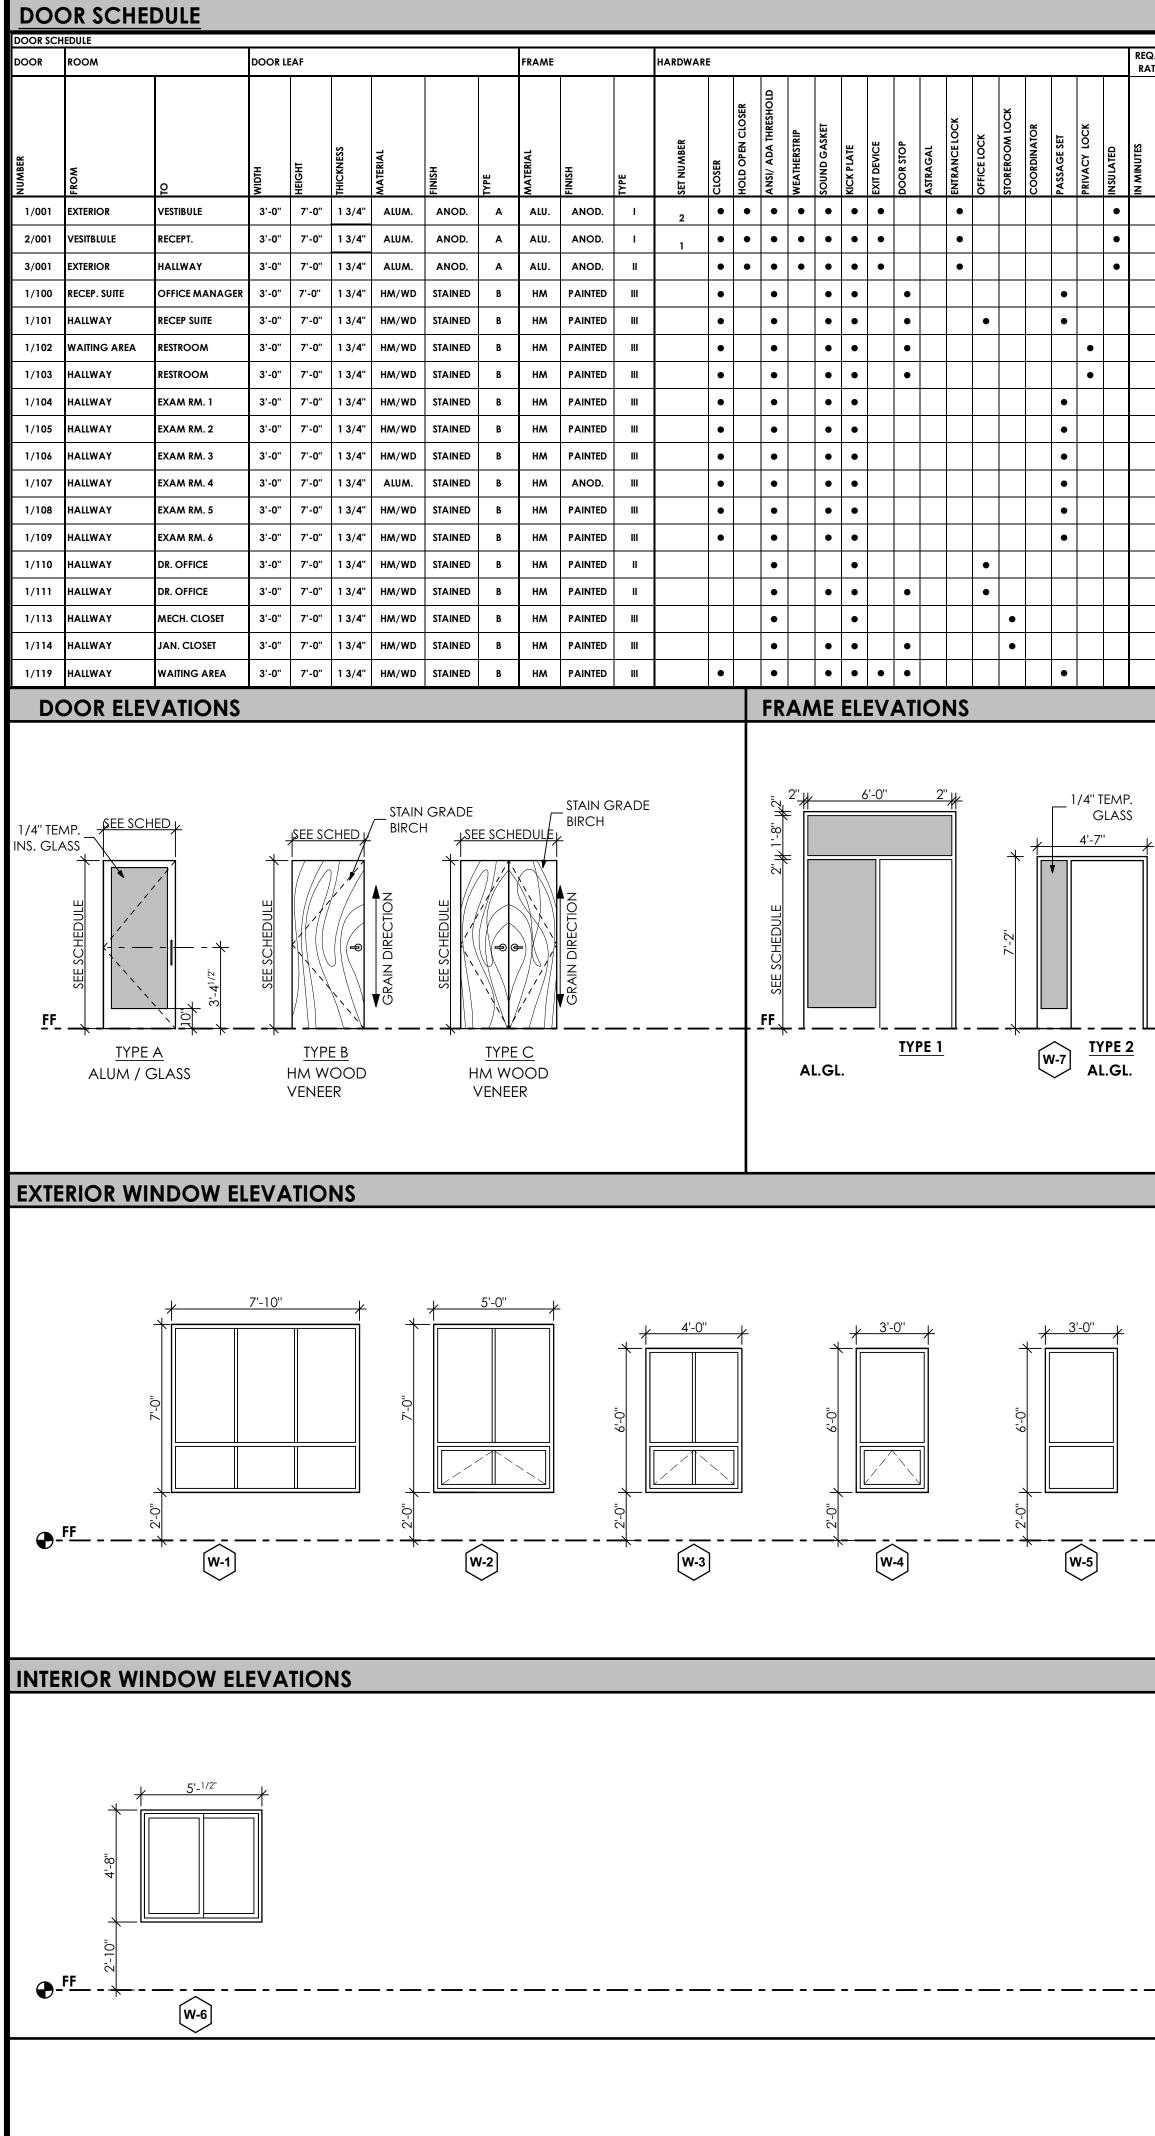


	DOOR NOTES	EXTERIOR WALL SCHEDULE
REQ. FIRE	1. ALL HANDLE TO BE LEVER TYPE U.N.O.	WALL NOTES:
	2. STOREFRONT DOORS: 'KAWNEER' MEDIUM STILE ENTRY DOOR OR EQUAL W/ FACTORY 70% KYRAN FINISH IN LIGHT SEQUIN.	GWB AT KITCHEN WALLS AND CEILING TO BE M (PURPLE BOARD)
N N N N N N N N N N N N N N N N N N N	양3.PROVIDE 'KAWNEER' 'ARCHITECURAL CLASSIC' PULL HANDLE AND별PUSH BAR ON STOREFRONT DOORS.	GWB AT WET WALLS TO BE MOLD/ MOISTURE RE REFER TO UL LISTING FOR RATED WALLS FOR AP FASTED WALLS FOR AP
ROOM ROOM PICTOG	4. PROVIDE NON-REMOVEABLE HINGES ON EXTERIOR DOORS.	FASTENING, INSTALLATION REQUIREMENTS AND
	• 4. •	 EXTERIOR WALLS UNDER ROOF TO BE FULLY INSU ALL WALLS TO BE FIRE BLOCKED PER CODE.
	PROVIDE 18GA WOOD VENEER HOLLOW METAL DOORS WITH 16 GA	PROVIDE BLOCKING FOR ALL CABINETS, GRAB ANSI TYPE B UNITS (ALL) SHALL RECEIVE BLOCKI
SECURITY ACESS CONTROL • • • • SECURITY ACESS CONTROL • • • • •	FRAMES. ALL HM DOORS TO BE SHOP PRIMED AND FIELD STAINED, ALL FRAMES TO BE SHOP PRIMED AND FILED PAINTED, U.N.O. EXTERIOR DOORS AND FRAMES TO BE GALVANIZED.	NOTE: SEE FINISH PLAN AND FINISH SCHEDULE FINFORMATION/ MATERIALS
	7. DOORS TO BE READILY OPERABLE FROM EGRESS SIDE WITHOUT THE USE OF A KEY OR SPECIAL KNOWLEDGE OR EFFORT.	SEAL ALL EXTERIOR WALL PENETRATIONS PER WI SEE STRUCTURAL DRAWINGS FOR STUD SIZE AND
• • • • • • • • •	8. DOOR OPENING HARDWARE MUST BE OPERATED BY A SINGLE HAND WITHOUT MEANS OF TIGHT GRASPING, PINCHING OR TWISTING OF	CI G
	 WRIST. 9. THE MAXIMUM FORCE FOR PULLING OR PUSHING OPEN INTERIOR / 	RA SE
SECUIRTY ACCESS CONTROL • • SECUIRTY ACCESS CONTROL • •	EXTERIOR DOORS EXCEPT FIRE DOORS SHALL BE 5 LBS. 10. SWINGING DOORS TO MAINTAIN 32" CLEAR WIDTH MEASURED	DF PL M
	BETWEEN THE FACE OF THE DOOR AND THE STOP, WITH THE DOOR OPEN AT 90 DEGREES.	EXTERIOR 1/ PL
• •	 WHERE CHANGES IN LEVEL IS 1/4" MINIMUM TO 1/2" MAXIMUM THRESHOLDS/ TRANSITIONS STRIPS SHALL BE BEVELED WITH A SLOPE NOT STEEPER THAN 1:2 	R-21 FOIL-FACED BATT INSULATION FLAME SPREAD 100 OR LESS.
	12. CONTRACTOR TO REVIEW HARDWARE W/ A QUALIFIED HARDWARE SPECIALIST W/ TENANT FOR APPROVAL.	2X6 WD STUDS @ 16" O.C. CONTINUOUS SPRAY OR ROLL ON WATERPROOFING MEMBRANE
2" <u>#SEE SCHED#</u> 2"		WALL TYPE 1.1
		G
SCHEDULE		EXTERIOR 1/
S EE S EE		1"
<u> </u>		R-21 FOIL-FACED BATT INSULATION FLAME SPREAD 100 OR LESS.
		CONTINUOUS SPRAY OR ROLL ON WATERPROOFING MEMBRANE
		WALL TYPE 1.3
	EXTERIOR WINDOW NOTES 1. WINDOWS SHALL BE 'KAWNEER' TRIFAB 451T STOREFRONT SYSTEMS,	
	U.N.O. 2. ALL ALUMINUM FRAMES TO BE THERMALLY BROKEN W/ FACTORY 70%	INTERIOR WALL SCHEDULE
	 KYNAR FINISH. ALL WINDOWS TO BE 1" CLEAR GLASS W/ 25% GREY TINT, . 	
	 ALL WINDOWS TO BE F CLEAK GLASS W/ 25% GRET HIN, . CONTRACTOR TO FIELD VERIFY ALL WINDOW DIMENSIONS & ROUGH OPENING SIZES. 	5/8" GWB, PTD.
	 MANUFACTURER SHALL VERIFY ALL NEW FIXED FENESTRATION ASSEMBLIES SHOWN COMPLY WITH THE ENERGY CODE MINIMUM 	▼ ⁺
	 U-VALUE OF 0.38 OR BETTER & A MINIMUM SHGC VALUE OF 0.40 OR BETTER, TYP. 6. ALL METAL FINISH TO BE PERMADZE® HARDCOAT FINISH IN LIGHT 	└── 5/8" GWB, PTD.
	 SEQUIN 7. ALL GLASS OVER 5.7 S.F. OR WITHIN 18" A.F.F. SHALL BE TEMPERED 	WALL TYPE 1
	SAFETY GLASS.	
	INTERIOR WINDOW NOTES	
		- 1/2" GWB, PTD. - ↓ - ↓ - ↓ - ↓ - ↓ - ↓ - ↓ - ↓ - ↓ - ↓
		WALL TYPE 2
		3" SOUND INSULATION
		2X4 WD STUDS @ 16" O.C. 5/8" GWB, PTD.
		WALL TYPE 4
		** <i>*</i> **E E **

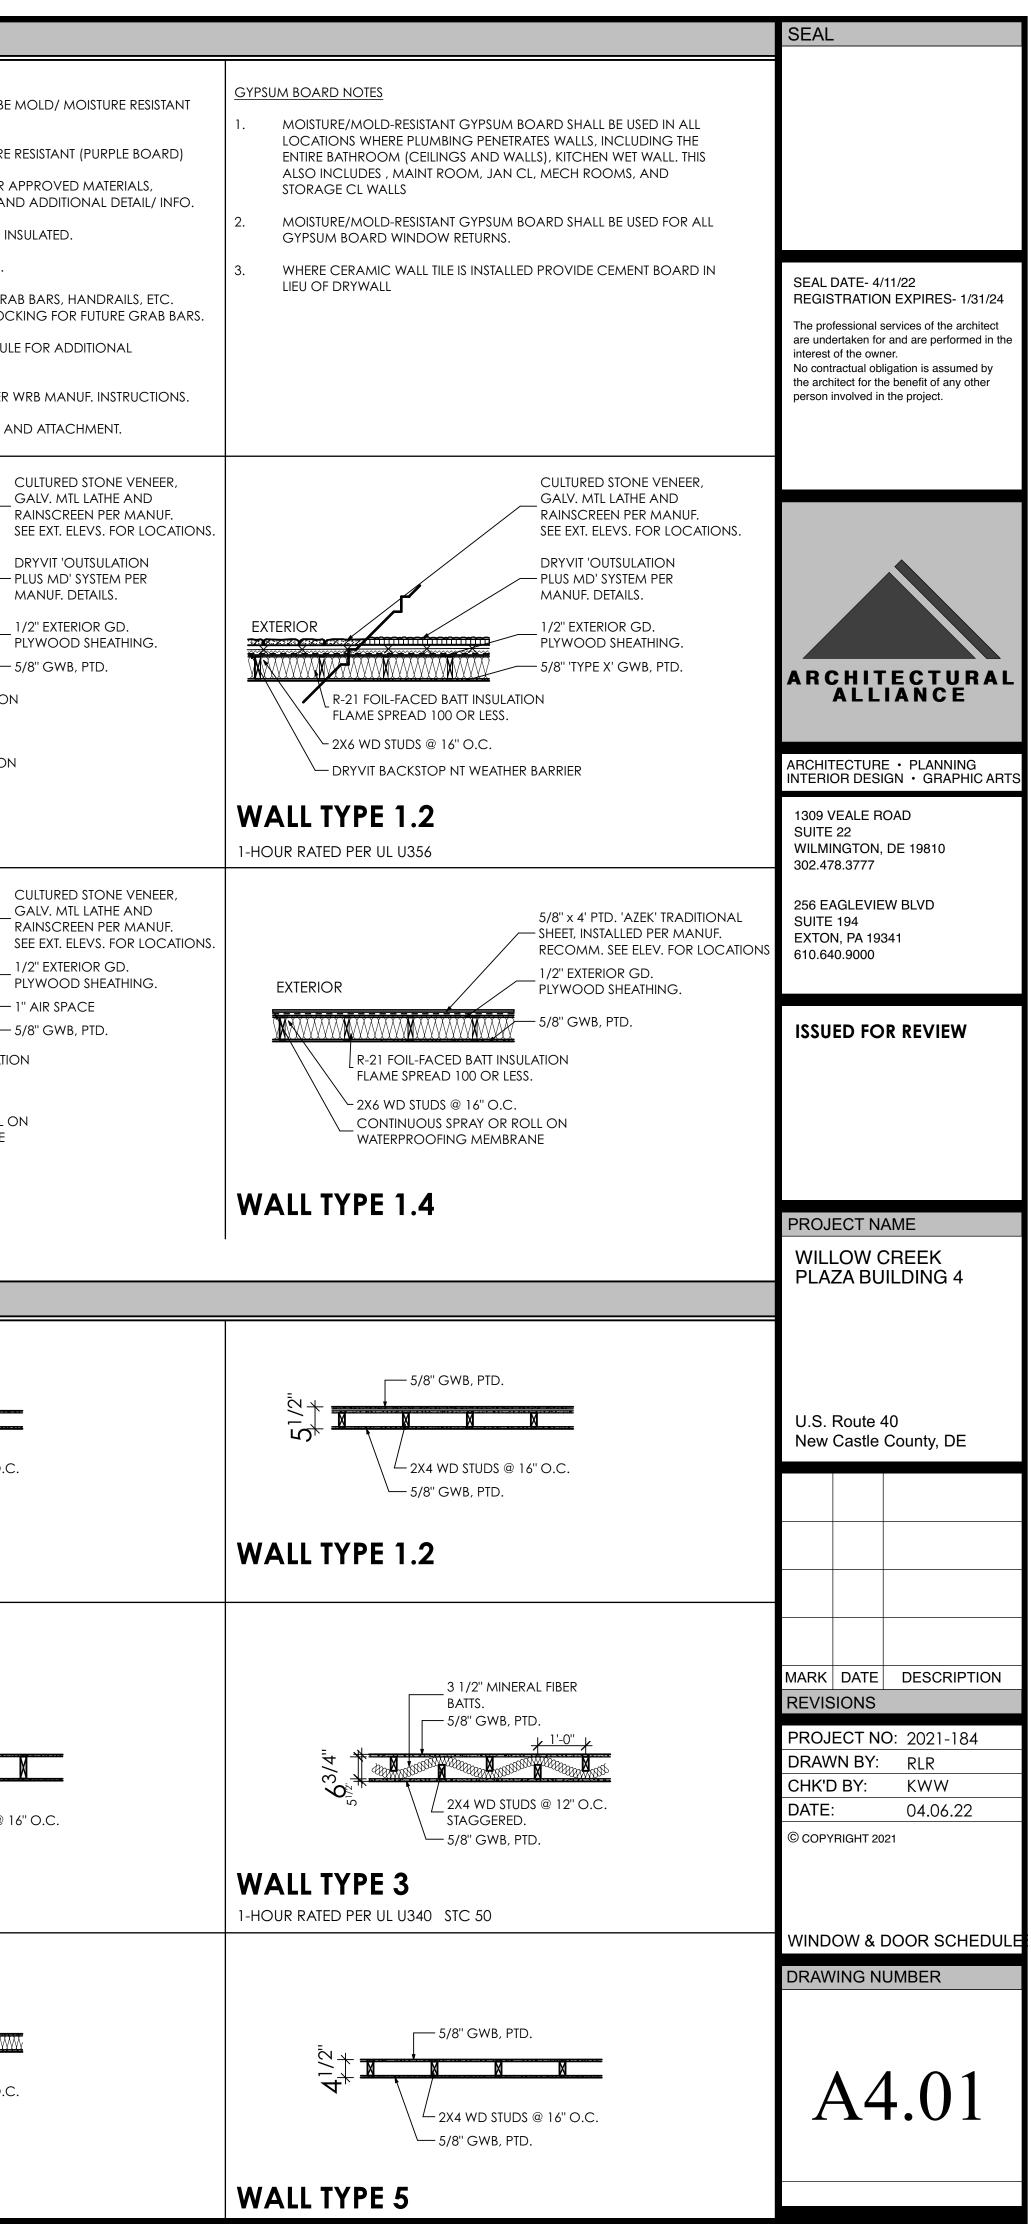

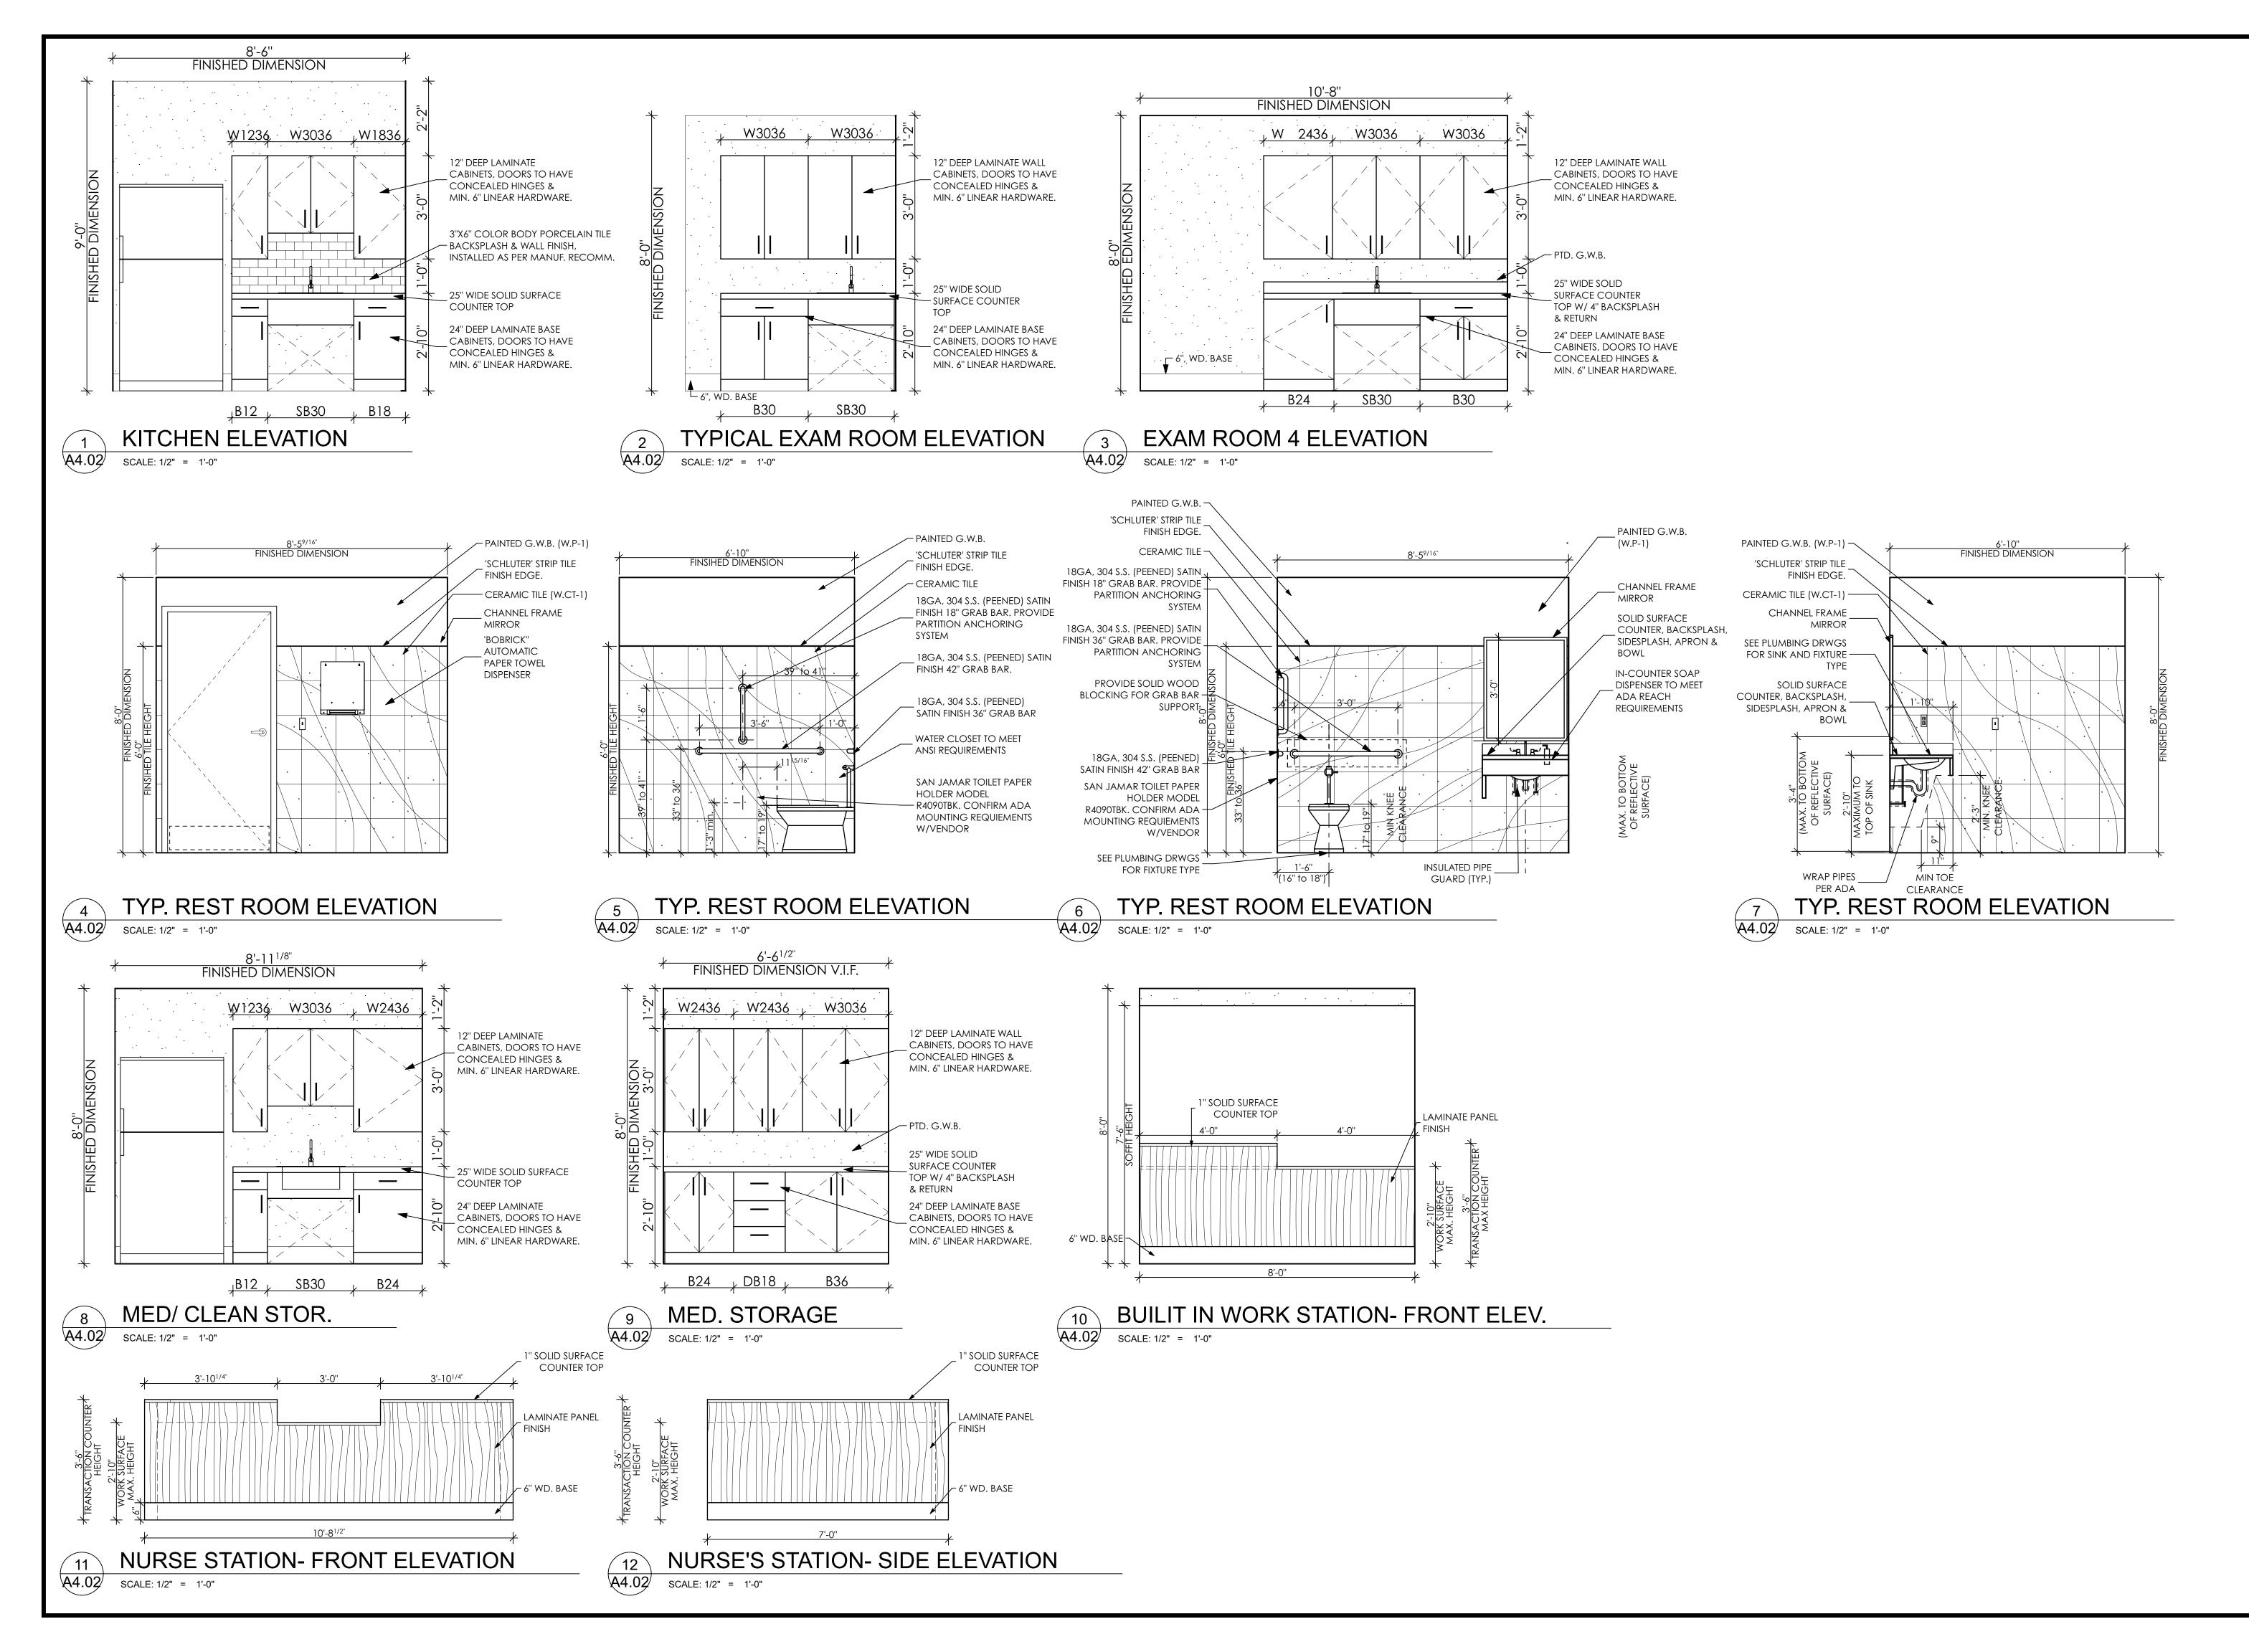

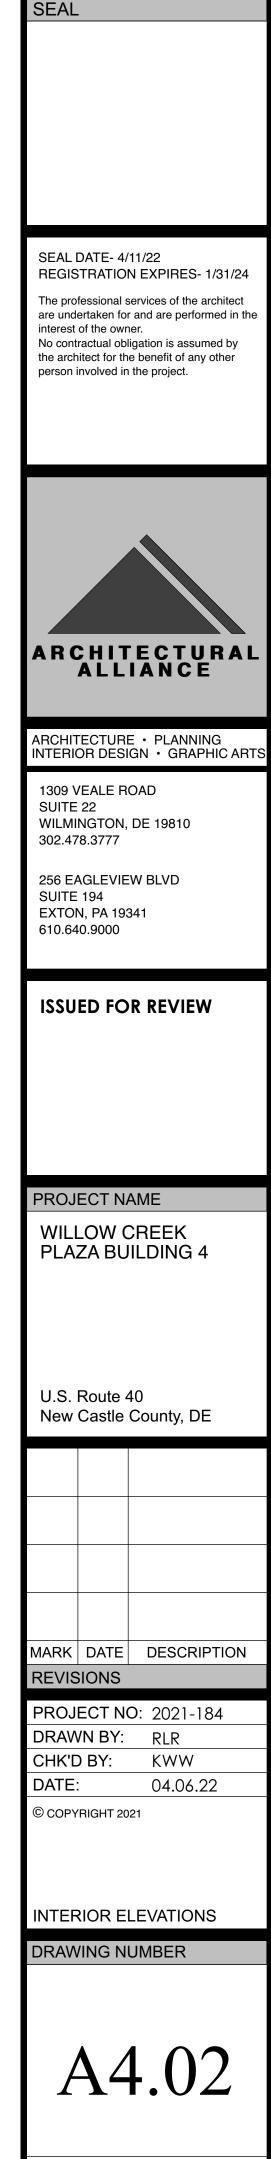

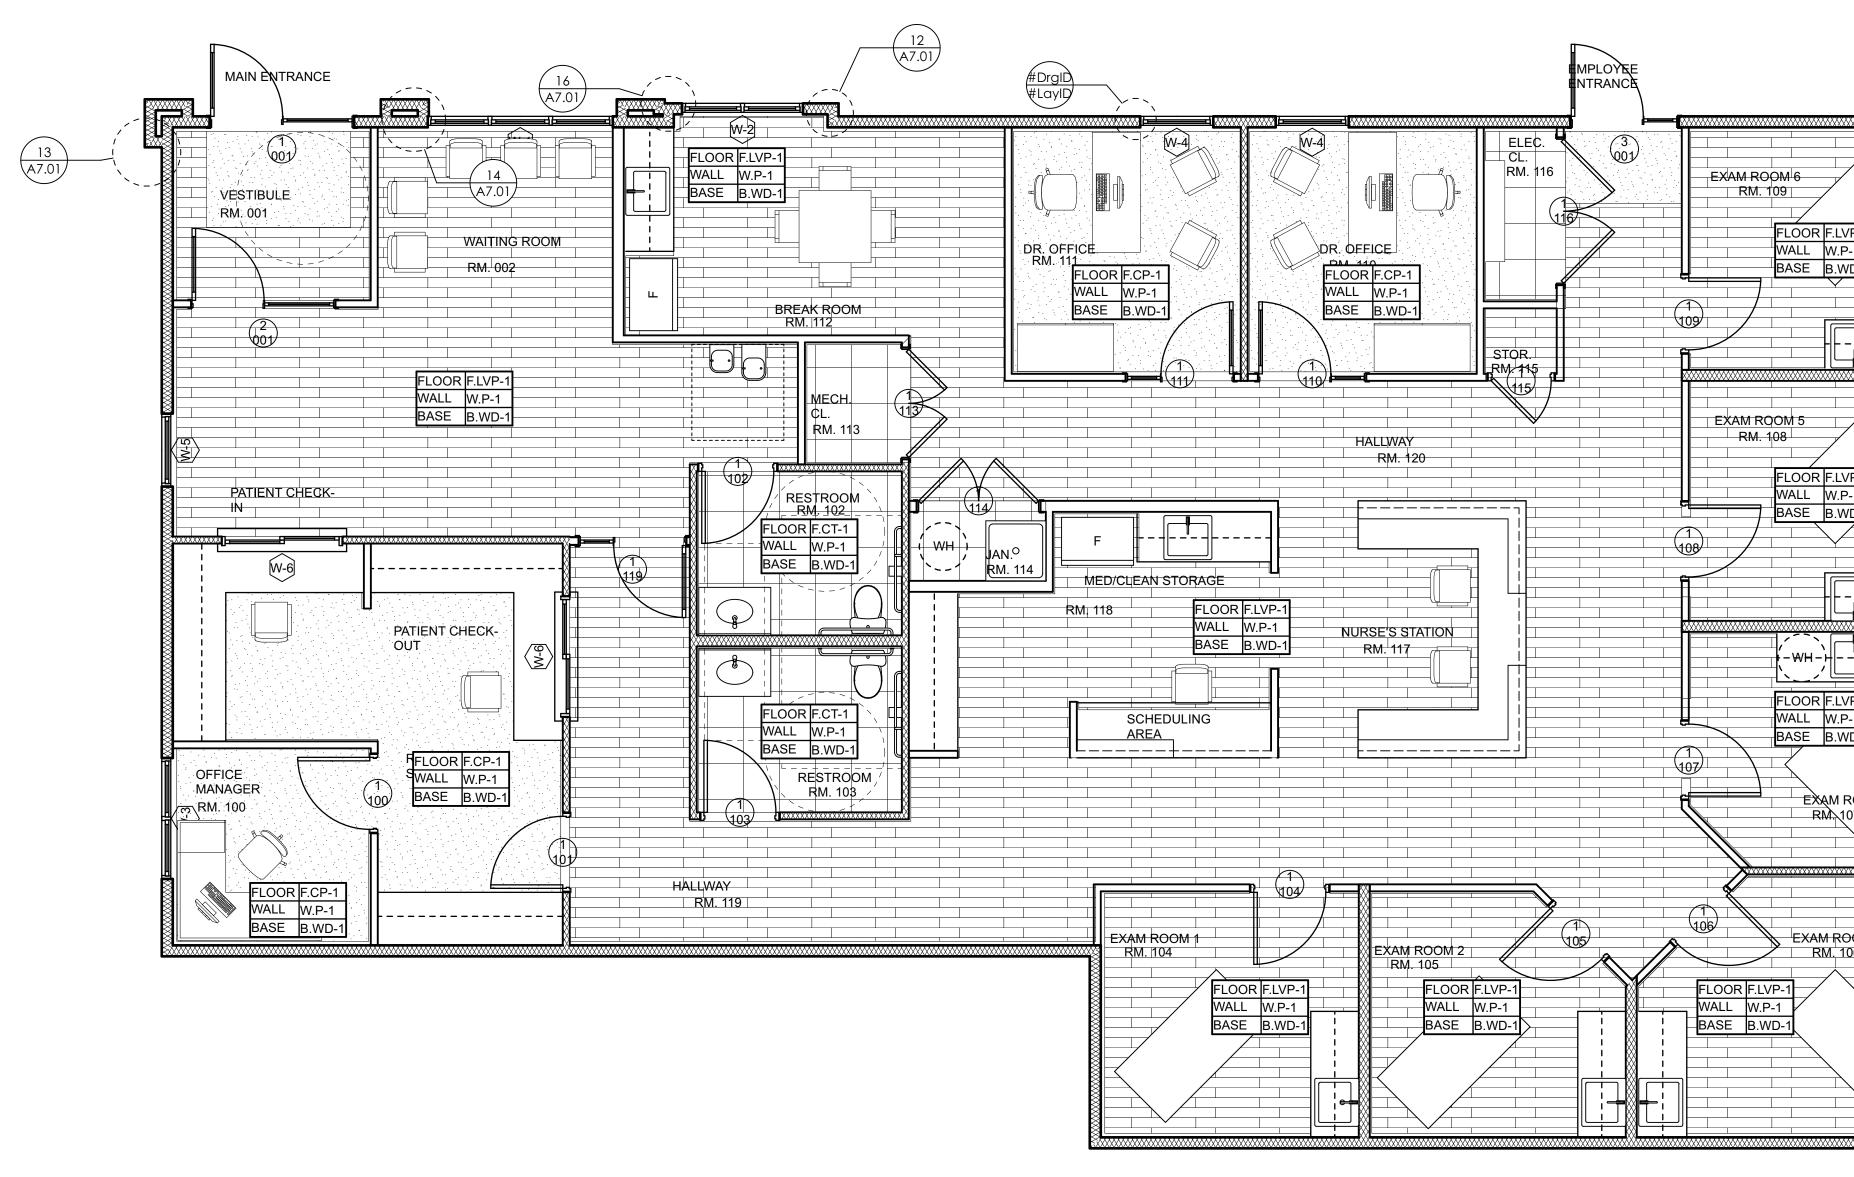



 1
 FINISH PLAN

 A4.03
 SCALE: 1/4" = 1'-0"

/P-1 /D-1		SEAL DATE- 4/11/22 REGISTRATION EXPIRES- 1/31/24 The professional services of the architect are undertaken for and are performed in the interest of the owner. No contractual obligation is assumed by the architect for the benefit of any other person involved in the project.
/P-1		ARCHITECTURAL ALLIANCE
→ → → → → → → → → → → → → → → → → → →		ARCHITECTURE • PLANNING INTERIOR DESIGN • GRAPHIC ARTS 1309 VEALE ROAD SUITE 22 WILMINGTON, DE 19810 302.478.3777 256 EAGLEVIEW BLVD SUITE 194 EXTON, PA 19341 610.640.9000
ROOM 4 07 		ISSUED FOR REVIEW
		PROJECT NAME WILLOW CREEK PLAZA BUILDING 4
		U.S. Route 40 New Castle County, DE
PRELIMINARY EL	NISH SCHEDULE	
	'SHAW INDUSTRIES' COMMERICAL LOW PILE CARPET	MARKDATEDESCRIPTIONREVISIONSPROJECT NO:2021-184DRAWN BY:RLRCHK'D BY:KWW
	LUXURY VINYL PLANK	DATE: 04.06.22 © COPYRIGHT 2021
	COLOR BODY PORCELAIN TILE	FINISH PLAN DRAWING NUMBER
	WALK OFF MATT	A4.03

SEAL

INTERIOR GRAPHICS

Types of Interior Graphic Signage: Entrance Signs. All building entrances that are accessible to and usable by persons with disabilities shall be identified with a minimum of one International Symbol of Accessibility and with additional directional signs, utilizing the symbol, at junctions, as required, to be visible to persons along approaching pedestrian ways.

Exit/ Stair Signs. Provide tactile Exit signs with the words "EXIT ROUTE," in 1 1/4 high letters, at all doors which exit directly to exterior safe areas; all doors which exit directly to fire-rated exit corridors and stairways which lead directly to exterior safe areas; and at all doors which exit to a separate building. Verify location with building official. Re: Plan for additonal information.

Elevator Signs. Provide tactile signs at each elevator entrance identifying elevator and call buttons inside and outside of cab per ANSI

Space Usage Signs. Provide tactile signs identifing room function and number (if applicable) at all interior doors. Provide international tactile pictorial sign with associated verbal description at all required accessible function doors. Interior Graphic Signage Requirements (Typical UNO):

International Symbols of Accessibility.

The International Symbol of Accessibility shall be the standard used to identify facilities that are accessible to and usable by physically disabled persons as set forth in these building standards and as specifically required in this section. See Typical Graphic for standard.


Character Letter and Number Type. Characters on signs shall be raised 1/32-inch minimum, have a width-to-height ratio between 3:5 and 1:1 and a stroke-width-to-height ratio between 1:5 and 1:10 using an upper-case "X" for measurement, and shall be sans-serif uppercase characters accompanied by Grade 2 Braille. Dots shall be 1/10-inch on centers in each cell with 2/10-inch space between cells, measured from the second column of dots in the first cell to the first column of dots in the second cell. Dots shall be raised a minimum of 1/40-inch above the background.

Raised Character Size. Raised characters shall be a minimum of 5/8-inch high, and a maximum of 2-inches high. Pictograms shall be accompanied by the equivalent verbal description placed directly below the pictogram. The border dimension of the pictogram shall be 6 inch minimum in height. The characters and background of signs shall be eggshell, matte, or other non-glare finish and shall contrast with their background, with either a light pictogram on a dark field or a dark pictogram on a light field. Mounting location and Height. Where permanent identification is provided for rooms and spaces, signs shall be installed on the wall adjacent to the latch outside of the door. Where there is no wall space on the latch side, including at double leaf doors,

signs shall be placed on the nearest adjacent wall, preferably on the right.

Mounting height shall be 60-inches above the finish floor to the centerline of the sign. Mounting location shall be determined so that a person may approach within 3-inches of signage without encountering protruding objects or standing within the swing of a door.


TOILET ROOM DOOR GRAPHICS

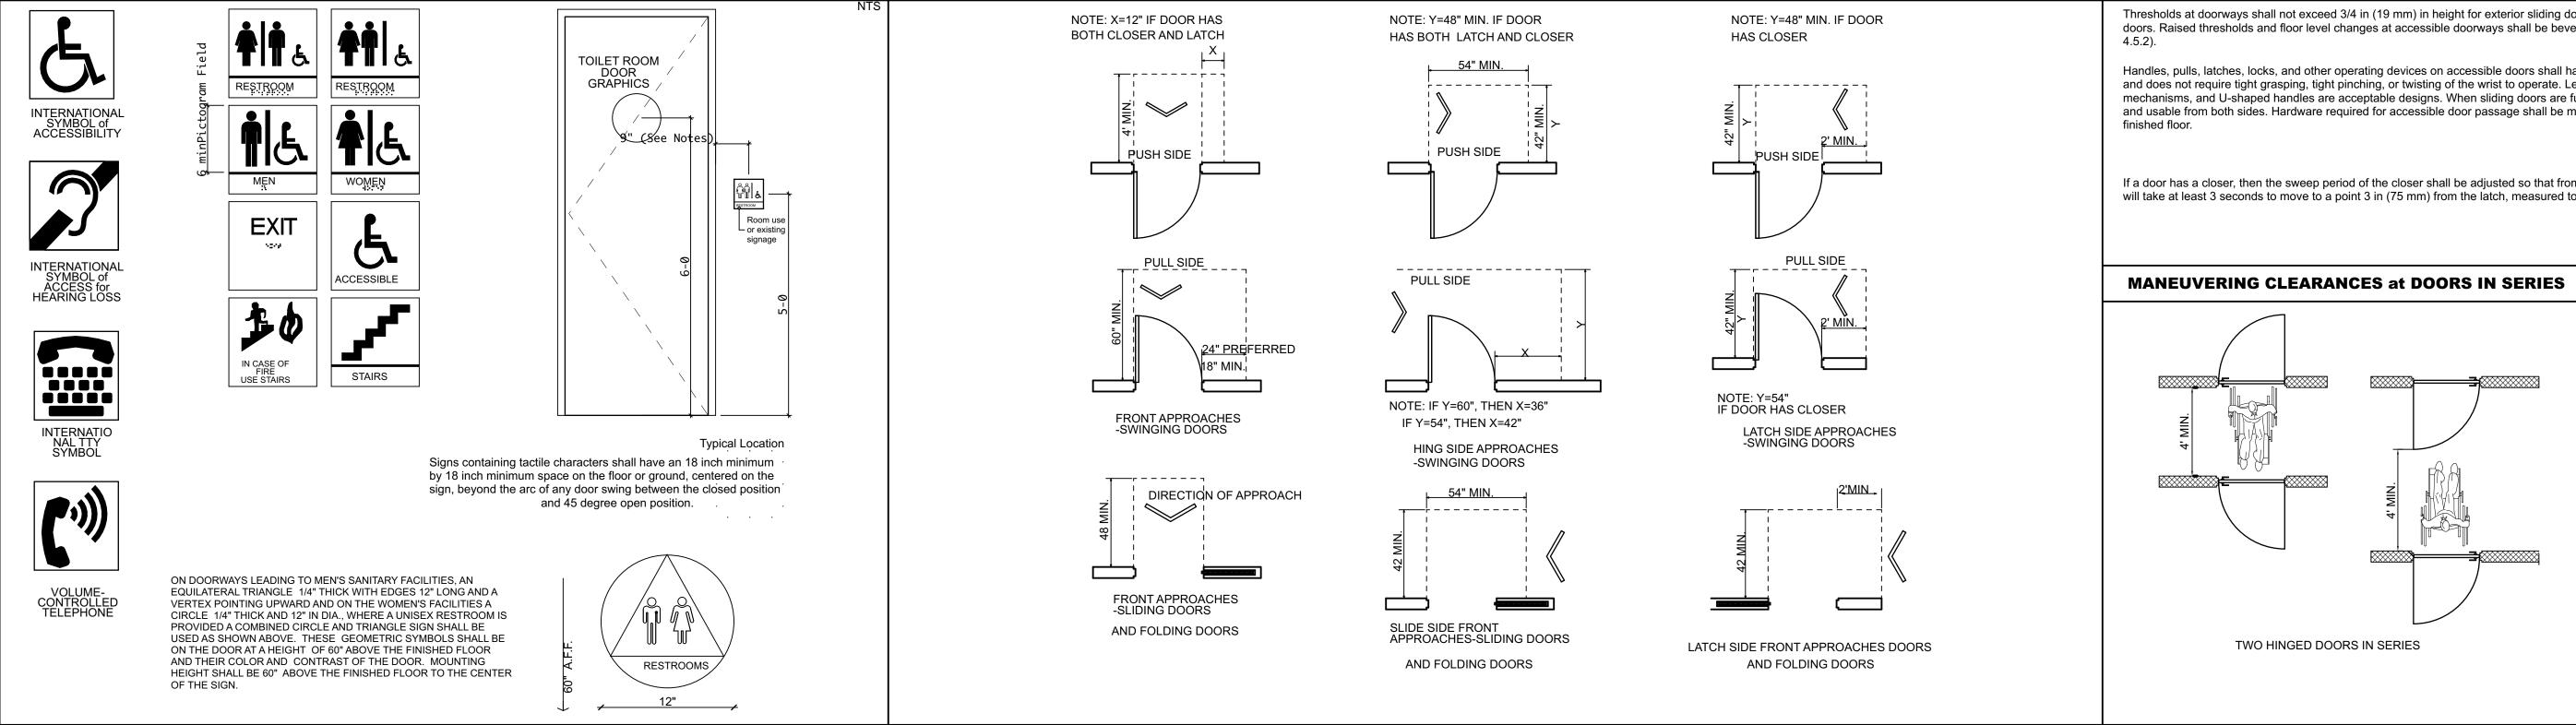


ANSI DETAILS

A4.04 SCALE: 1/4" = 1'-0"

1

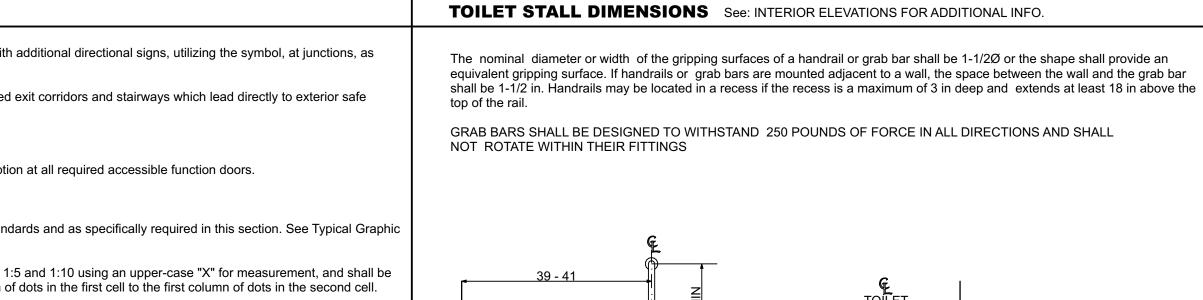


TOILE 42 MIN 12 🔒 _____ 36 MAX____ 24 MIN -- |-1.5" 1.5" S STL HANDRAIL Toilet Paper Holder SIDE WALLS REAR WALL OF STANDARD STALL

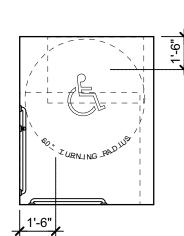

MANEUVERING CLEARANCES at DOORS NOTE: ALL DOORS IN ALCOVES SHALL COMPLY WITH THE CLEARANCES FOR FRONT APPROACHES

A.D.A. MOUNTING HEIGHTS

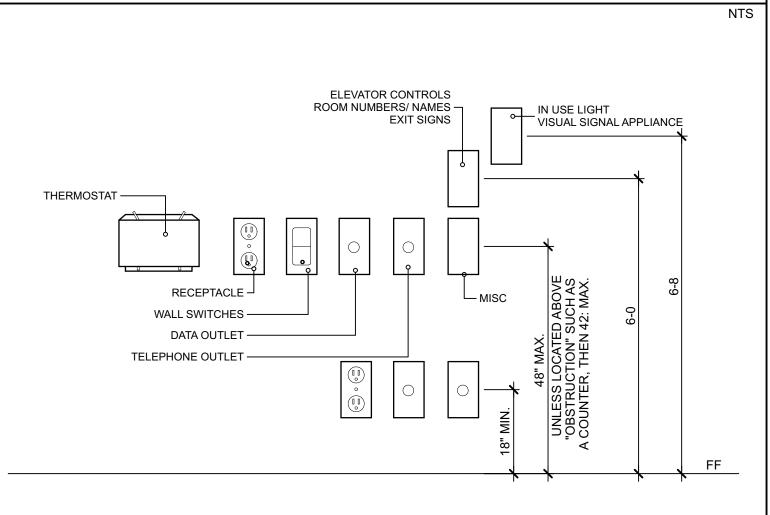


GENERAL ACCESSIBLE DOOR REQUIREMENTS

Thresholds at doorways shall not exceed 3/4 in (19 mm) in height for exterior sliding doors or 1/2 in (13 mm) for other types of doors. Raised thresholds and floor level changes at accessible doorways shall be beveled with a slope no greater than 1:2 (see

Handles, pulls, latches, locks, and other operating devices on accessible doors shall have a shape that is easy to grasp with one hand and does not require tight grasping, tight pinching, or twisting of the wrist to operate. Lever-operated mechanisms, push-type mechanisms, and U-shaped handles are acceptable designs. When sliding doors are fully open, operating hardware shall be exposed and usable from both sides. Hardware required for accessible door passage shall be mounted no higher than 48 in (1220 mm) above

If a door has a closer, then the sweep period of the closer shall be adjusted so that from an open position of 70 degrees, the door will take at least 3 seconds to move to a point 3 in (75 mm) from the latch, measured to the leading edge of the door.

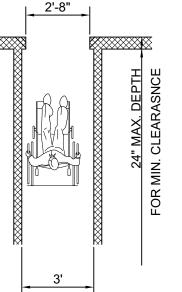

MINIMUM CLEAR WIDTH FOR SINGLE WHEELCHAIR

SEAL DATE- 4/11/22 **REGISTRATION EXPIRES- 1/31/24** The professional services of the architect are undertaken for and are performed in the interest of the owner. No contractual obligation is assumed by the architect for the benefit of any other person involved in the project. ARCHITECTURAL ALLIANCE ARCHITECTURE • PLANNING INTERIOR DESIGN • GRAPHIC ARTS 1309 VEALE ROAD SUITE 22 WILMINGTON, DE 19810 302.478.3777 256 EAGLEVIEW BLVD SUITE 194 EXTON, PA 19341 610.640.9000 **ISSUED FOR REVIEW** PROJECT NAME WILLOW CREEK PLAZA BUILDING 4 U.S. Route 40 New Castle County, DE

SEAL


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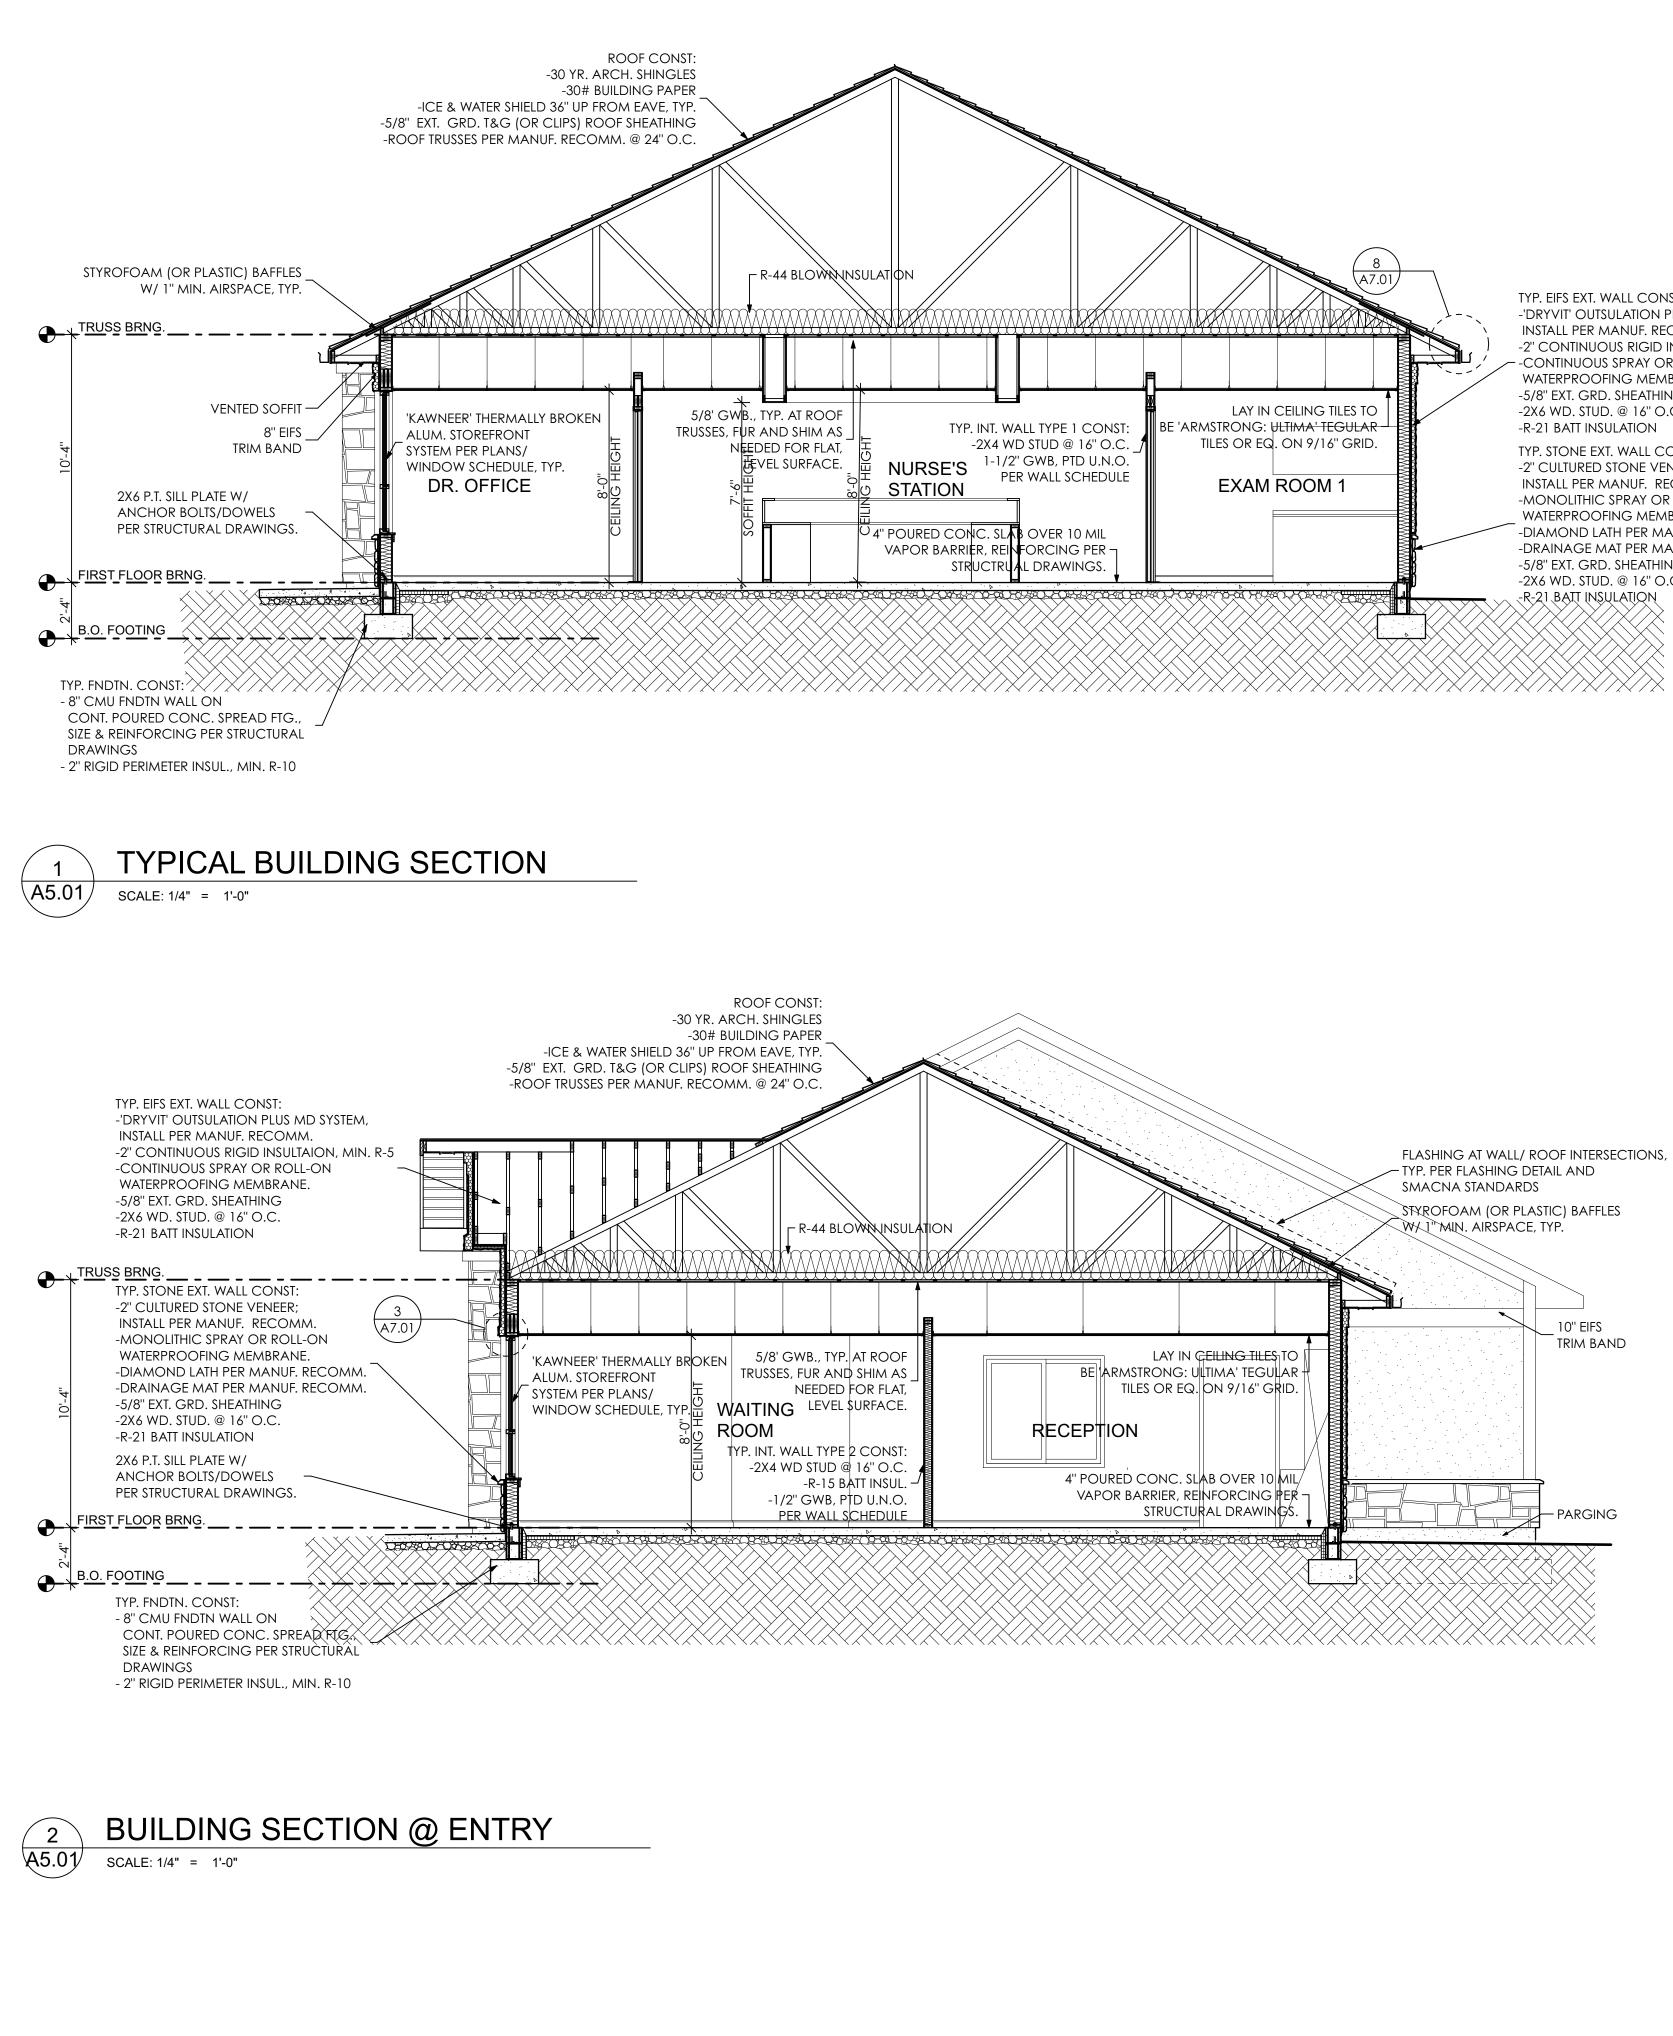
ANSI DETAILS

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DRAWING NUMBER


A4.04



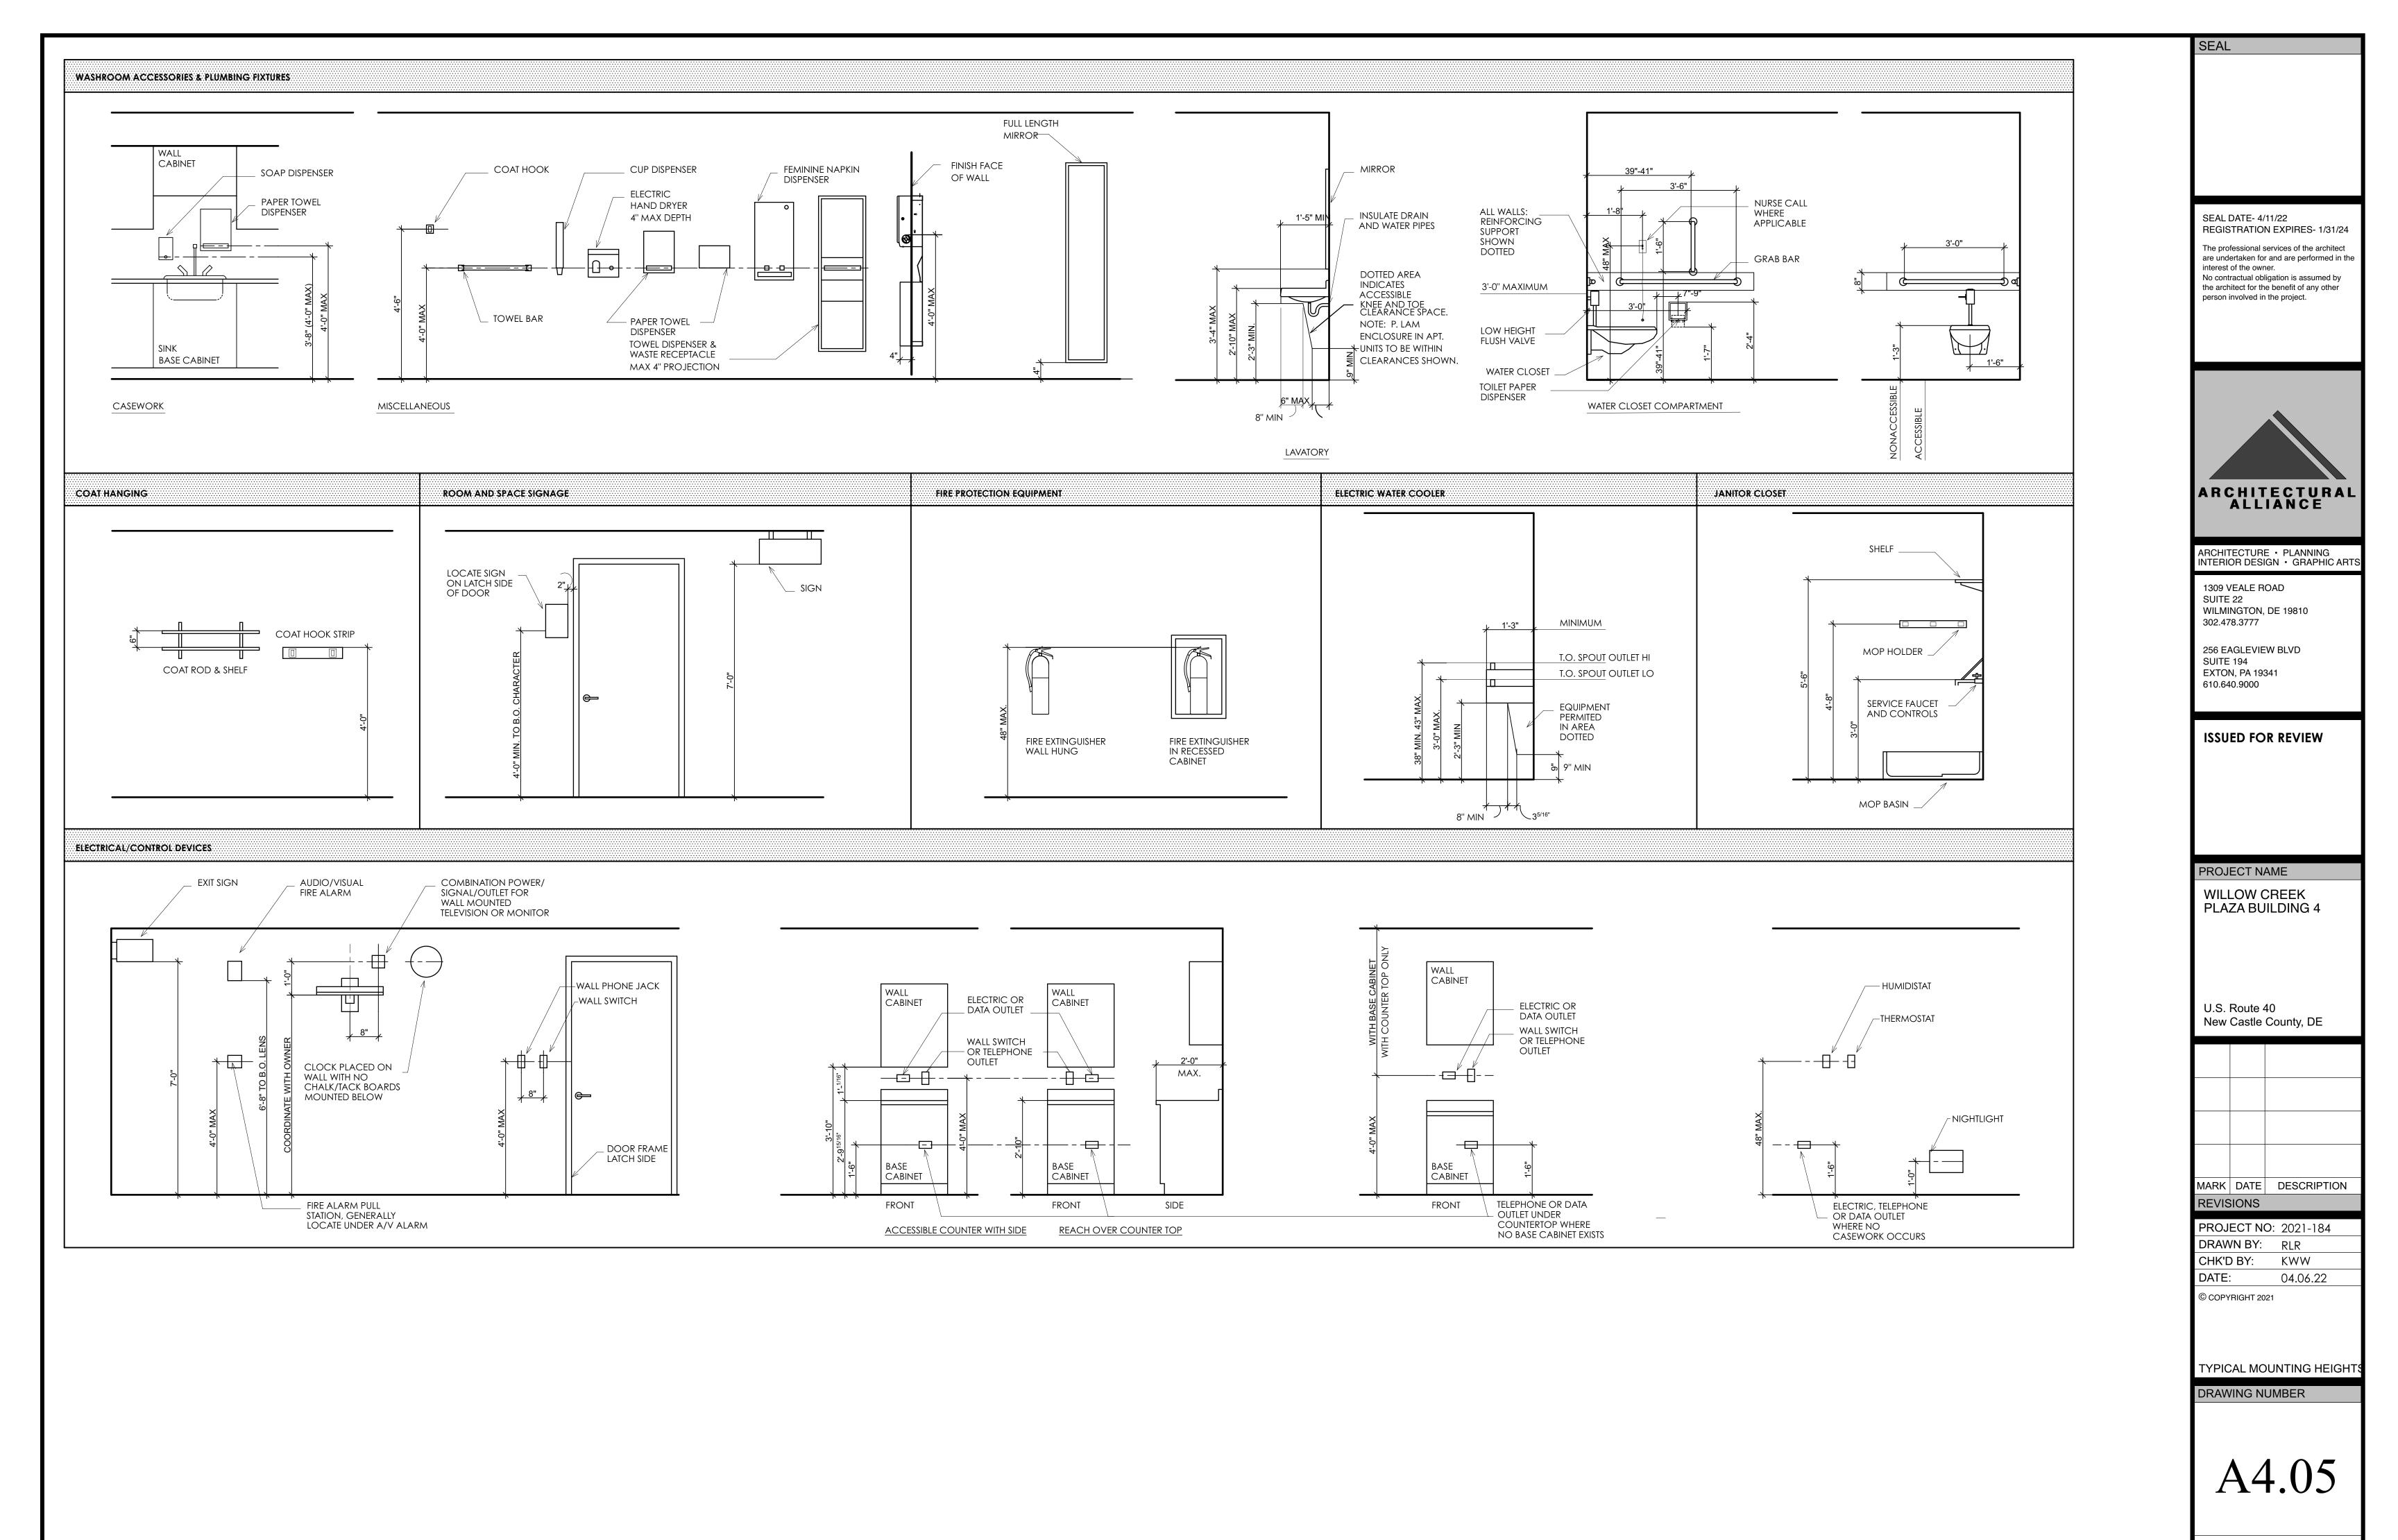

TYP. EIFS EXT. WALL CONST: UL356 -'DRYVIT' OUTSULATION PLUS MD SYSTEM, INSTALL PER MANUF. RECOMM. -2" CONTINUOUS RIGID INSULTAION, MIN. R-5 -CONTINUOUS SPRAY OR ROLL-ON WATERPROOFING MEMBRANE. -5/8" EXT. GRD. SHEATHING -2X6 WD. STUD. @ 16" O.C. TYP. STONE EXT. WALL CONST: UL356 -2" CULTURED STONE VENEER; INSTALL PER MANUF. RECOMM. -MONOLITHIC SPRAY OR ROLL-ON WATERPROOFING MEMBRANE. -DIAMOND LATH PER MANUF. RECOMM. -DRAINAGE MAT PER MANUF. RECOMM. -5/8" EXT. GRD. SHEATHING -2X6 WD. STUD. @ 16" O.C.


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SEAL DATE- 4/11/22				
REGISTRATION EXPIRES- 1/31/24				
The professional services of the architect are undertaken for and are performed in the				
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ALLIANCE				
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1309 VEALE ROAD				
SUITE 22 WILMINGTON, DE 19810				
302.478.3777				
256 EAGLEVIEW BLVD				
SUITE 194 EXTON, PA 19341				
610.640.9000				
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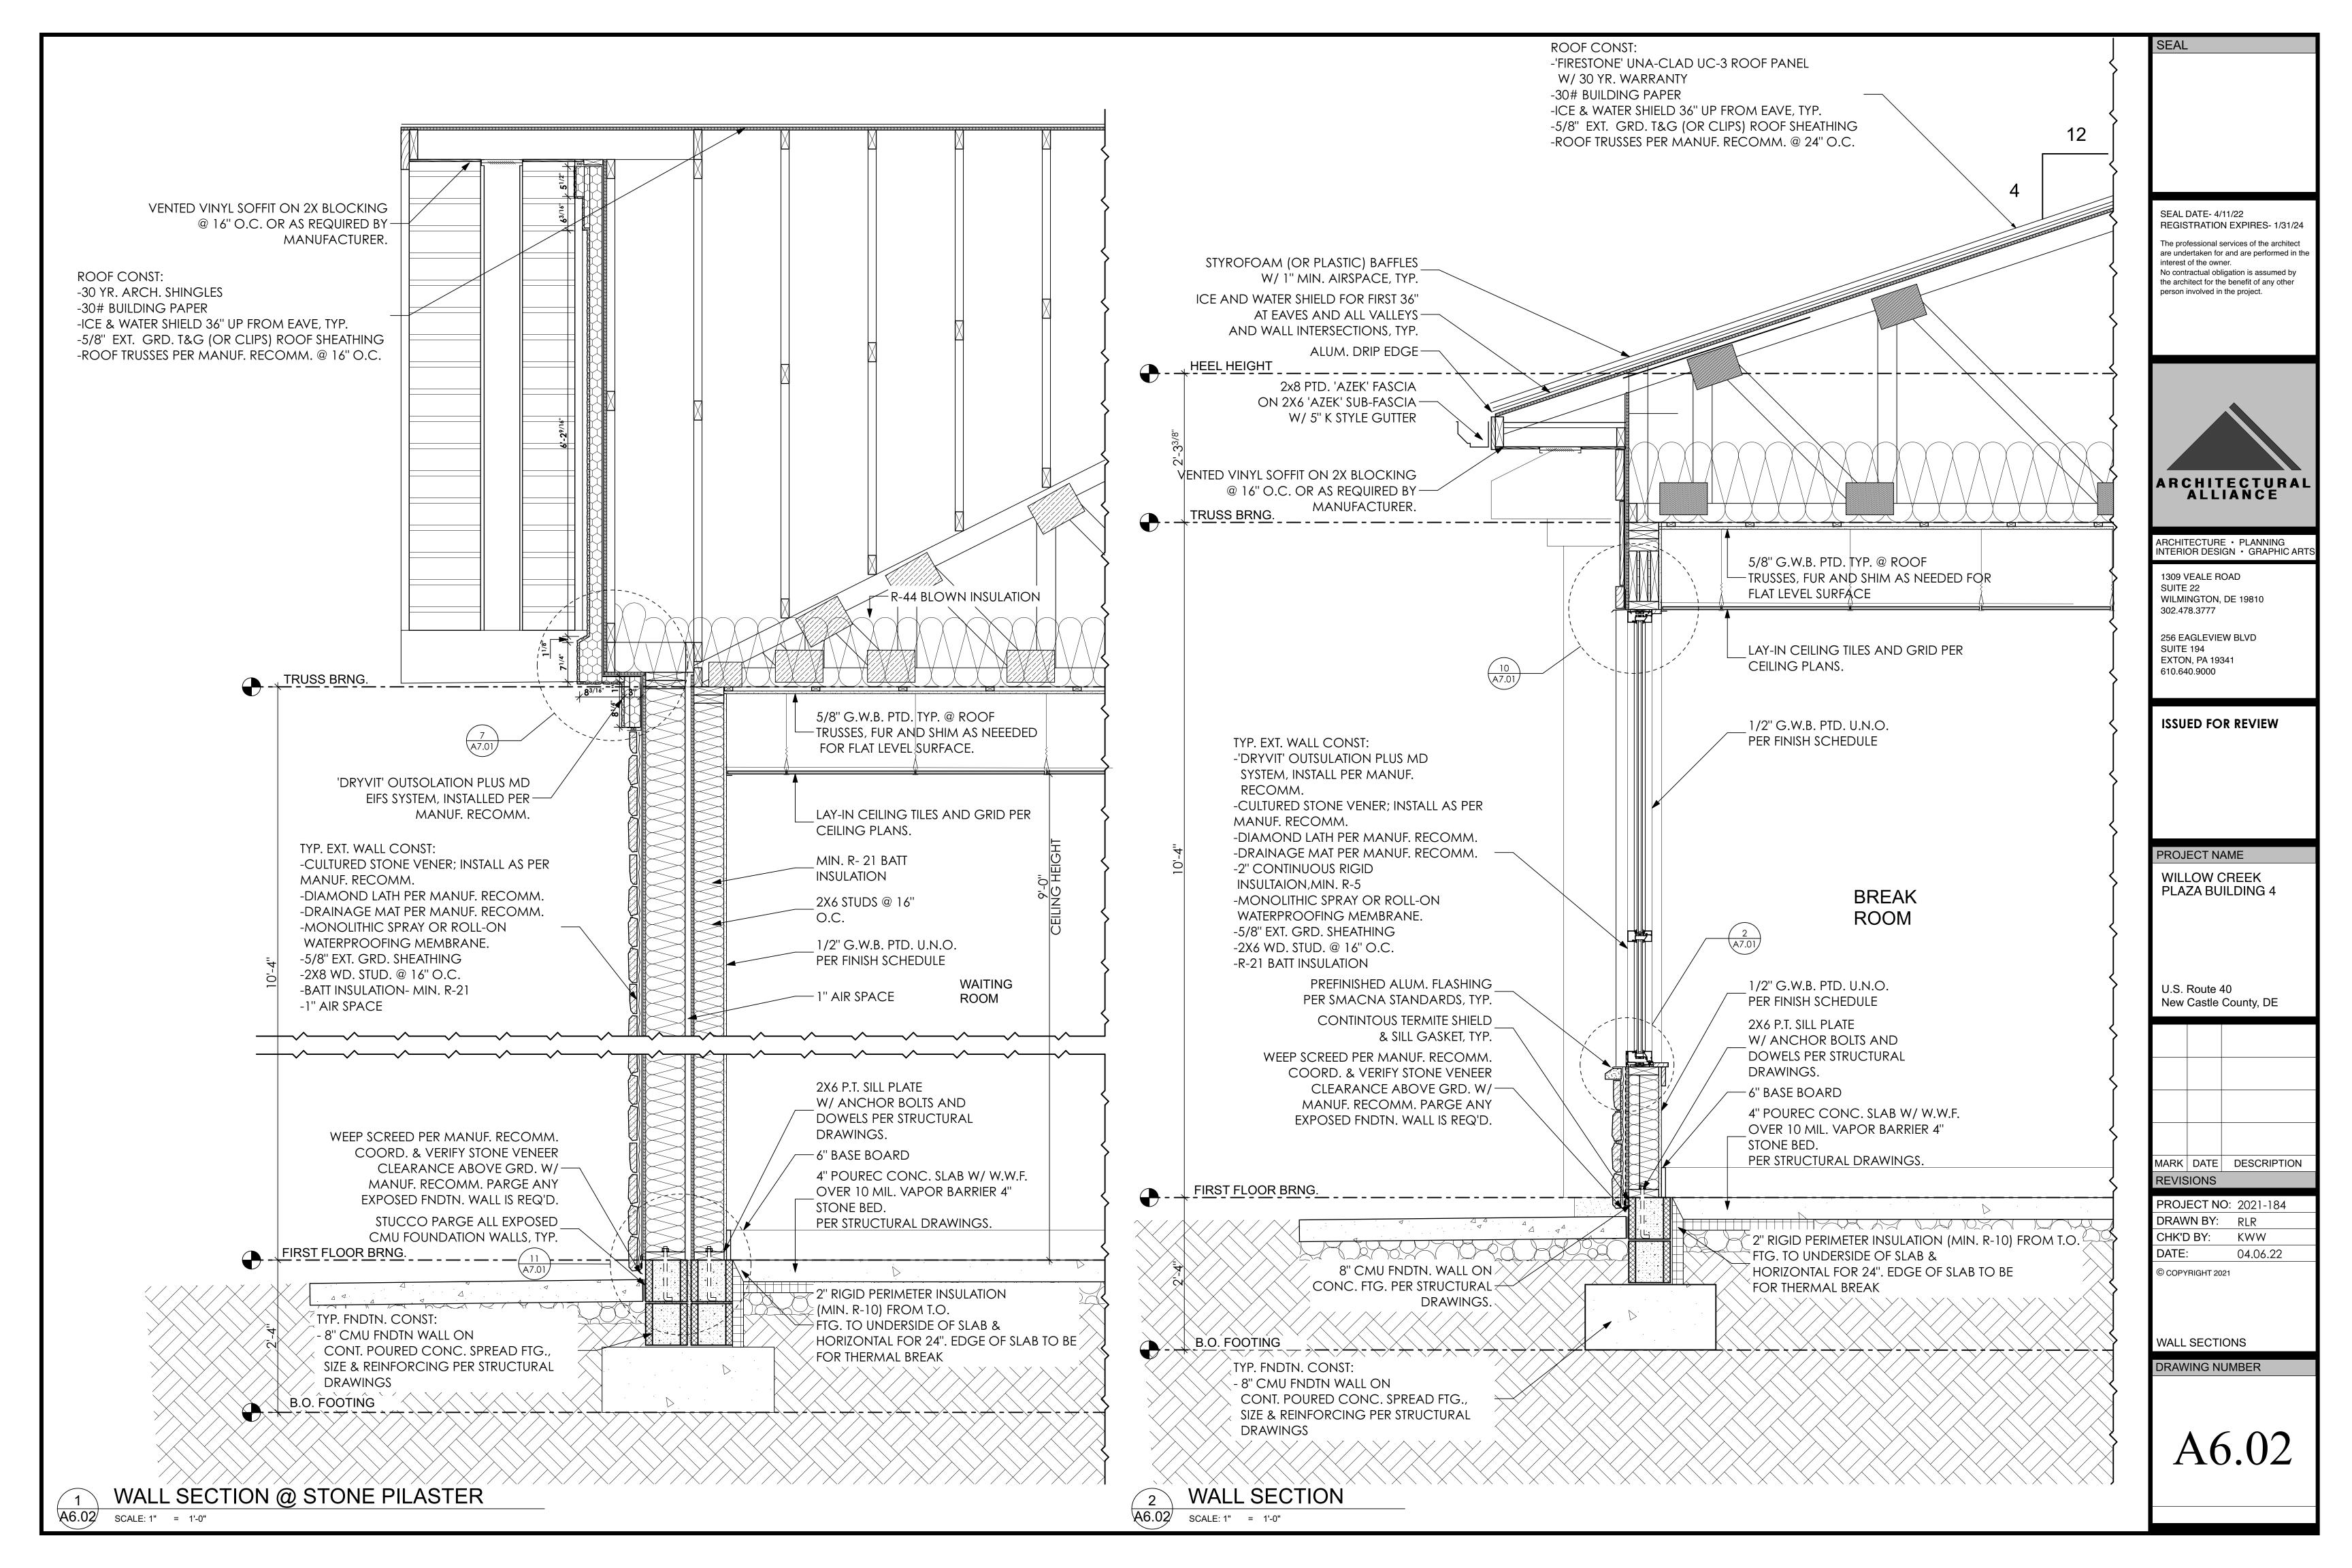


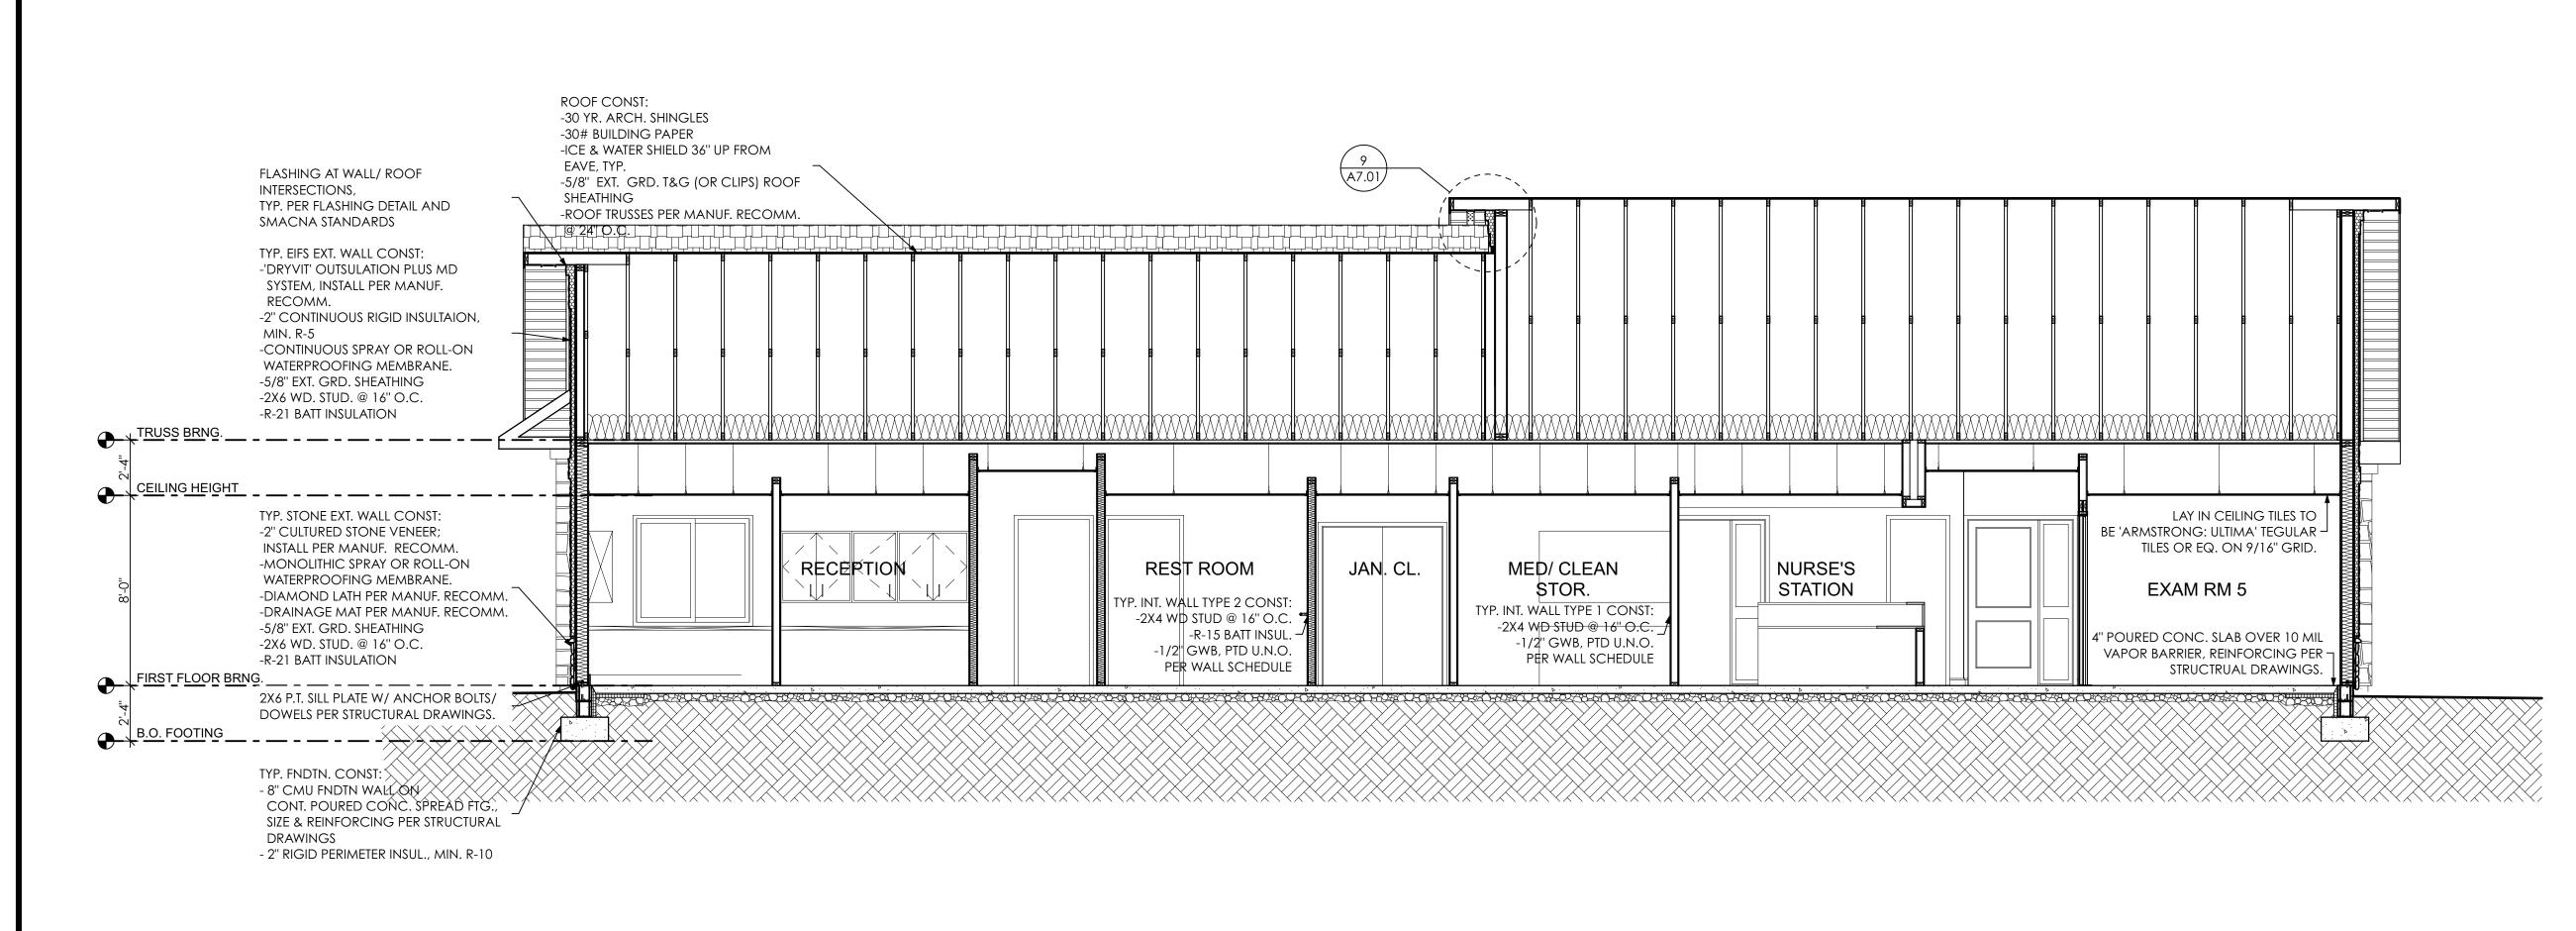


LONGITUDINAL BUILDING SECTION

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SEAL DATE- 4/11/22				
REGISTRATION EXPIRES- 1/31/24				
The professional services of the architect				
are undertaken for and are performed in the interest of the owner.	9			
No contractual obligation is assumed by the architect for the benefit of any other				
person involved in the project.				
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ALLIANCE				
INTERIOR DESIGN · GRAPHIC ARTS				
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SUITE 22				
WILMINGTON, DE 19810 302.478.3777				
302.478.3777				
256 EAGLEVIEW BLVD				
SUITE 194 EXTON, PA 19341				
610.640.9000				
ISSUED FOR REVIEW				
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WILLOW CREEK PLAZA BUILDING 4 U.S. Route 40 New Castle County, DE				



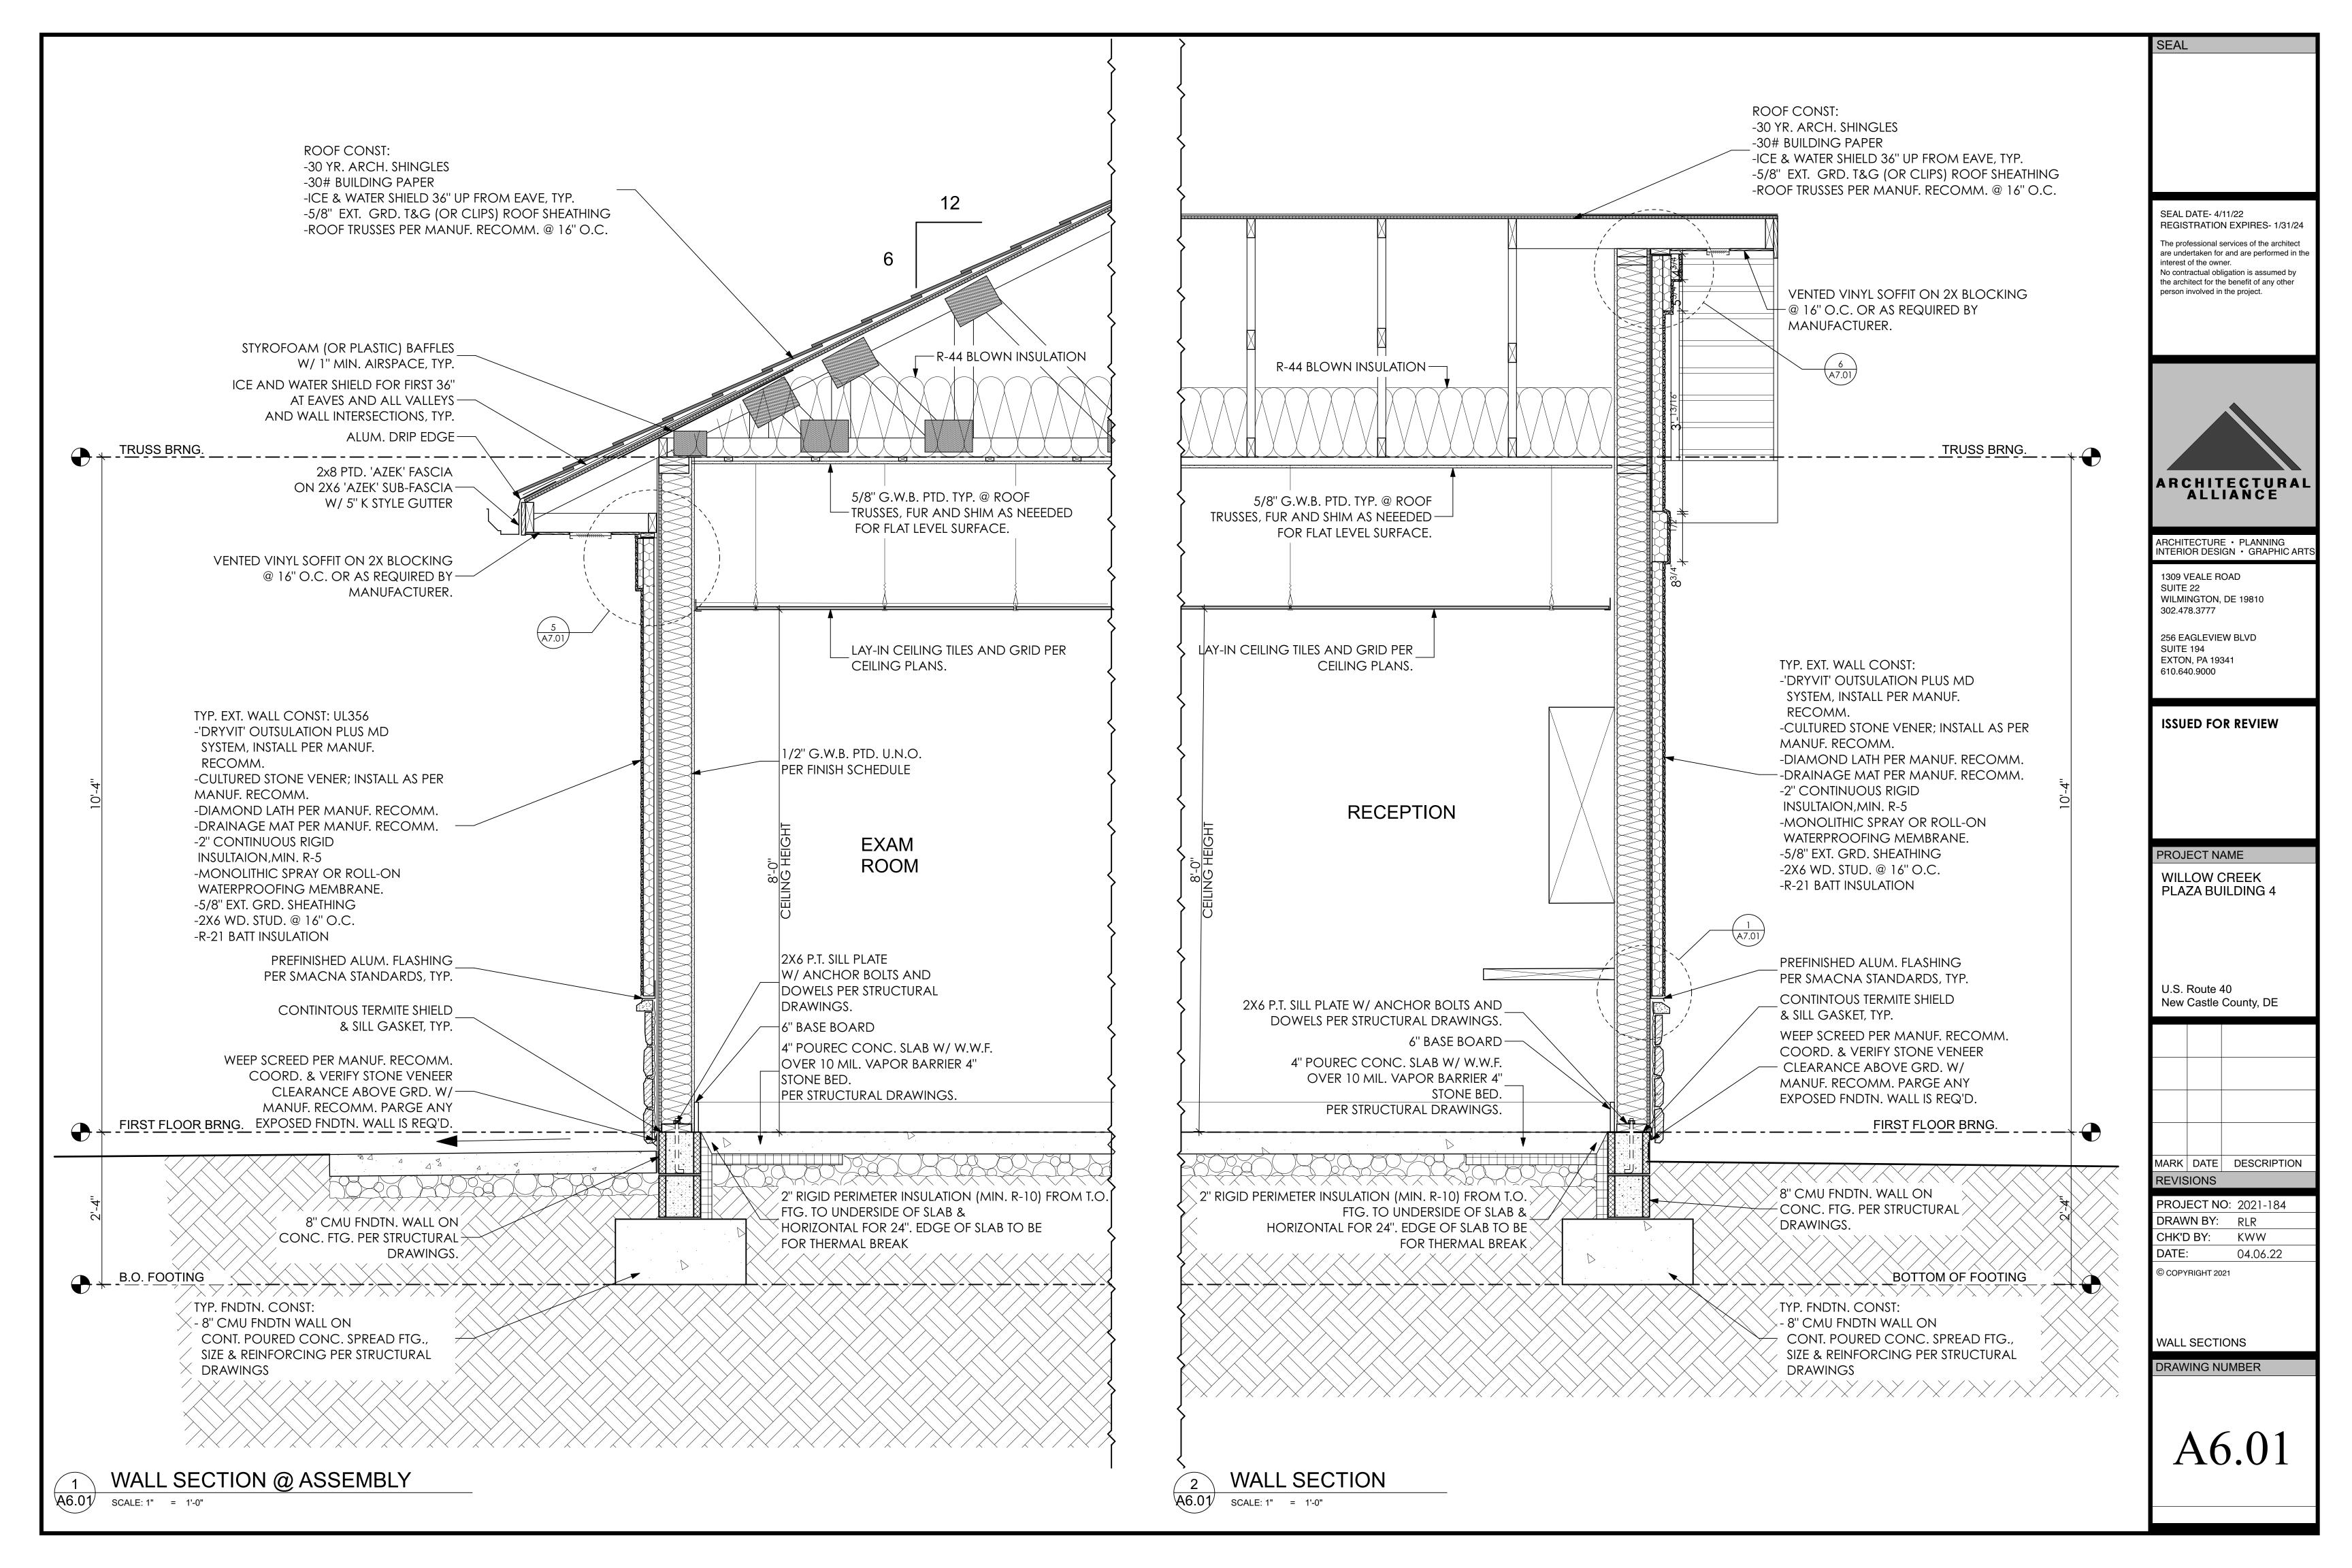

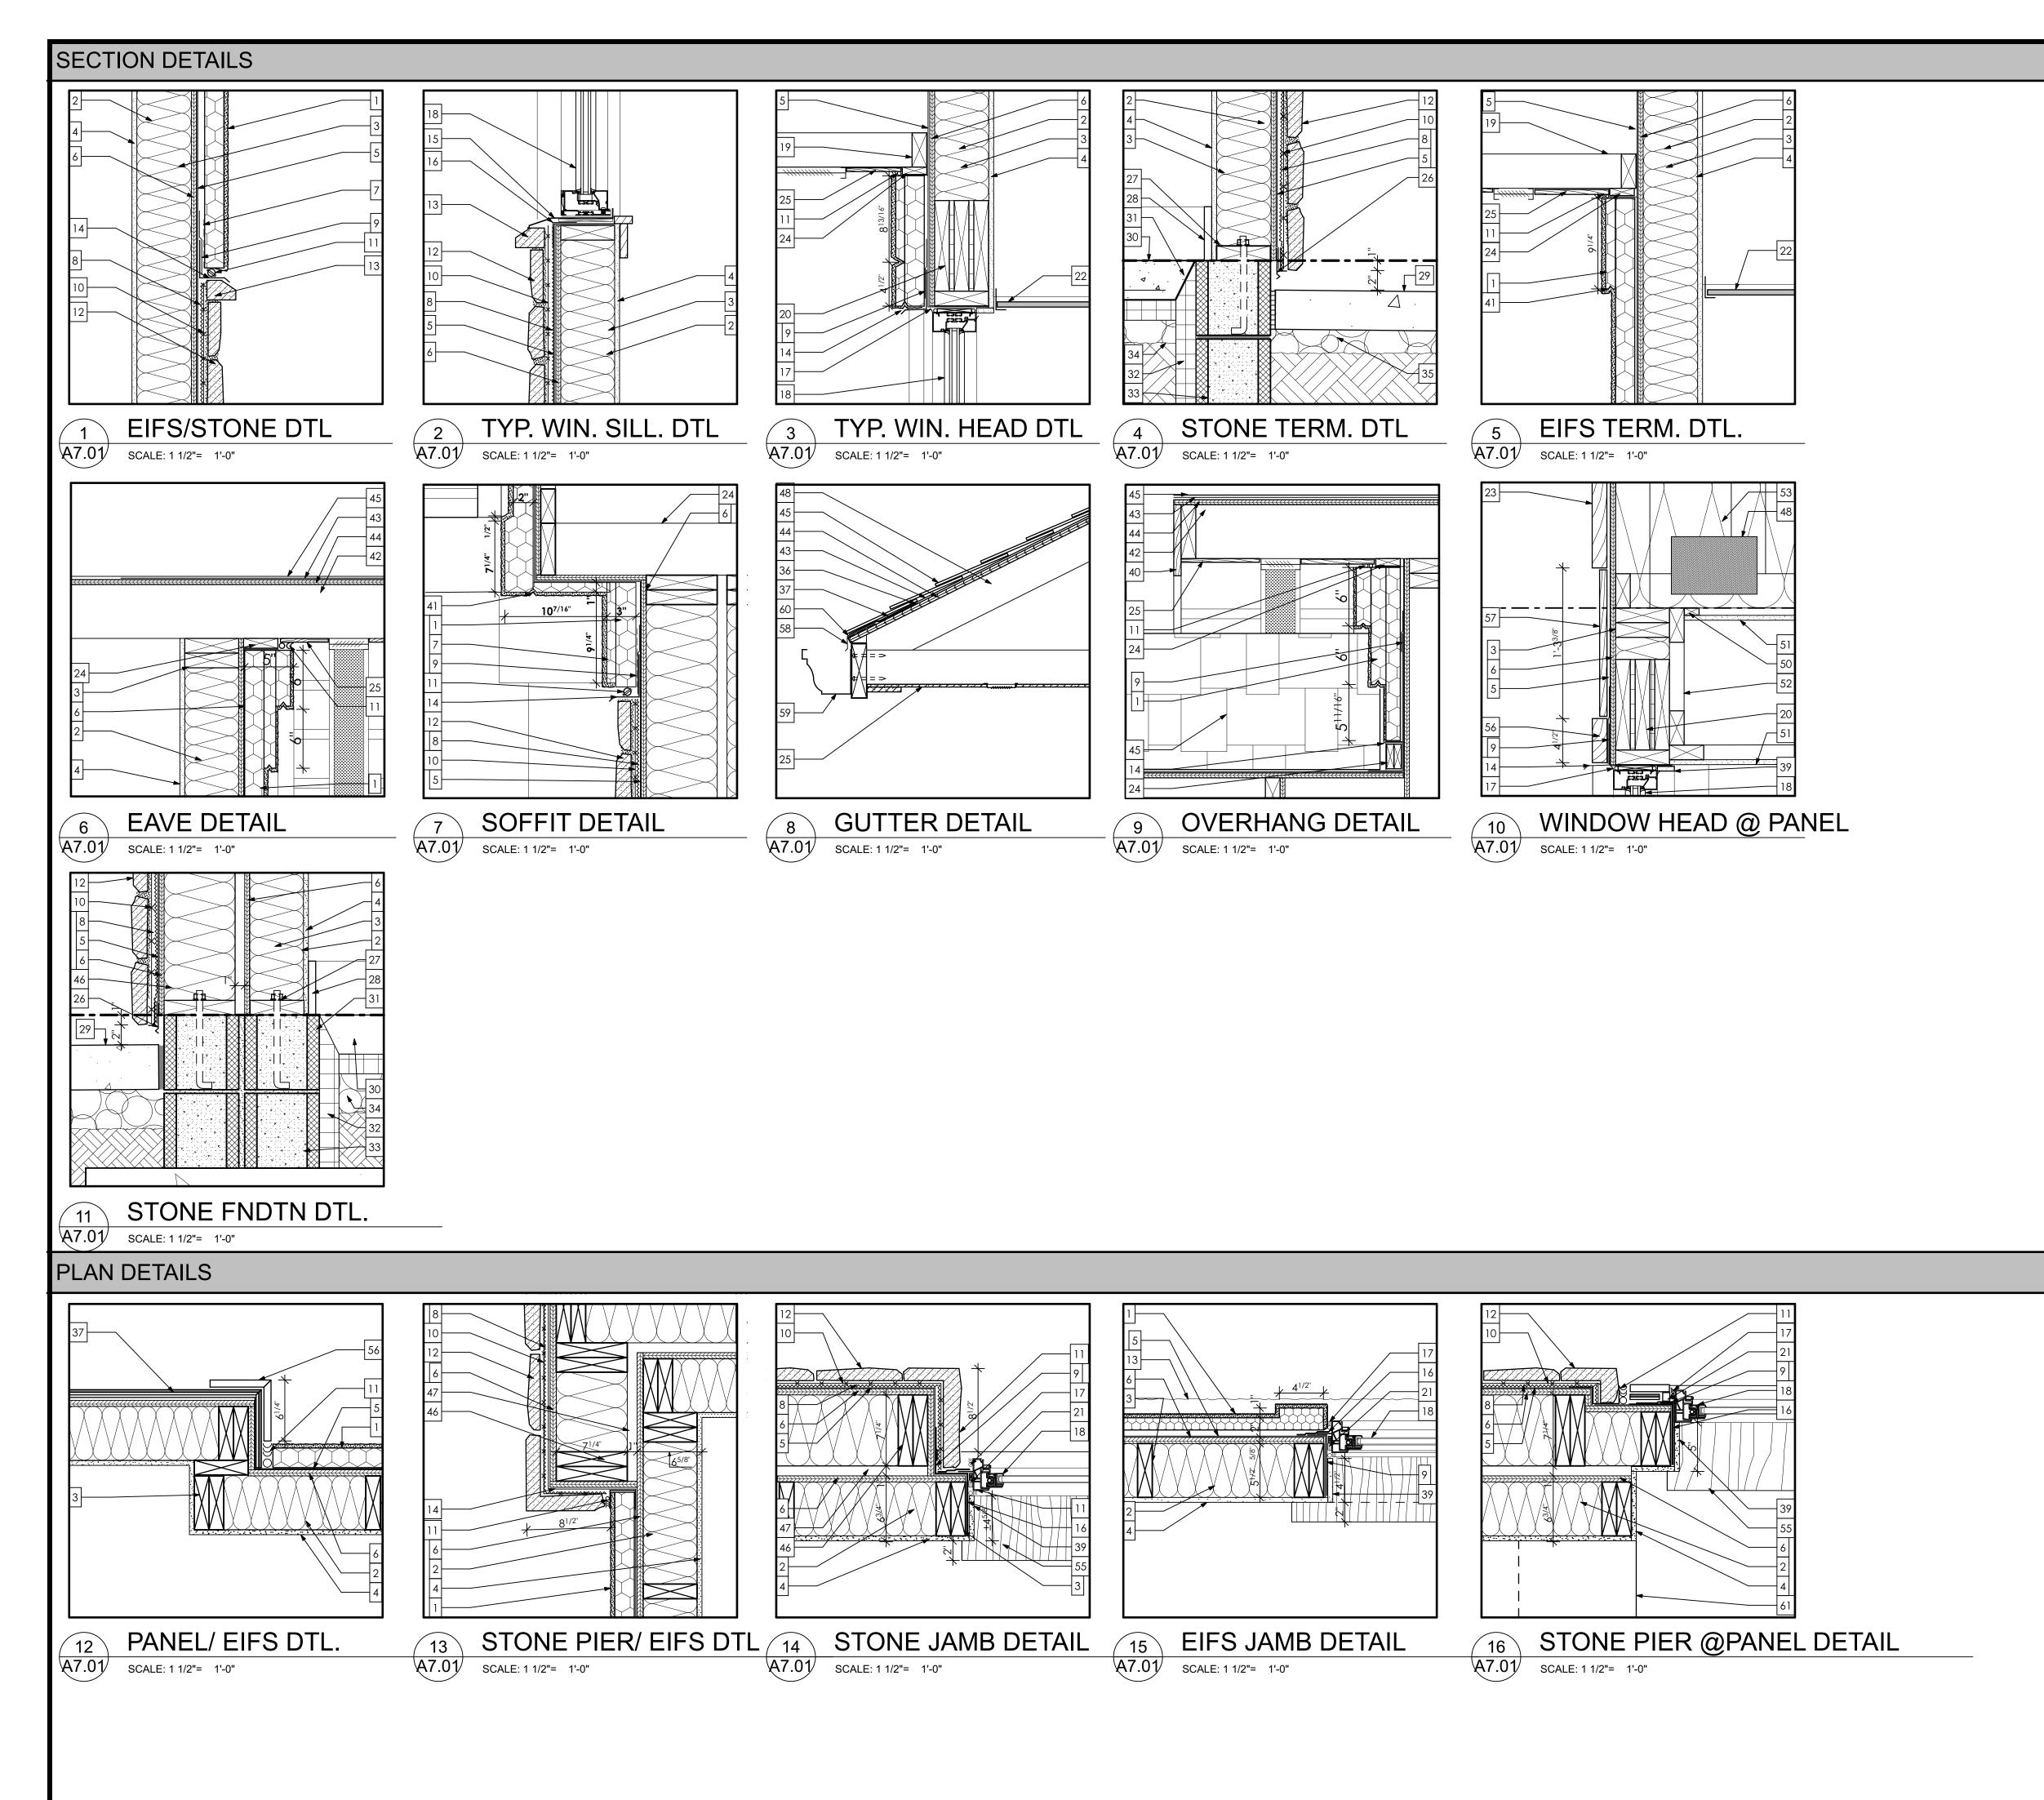

DETAIL NOTES	SEAL
1. EIFS SYSTEM TO BE 'DRYVIT' OUTSULATION PLUS MD OR APPROVED EQUAL ON 2" INSULATION BOARD. INSTALL IN ACCORDANCE WITH MANUFACTURER DETAILS AND INSTRUCTIONS. GC TO	
 PROVIDE OWNER WITH FULL MANUFACTURER WARRANTY. 2. MIN. R-21 FOIL-FACED INSULATION. 3. 2X6 STUDS, SEE WALL SCHEDULE AND STRUCTURAL DRAWINGS. 4. 5/8" GWB PAINTED PER WALL SCHEDULE. 	
 BACKSTOP NT WRB, TYP. INSTALL PER MANUFACTURER DETAILS AND INSTRUCTIONS. 5/8" EXTERIOR GRADE APA RATED PLYWOOD SHEATHING IN ACCORDANCE WITH STRUCTURAL DRAWINGS AND UL LISTINGS. 	
 DRIANAGE STRIP PER EIFS MANUFACTURER. CONTINUOUS RAINSCREEN, TYP. AT CULTURED STONE AND METAL LATHE. EXTEND WRB OVER FLASHING AND TAPE PER WRB AND WINDOW MANUFACTURER INSTRUCTIONS. SELF-ADHERED FLASHINGS MUST COMPLY WITH AAMA 711-07 AND ASTM E 2112. 	
 GALVANIZED METAL LATHE INSTALL PER ASTM C1063 CONTINUOUS SEALANT AND BACKER ROD, TYP AT DISSIMILAR MATERIALS. CULTURED STONE VENEER INSTALLED PER MANUFACTURER DETAILS. 	SEAL DATE- 4/11/22
 CULTURED STONE SILL, INSTALLED PER MANUFACTURER DETAILS. PREFINISHED ALUM. FLASHING PER SMACNA STANDARDS, TYP. PRE-FINISHED ALUM. PAN FLASHING TO MATCH WINDOW/ STOREFRONT FRAME, EXTEN PAN 	REGISTRATION EXPIRES- 1/31/20 The professional services of the architect
 FLASHING 6' VERTICALLY AT JAMBS AND MIN. 1" AT INTERIOR FACE OF SILL, SET IN FULL BEC OF SEALANT. 16. WRAP WRB AND FLASHING TAPE INTO OPENING AT JAMBS AND SILL IN ACCORDANCE WITH 	are undertaken for and are performed in the interest of Capano inc. No contractual obligation is assumed by
MANUFACTURER DETAILS. INSTALL FLASHING TAPE TO ADHERE WRB TO FRAMING IN ACCORDANCE WITH EIFS MANUFACTURER DETAILS. SEE NOTE 9 FOR ADHERED FLASHING NOTES. 17. CONT. SELANT AROUND WINDOW HEADS, SILLS AND JAMBS, TYP.	the architect for the benefit of any other person involved in the project.
 PRE-FINISHED THERMALLY-BROKEN FIBERGLASS WINDOW/ STOREFRONT PER WINDOW SCHEDULE, INSTALLED PER MANUFACTURER DETAILS AND INSTRUCTIONS, TYP 2X PT. SOFFIT FRAMING @ 16" O.C. 	
 WOOD WINDOW HEAD PER STRUCTURAL DRAWINGS. PACK OUT ALL WOOD HEADERS TO FULL WIDTH OF WALL STUDS, TYP. ADDITIONAL 1" INSULATION TO FORM WIDOW CASINGS, TYP. AT WINDOW HEADS AND JAMBS, 	
INSTALL PER MANUF. RECOMM. 22. LAY IN CEILING TILE AND GRID SYSTEM PER CEILING PLANS, INSTALL PER MANUF. RECOMM. 23. 10" 'AZEK' TRIM BOARD, PTD., LOCATIONS PER ELEVATIONS. INSTALL PER MANUF. RECOMM.	
 CONT. 2X P.T. WD. BLOCKING CELLULAR PVC SOFFIT BOARD W/ CONT. VENTED VINYL SOFFIT, INSTALL PER MANUF. RECOMM. CONTINUOUS STAINLESS STEEL WEEP SCREED. ALLOW SPACE FOR DRAINAGE, TERMINATE STONE BASE IN ACCORDANCE WITH MANUF. RECOMM. 	
 27. 2X6 P.T. SILL PLATE WITH ANCHOR BOLTS PER STRUCTURAL DRAWINGS. 28. 1/2" X 6" STAINED WD. BASE 29. EXTERIOR HARDSCAPING PER CIVIL AND LANDSCAPE DRAWINGS. 	
 POURED CONCRETE SLAB PER STRUCTURAL DRAWINGS. SEE PLAN FLOR SLAB ELEVATIONS AND STEP-DOWN LOCATIONS TAPER END OF SLAB AT ENTIRE EXTERIOR WALL PERIMETER. 	ARCHITECTURAL
 2" RIGID PERIMETER INSULATION VERTICALLY FROM TOP OF FOOTING TO TOP OF SLAB AND HORIZONTALLY FROM INTERIOR FACE OF FOUNDATION WALL TO 24" INWARD. TYP. ENTIRE PERIMETER. 32 PERIMETER. 	ALLIANCE
 8" CMU FOUNDATION WALL, SEE STRUCTURAL DRAWINGS FOR SIZE AND REINFORCING. 10 MIL CONTINUOUS VAPOR BARRIER. LAP AND TAPE ALL SEAMS AND SEAL ALL PENETRATIONS MIN. 4" STONE BED. SEE STRUCTURAL DRAWINGS. ICE AND WATER SHIELD, MIN. 48" FROM EAVE, TYP. 	ARCHITECTURE · PLANNING
 Stephen Strick Membrane Min, 48 FROM EAVE, TTP. PEEL AND STICK MEMBRANE MIN, 8" ALONG EDGE OF SHEATHING, TYP. PTD. 'AZEL' PANELS, INSTALLED PER MANUF. RECOMM. 5/8" G.W.B. PTD. WINDOW RETURN, TYP. AT ALL WINDOW HEADS & JAMBS. 	INTERIOR DESIGN • GRAPHIC ARTS
 8" 'AZEK' TRIM BOARD, LOCATIONS PER ELEVATIONS, INSTALL AS PER MANUF. RECOMM. EIFS DRIP EDGE 2X WOOD RAFTERS @ 16" O.C., PER STRUCTURAL DRAWINGS. 	1309 VEALE ROAD SUITE 22 WILMINGTON, DE 19810
 30# ROOF PAPER. 5/8" EXT. GRD. T&G (CLIPS) ROOF SHEATHING, TYP. 30 YR. ARCH. SHINGLES, INSTALL AS PER MANUF. RECOMM. 2x8 P.T. STUDS @ 16" O.C. 	302.478.3777
 46. 2x6 F.1. STUDS @ 16 O.C. 47. 1" AIR SPACE 48. ROOF TRUSSES @ 24" O.C. PER TRUSS MANUF. 50. 1X2 FURRING STRIPS @ 16" O.C. 	401 SUNSET HOLLOW ROAD SUITE 300
 5/8" PTD. G.W.B. CEILING 2X4 STUDS @ 16" O.C. ATTACHED TO CEILING TO FORM INTERIOR SOFFIT R-44 BLOWN INSULATION, BETWEEN TRUSSES. 	WEST CHESTER, PA 19380 610.640.9000
 STYROFOAM (OR PLASTIC) BAFFLES W/ 1" MIN. AIRSPACE, TYP. 3/4" STAINED WOOD BULLNOSE SILL AND APRON. 4" 'AZEK' TRIM BOARD PTD., LOCATIONS PER ELEVATIONS. INSTALL PER MANUF. RECOMM. 	
 3/4" X 'AZEK' PANEL PTD., LOCATIONS PER ELEVAITONS, INSTALL PER MANUF. RECOMM. PRE- FINISHED 'KYNAR' ALUM. 5" K GUTTER PRE- FINISHED ALUM. DRIP EDGE, INSTALLED PER MANUF. RECOMM. INSTALL PER MANUF. RECOMM. BENDABLE ALUM. FLASHING OVER DRIP EDGE, TAPE AND SEAL 	ISSUED FOR REVIEW 04.06.22
 EDGES, TYP. LAMINATE CABINETS W/ SOLID SURFACE COUNTERTOP PER INT. ELEV. 	
	PROJECT NAME
	WILLOW CREEK PLAZA BUILDING 4
	U.S. Route 40 New Castle County, DE
	MARK DATE DESCRIPTION
	MARKDATEDESCRIPTIONREVISIONS
	PROJECT NO: 2021-184 DRAWN BY: RLR
	CHK'D BY: KWW
	DATE: 04.04.22 © COPYRIGHT 2021
	DETAILS
	DETAILS DRAWING NUMBER
	A7.01
	SHEET 16 OF 16