GENERAL NOTES

- THESE DRAWINGS ARE TO BE READ IN CONJUNCTION WITH THE ARCHITECTURAL DRAWINGS, THE CONTRACTOR SHALL CHECK AND VERIFY ALL DIMENSIONS, ELEVATIONS, AND CONDITIONS PRIOR TO CONSTRUCTION. THE ENGINEER SHALL BE NOTIFIED IMMEDIATELY OF ANY DISCREPANCIES OR INCON-SISTENCIES.
- THESE DRAWINGS ARE TO BE USED FOR CONSTRUCTING THE FOUNDATION AND STRUCTURE ONLY, SEE DRAWINGS AND SPECIFICATIONS OF THE ARCHITECT FOR ALL NON STRUCTURAL INFORMATION AND DETAILS.
- 2. ALL DIMENSIONS TO TAKE PRECEDENCE OVER THE SCALES SHOWN ON THE PLANS, SECTIONS, AND DETAILS,
- 3. COORDINATE WITH THE ARCHITECTURAL DRAWINGS FOR OPENINGS, SLOPES, CURBS, DRAINAGE, WATERPROOFING. NAILERS AND INSERTS.
- 4. NO STRUCTURAL CHANGES ARE ALLOWED WITHOUT THE WRITTEN APPROVAL OF LUIZ LEON & ASSOCIATES LTD.
- 5. ALL CONSTRUCTION MUST BE IN ACCORDANCE WITH THE 1998 BRITISH COLUMBIA BUILDING CODE, AND ALL REFERENCED
- 6. DO NOT CONSTRUCT FROM THESE DRAWINGS UNLESS THEY ARE MARKED "ISSUED FOR CONSTRUCTION", DO NOT SCALE DRAWINGS.
- 7. DO NOT CUT OR DRILL ANY OPENINGS INTO STRUCTURAL MEMBERS WITHOUT OBTAINING WRITTEN PERMISSION FROM THE STRUCTURAL ENGINEER.

INSPECTIONS

- THE CONTRACTOR SHALL NOTIFY THE ENGINEER 24 HOURS IN ADVANCE FOR INSPECTION AND APPROVAL OF THE FOLLOWING:
- A) WOOD FRAMING TO BE INSPECTED PRIOR TO COVER-UP BUT AFTER ALL FRAMING IS COMPLETE AND ALL ROUGH-IN PLUMBING, WIRING AND HEATING HAS BEEN INSTALLED.
- B) REINSPECTIONS AS REQUIRED BY DEFICIENCIES IN PRIOR INSPECTIONS,

DESIGN CRITERIA

ALL DESIGNS HAVE BEEN COMPLETED IN ACCORDANCE WITH THE 1998 BRITISH COLUMBIA BUILDING CODE

2. DESIGN LOADS LIVE LOAD

TYP. FLOOR

LL = 100.0 PSF

DEAD LOAD TYP. FLOOR

V = 0.2

DL = 15.0 PSF

SEISMIC FACTORS Za = Zv = 4.0

WIND

q = 9.2 PSF (1/30)

- ALL TIMBER FRAMING HAS BEEN DESIGNED IN ACCORDANCE WITH CAN/CSA-086,1-M94.
- ALL TIMBER SHALL BE KILN DRIED WITH MAXIMUM MOISTURE CONTENT OF 19% PER B.C. HOUSING 4 HPO REQUIREMENTS AND TO BE OF THE FOLLOWING GRADES:

BEAMS S.P.F. KD. or D. FIR No. 1/2 AND BETTER S.P.F. KD. or D. FIR No. 1/2 AND BETTER STUDS S.P.F. KD. or D. FIR No. 1/2 AND BETTER

- FLOOR SHEATHING SHALL BE 5/8" MIN. D. FIR TONGUE & GROOVE COFI MINIMUM EXTERIOR GRADE FIR PLYWOOD OR SPRUCE LAID STAGGERED, GLUED, AND FASTENED TO SUPPORTS WITH 2.5" COMMON NAILS AT 4" O/C ALONG PANEL EDGES AND AT 8" O/C ALONG INTERMEDIATE SUPPORTS (TYP. UNO).
- 4 LINTELS AND HEADERS SHALL BE 2-2 x 10 S.P.F. #2 AND BETTER KD \$ LESS THEN 19% MOISTURE CONTENT UNLESS OTHERWISE NOTED.
- STUDS SUPPORTING BUILT-UP BEAMS SHALL HAVE THE SAME NUMBER OF LAMINATIONS AS THE BEAM THEY SUPPORT PLUS A NUMBER OF STUDS SO AS TO PROVIDE THE REQUIRED BEARING LENGTH AND ENSURE PROPER FOUNDATION SUPPORT UNLESS NOTED OTHERWISE ON DWGS.
- ALL WOOD IN CONTACT WITH CONCRETE TO BE PRESSURE TREATED OR ISOLATED FROM CONCRETE WITH APPROVED MEMBRANE.
- 7. APPROVED JOIST HANGERS TO BE USED AT ALL FLUSH CONNECTIONS.
- 8. ALL CONNECTIONS AND SUPPORT HANGERS TO BE ENGINEER APPROVED AND SUPPLIED BY THE BEAM AND JOIST MANUFACTURER.
- 9. ALL PLYWOOD TO BE SHEATHING GRADE TO CSA STANDARD 0121 OR 0151.
- 10. STUD WALL SHALL HAVE CONTINUOUS DOUBLE TOP PLATES LAPPED AT WALL INTERSECTIONS
- ALL PLUMBING STUD WALLS TO BE 2×6 @ 16" O.C. ALSO SEE ARCH, DRAWINGS FOR WALL TYPES.
- 12. ALL POINT LOAD BLOCKING TO BE CARRIED TO THE FOUNDATION
- 13. SEE ARCHITECTURAL DRAWINGS FOR ALL DIMENSIONS.

SHEARWALLS

- 1. PROVIDE 1/2" PLYWOOD AT SHEARWALLS NAIL TO FRAME C/W MIN. 21/2" NAILS AT 3" O.C. ALONG EDGES & 6" O.C. WITHIN FIELD.
- 2. SOLID BLOCK ALL EDGES

MATL - MATERIAL

ABBREVIATIONS

AFF	-	ABOVE FINISH FLOOR	MAX	-	MAXIMUM
AGG	~	AGGREGATE	MFR	-	MANUFACTURER
ARCH	-	ARCHITECT	MIN	-	MINIMUM
BLDG	-	BUILDING	MK	_	MARK
BLK	_	BLOCK	M	_	MOMENT
BM	-	BEAM	NIC	~	NOT IN CONTRACT
BOB	_	BOTTOM OF GRADE BEAM	NO	_	NUMBER
BOT	-	BOTTOM	NSG	_	NON-SHRINK GROUT
C	_	COMPRESSION	NTS	_	NOT TO SCALE
CJ	_	CONSTRUCTION JOINT	00		ON CENTER
CL	-	CENTERLINE	OP HD		
CMU	_	CONCRETE MASONRY UNIT		_	
COL	_				PENETRATION
		CONCRETE	PSF.		POUNDS PER SQ. FOOT
		CONTRACTOR			
			PSI	-	
D	-	DIAMETER	R		RADIUS
DET	-	DETAIL	REINF		
DIAM	-	DIAMETER	SCHED		
DIM	-	DIMENSION	SECT	-	SECTION
EJ	-	EXPANSION JOINT	SHT		SHEET
ELEV	-	ELEVATION	STD	~	STANDARD
ENGR	-	ENGINEER	S.W.	-	SHEARWALL
EP	***	EMBEDDED PLATE	STL	-	STEEL
EXIST	-	EXISTING	Tricke &	-	TENSION
FABR	-	FABRICATOR	TOC	-	TOP OF CONCRETE
FF	~		TOF	-	TOP OF FOOTING
FK	-	FOOT KIPS	TOJ	-	TOP OF JOIST
HOR	-		TOP	-	TOP OF PIER
INT	-		TOS	-	TOP OF STEEL
JB	-		TOW	-	TOP OF WALL
JST K	-	(OR J) JOIST	TYP	-	TYPICAL
LB	_	KIP (1,000 LB)	UNO	_	UNLESS NOTED OTHERWISE
	-	POUND	WD	-	WOOD

PRE-ENGINEERED ROOF & FLOOR JOISTS. BEAMS. & TRUSSES

- ALL BEAMS, JOISTS, AND TRUSSES SHALL BE INSTALLED AS PER SHOP ERECTION DRAWING DETAILS, FOLLOWING ALL MANUFACTURERS INSTRUCTIONS AND RECOMMENDATIONS
- 2. BUILT-UP BEAMS SHALL BE CONNECTED TOGETHER BY NAILS AND BOLTS FOR TOP LOADED OR SIDE LOADED CONDITIONS TO MANUFACTURERS RECOMMENDATIONS.
- ALL CONNECTIONS AND SUPPORT HANGERS TO BE ENGINEER APPROVED AND SUPPLIED BY MANUFACTURER.
- 4. JOISTS TO BE DOUBLED AROUND OPENINGS.
- 5. ALL WOOD IN CONTACT WITH CONCRETE TO BE PRESSURE TREATED OR ISOLATED FROM CONCRETE WITH APPROVED MEMBRANE.
- PROVIDE SHOP AND ERECTION DRAWINGS OF ROOF AND FLOOR JOISTS SYSTEMS, SIGNED AND SEALED BY AN ENGINEER REGISTERED IN THE PROVINCE OF BRITISH COLUMBIA.
- 7. ALL MICRO LAM MEMBERS TO BE 1.9E MICRO LAM LVL OR APPROVED EQUAL, MULTIPLE MEMBER MICRO LAM BEAMS TO BE NAILED TOGETHER WITH A MIN. OF 3 ROWS OF 3.5" COMMON NAILS AT 12" O.C. FROM BOTH SIDES
- 8. ALL PARALLAM MEMBERS TO BE 2.0E DF. PARALLAM PSL
- 9. ALL TIMBERSTRAND MEMBERS TO BE I.TE TIMBERSTRAND LSL UN.O.

THE CITY HAS RELIED EXCLUSIVELY ON THE UNDERSIGNED REGISTERED PROFESSIONAL FOR THE ADEQUACY OF THE PLANS IN CONFORMANCE

SUBMITTED WITH THIS APPLICATION FOR A BUILDING PERMIT. L.G. LEON

WITH THE CURRENT EDITION OF THE B.C. BUILDING CODE IN REVIEWING THE PLANS

PERMIT ISSUED BY DATE

Richmond Building Approvals Department

City review of this document:

- 1. does not relieve the Owner of Lands referred to in this document from full responsibility for work being carried out in compliance with City and Provincial enactments:
- 2. is subject to terms and conditions printed or the pounts and proscribed in the City bylaws.

MAY 18,2006 ISSUED FOR BUILDING PERMI DATE DESCRIPTION




MEZZANINE ADDITION 1165 - 11871 HORSESHOE WAY RICHMOND, B.C.

CLIENT: TASCO ENTERPRISES LTD.

DRAWING TITLE: CITY OF RICHMOND **SPECIFICATIONS** MAY Z 5 2006


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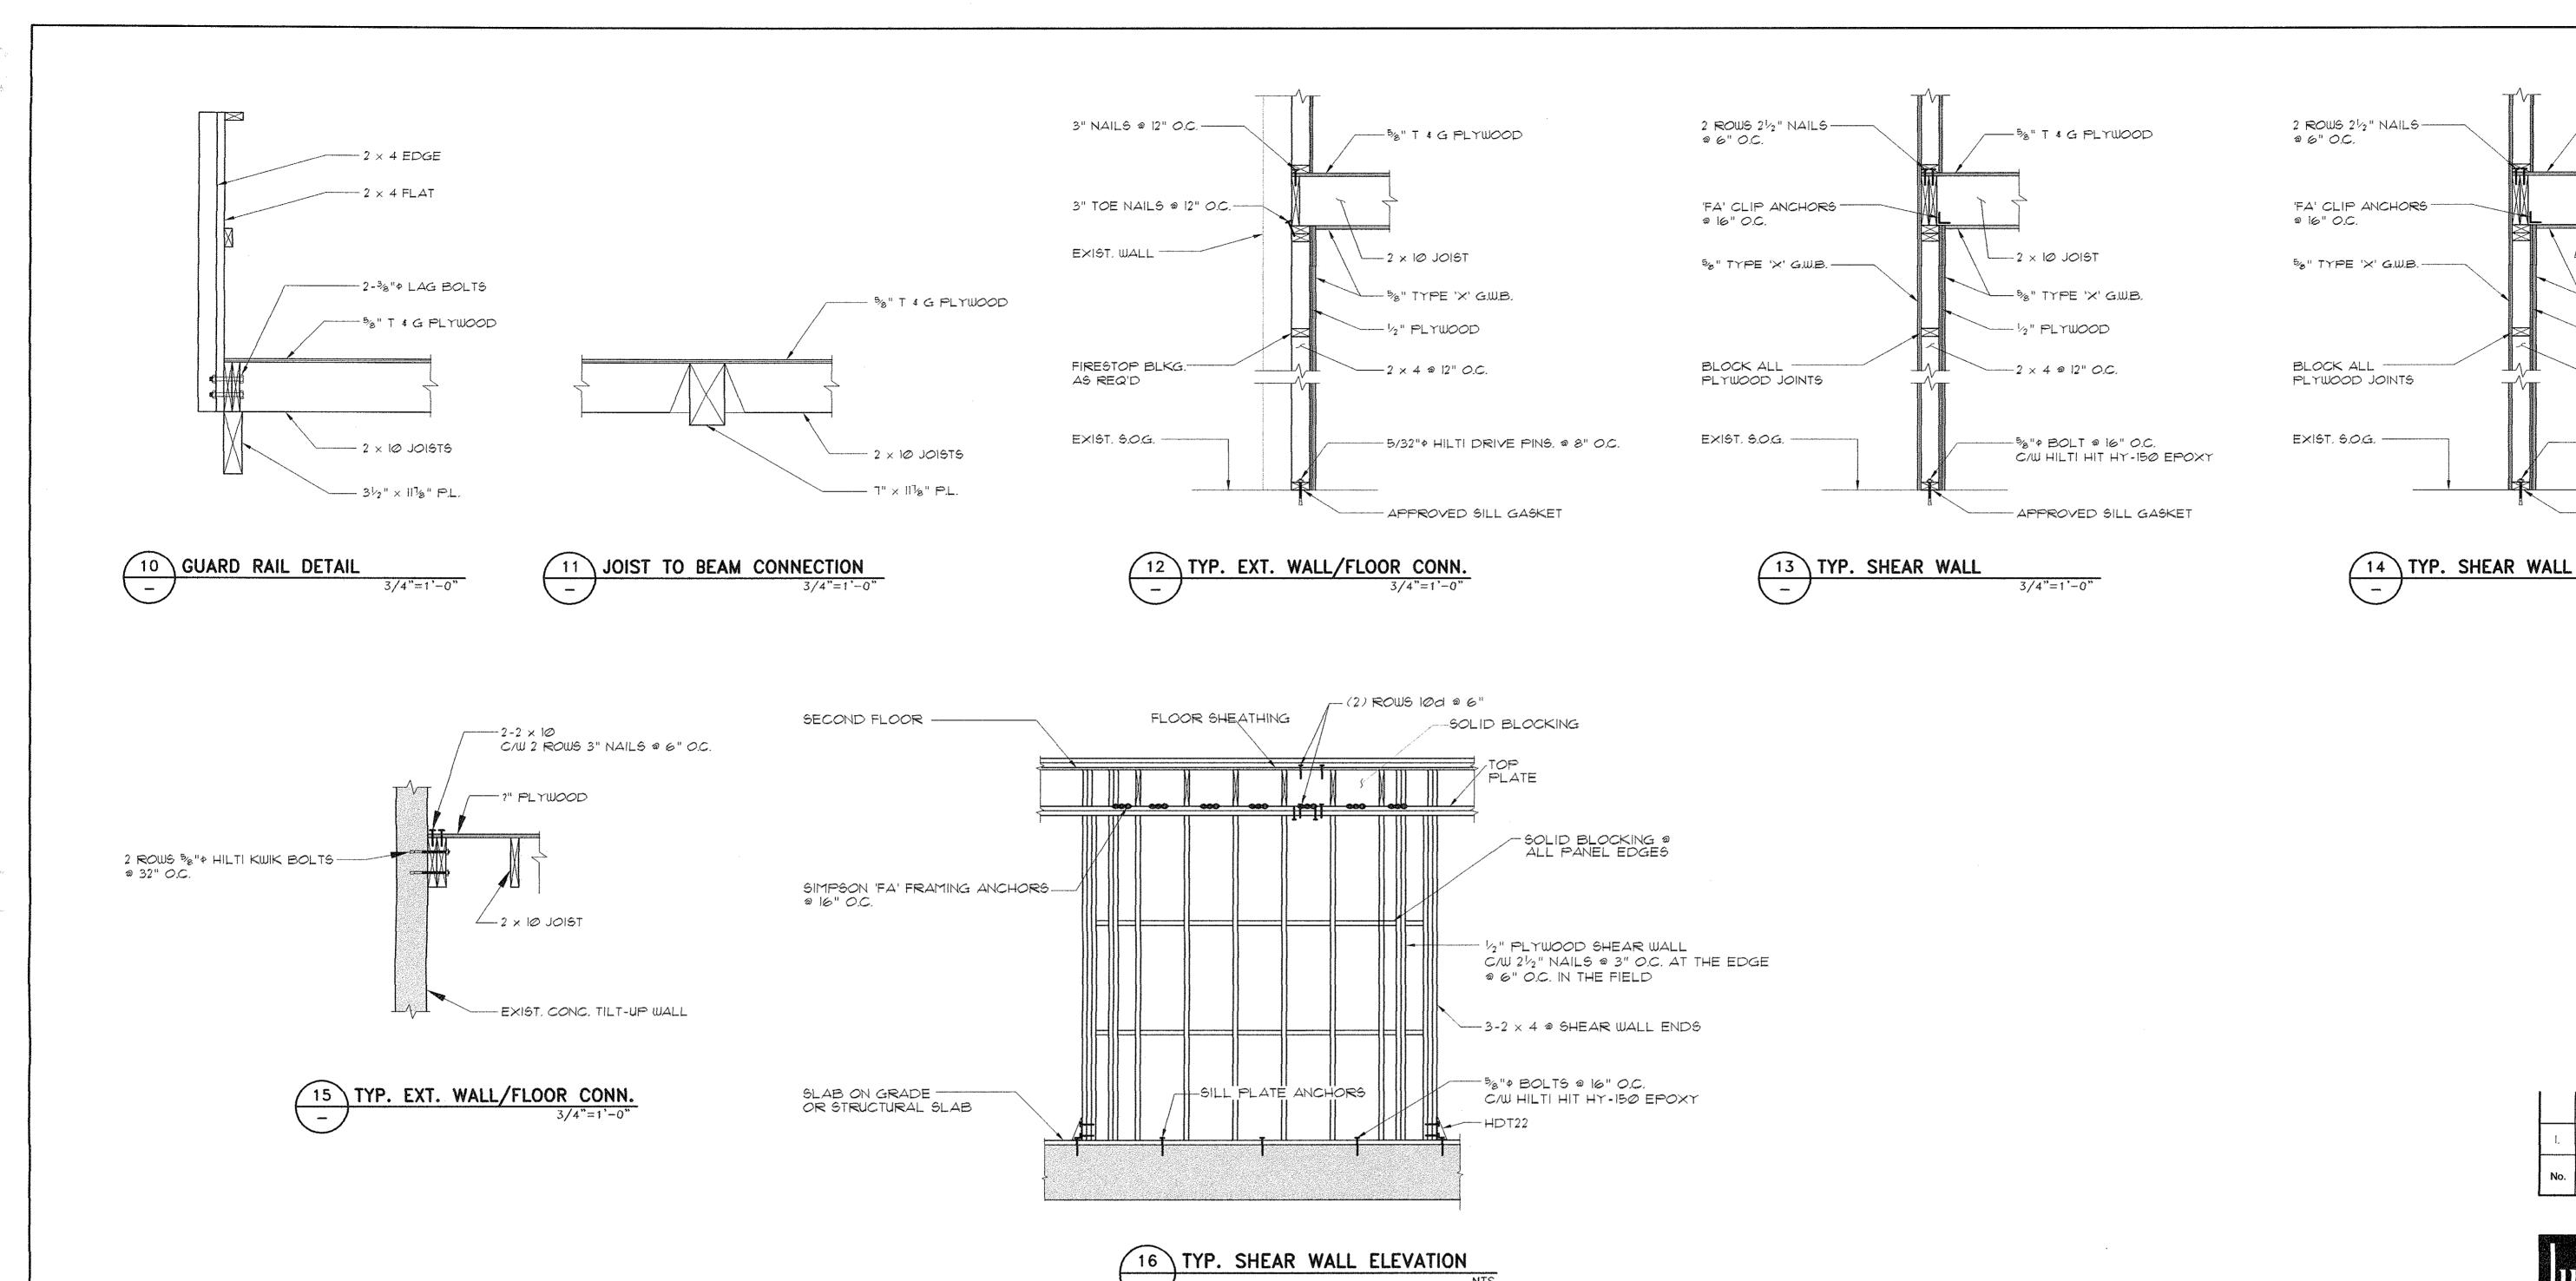


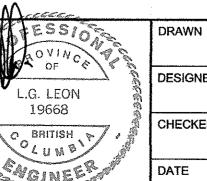
V.N. DESIGNED L.G.L. CHECKED T.N.T. MAY 2006

PROJECT - DRAWING NUMBER

2006-01-23



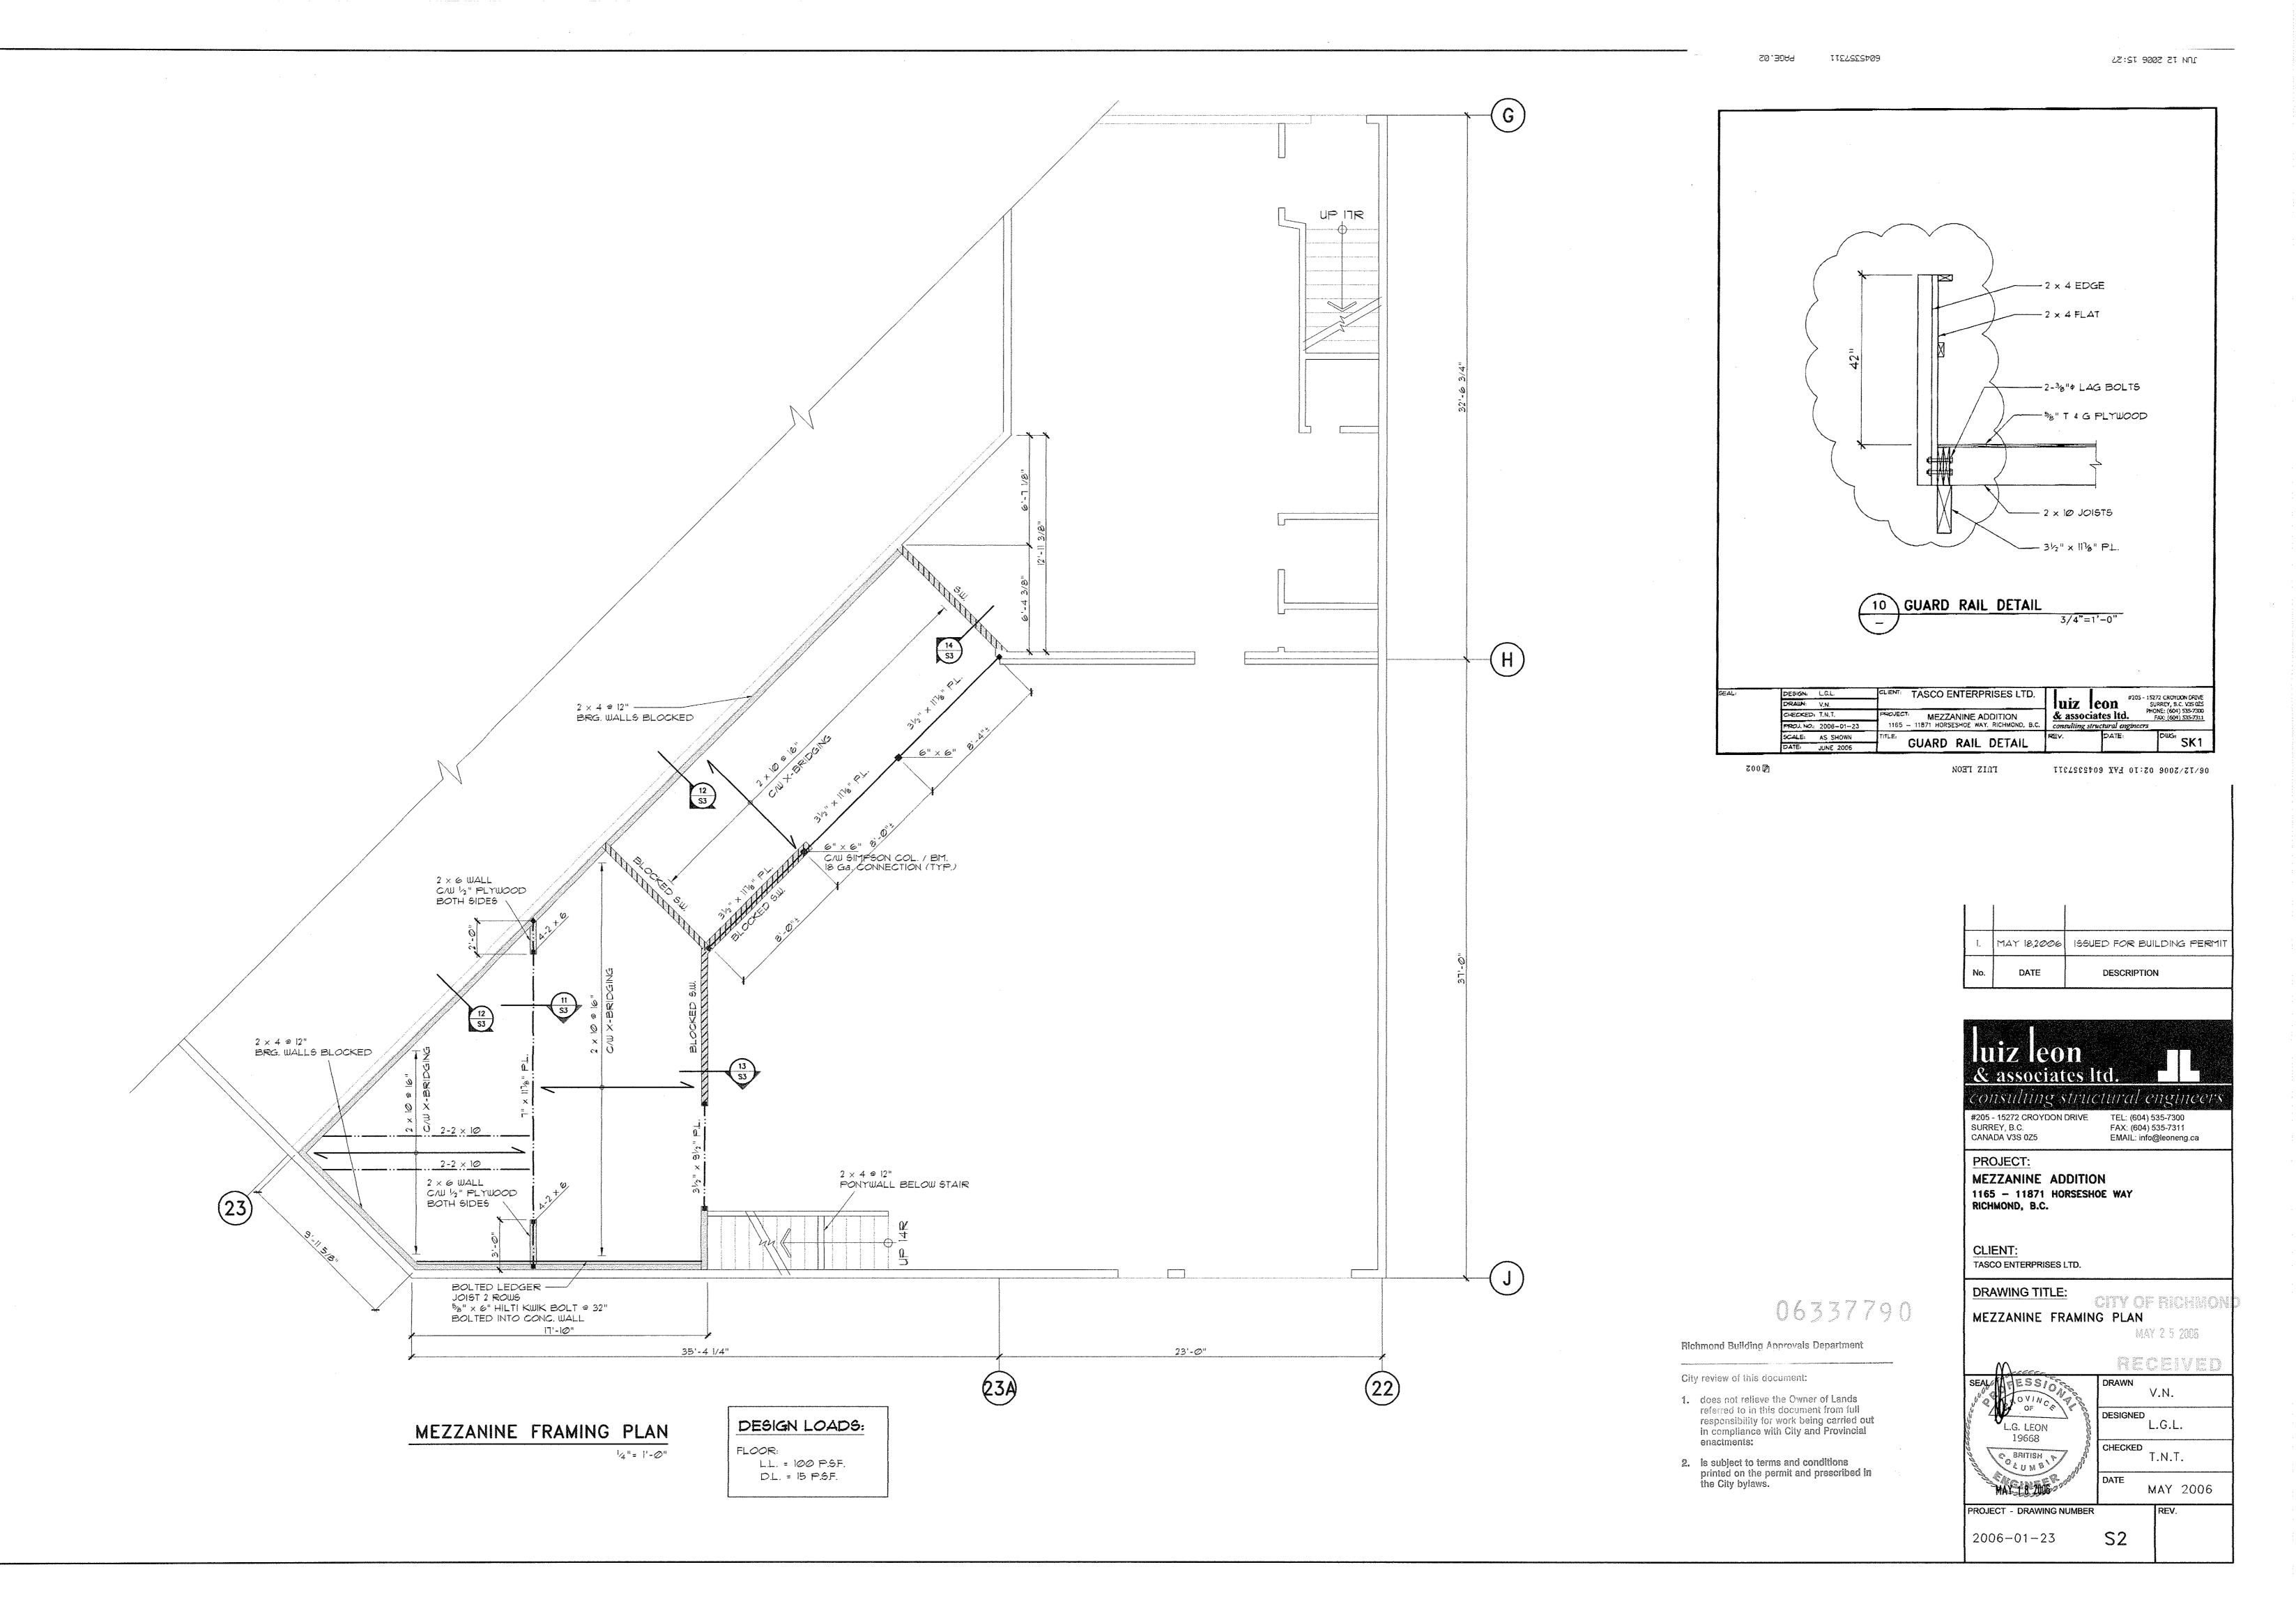

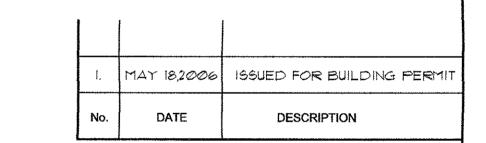

-%" T & G PLYWOOD

- 2 × 10 JOIST

--- 1/2" PLYWOOD

2 × 4 @ 12" O.C.


3/4"=1'-0"

- %" TYPE 'X' GWB.

--- 58" + BOLT @ 16" O.C.

C/W HILTI HIT HY-150 EPOXY

- APPROVED SILL GASKET

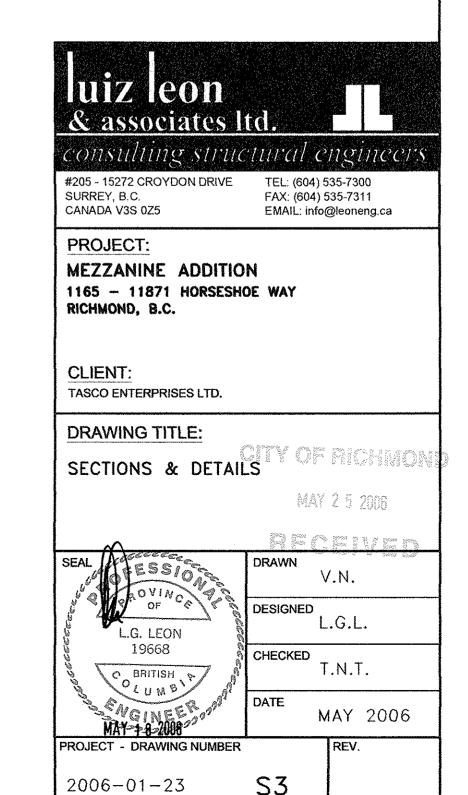


Pichmond Building Approvals Department


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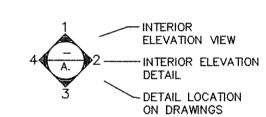
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O APR.10/06 AS BUILT. REV. DATE DESCRIPTION

Tasco Enterprises Ltd. 1165 - 11871 Horseshoe Way, Richmond B.C.

LEGEND

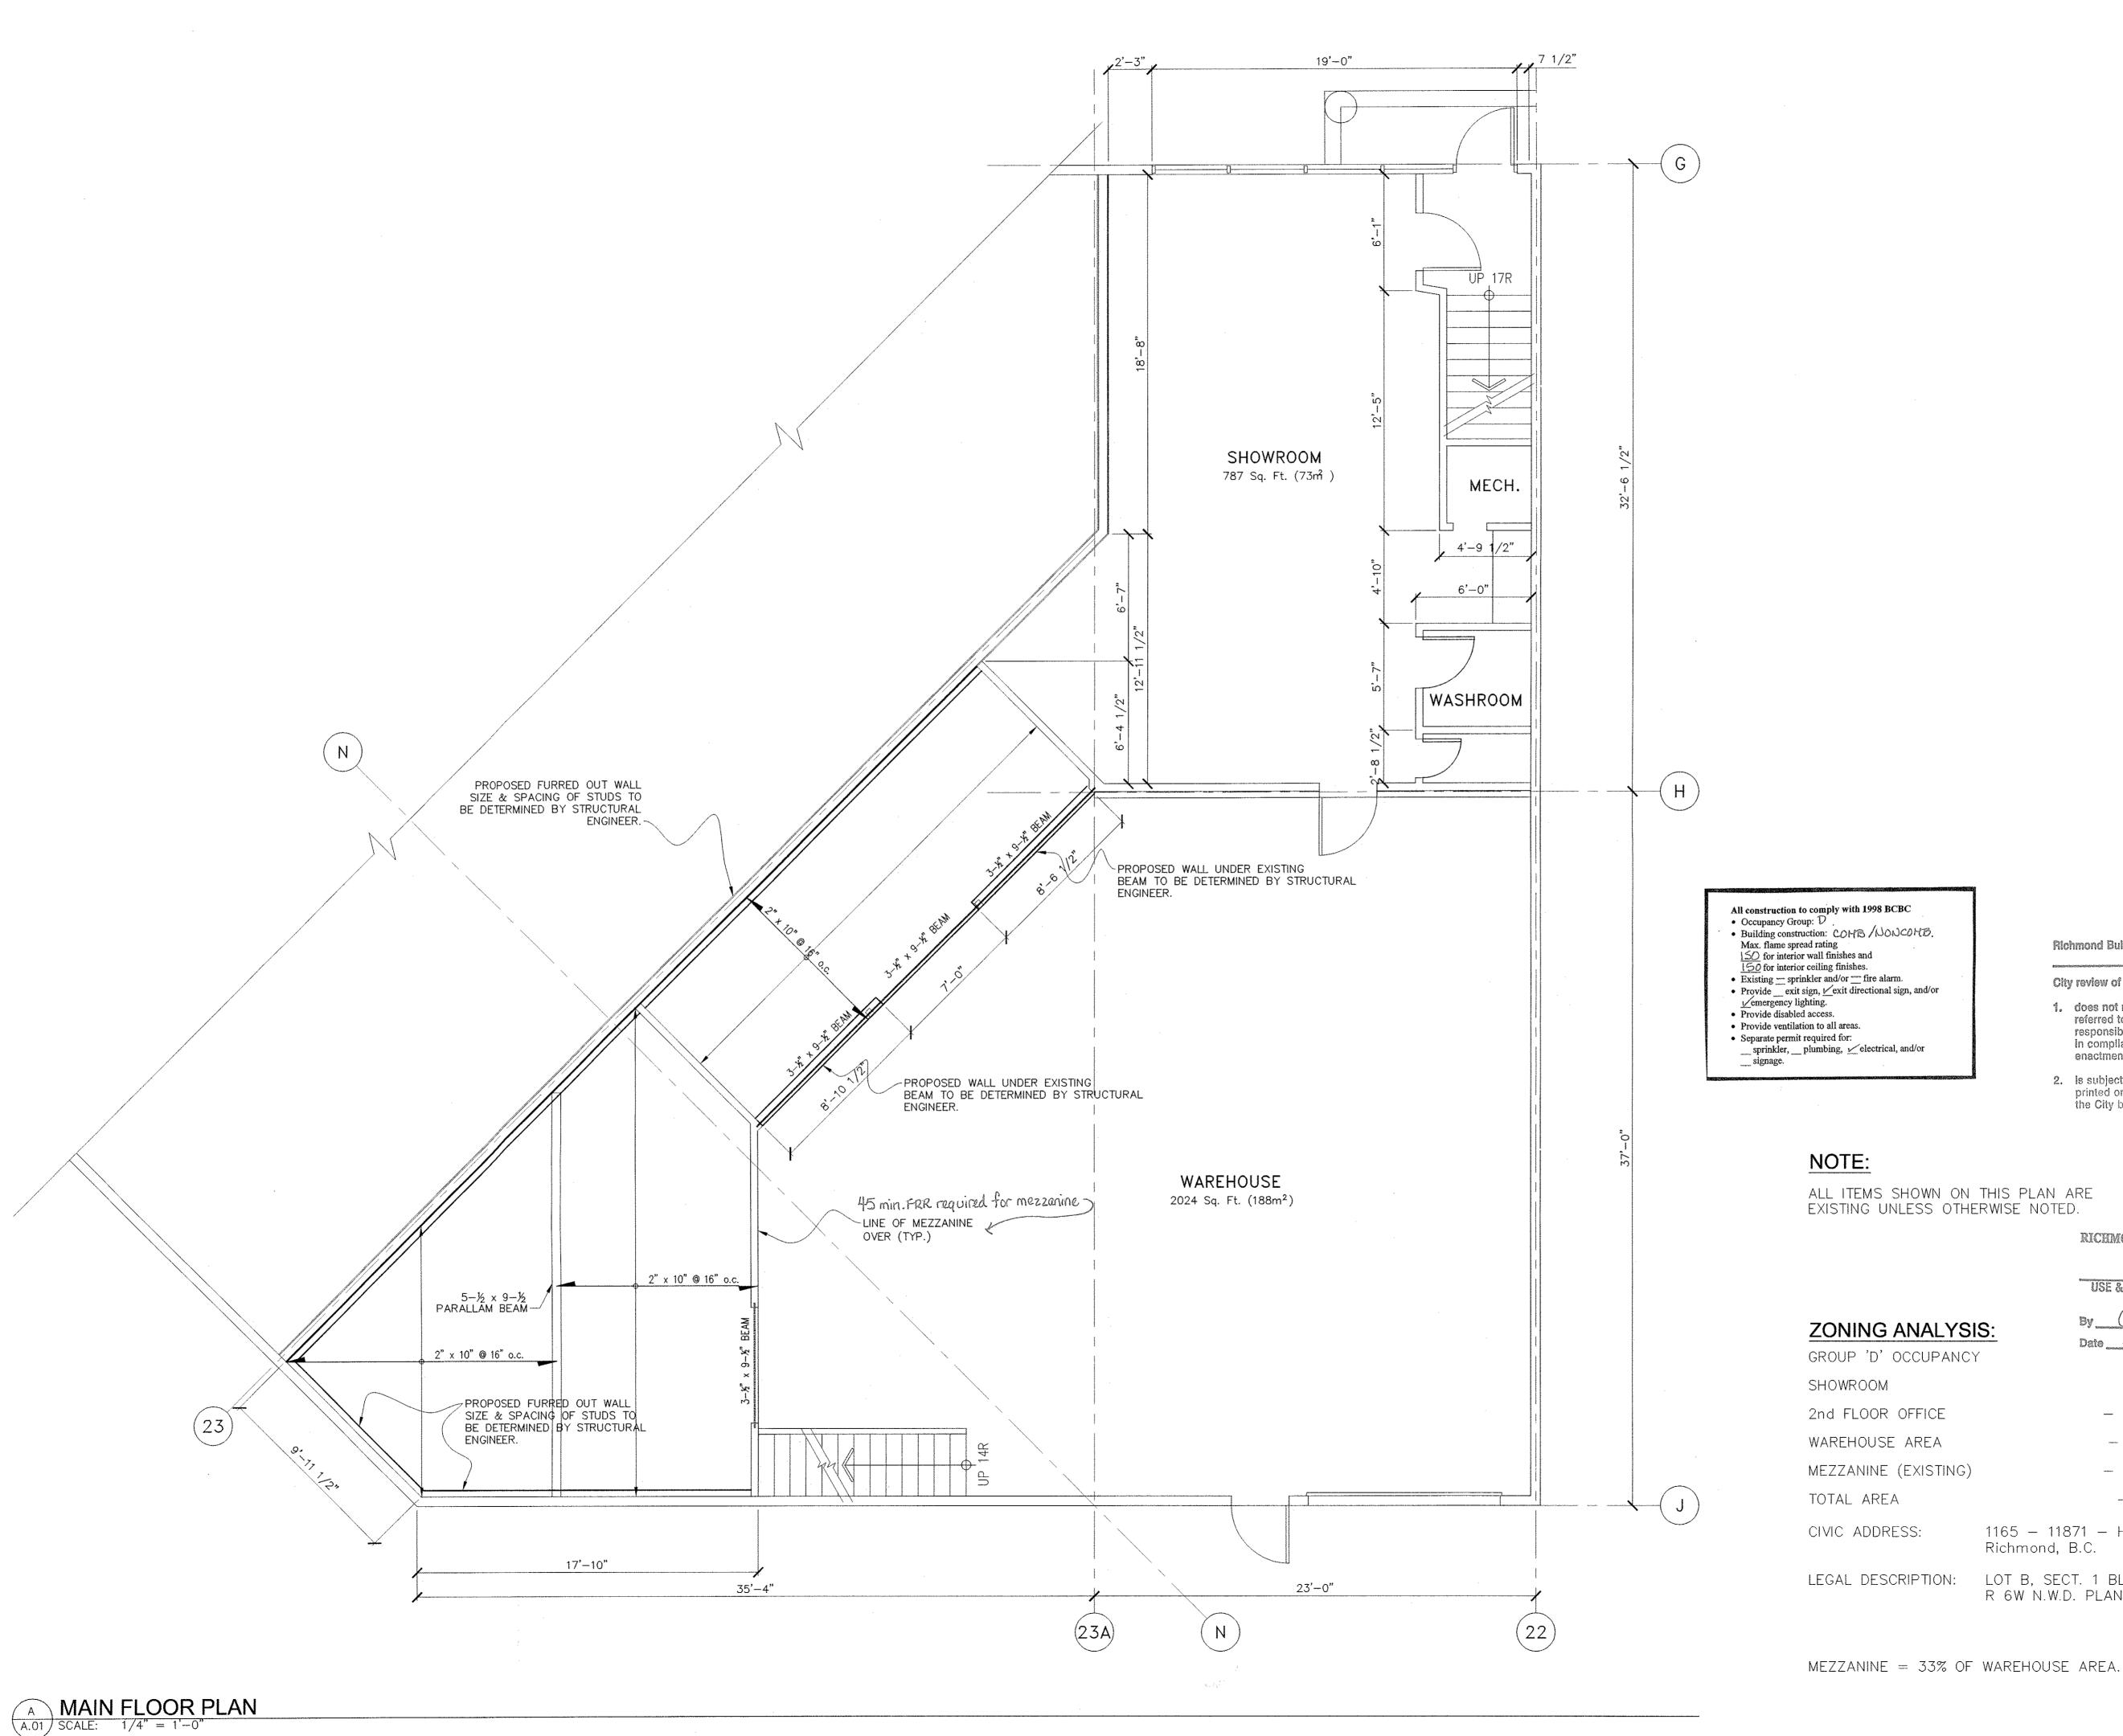

WINDOW TYPE A.02 DETAIL LOCATION IN SPECIFICATION

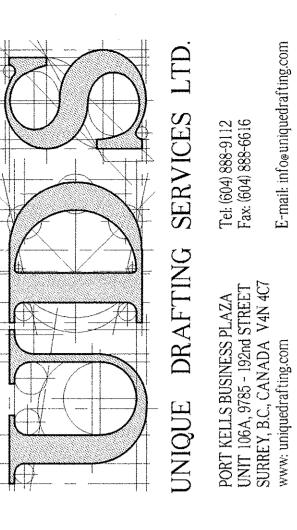DOOR NUMBER TAG (REFER TO DOOR SCHEDULE) A. DETAIL NUMBER

ON DRAWINGS

SCALE: 1/4" = 1'-0"

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Richmond Building Approvals Department

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NOTE:

ALL ITEMS SHOWN ON THIS PLAN ARE EXISTING UNLESS OTHERWISE NOTED.

> RICHMOND BUILDING APPROVALS DEPARTMENT

By C. Whitty

USE & OCCUPANCY REVIEW ONLY

ZONING ANALYSIS:

Date July 13, 2006 GROUP 'D' OCCUPANCY

- 787 Sq. Ft. (73m) SHOWROOM - 734 Sq. Ft. (68m) 2nd FLOOR OFFICE – 2,024 Sq. Ft. (f88m)

MEZZANINE (EXISTING) TOTAL AREA

1165 — 11871 — Horseshoe Way, CIVIC ADDRESS:

LEGAL DESCRIPTION:

Richmond, B.C.

LOT B, SECT. 1 BLK. 3N R 6W N.W.D. PLAN 76716

06337790

- 669 Sq. Ft. (62m)

- 4,267 Sq. Ft. ²(396m)

CITY OF BICHWOND DATE JUN . 6 2006

DRAWN: S.M., L.K. DATE: 04/10/06 DESIGNED: PROJ. No.: 06-1897 APPROVED: FILE: 1897-A.01

PROJECT TITLE: Tasco Enterprises Ltd.

Unit 1165 1165 - 11871 Horseshoe Way, Richmond B.C.


SHEET TITLE:

MAIN FLOOR PLAN


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1 of 2

REV.:

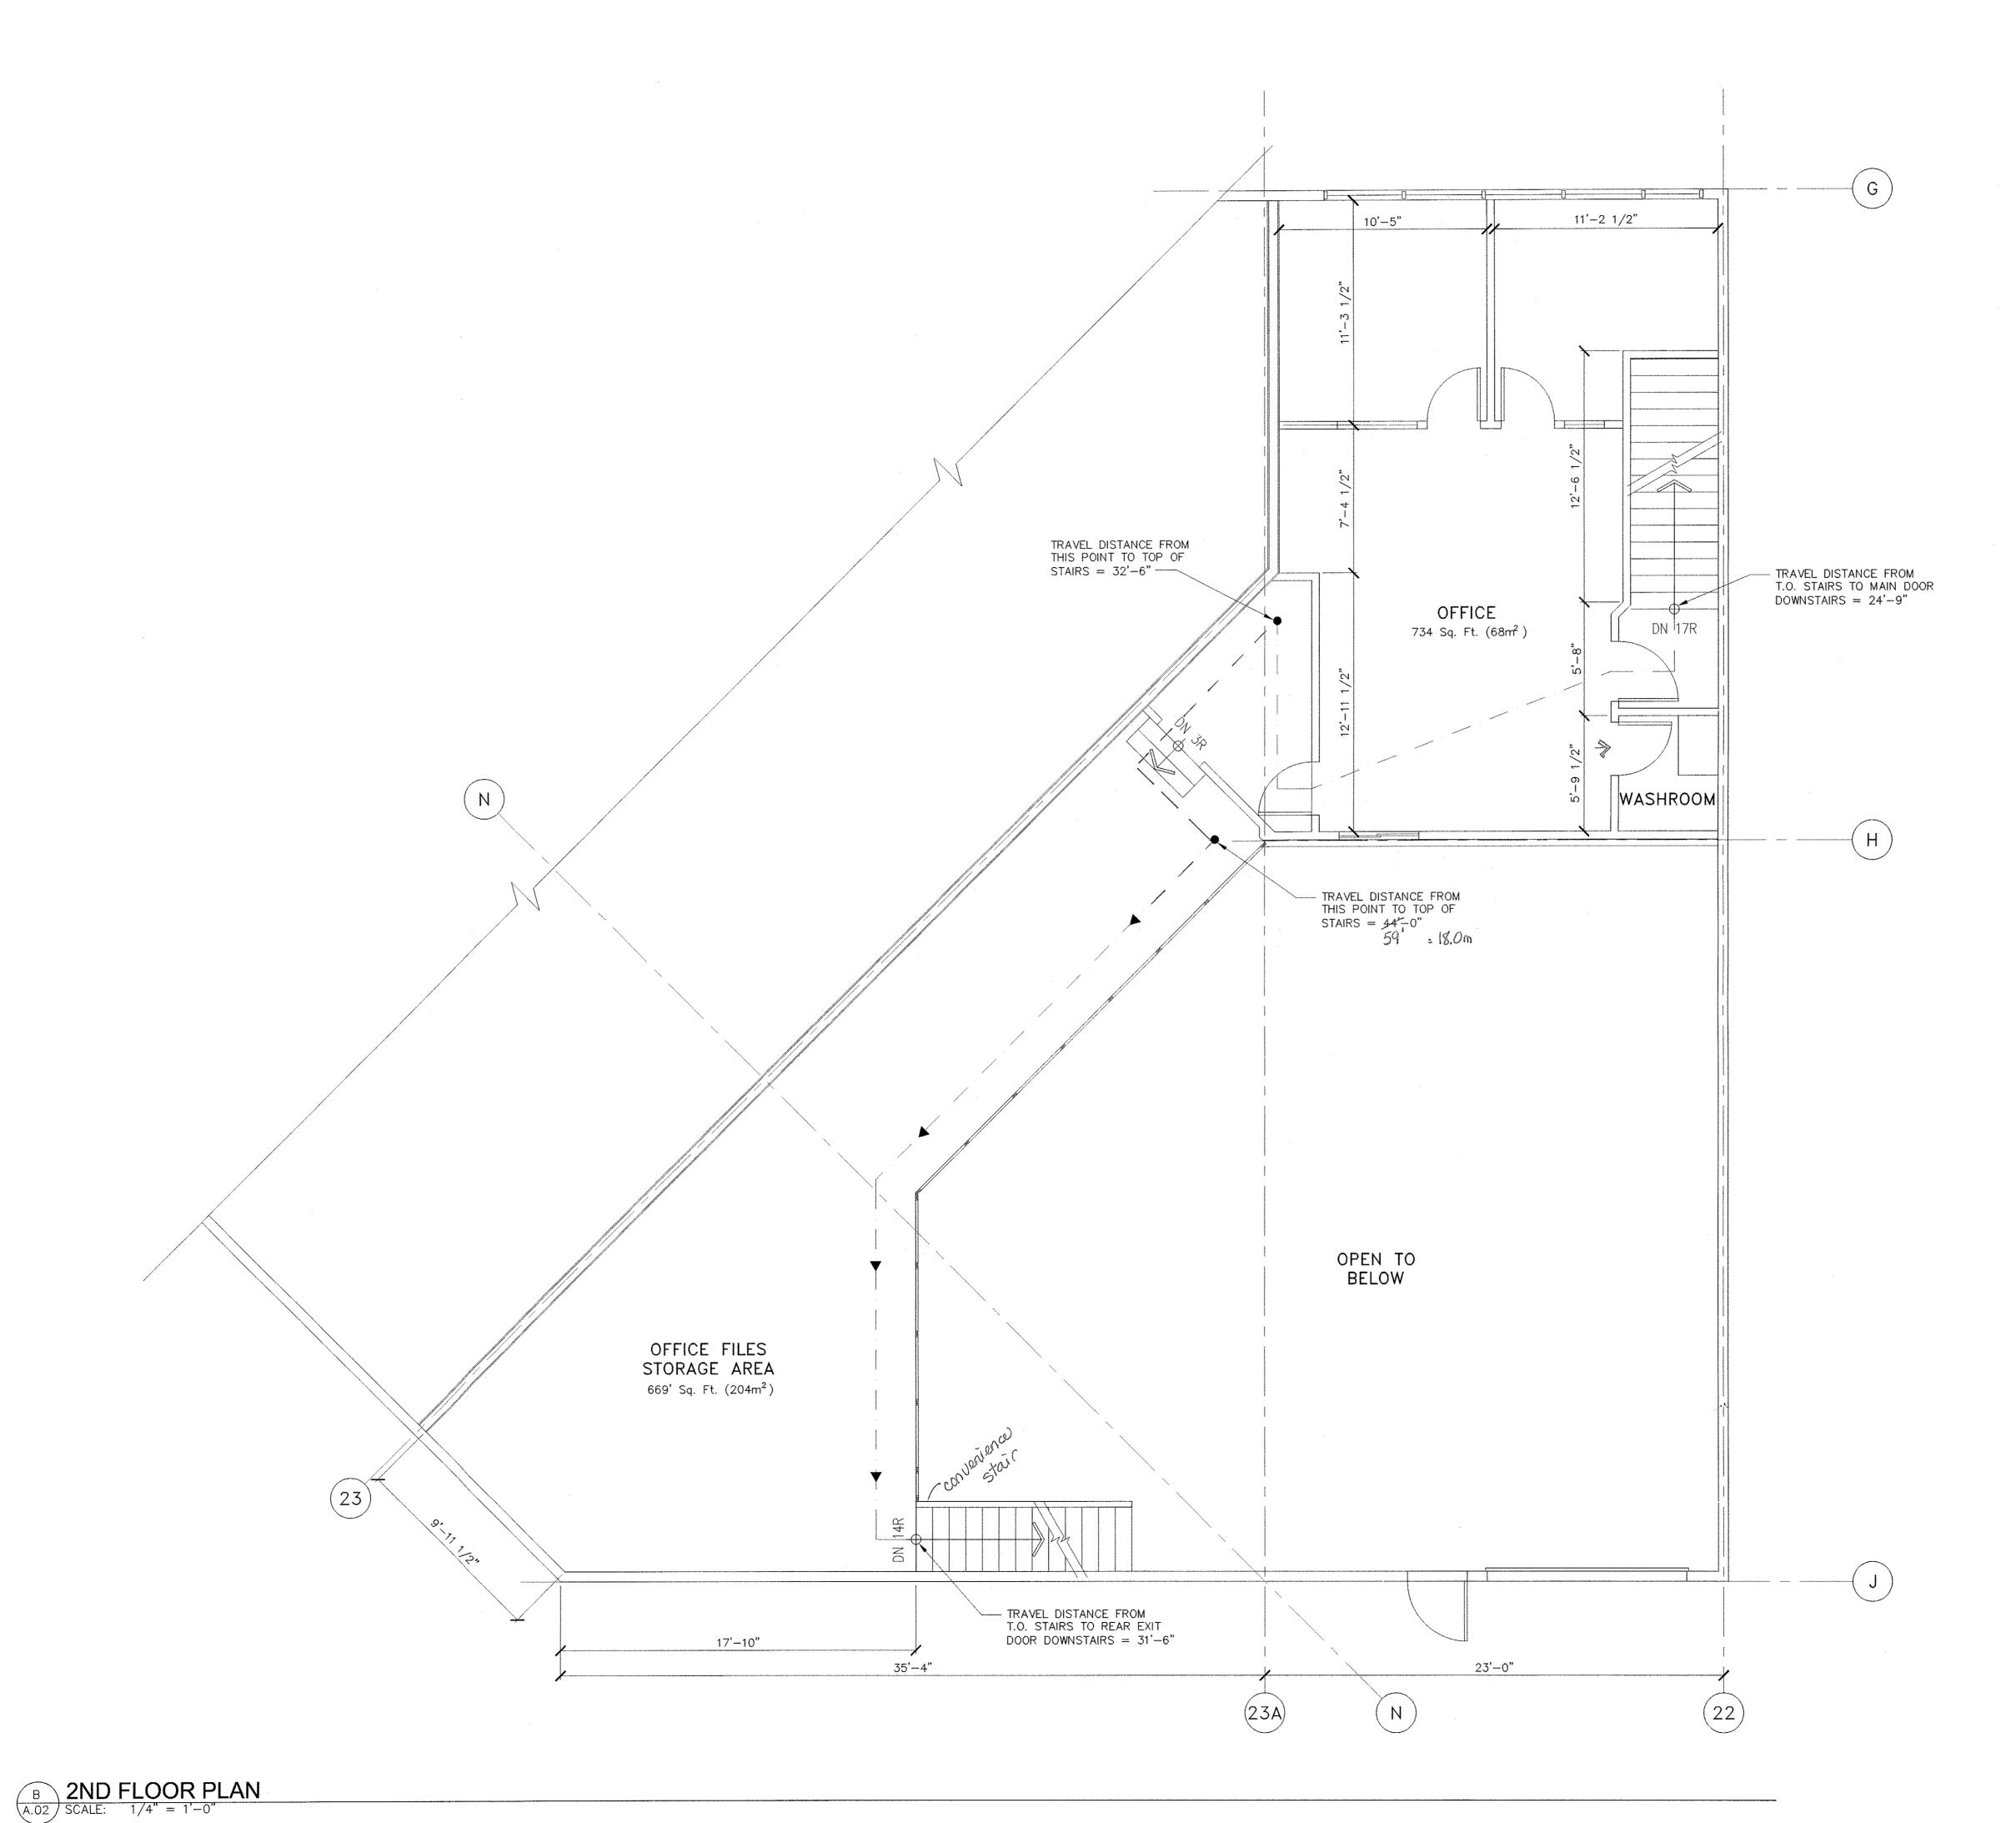

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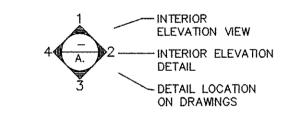


0 APR.10/06 AS BUILT. REV. DATE DESCRIPTION

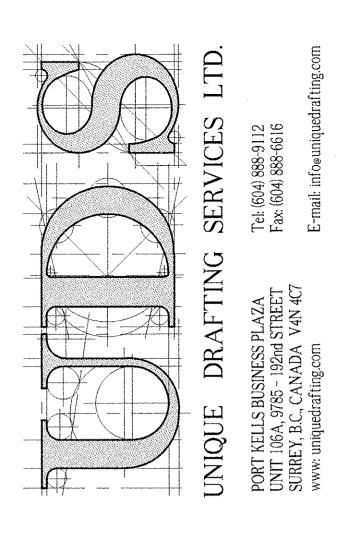Tasco Enterprises Ltd. 1165 - 11871 Horseshoe Way,

Richmond B.C.

LEGEND



WINDOW TYPE

A.02 DETAIL LOCATION
IN SPECIFICATION

DOOR NUMBER TAG (REFER TO DOOR SCHEDULE)

DETAIL NUMBER

DETAIL LOCATION
ON DRAWINGS

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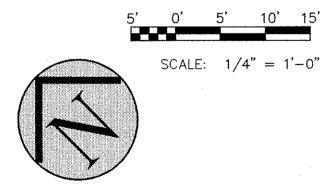
RICHMOND BUILDING APPROVALS DEPARTMENT

USE & OCCUPANCY REVIEW ONLY

By C. Whitty Date July 13, 2006

06337790





DRAWN: L.K., S.M. DATE: 04/10/06 DESIGNED: PROJ. No.: 06-1897

FILE: 1897-A.02

PROJECT TITLE: Tasco Enterprises Ltd.

Unit 1165 1165 - 11871 Horseshoe Way, Richmond B.C.

SHEET TITLE: UPPER FLOOR PLAN

DRAWING No .:

2 of 2