KR MECHANICAL NEW OFFICE

PERMIT AND PRICING PLANS 10/22/2021

ABBREVIATIONS									
AC	ACRE	EXT	EXTERIOR	MATL	MATERIAL	S/S	STUD TO STUD		
ACOUS	ACOUSTICAL	F/F	FINISH TO FINISH	MAX	MAXIMUM	SAB	SOUND ATTENUATION BLANKET		
ACT	ACOUSTIC CEILING TILE	FA	FIRE ALARM	MECH	MECHANIC(AL)	SC	SOLID CORE		
AD	AREA DRAIN	FD	FLOOR DRAIN	MEMB	MEMBRANE	SCHED	SCHEDULE, SCHEDULED		
ADJ	ADJUSTABLE	FDN	FOUNDATION	MFR	MANUFACTURER	SD	SMOKE DETECTOR		
AFC	ABOVE FINISHED CEILING	FE	FIRE EXTINFUISHER	MIN	MINIMUM	SECT	SECTION		
AFF	ABOVE FINISHED FLOOR	FEC	FIRE EXTINFUISHER CABINET	MIR	MIRROR	SF	SQUARE FOOT		
AGGR	AGGREGATE	FHC	FIRE HOSE CABINET	MISC	MISCELLANEOUS	SH	SHOWER		
ALLUM	ALUMINUM	FIN	FINISH (ED)	MLW	MILLWORK	SHLF	SHELF		
ALT	ALTERNATE	FL	FLOOR	MO	MASONRY OPENING	SHT	SHEET		
ALUM	ALUMINUM	FLOUR	FLOURESCENT	MTD	MOUNTED	SHWR	SHOWER		
ANOD	ANODIZED	FOC	FACE OF CONCRETE	MTL	METAL	SIM	SIMILAR		
APPROX	APPROXIMATE	FOF	FACE OF FINISH	N/A	NOT APPLICABLE	SPEC	SPECIFICATION(S)		
ARCH	ARCHITECTURAL	FOM	FACE OF MASONRY	NIC	NOT IN CONTRACT	SPF	SPRAY POLYURETHANE FOAM		
ATTEN	ATTENUATION	FOS	FACE OF STUDS	NO (OR) #	NUMBER	SQ	SQUARE		
BLDG	BUILDING	FR	FIRE RESISTANT	NOM	NOMINAL	SS	STAINLESS STEEL		
BLK	BLOCK	FRMG	FRAMING	NTS	NOT TO SCALE	STC	SOUIND TRANSMISSION		
BLKG	BLOCKING	FRT	FIRE RETARDANT TREATED	OA	OVERALL		COEFFICIENT		
ВО	BY OTHERS	FT	FOOT OR FEET	OBS	OBSCURE	STD	STANDARD		
ВОТ	BOTTOM	FTG	FOOTING	OC	ON CENTER	STL	STEEL		
BRG	BEARING	FURR	FURRING	OD	OUTSIDE DIAMETER	STOR	STORAGE		
BRK	BRICK	FUT	FUTURE	OFF	OFFICE	STR	STAIR		
CAB	CABINET	FV	FIELD VERIFY	OPNG	OPENING	SUSP	SUSPENDED		
СВ	CATCH BASIN	GA	GAUGE	OPP	OPPOSITE	SY	SQUARE YARD		
CEM	CEMENT	GALV	GALVANIZED	OZ	OUNCE	SYM	SYMMETRICAL		
CFM	CUBIC FEET PER MINUTE	GB	GRAB BAR	PA	PUBLIC ADDRESS	T/	TOP OF		
CG	CORNER GUARD	GC	GENERAL CONTRACTOR	РВ	PARTICLE BOARD	TBD	TO BE DETERMINED		
CJ	CONTROL JOINT	GFI	GROUND FAULT INTERRUPTION	PC	PRECAST	TC	TOP OF CURB		
CL	CENTERLINE	GL	GLASS	PCF	POUNDS PER CUBIC FOOT	TDE	TRAVEL DISTANCE TO EXIT		
CLG	CEILING	GND	GROUND	PERF	PERFORATED	TEL	TELEPHONE		
CLKG	CAULKING	GNRL	GENERAL	PL	PLATE	TEMP	TEMPORARY		
CLO	CLOSET	GR	GRADE	PLAM	PLASTIC LAMINATE	THK	THICK		
CLR	CLEAR	GSF	GROSS SQUARE FEET	PLAS	PLASTER	TP	TOP OF PAVEMENT		
CMU	CONCRETE MASONRY UNIT	GWB	GYPSUM WALL BOARD	PLMBG	PLUMBING	TRD	TREAD		
CNTR	COUNTER LINE	GYP	GYPSUM	PLYWD	PLYWOOD	TSTAT	THERMOSTAT		
CO	CLEANOUT	HDWD	HARDWOOD	PNL	PANEL	TV	TELEVISION		
COL	COLUMN	HDWR	HARDWARE	PNT	PAINT	TW	TOP OF WALL		
CONC	CONCRETE	HGT	HEIGHT	POL	POLISHED	TYP	TYPICAL		
CONN	CONNECTION	HM	HOLLOW METAL	PR	PAIR	WH	WATER HEATER		
CPT	COMMON PATH OF TRAVEL	HORIZ	HORIIZONTAL	PREFAB	PREFABRICATED	UC	UNDER COUNTER		
CPT	CARPET	HR	HOUR	PROP	PROPERTY	UL	UNDERWRITERS		
CR	CARD READER		HEIGHT	PSF	POUNDS PER SQUARE FOOT	OL .	LABORATORIES		
CW	CURTAINWALL	HT (OR) H HTR	HEATER	PSI	POUNDS PER SQUARE FOOT POUNDS PER SQUARE INCH	UNF	UNFINISHED		
	DEPTH		HEATING, VENTILATION, AIR	PT	POINT	UNO	UNLESS NOTED OTHERWISE		
D DBL	DOUBLE	HVAC	CONDITIONING	PT	PRESSURE TREATED	UON	UNLESS OTHERWISE NOTED		
	DEMOLITION	HW	HOTWATER	PTD	PAINTED	US	UNDER SIDE		
DEMO	DESCRIPTION	IF	INSIDE FACE	PTN	PARTITION	VERT	VERTICAL		
DESC		IN	INCH			VEST	VESTIBULE		
DET	DETAIL DEVINITAIN	INCL	INCLUDE	PVC	POLYVINYL CHLORIDE	VG	V SHAPED GROOVE, EIFS		
DF	DRINKING FOUNTAIN	INSUL	INSULATION	QT	QUARRY TILE	VIF	VERIFY IN FILED		
DIA	DIAMETER	INT	INTERIOR	QTR	QUARTER	W	WEST		
DIM	DIMENSION	ITF	INFORMATION TO FOLLOW	R	RISER	W	WIDTH		
DN	DOWN		JANITOR	RAD	RADIUS	W/	WITH		
DR	DOOR	JAN	JOINT	RCP	REFLECTED CEILING PLAN	W/O	WITHOUT		
DTL	DETAIL	JNT		REF	REFERENCE	WC	WATER CLOSET		
DWG	DRAWING	JST	JOIST	REF	REFRIGERATOR	WD	WOOD		
Ε	EAST	KIT	KITCHEN	REINF	REINFORCED	WDW	WINDOW		
EA	EACH	КО	KNOCKOUT	REQD	REQUIRED	WP	WATERPROOF		
EL	ELEVATION	L	LENGTH	RESIL	RESILIENT		WATER RESISTANT		
ELEC	ELECTRICAL	LAM	LAMINATE	REV	REVISION(S) / REVISED	WR			
ELEV	ELEVATOR	LAV	LAVATORY	RGSTR	REGISTER	WRB	WEATHER RESISTANT BARRIER		
EMER	EMERGENCY	LG	LONG	RLG	RAILING	WT	WEIGHT		
ENCL	ENCLOSURE	LH	LEFT HAND	RM	ROOM	WWF	WELDED WIRE FABRIC		
EQ	EQUAL	LKR	LOCKER	RND	ROUND				
ETR	EXISTING TO REMAIN	LOC	LOCATION	RO	ROUGH OPENING				
EMC	ELECTRIC WATER COOLER	ΙP	I OW POINT	POMT	DEOLIIDEMENT				

REQUIREMENT

SOUTH

LOW POINT

MAINTENANCE

LIGHT

MAINT

ELECTRIC WATER COOLER

EXISTING

EXPANSION

EXPOSED

EXIST

EXP

GENERAL PROJECT NOTES

- 1. ALL WORK SHALL CONFORM TO ALL APPLICABLE CODES, STANDARDS AND GOVERNING AUTHORITIES
- 2. REFER TO INTERIOR DESIGN, MECHANICAL, PLUMBING, FIRE PROTECTION AND ELECTRICAL DRAWINGS FOR COORDINATION OF WORK. THE CONTRACTOR IS RESPONSIBLE FOR INFORMATION ON DRAWINGS FROM ALL DISCIPLINES.
- 3. DO NOT SCALE THE DRAWINGS.
- THE CONTRACTOR SHALL VISIT THE SITE AND BECOME KNOWLEDGEABLE OF CONDITIONS.
 THE CONTRACTOR SHALL INVESTIGATE, VERIFY AND BE RESPONSIBLE FOR ALL THE
 REQUIREMENTS OF THE PROJECT AND SHALL NOTIFY THE OWNER AND INTERIOR DESIGNER
 OF ANY EXISTING CONDITIONS REQUIRING INFORMATION BEFORE PROCEEDING WITH ANY
 WORK.
- 5. THE CONTRACTOR SHALL FAMILIARIZE HIM/HERSELF WITH THE EXISTING CONDITIONS AND ADVISE THE OWNER AND INTERIOR DESIGNER, IN WRITING, OF ANY SITUATION THAT WOULD NOT ALLOW HIM/HER TO PROCEED ON THE BASIS OF THESE DOCUMENTS.

 THE CONTRACTOR SHALL VERIES ALL DIMENSIONS AND EXISTING CONDITIONS IN THE FIELD.
- 6. THE CONTRACTOR SHALL VERIFY ALL DIMENSIONS AND EXISTING CONDITIONS IN THE FIELD. ADVISE THE INTERIOR DESIGNER AND OWNER OF ANY DISCREPANCIES PRIOR TO THE COMMENCEMENT OF THAT WORK.
- 7. THE CONTRACTOR SHALL PROTECT ALL EXISTING SITE ELEMENTS FROM DAMAGE DUE TO ALTERATION AND CONSTRUCTION OPERATIONS AND THEY SHALL REPAIR OR REPLACE
- 8. THE CONTRACTOR SHALL MAINTAIN ALL EXISTING EXITS DURING CONSTRUCTION.

ELEMENTS DAMAGED DURING THE PROJECT.

- 9. THE CONTRACTOR SHALL GIVE NOTICE AND COORDINATE WITH THE OWNER FOR ANY TEMPORARY CUT OFF OF ANY UTILITIES PRIOR TO COMMENCING WORK.
- 10. THE CONTRACTOR SHALL INSTALL AND MAINTAIN TEMPORARY SIGNAGE FOR ALL PHASES OF CONSTRUCTION TO INDICATE "WARNING CONSTRUCTION AREA DO NOT ENTER" ON THE DOOR TO THE CONSTRUCTION AREA.
- 11. ALL HOLES IN FLOORS OR WALLS AS A RESULT OF DEMOLITION SHOULD BE FILLED, REPAIRED, AND PREPPED TO RECEIVE NEW FINISHES AS APPLICABLE.
- 12. ALL WORK SHALL CONFORM TO THE LATEST EDITION OF THE U.S. GYPSUM PRODUCTS AND SYSTEMS SPECIFICATION BULLETIN OR NATIONAL GYPSUM COMPANY'S LATEST SPECIFICATIONS EXCEPT AS NOTED. ALL GYPSUM BOARD TO BE FIRE RESISTIVE UNLESS NOTED OTHERWISE.
- 13. TYPICAL INTERIOR PARTITIONS SHALL BE 3-5/8" METAL STUDS AT 16" CENTERS WITH 5/8" GWB SMOOTH FINISH ON BOTH SIDES. ANY DRYWALL CEILINGS OR SOFFITS SHALL BE 5/8" GWB WITH A SMOOTH FINISH.
- 14. TYPICAL EXTERIOR WALLS SHALL BE 5/8" GWB FINISH ON MIN. 1-1/2" MTL FURRING W/ R-11 INSULATION ON EXISTING BRICK SEE PARTITION DETAILS.
- 15. DOOR UNDERCUTS SHALL BE KEPT TO A MINIMAL DIMENSION AND SHALL BE UNIFORM THROUGHOUT THE PROJECT, U.O.N.
- 16. UNLESS NOTED OTHERWISE, ALL FASTENERS AND FASTENING DEVICES ARE TO BE CONCEALED IN ALL FINISHED SPACES.
- 17. SEE MECHANICAL, PLUMBING, FIRE PROTECTION, AND ELECTRICAL DRAWINGS TO DETERMINE QUANTITIES OF DIFFUSERS, GRILLES, LIGHT FIXTURES, ETC.
- 18. THE CONTRACTOR SHALL VERIFY WITH THE MATERIAL SUPPLIERS THAT THE PROPOSED MATERIALS ARE CORRECT AND PROPER FOR THE INTENDED APPLICATION AND USE.
- 19. ALL WOOD BLOCKING AND CONCEALED LUMBER TO BE FIRE RETARDANT TREATED.
 PROVIDE BLOCKING IN WALLS, SOFFITS, AND CEILINGS RECEIVING SIGNAGE, COAT HOOKS,
 LOCKERS, MARKER BOARDS, AND OTHER MOUNTED ITEMS, ACCORDING TO THE
 MANUFACTURER'S RECOMMENDATIONS.
- 20. AT PLACES WHERE MATERIALS ARE APPLIED TO, OR ARE IN DIRECT CONTACT WITH WORK INSTALLED BY ANOTHER SUBCONTRACTOR, COMMENCEMENT OF WORK IMPLIES THE ACCEPTANCE OF THE SUBSTRATE AND EXISTING CONDITIONS AS SUITABLE FOR THE APPLICATION INTENDED.
- 21. ALL WORK SHALL BE EXECUTED IN A WORKMANLIKE MANNER. CONSTRUCTION OF NEW HORIZONTAL SURFACES SHALL BE LEVEL AND FLAT AND NEW VERTICAL SURFACES SHALL BE CONSTRUCTED TO BE PLUMB, UNLESS NOTED OTHERWISE.
- 22. ALL CONTRACTOR PROVIDED MATERIALS SHALL BE NEW AND DELIVERED AND INSTALLED IN GOOD CONDITION AND WITHOUT ANY DEFECTS.
- 23. ANY WORK NOT CONFORMING TO THESE SPECIFICATIONS WILL BE REJECTED. THE INTERIOR DESIGNER OR THE OWNER MAY REJECT THE WORK AND REJECTED WORK WILL BE REMOVED AND REPLACED AT NO ADDITIONAL COST TO THE OWNER.

STUDIO 10-19

STUDIO1019, LLC | IB26001903 (407)-864-1885 becca@studio1019.com

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KR MECHANICAL NEW OFFICE

2672 PHYLLIS STREET JACKSONVILLE, FL 32206

CONTACT
RAYMOND CHIN & KERRY MOWLAM


REVISIONS


. Description

INTERIOR DESIGN DRAWING INDEX

	SHEET ISSUE	CURRENT	REVISION	REVISION
NAME	DATE	REVISION	DATE	ISSUED
R DESIGN				
GENERAL NOTES, ABBREVIATIONS, SYMBOLS, AND DRAWING INDEX	10/22/2021			No
EXIT PLAN AND PROJECT INFORMATION	10/22/2021			No
DEMOLITION PLAN	10/22/2021			No
DEMOLITION REFLECTED CEILING PLAN	10/22/2021			No
NEW PLAN	10/22/2021			No
NEW REFLECTED CEILING PLAN	10/22/2021			No
ENLARGED PLANS	10/22/2021			No
INTERIOR ELEVATIONS	10/22/2021			No
INTERIOR ELEVATIONS	10/22/2021			No
INTERIOR ELEVATIONS AND EXTERIOR STOREFRONT	10/22/2021			No
DOOR SCHEDULE & DETAILS	10/22/2021			No
FINISH PLAN	10/22/2021			No
FURNITURE PLAN	10/22/2021			No
	GENERAL NOTES, ABBREVIATIONS, SYMBOLS, AND DRAWING INDEX EXIT PLAN AND PROJECT INFORMATION DEMOLITION PLAN DEMOLITION REFLECTED CEILING PLAN NEW PLAN NEW REFLECTED CEILING PLAN ENLARGED PLANS INTERIOR ELEVATIONS INTERIOR ELEVATIONS INTERIOR ELEVATIONS AND EXTERIOR STOREFRONT DOOR SCHEDULE & DETAILS FINISH PLAN	NAME R DESIGN GENERAL NOTES, ABBREVIATIONS, SYMBOLS, AND DRAWING INDEX EXIT PLAN AND PROJECT INFORMATION DEMOLITION PLAN DEMOLITION REFLECTED CEILING PLAN NEW PLAN NEW PLAN NEW REFLECTED CEILING PLAN 10/22/2021 NEW REFLECTED CEILING PLAN 10/22/2021 INTERIOR ELEVATIONS INTERIOR ELEVATIONS INTERIOR ELEVATIONS AND EXTERIOR STOREFRONT DOOR SCHEDULE & DETAILS FINISH PLAN 10/22/2021	NAME R DESIGN GENERAL NOTES, ABBREVIATIONS, SYMBOLS, AND DRAWING INDEX EXIT PLAN AND PROJECT INFORMATION DEMOLITION PLAN DEMOLITION REFLECTED CEILING PLAN NEW PLAN NEW PLAN NEW REFLECTED CEILING PLAN NEW REFLECTED CEILING PLAN NEW REFLECTED CEILING PLAN NEW REFLECTED CEILING PLAN 10/22/2021 ENLARGED PLANS 10/22/2021 INTERIOR ELEVATIONS 10/22/2021 INTERIOR ELEVATIONS AND EXTERIOR STOREFRONT DOOR SCHEDULE & DETAILS FINISH PLAN 10/22/2021	NAME DATE REVISION DATE R DESIGN GENERAL NOTES, ABBREVIATIONS, SYMBOLS, AND DRAWING INDEX 10/22/2021 10/22/2021 EXIT PLAN AND PROJECT INFORMATION 10/22/2021 10/22/2021 DEMOLITION PLAN 10/22/2021 10/22/2021 NEW PLAN 10/22/2021 10/22/2021 NEW REFLECTED CEILING PLAN 10/22/2021 10/22/2021 ENLARGED PLANS 10/22/2021 10/22/2021 INTERIOR ELEVATIONS 10/22/2021 10/22/2021 INTERIOR ELEVATIONS AND EXTERIOR STOREFRONT 10/22/2021 10/22/2021 DOOR SCHEDULE & DETAILS 10/22/2021 10/22/2021 FINISH PLAN 10/22/2021 10/22/2021

GENERAL SYMBOL LEGEND

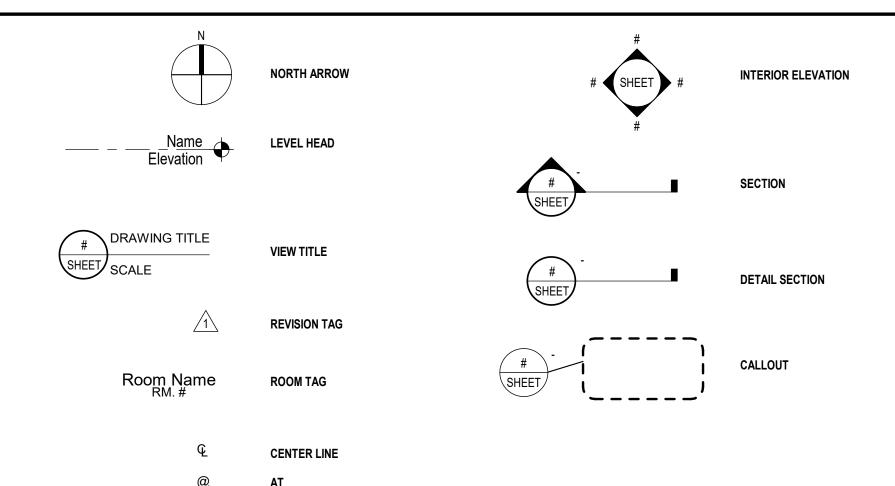

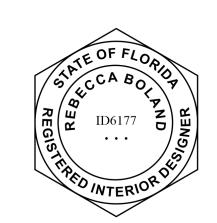

PROJECT NUMBER:	KR MECH
DATE ISSUED:	10/22/202
DRAWN BY:	B. BOLANI
PROJECT	PERMIT AND PRICING
STATUS:	PLANS

GENERAL NOTES, ABBREVIATIONS, SYMBOLS, AND DRAWING INDEX

ID0.1

VICINITY MAP PROJECT LOCATION 2672 PHYLLIS STREET JACKSONVILLE, FL 32226

PROJECT LOCATION **GENERAL NOTES**

Trinity Fitness - Riverside

"NOT AN EXIT" SIGNAGE ──

PASSAGE 101B

OPEN OFFICE

OFFICE

118 SF

OFFICE

118 SF

- FIRE EXTINGUISHERS (TYPE A HAZARD) SHALL BE 2A-10BC MULTI-PURPOSE DRY CHEMICAL EQUAL TO "COSMIC 5E" BY JL INDUSTRIES. EXTINGUISHERS SHALL BE
- 3,000 SF PER UNIT OF "A" IN LOW HAZARD OCCUPANCY SUCH AS OFFICES.
- PROVIDE TACTILE SIGNAGE AT EACH EXIT DOOR READING "EXIT" AND IN COMPLIANCE WITH NFPA 101 7.10.1.3
- ALL LIFE SAFETY COMPONENTS ARE SHOWN FOR DESIGN INTENT. REFER TO ENGINEER'S DRAWINGS.
- REFER TO ENGINEER'S DRAWINGS FOR LIFE SAFETY FIXTURES AND EQUIPMENT (AUDIO/VISUAL ALARMS, PULL DEVICES, SMOKE DETECTORS, HEAT DETECTORS,

PLAN LEGEND

EXISTING STRUCTURE AND PARTITIONS



FIRE EXTINGUISHER

FLAT, LEVEL SURFACE

COMPLIANT

HANDRAILS

PEDESTRIAN

STRUCTURAL

EXISTING

CONCRETE

RAMP

PROJECT FORUM

ELEC. PANEL

PASSAGE 102A 325 SF

224 SF

373 SF

TEAMING AREA

EXISTING ROLL-UP

DOOR TO REMAIN

EXISTING DOOR

- "NOT AN EXIT"

SIGNAGE

COOLER

TEAM BEVERAGE

STATION 102C

AND TAPS

TEAM GAMES (PINBALL,

DARTS, ETC.)

GALAGA,

TO REMAIN

RAMP WITH 1:12 SLOPE; SEE

OCCUPANCY USE DIAGRAM 100.1-EP 1/32" = 1'-0" STAIRS AND RAILING STAIRS AND RAILING FIFIFIE = '= **EXISTING** DOOR TO REMAIN - EXISTING ELEC. PANELS SIGNAGE

CONFERENCE

SAFETY GEAR

CLOSET 124

158 SF

SAFETY GEAR =

CLOTHES, HARD

HATS, GLASSES, &

TDE = 101'-6"

GLOVES

NEW ROLL-UP

EGRESS DOOR

1' - 0"___3' - 0"

EXISTING

CONCRETE

RAMP

PEDESTRIAN

SLOPE; SEE STRUCTURAL

COMPLIANT

HANDRAILS

ADA

RAMP WITH 1:12

DOOR WITH

PRINT 110A

PASSAGE 110B

330 SF

ALTERNATE

WORK ZONE

81 SF

OFFICE 117

OFFICE

118 SF

OFFICE

118 SF

FUTURE

OFFICE

118 SF

ALTERNATE **WORK ZONE**

ESTIMATING

OFFICE 108

254 SF

PASSAGE 110D

G

EXISTING -

FUTURE OPEN OFFICE 110

PASSAGE 110F

EXERCISE

FLAT, LEVEL

SURFACE

319 SF

EXISTING ROLL-UP

DOOR TO REMAIN

ELEC. PANELS

71,649 SF ASSEMBLY (1:15)

5,721 SF

8,141 GSF

BUSINESS (1:150)

(UNCONCENTRÁTED, TABLES AND CHAIRS)

CÓNCENTRATED BUSINESS (1:50)

(EXIT ACCESS SEPARATION)

PASSAGE 101G 180 SF

310 SF

ALTERNATE

WORK ZONE

OFFICE

OFFICE

118 SF

ALTERNATE

WORK ZONE 101D

170 SF

OFFICE 107

118 SF

OFFICE 106

118 SF

TEAMING AREA

190 SF

EXIT PLAN

BUILDING DOES NOT HAVE A SPRINKLER SYSTEM

MOUNTED ON SURFACE MOUNTED BRACKETS.

1,500 SF PER UNIT OF "A" FOR MODERATE HAZARD OCCUPANCIES SUCH AS KITCHENS AND DINING AREAS

_____ NEW PARTITIONS

EXIT AND EXIT WIDTH IN INCHES

TDE = TRAVEL DISTANCE TO EXIT CPT = COMMON PATH OF TRAVEL

FIRE ALARM, VISUAL & AUDIO/VISUAL

PROJECT INFORMATION

PROJECT DESCRIPTION:
THE PROJECT SCOPE IS WITHIN AN EXISTING STAND-ALONE ABOVE GRADE BRICK BUILDING. THE BUILDING WAS PREVIOUSLY AN ART GALLERY AND STUDIO, THE NEW OWNER IS CONVERTING THE BUILDING INTO THEIR NEW BUSINESS OFFICE. THE OWNER WILL BE THE SOLE OCCUPANT IN THIS

BUILDING OWNER: KR MECHANICAL INTERIOR DESIGN. STUDIO1019, LLC

MECHANICAL, ELECTRICAL, PLUMBING, FIRE PROTECTION, STRUCTURAL KR MECHANICAL

AUTHORITY HAVING JURISDICTION: CITY OF JACKSONVILLE

> PLANNING AND DEVELOPMENT DEPARTMENT **CURRENT PLANNING DIVISION** 214 NORTH HOGAN STREET, SUITE 300 JACKSONVILLE, FL 32202

EXISTING BUILDING DOES NOT HAVE A SPRINKLER SYSTEM

CODE ANALYSIS

FLORIDA BUILDING CODE ANALYSIS

APPLICABLE CODES: FLORIDA BUILDING CODE, SEVENTH EDITION (2020) - BUILDING FLORIDA BUILDING CODE, SEVENTH EDITION (2020) - ACCESSIBILITY FLORIDA BUILDING CODE, SEVENTH EDITION (2020) - EXISTING BUILDING FLORIDA BUILDING CODE, SEVENTH EDITION (2020) - PLUMBING

FLORIDA BUILDING CODE, SEVENTH EDITION (2020) - MECHANICAL FLORIDA FIRE PREVENTION CODE, SEVENTH EDITION (2020) NFPA 101, 2018, 14TH EDITION NFPA 10, 2018, 14TH EDITION

NFPA 70 NATIONAL ELECTRIC CODE, 2017 EDITION BUSINESS GROUP B, SINGLE OCCUPANT BUILDING

OCCUPANCY TYPE: **EXISTING BUILDING** CLASSIFICATION OF WORK: ALTERATION LEVEL 3 **BUILDING AREA:** 15,511 GSF

NUMBER OF STORIES:

TYPE III B CONSTRUCTION TYPE: 2 EXITS MINIMUM, **3 PROVIDED** NUMBER OF EXITS:

EXIT SEPARATION: 97'-2" PROVIDED AT SHORTEST SEPARATION

OVERALL DIAGONAL DIMENSION OF EXISTING BUILDING = 193'-4"

EXIT SEPARATION CALCULATION: 193'-4" / 2 = 96'-8" MINIMUM

FIRE RESISTANCE RATING (TYPE III B, UNSPRINKLERED) REQUIREMENTS FOR BUILDING ELEMENTS: PRIMARY STRUCTURAL FRAME: 0

BEARING WALLS - EXTERIOR: 2 HOURS BEARING WALLS - INTERIOR: 0 NON BEARING WALLS - EXTERIOR: 1 HOUR NON BEARING WALLS - INTERIOR: 0 FLOOR CONSTRUCTION: 0

INTERIOR EXIT STAIRWAYS, RAMPS, & PASSAGEWAYS = CLASS B INTERIOR FINISHES: ROOMS AND ENCLOSED SPACES = CLASS C

OCCUPANT CALCULATION: BUILDING AREA = 15,511 SF, BUSINESS OCCUPANCY

ROOF CONSTRUCTION: 0

OCCUPANTS OCC. TYPE SF/OCC SF OFFICES/CIRCULATION CONCENTRATED BUSINESS B 5,721 110

ASSEMBLY 1.649 TOTAL OCCUPANTS: 280 0.2" PER OCC EXIT CAPACITY, DOORS: 0.2" x 280 = 56" REQUIRED, **139" PROVIDED**

TRAVEL DISTANCE TO EXITS: 200 FEET MAXIMUM (UNSPRINKLERED) COMMON PATH OF TRAVEL: 30 FEET MAXIMUM (UNSPRINKLERED) DEAD END CORRIDOR: 20 FEET (UNSPRINKLERED)

WATER CLOSETS = 7 MINIMUM, 5 PROVIDED (SEE URINALS) PLUMBING FIXTURES: 1:25 FIRST 50 OCCUPANTS 1:50 FOR REMAINDER EXCEEDING 50

> URINALS = NOT REQUIRED, 2 PROVIDED (REPLACING LESS THAN 50% OF REQUIRED WATER CLOSETS) LAVATORIES = 5 MINIMUM, **5 PROVIDED**

1:40 FIRST 80 OCCUPANTS 1:80 FOR REMAINDER EXCEEDING 80 DRINKING FOUNTAIN = 3 MINIMUM, 3 PROVIDED 1:100 OCCUPANTS

SERVICE SINK = 1 MINIMUM, 1 PROVIDED

INTERIOR DESIGNERS STATEMENT: THIS DESIGN TO THE BEST OF THE INTERIOR DESIGNER'S KNOWLEDGE COMPLIES WITH THE 7TH EDITION 2020 FLORIDA BUILDING CODE(S)

FIRE CODE ANALYSIS

APPLICABLE CODES: FLORIDA FIRE PREVENTION CODE, SEVENTH EDITION (2020)

NFPA 101, 2018, 14TH EDITION NFPA 10, 2018, 14TH EDITION OCCUPANCY TYPE: **BUSINESS OCCUPANCY** BUILDING AREA: 15,511 GSF

NUMBER OF STORIES: OCCUPANT CALCULATION: BUILDING AREA = 15,511 SF, BUSINESS OCCUPANCY

> OCCUPANTS **BUSINESS & CIRCULATION CONCENTRATED BUSINESS** 4,500 COLLABERATION (>450sf): PROJECT FORUM (102) **TEAMING AREA (102B)** 373 TEAM BEV. STN. (102C) 422 TEAMING AREA (102E) 657 CONFERENCE (111) 645 COLLABERATION (<450sf): **BREAK AREA (101J)**

> > 190

TOTAL OCCUPANTS: 333

383

MINIMUM NUMBER OF EXITS OR ACCESS TO EXITS:

COMMON PATH OF TRAVEL: 75 FEET MAX. (UNSPRINKLERED) TRAVEL DISTANCE TO EXITS: 200 FEET MAX. (UNSPRINKLERED) FIRE RESISTANCE RATINGS

TEAMING AREA (105)

EXERCISE (109) with equipment

FOR BUILDING ELEMENTS: BEARING WALLS - EXTERIOR: 2 HOURS BEARING WALLS - INTEIROR: 0 COLUMNS - SUPPORTING ROOF: 0 FLOOR CONSTRUCTION: 0 ROOF CONSTRUCTION: 0 NON BEARING WALLS - EXTERIOR: 0

NON BEARING WALLS - INTERIOR: 0 OCCUPANCY HAZARD: ORDINARY FIRE EXTINGUISHERS: MINIMUM RATED SINGLE EXTINGUISHER: 2-A MAXIMUM FLOOR AREA PER EXTINGUISHER: 3,000 SF

MAXIMUM TRAVEL DISTANCE TO EXTINGUISHER: 75 FEET MIN. # REQ. # PROVIDED LEVEL 1 3,000 INTERIOR FINISHES: EXITS: CLASS A OR B ROOMS AND ENCLOSED SPACES: CLASS A, B, OR C

INTERIOR DESIGNERS THIS DESIGN TO THE BEST OF THE INTERIOR DESIGNER'S STATEMENT: KNOWLEDGE COMPLIES WITH THE 6TH EDITION OF THE FLORIDA FIRE PREVENTION CODE.

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becca@studio1019.com

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KR MECHANICAL **NEW OFFICE**

2672 PHYLLIS STREET JACKSONVILLE, FL 32206

CONTACT

RAYMOND CHIN & KERRY MOWLAM

REVISIONS

KR MECH 1 PROJECT NUMBER: DATE ISSUED: 10/22/2021

PLANS

DRAWN BY: B. BOLAND PERMIT AND PRICING **PROJECT** STATUS:

EXIT PLAN AND PROJECT **INFORMATION**



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KR MECHANICAL NEW OFFICE

2672 PHYLLIS STREET JACKSONVILLE, FL 32206

CONTACT
RAYMOND CHIN & KERRY MOWLAM

REVISIONS

o Description

ntion Dat


DEMOLITION PLAN NOTES


- 1. EXISTING DOORS AND WINDOWS TO REMAIN, UNLESS OTHERWISE NOTED.
- 2. PROTECT ALL EXISTING TO REMAIN BUILDING ELEMENTS, COMPONENTS, AND FIXTURES DURING ALL PHASES OF CONSTRUCTION.
- 3. PLUMBING, MECHANICAL, AND ELECTRICAL FIXTURES SHOWN FOR REFERENCE ONLY. REFER TO ENGINEER'S DRAWINGS PROVIDED BY OWNER.
- 4. ALL DEMOLISHED ITEMS SHALL BE REMOVED FROM THE PREMISES EXCEPT ITEMS NOTED TO BE SALVAGED FOR
- 5. THE CONTRACTOR SHALL FURNISH A SYSTEM OF TEMPORARY LIGHTS THROUGHOUT THE SPACE UNDER CONSTRUCTION AS
- 6. THE CONTRACTOR SHALL CAP AND FLUSH OFF BEHIND FINISH SURFACES ALL PROJECTING PLUMBING, FLOOR ELECTRICAL/TELEPHONE OUTLETS, AND ALL OTHER PROJECTING ITEMS WHICH ARE BEING ABANDONED. REFER TO ENGINEER'S DRAWINGS PROVIDED BY OWNER.
- 7. DEMOLITION NOT DESCRIBED HERE BUT NECESSARY FOR THE COMPLETION OF THE WORK SHALL BE THE RESPONSIBILITY OF THE CONTRACTOR. THE DEMOLITION DRAWINGS ARE ISSUED FOR INFORMATION ONLY AND SHOW THE GENERAL EXTENT OF THE DEMOLITION REQUIRED. THESE DRAWINGS DO NOT NECESSARILY SHOW EVERYTHING TO BE REMOVED IN ORDER TO PREPARE THE EXISTING BUILDING ELEMENTS FOR REMODELING OR NEW CONSTRUCTION. THE INTERIOR DESIGN DRAWINGS SHOW THE EXISTING PARTITIONS WITH DOORS AND OTHER ITEMS TO REMAIN.
- 8. MAINTAIN FULLY CHARGED FIRE EXTINGUISHER READILY AVAILABLE DURING ALL DEMOLITION OPERATIONS.
- THE DEMOLITION DRAWINGS HAVE BEEN DEVELOPED FROM EXISTING DRAWINGS PROVIDED TO THE INTERIOR DESIGNER BY THE OWNER, AND MAY NOT REFLECT ACTUAL FIELD CONDITIONS. PRIOR TO PROCEEDING WITH ANY WORK, IT IS THE RESPONSIBILITY OF THE CONTRACTOR TO VERIFY THE ACCURACY OF THESE DRAWINGS IN COMPARISON TO EXISTING FIELD CONDITIONS AND THEN IMMEDIATELY NOTIFY THE INTERIOR DESIGNER AND OWNER OF ANY INCONSISTENCIES BETWEEN THESE DRAWINGS AND ACTUAL CONDITIONS.

DEMOLITION PLAN LEGEND

EXISTING STRUCTURE AND PARTITIONS TO REMAIN

PARTITIONS AND DOORS TO BE DEMOLISHED

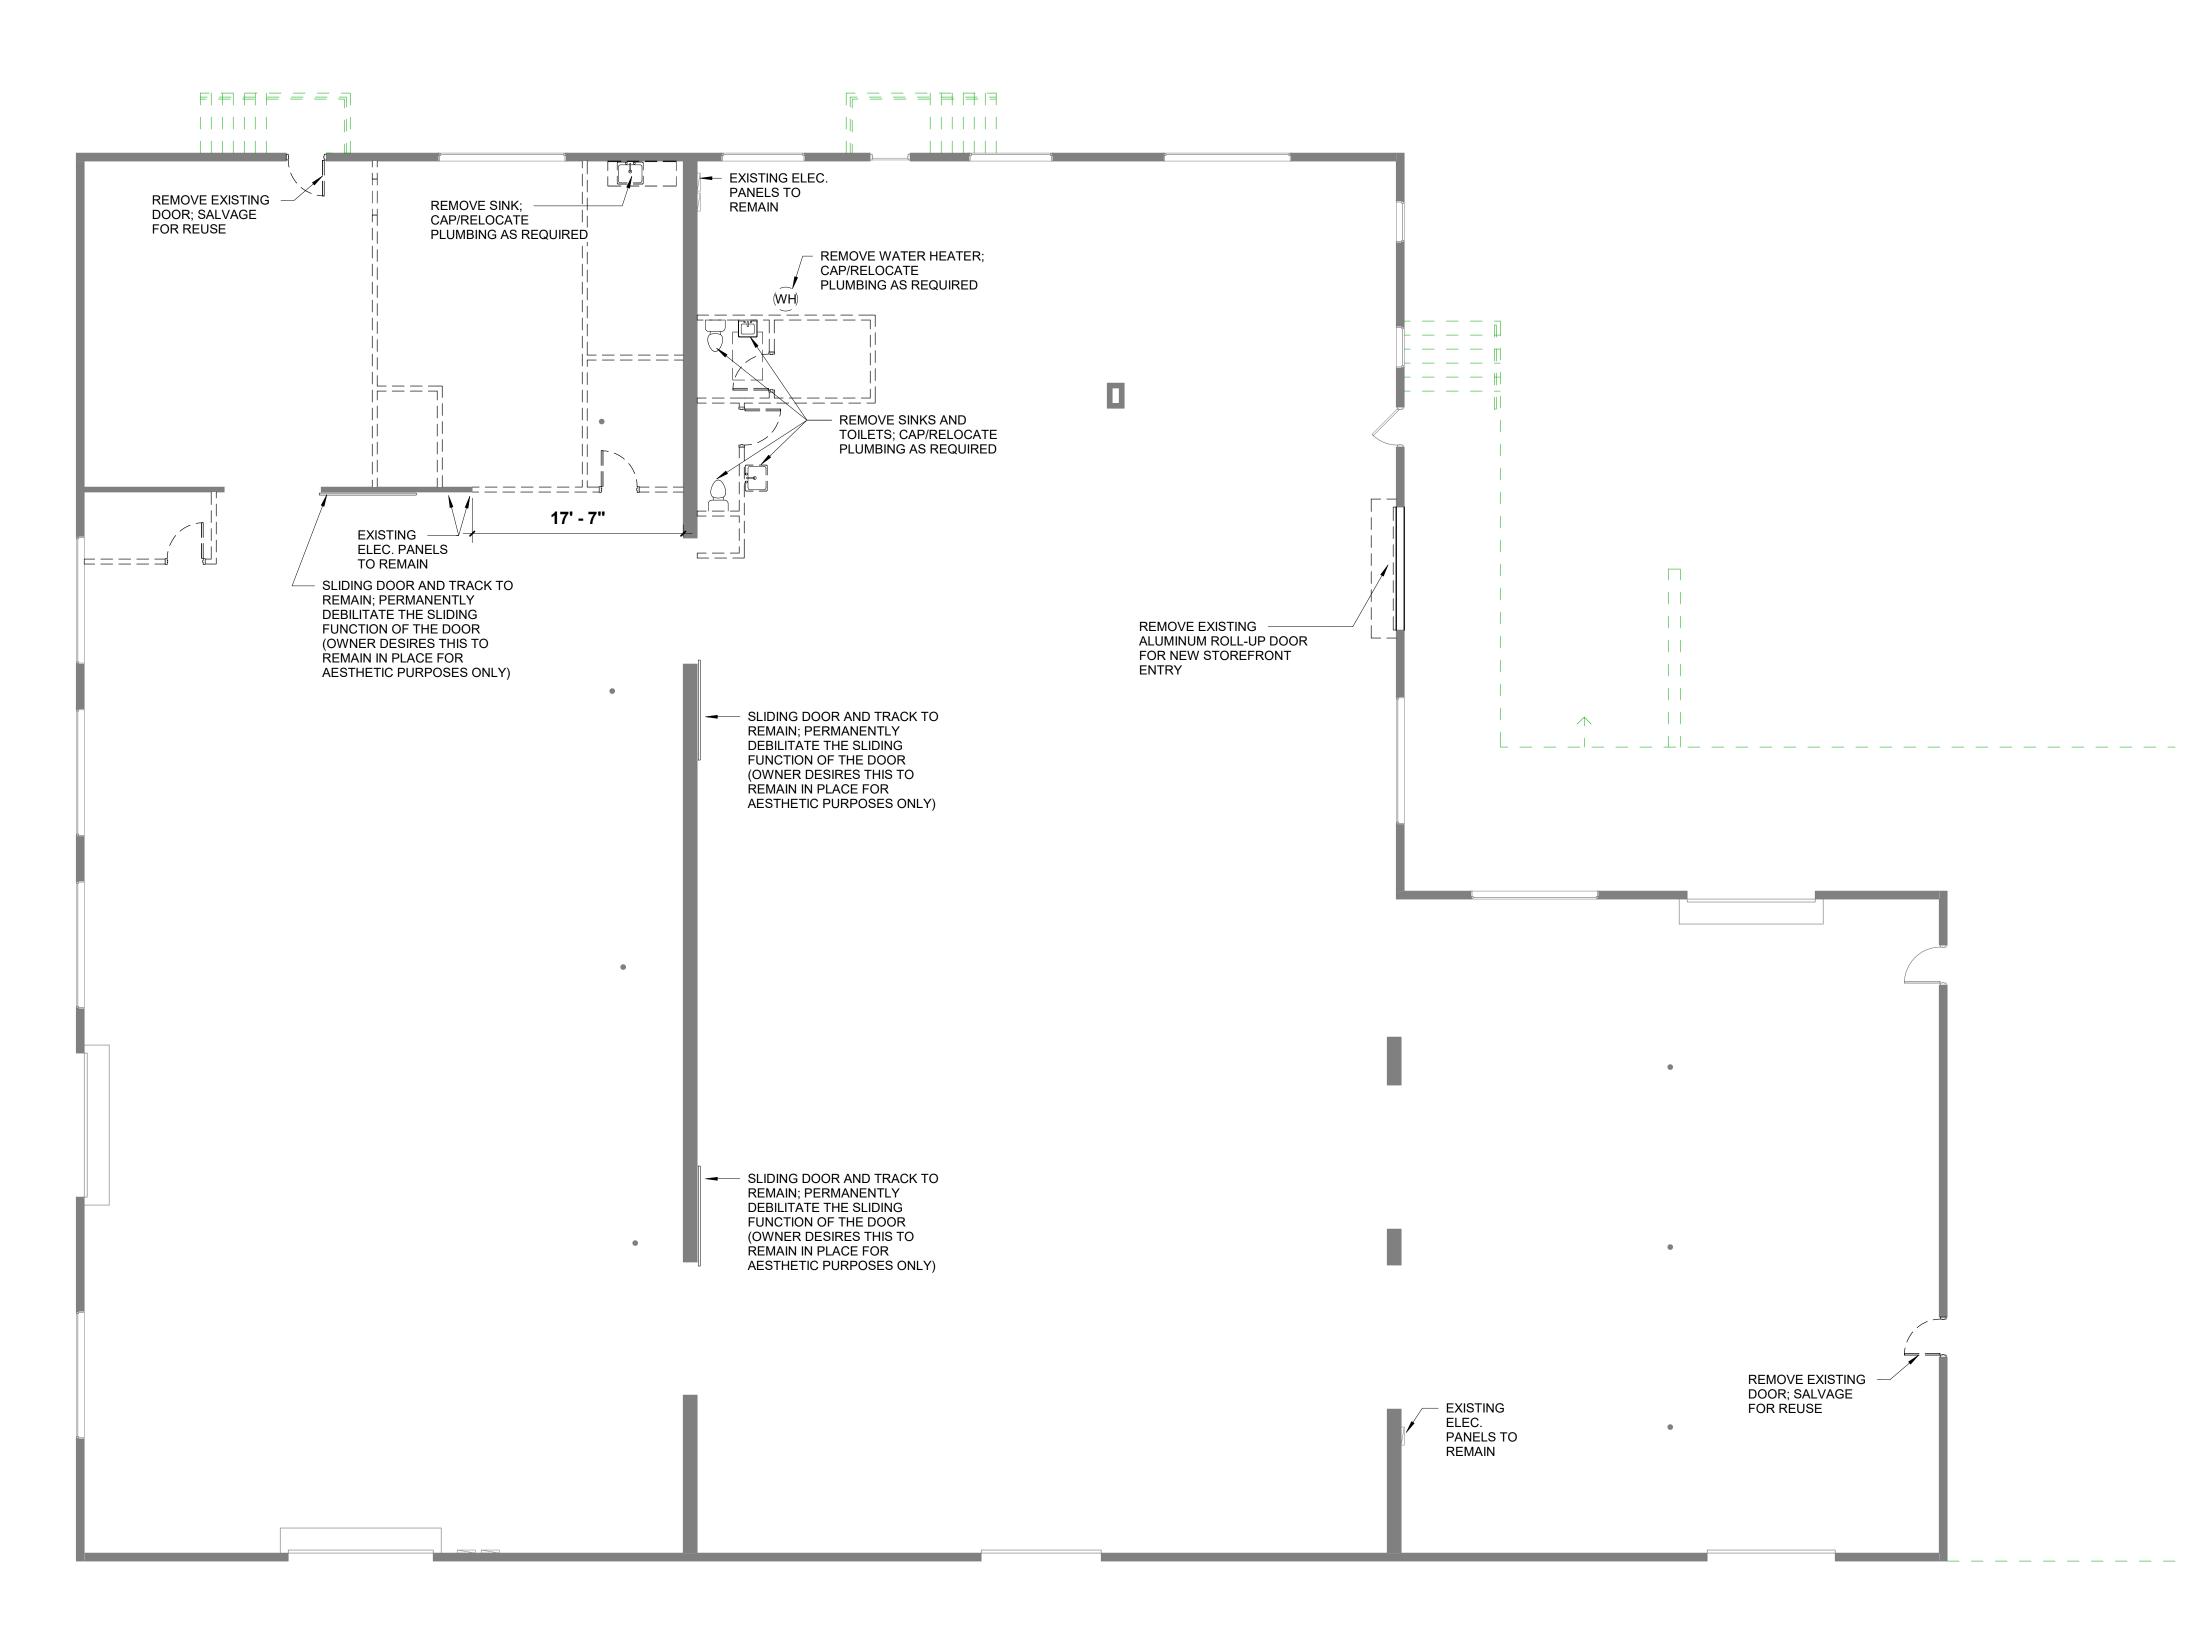

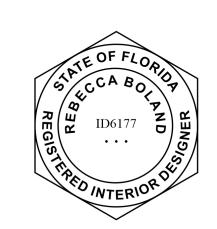

PROJECT NUMBER:

DATE ISSUED: DRAWN BY:


DRAWN BY: B. BOLAND
PROJECT PERMIT AND PRICING
STATUS: PLANS

DEMOLITION PLAN

ID1.

KR MECH 1

10/22/2021

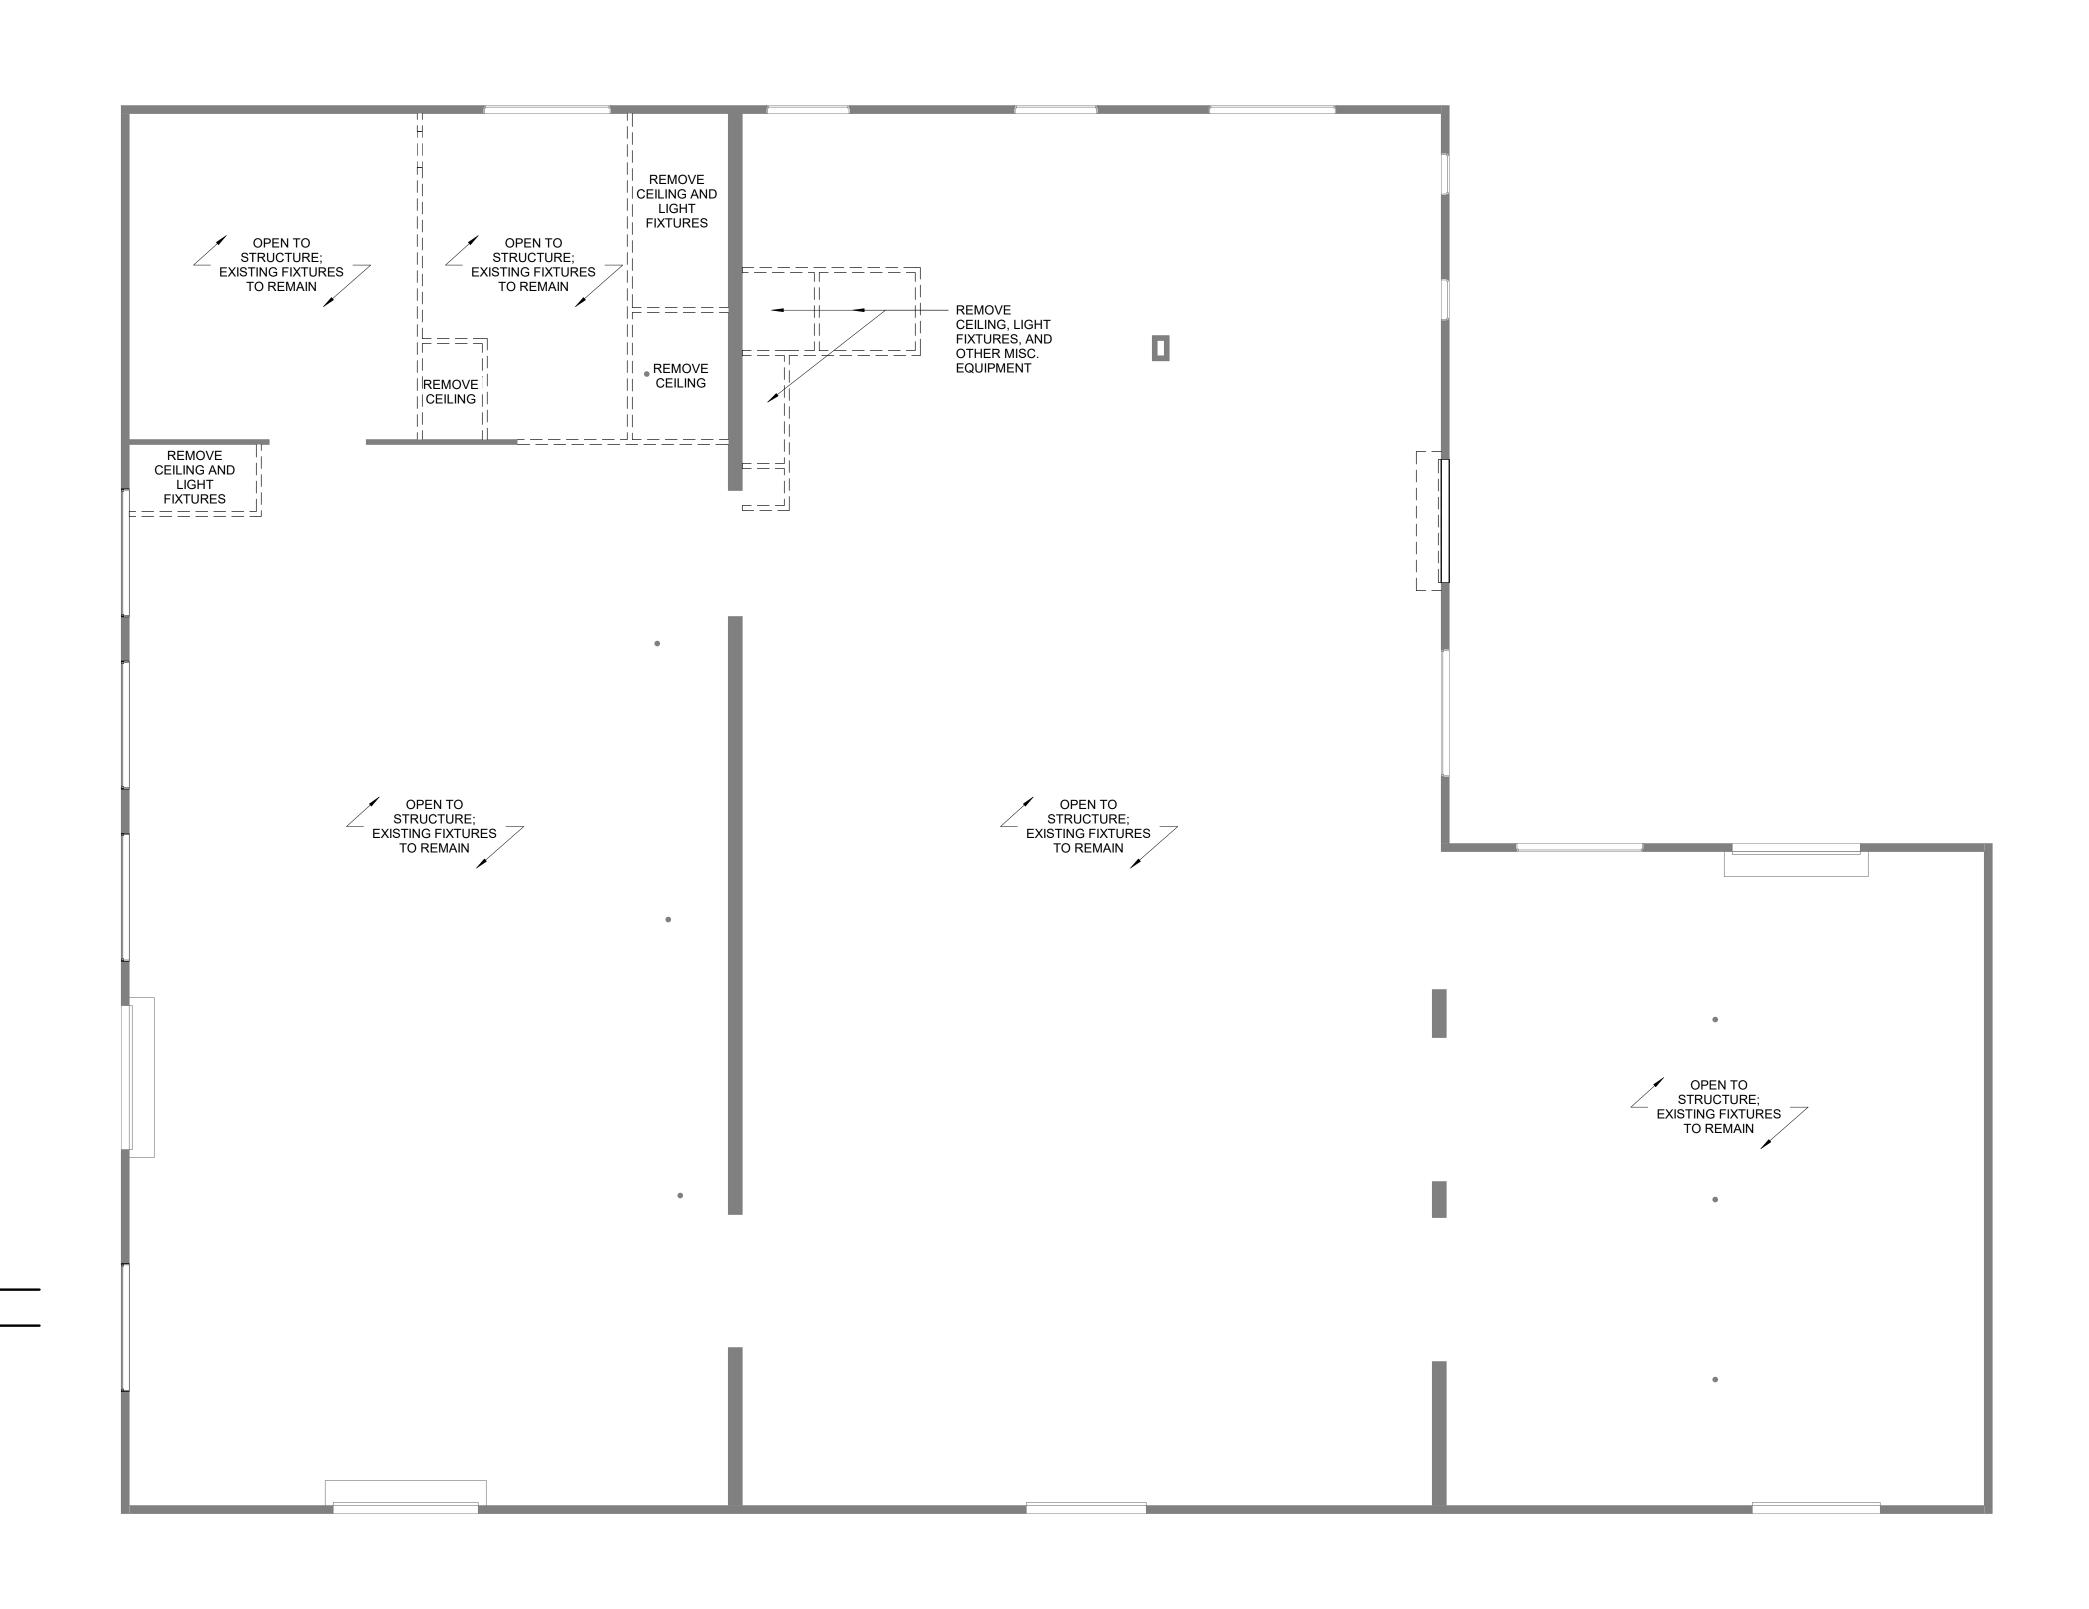

DEMOLITION RCP NOTES

- ALL EXISTING LIGHT FIXTURES ARE TO REMAIN, UNLESS
 OTHERWISE NOTED. PROTECT DURING ALL PHASES OF CONSTRUCTION.
- ANY PLUMBING, MECHANICAL, OR ELECTRICAL FIXTURES SHOWN FOR REFERENCE ONLY. REFER TO ENGINEER'S DRAWINGS.





STUDIO1019, LLC | IB26001903 (407)-864-1885 becca@studio1019.com

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KR MECHANICAL NEW OFFICE

2672 PHYLLIS STREET JACKSONVILLE, FL 32206

CONTACT RAYMOND CHIN & KERRY MOWLAM

REVISIONS




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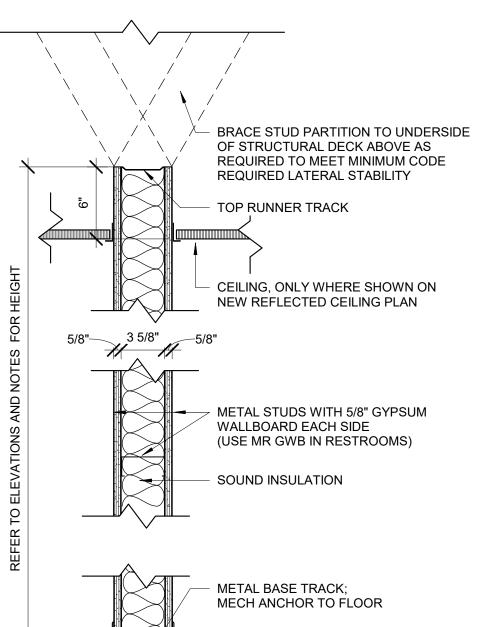
DATE ISSUED: DRAWN BY:

10/22/2021 B. BOLAND PERMIT AND PRICING PLANS PROJECT STATUS:

DEMOLITION REFLECTED CEILING PLAN

KR MECH 1



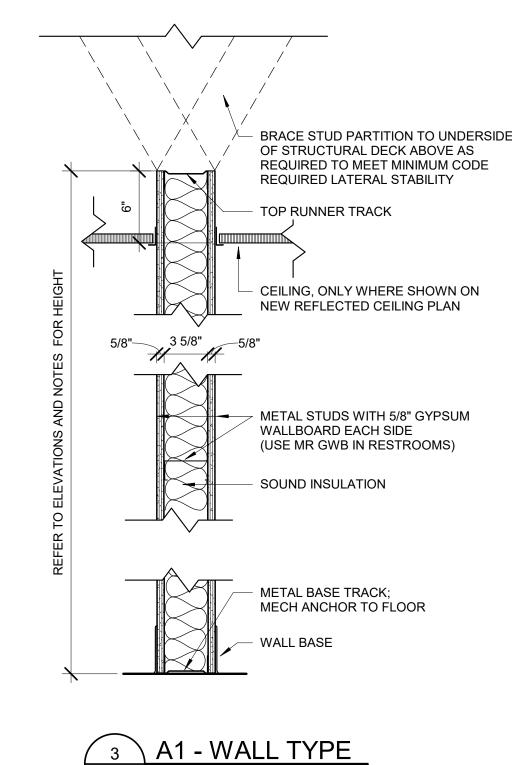



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KR MECHANICAL **NEW OFFICE**

2672 PHYLLIS STREET JACKSONVILLE, FL 32206

CONTACT RAYMOND CHIN & KERRY MOWLAM

REVISIONS



- EXISTING CONCRETE SLAB TO REMAIN. PATCH AND REPAIR AS REQUIRED TO INFILL HOLES, GAPS, AND OTHER MISCELLANEOUS IMPERFECTIONS TO PROVIDE A SMOOTH AND
- GENERIC ALUMINUM STOREFRONT SYSTEM DETAILED FOR PRICING PURPOSES AND DESIGN INTENT. CONTRACTOR SHALL COORDINATE FINAL STOREFRONT SYSTEM WITH OWNER AND INSTALL IT PER MANUFACTURER'S RECOMMENDATIONS.
- PLUMBING, MECHANICAL, AND ELECTRICAL FIXTURES SHOWN FOR REFERENCE ONLY. REFER TO ENGINEER'S DRAWINGS.
- CONTRACTOR TO COORDINATE SELECTION OF PLUMBING FIXTURES AND ACCESSORIES WITH OWNER. SELECTIONS SHALL COMPLY WITH ALL APPLICABLE CODES.


LEVEL SURFACE.

- REFER TO ELECTRICAL ENGINEER'S DRAWINGS FOR ALL ELECTRICAL OUTLET, DATA, AND SWITCH LOCATIONS.
- TOILET ACCESSORY SPECIFICATIONS PROVIDED FOR PRICING PURPOSES. CONTRACTOR TO COORDINATE EQUAL ALTERNATE OPTIONS WITH OWNER IF REQUESTED BY OWNER.
- SHOWERS ARE NOT REQUIRED BY CODE, BUT ARE PROVIDED AT THE REQUEST OF THE OWNER AS AN EMPLOYEE AMENITY. THESE SHOWERS ARE NOT INTENDED FOR PUBLIC USE.
- TOILET PARTITIONS SHOWN FOR DESIGN INTENT ONLY; CONTRACTOR TO COORDINATE PRODUCT SELECTION DIRECTLY WITH OWNER: INSTALL PARTITIONS PER MANUFACTURE'S RECOMMENDATIONS AND IN COMPLIANCE WITH APPLICABLE CODES.

NEW PLAN LEGEND

POWER POLE

EXISTING STRUCTURE AND PARTITIONS TO REMAIN NEW PARTITIONS AND PARTITION TAG NEW DOOR AND TAG

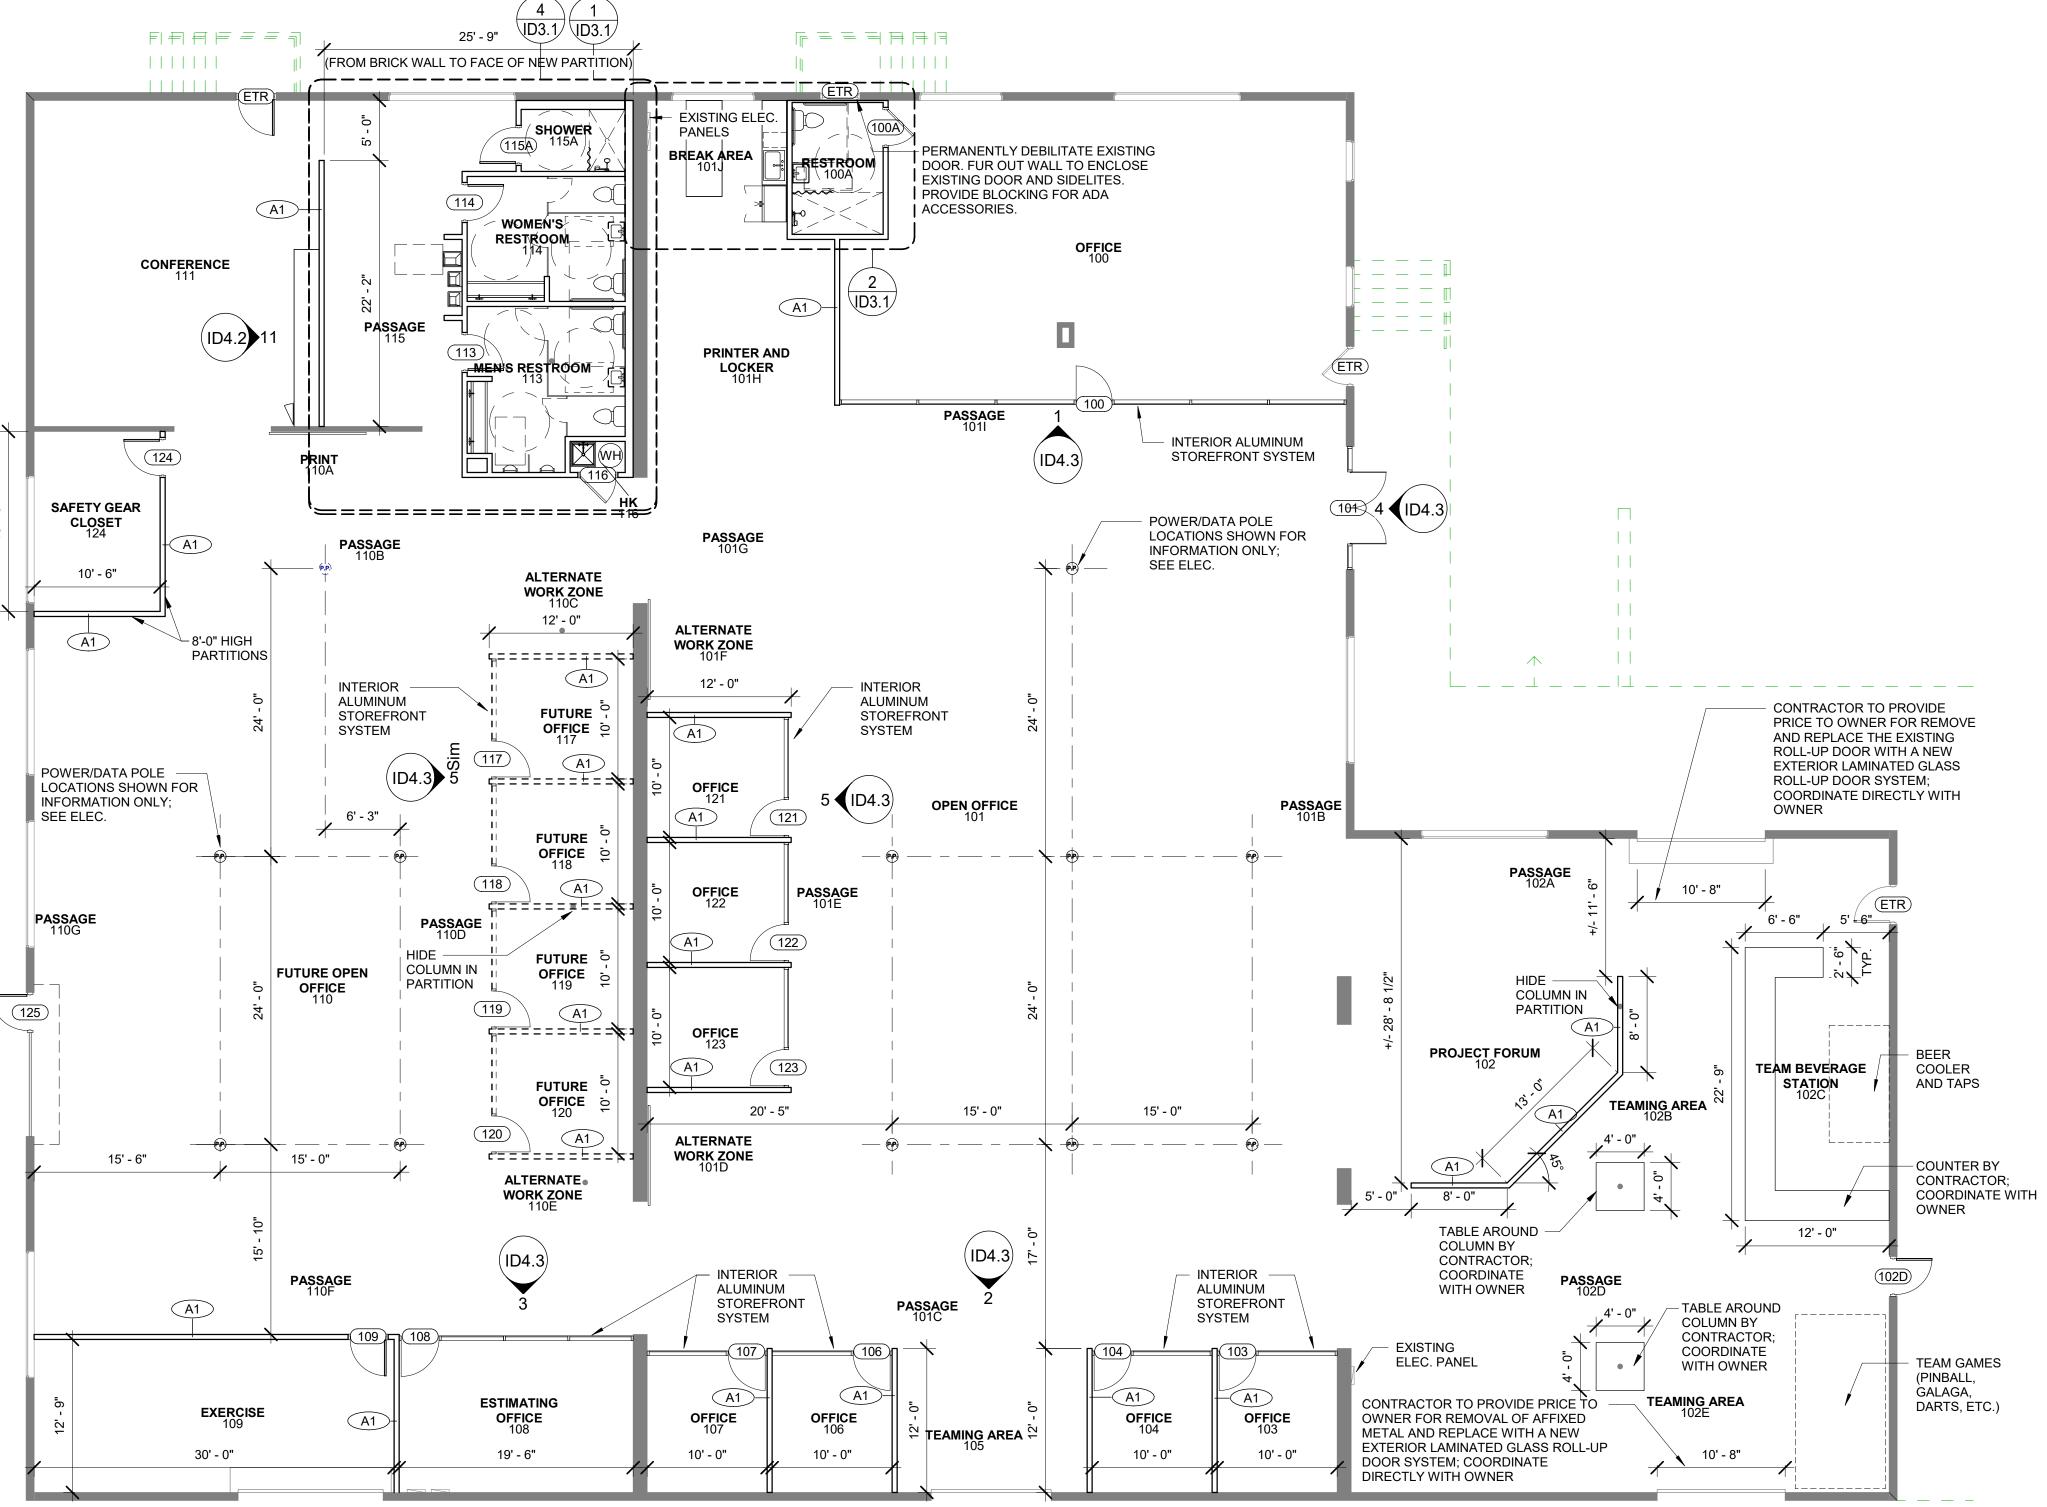

PROJECT NUMBER:

DATE ISSUED: DRAWN BY: PERMIT AND PRICING PLANS PROJECT STATUS:

NEW PLAN

1 NEW PLAN 1/8" = 1'-0"

KR MECH 1

10/22/2021

STUDIO 10-13
INTERIOR DESIGN
STUDIO1019, LLC | IB26001903

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KR MECHANICAL NEW OFFICE


2672 PHYLLIS STREET JACKSONVILLE, FL 32206

CONTACT
RAYMOND CHIN & KERRY MOWLAM

REVISIONS


No. Description

escription Date

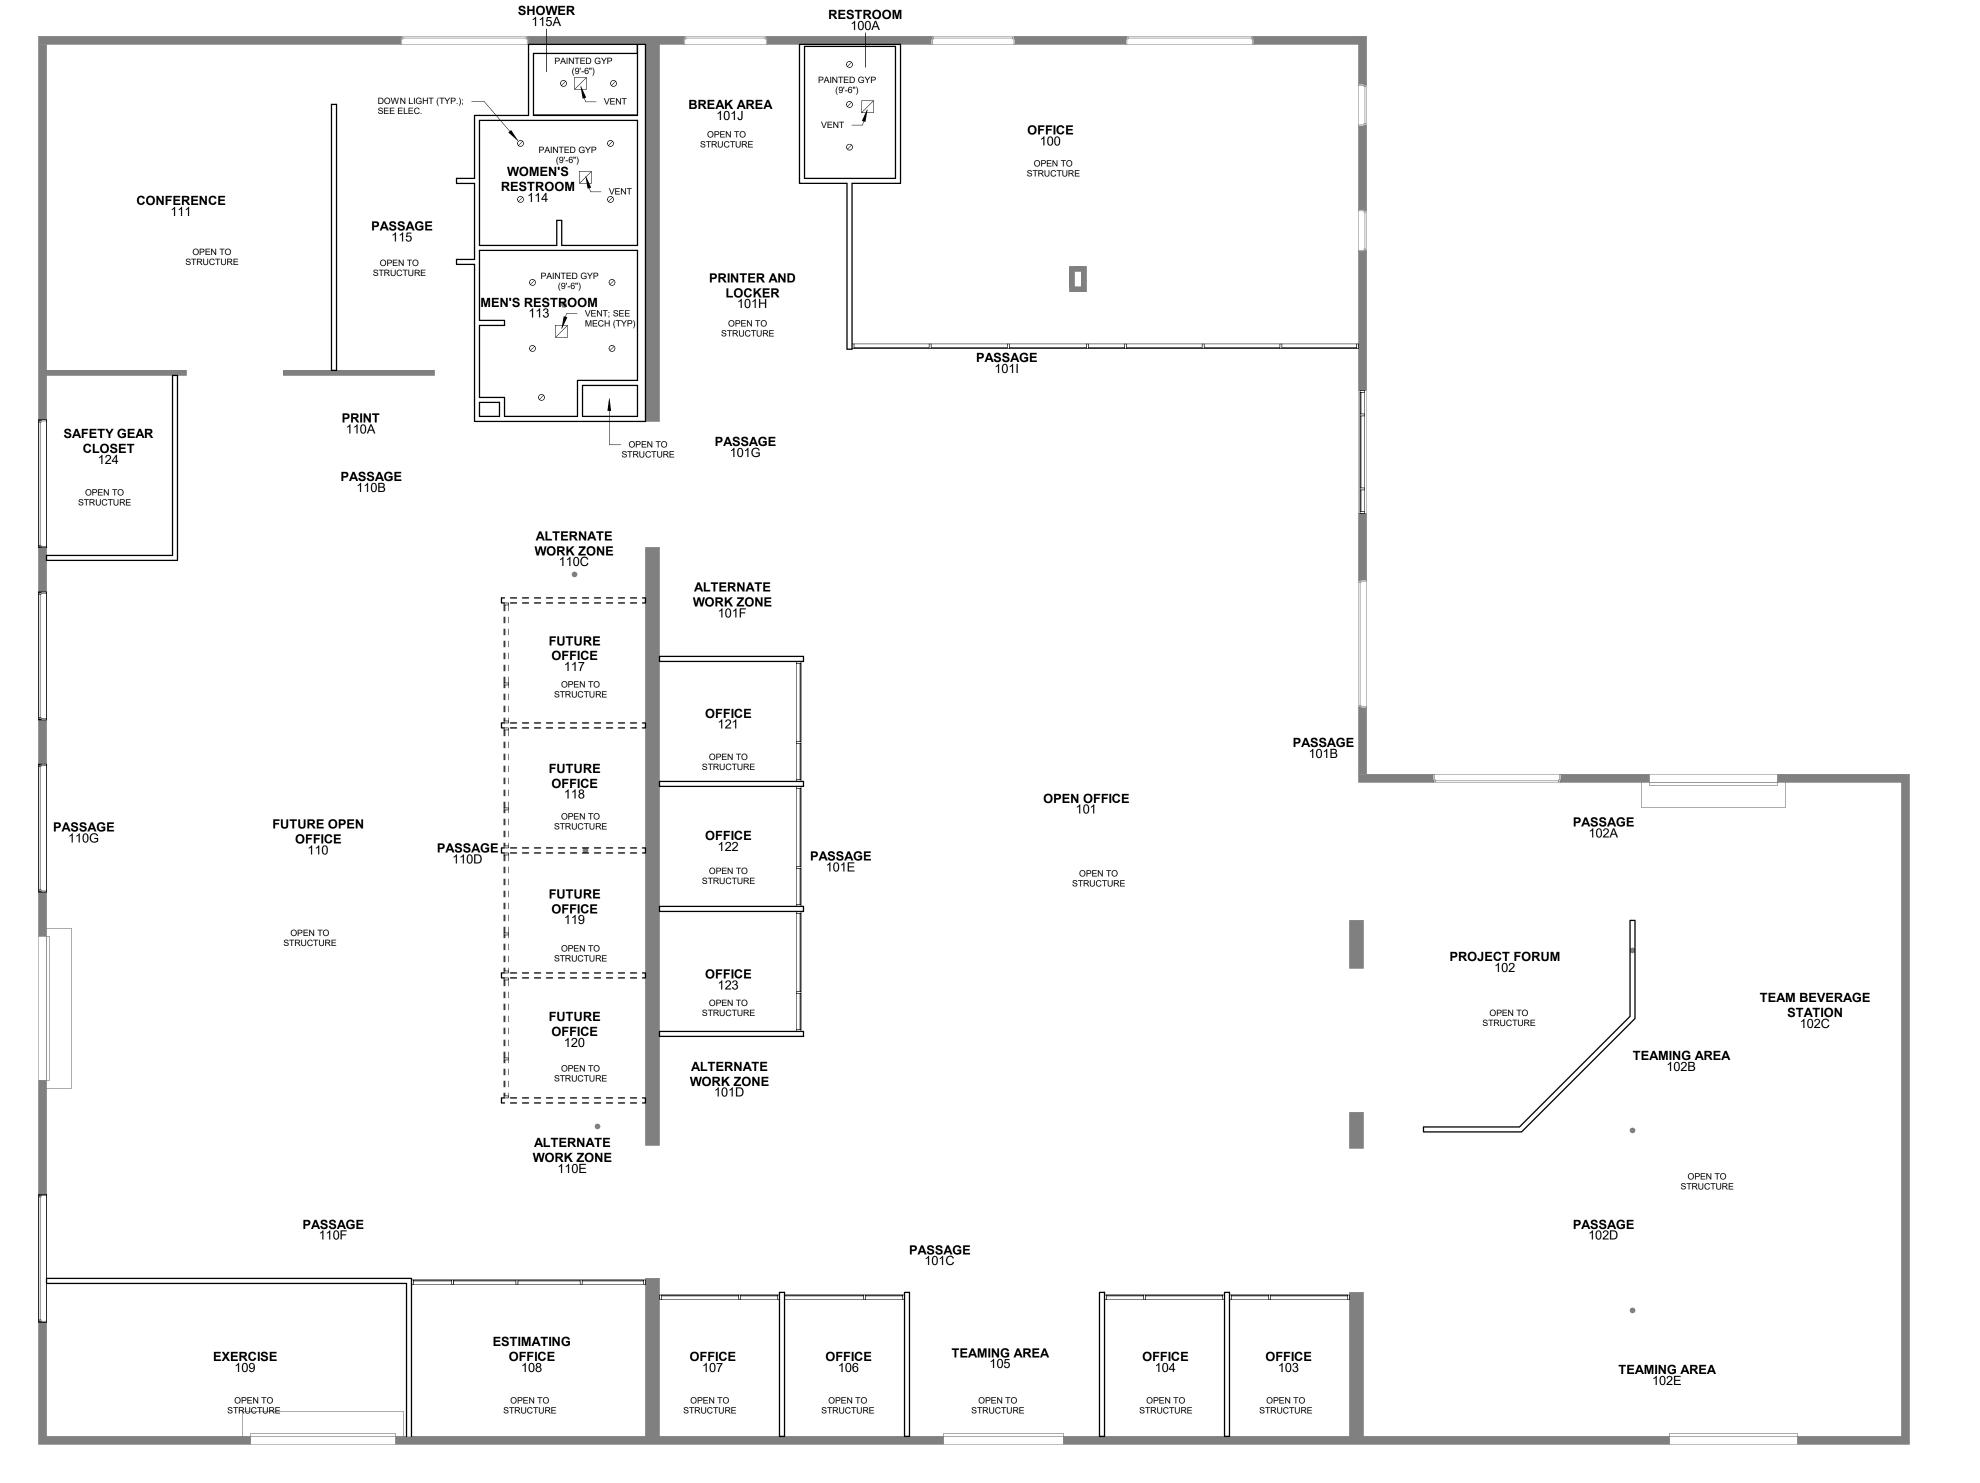

NEW RCP NOTES

ANY PLUMBING, MECHANICAL, ELECTRICAL, OR FIRE PROTECTION FIXTURES SHOWN FOR REFERENCE ONLY. REFER TO ENGINEER'S DRAWINGS.

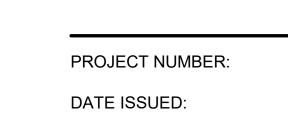


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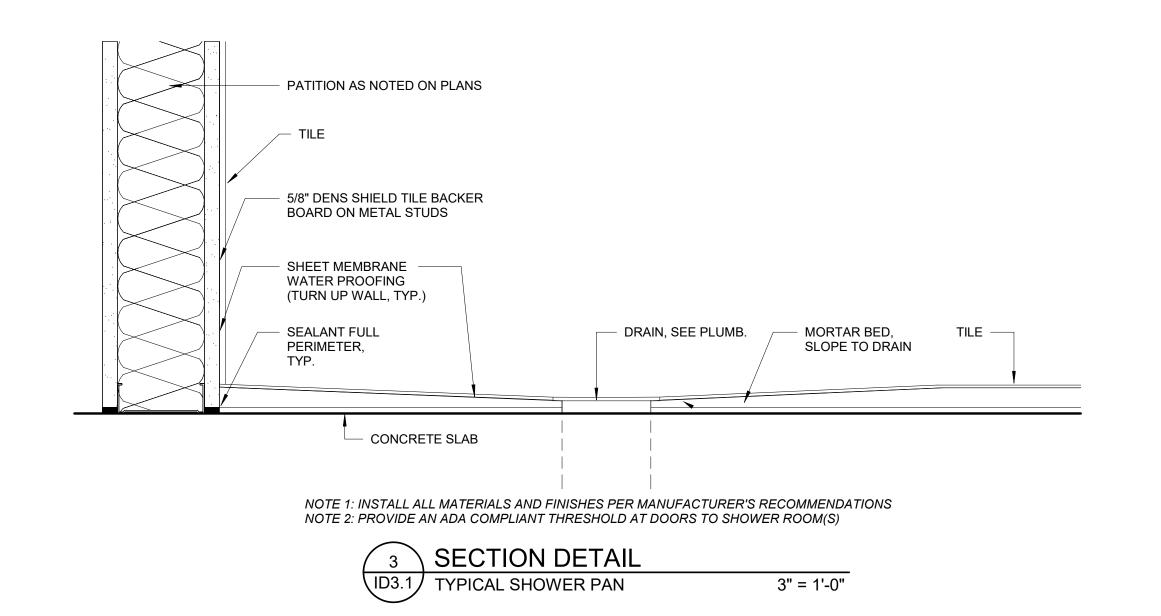
NEW REFLECTED CEILING PLAN


KR MECH 1

PERMIT AND PRICING PLANS

10/22/2021



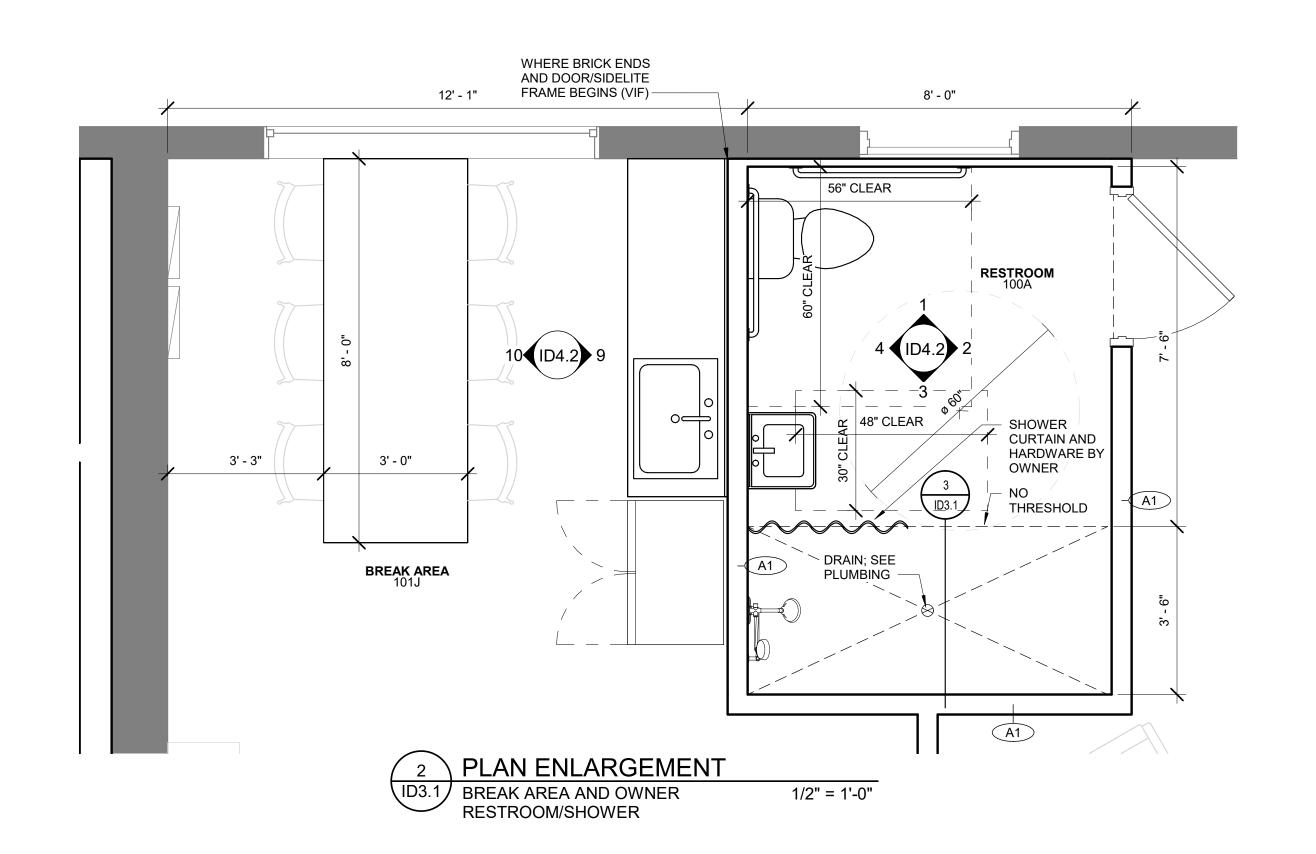

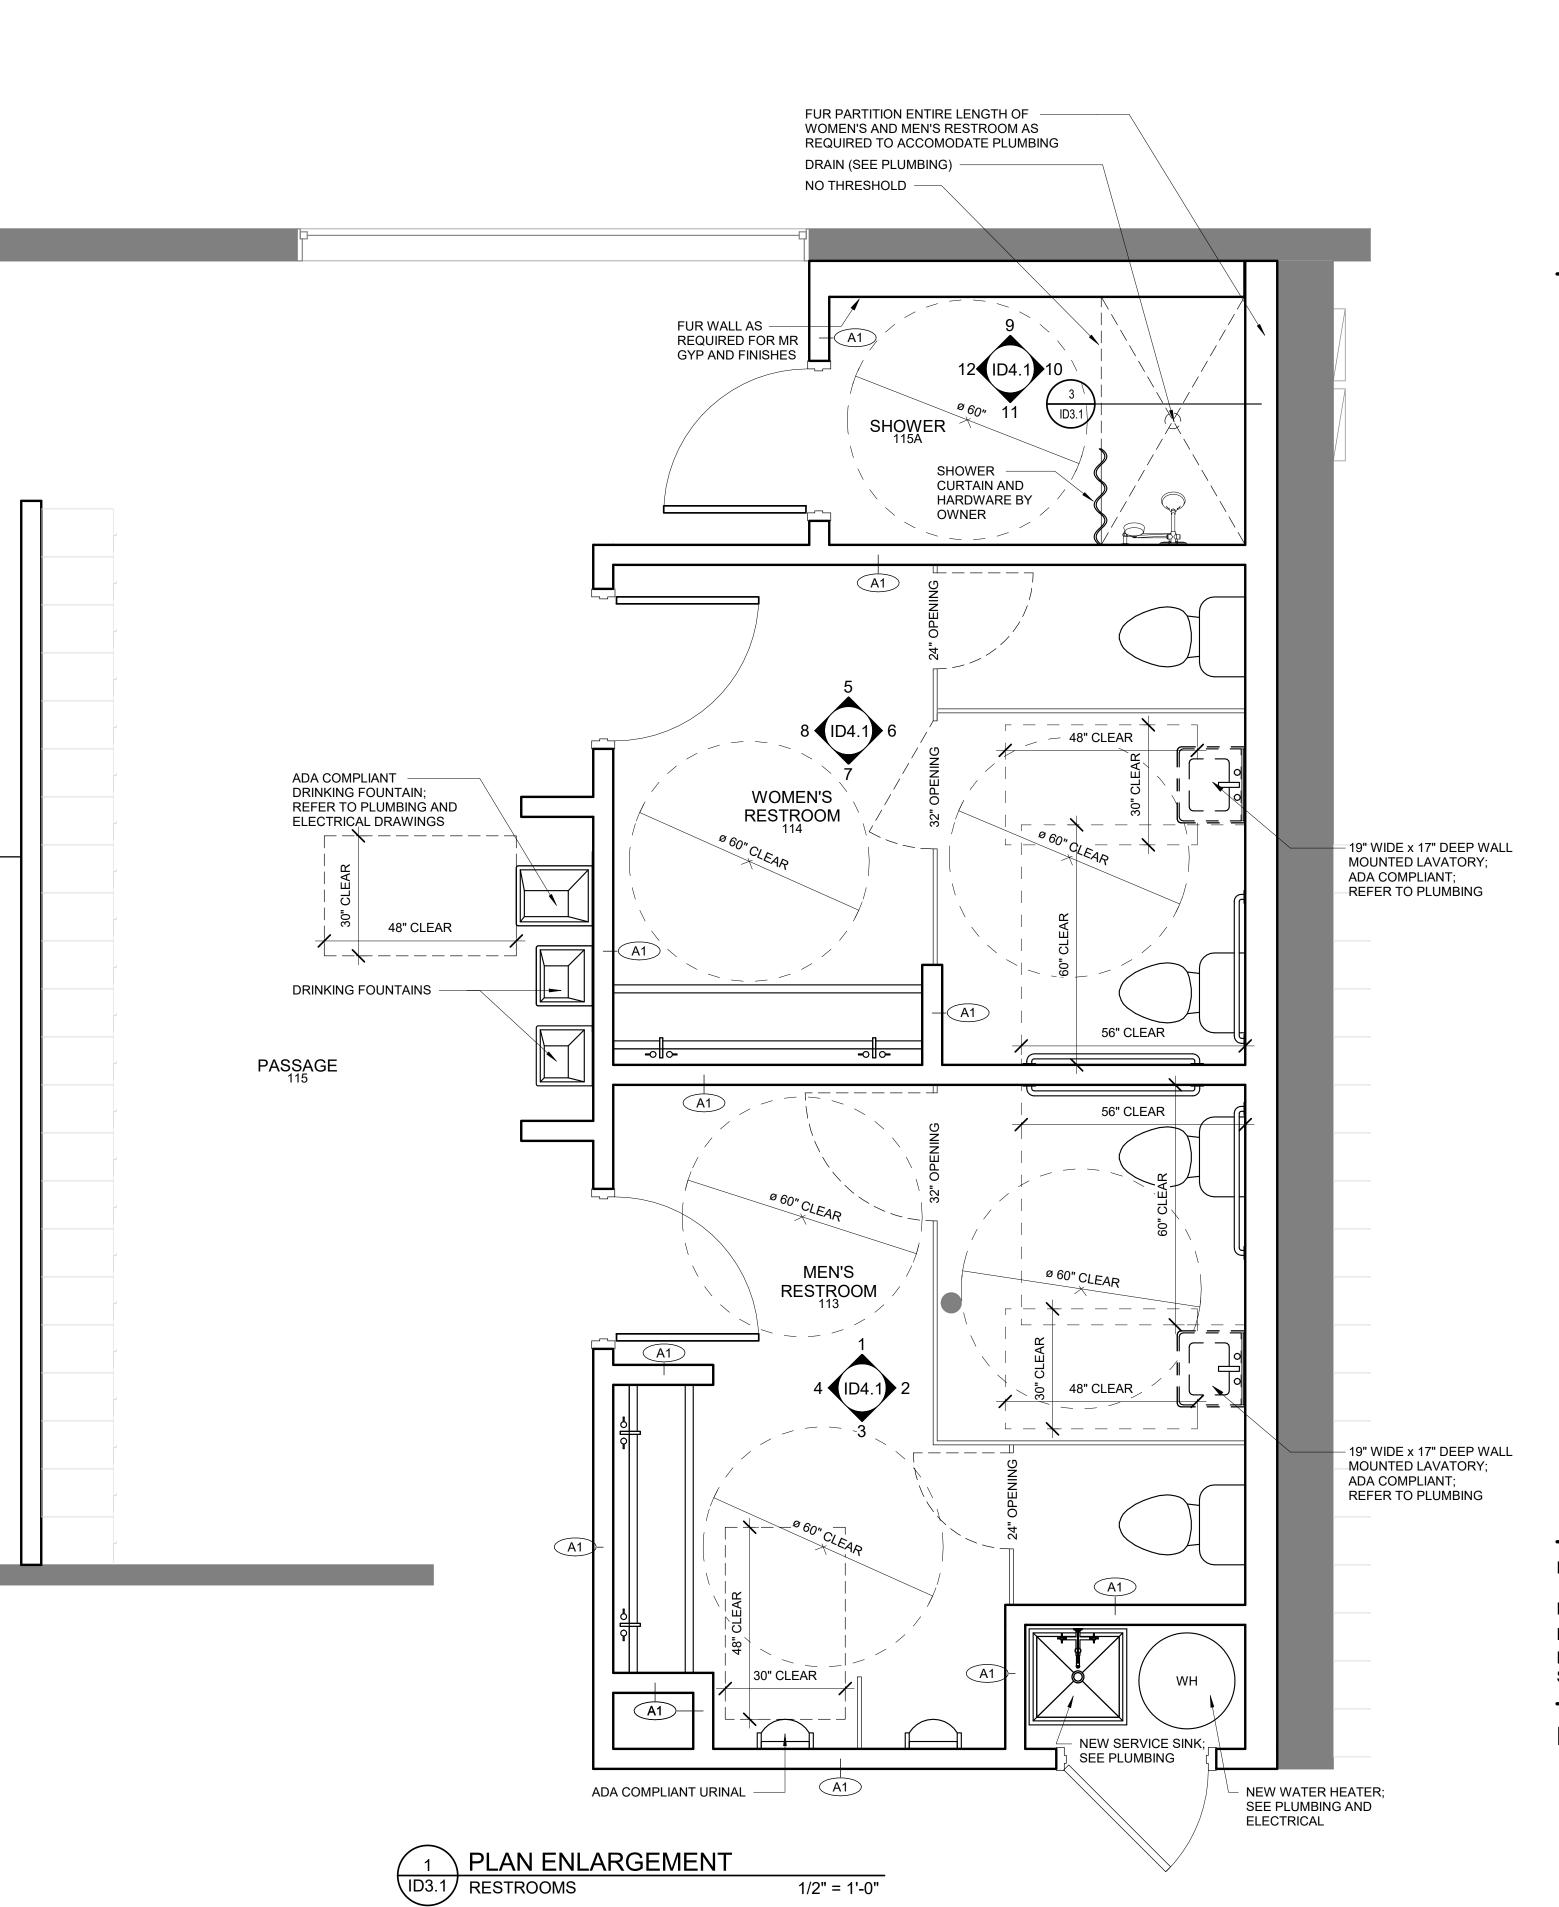

1/2" = 1'-0"




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CONTACT RAYMOND CHIN & KERRY MOWLAM

REVISIONS



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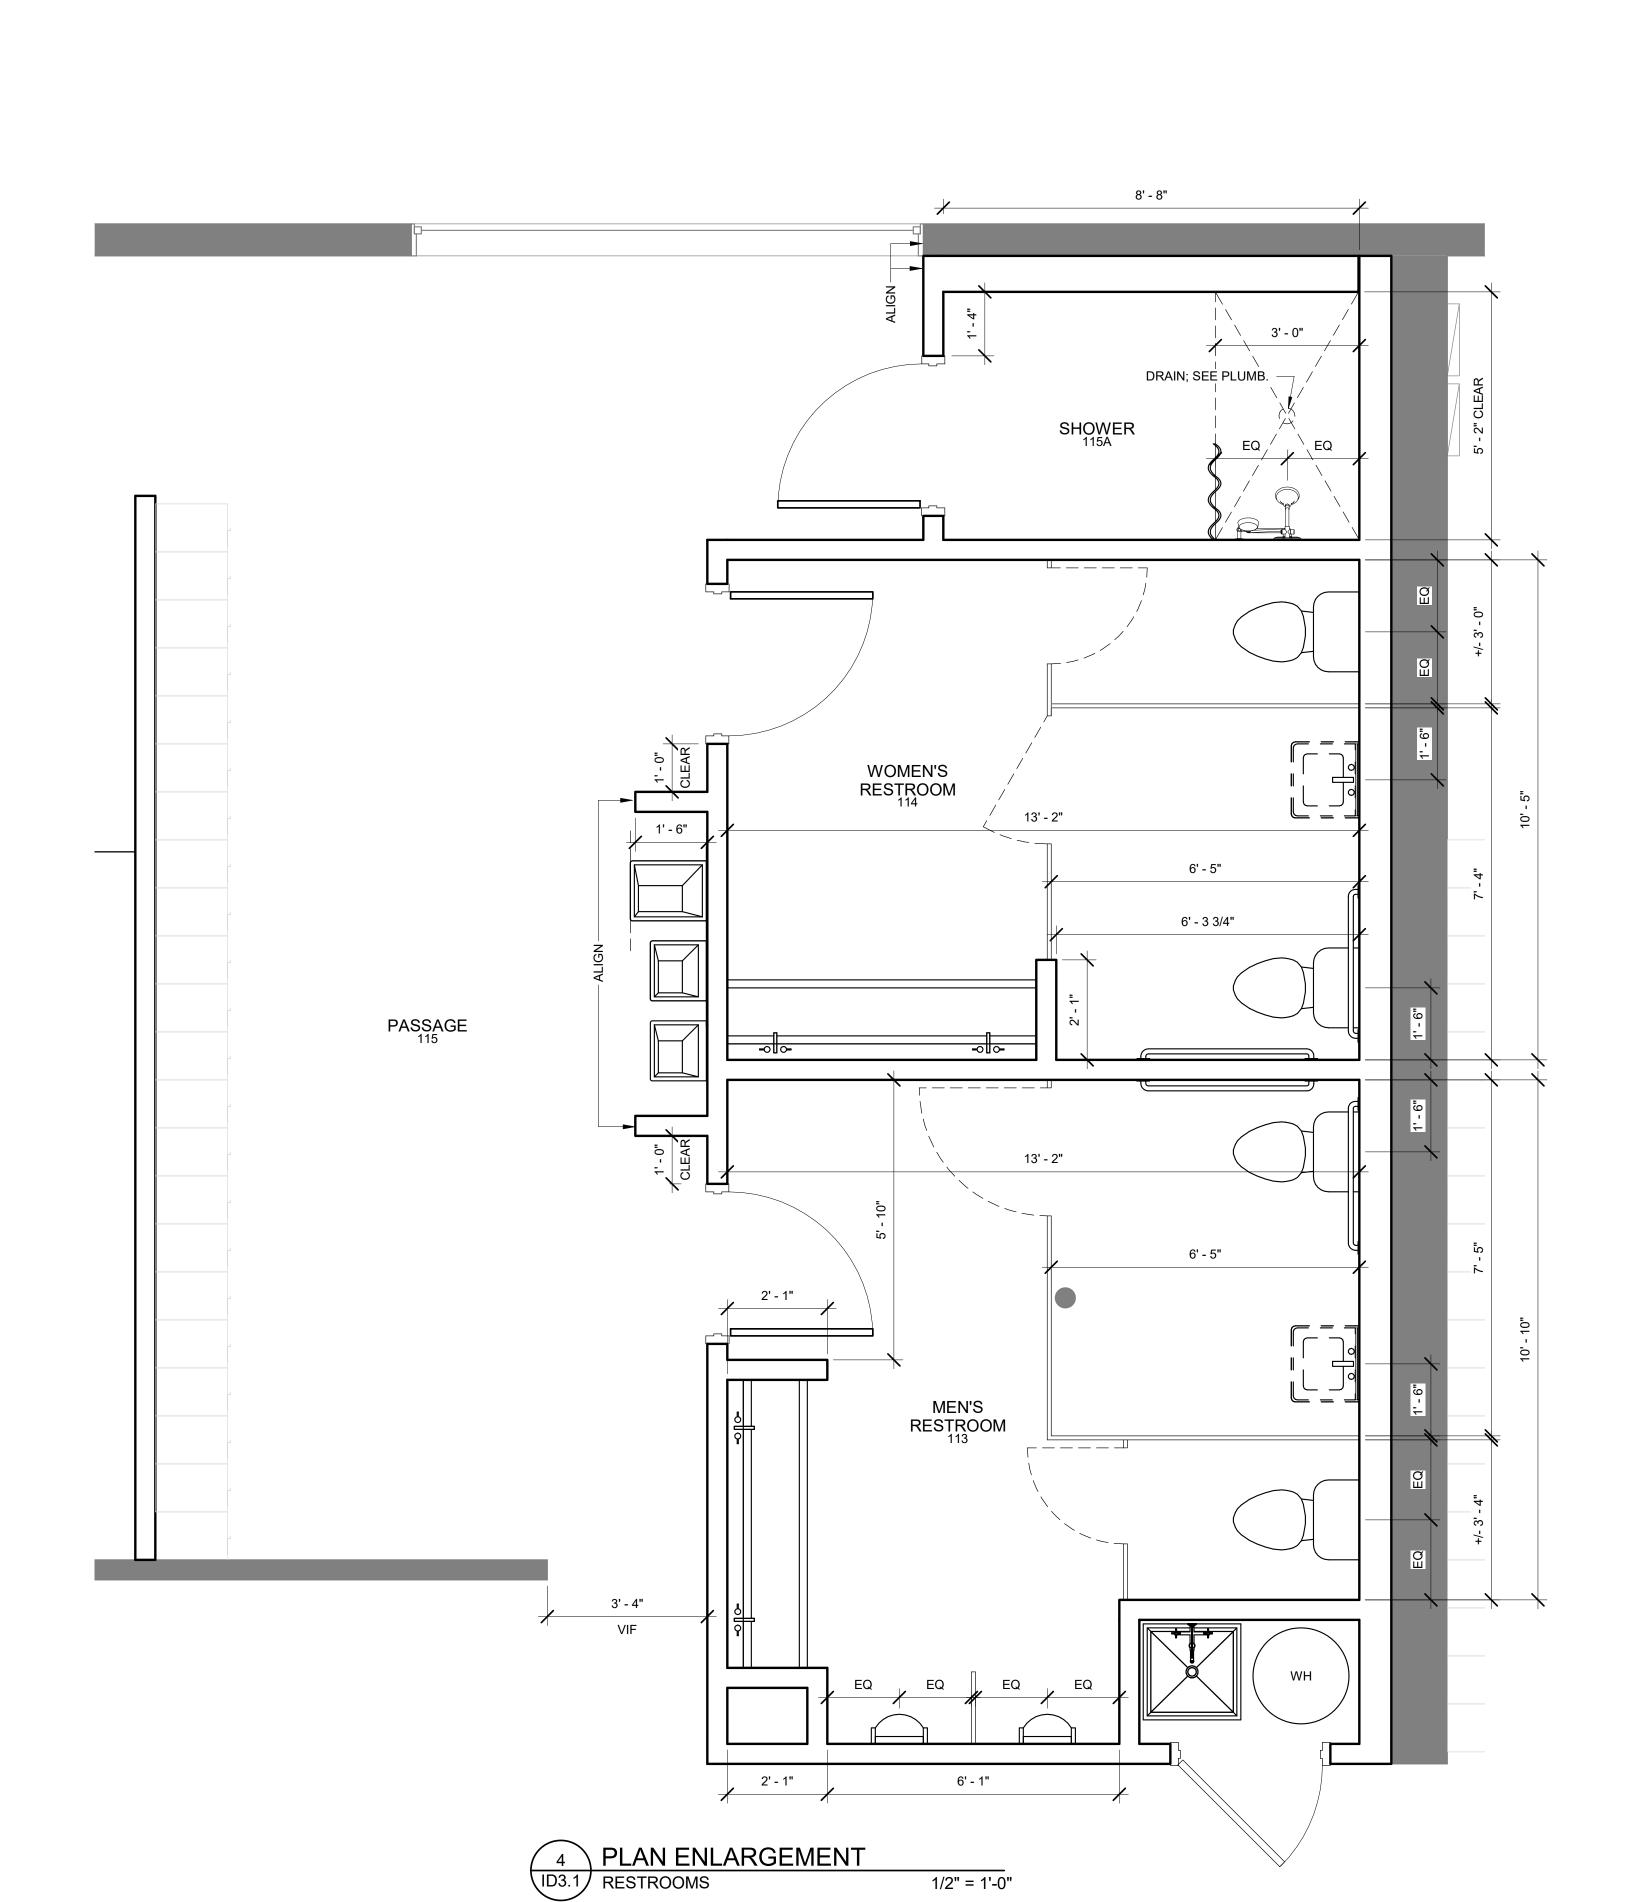
DRAWN BY: PROJECT STATUS:

ENLARGED PLANS

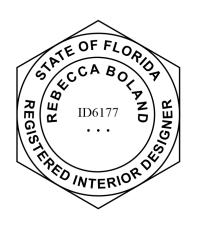KR MECH 1

PERMIT AND PRICING PLANS

10/22/2021




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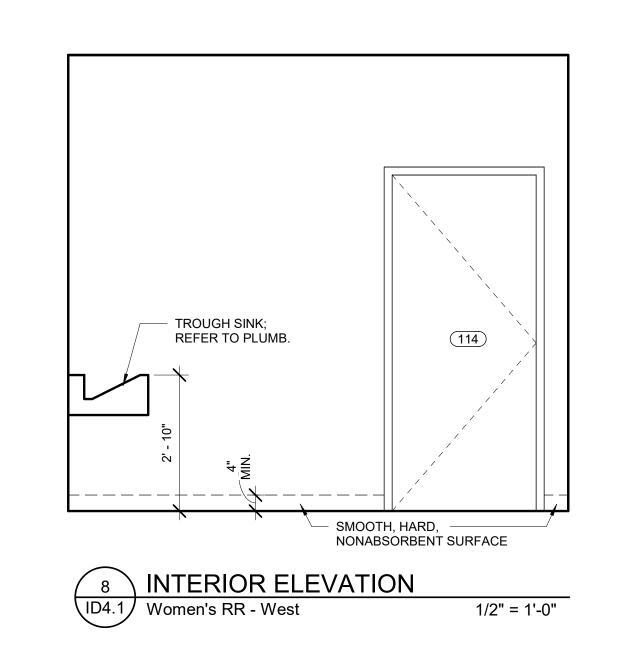
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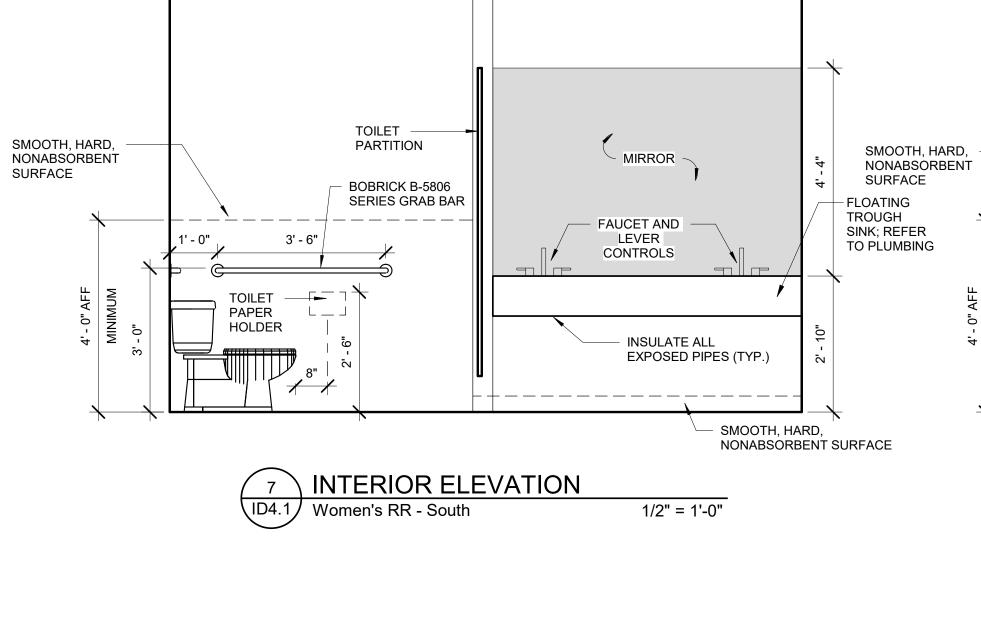
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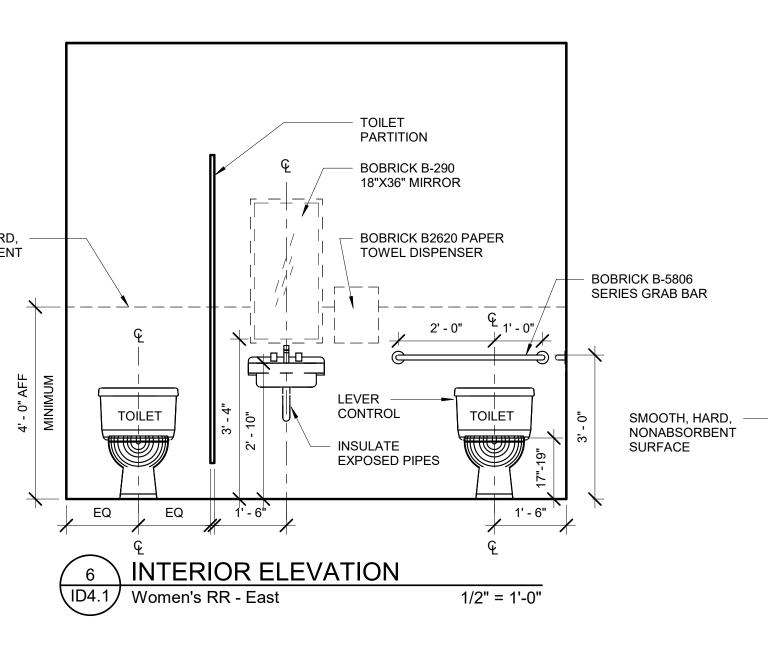
CONTACT RAYMOND CHIN & KERRY MOWLAM


REVISIONS










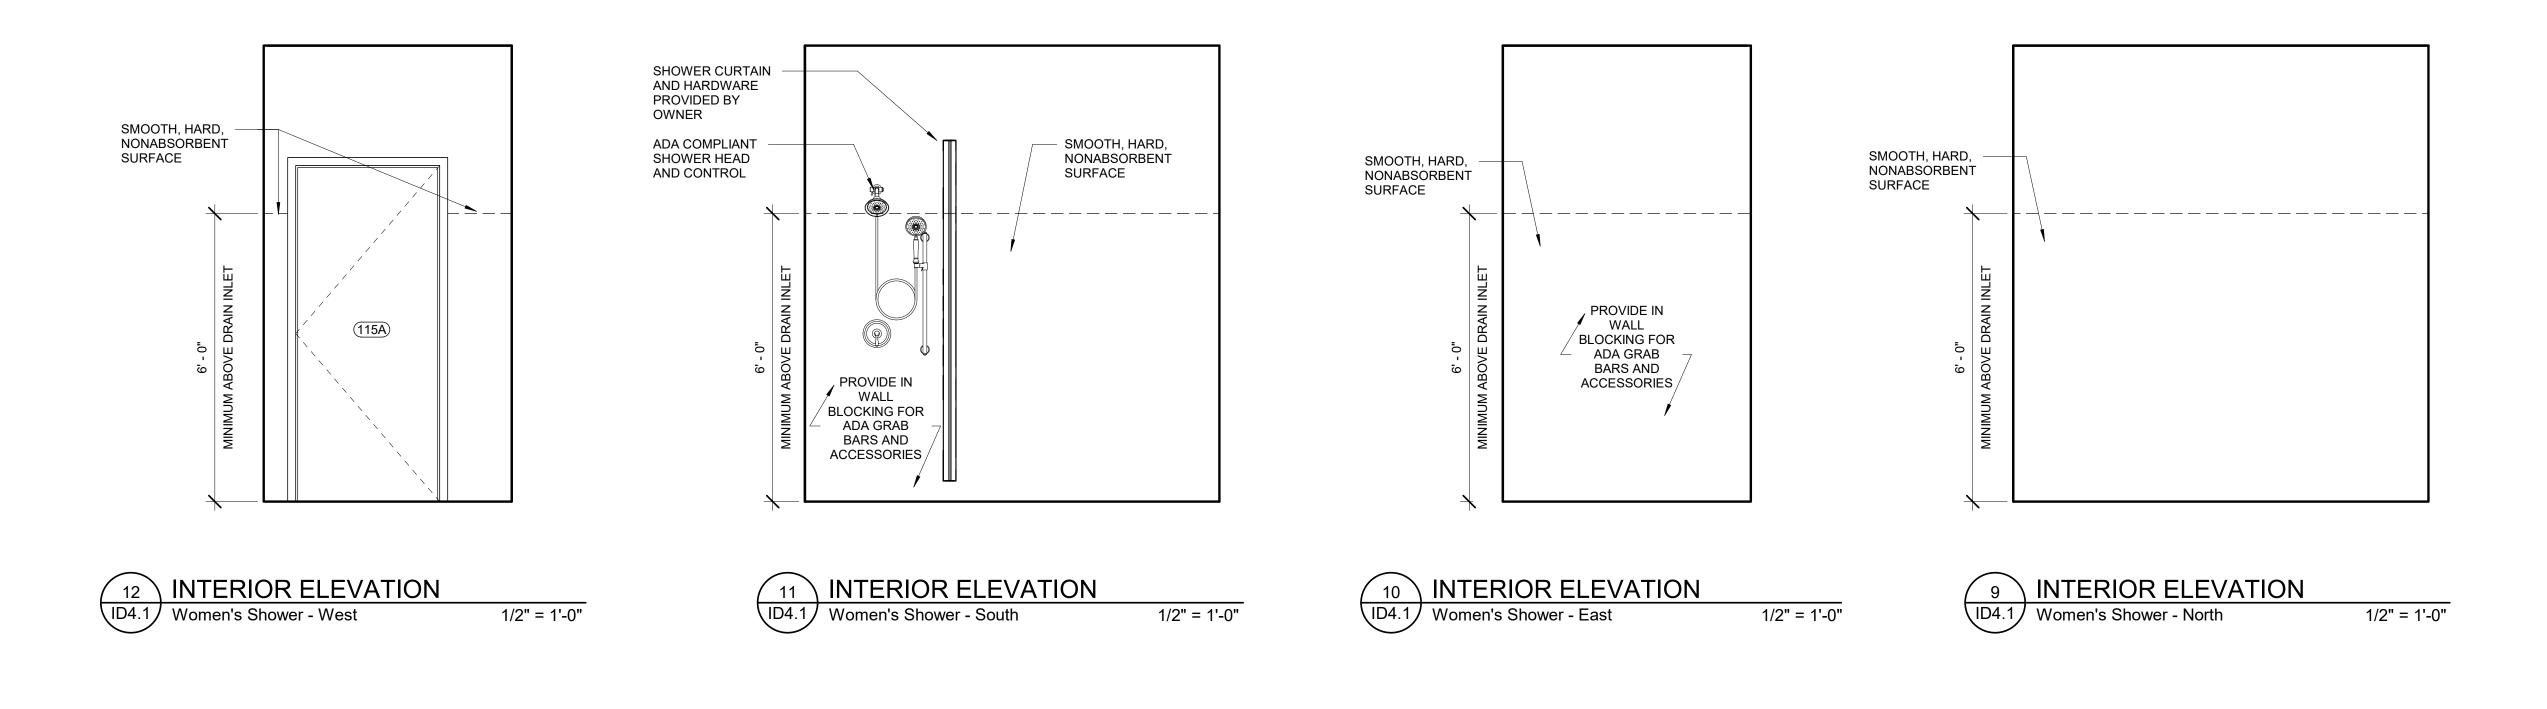


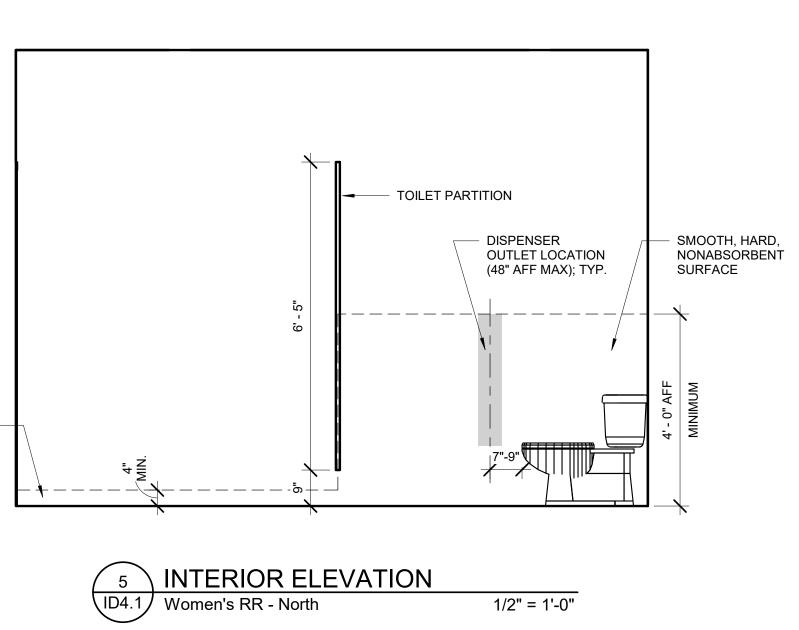

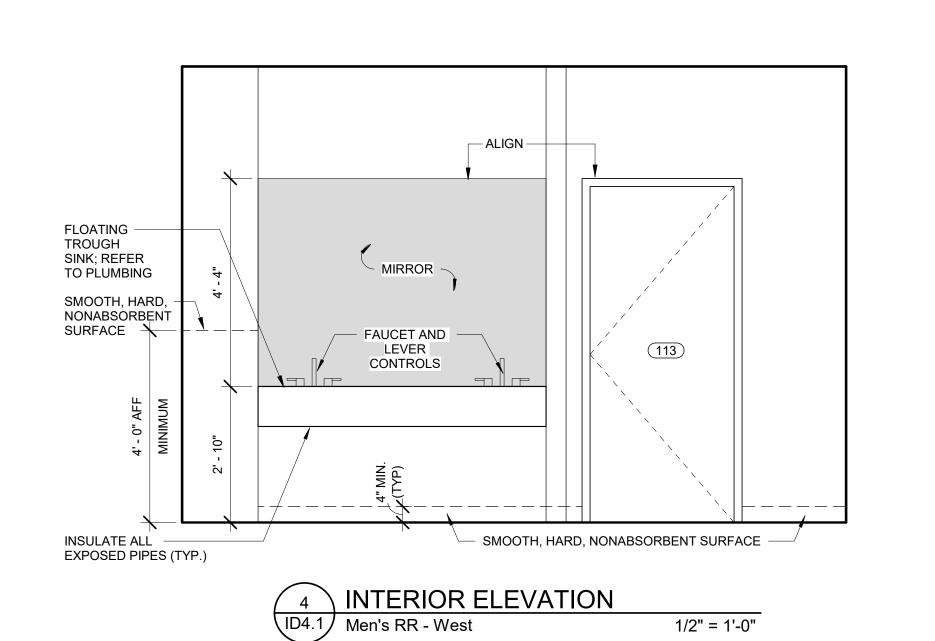


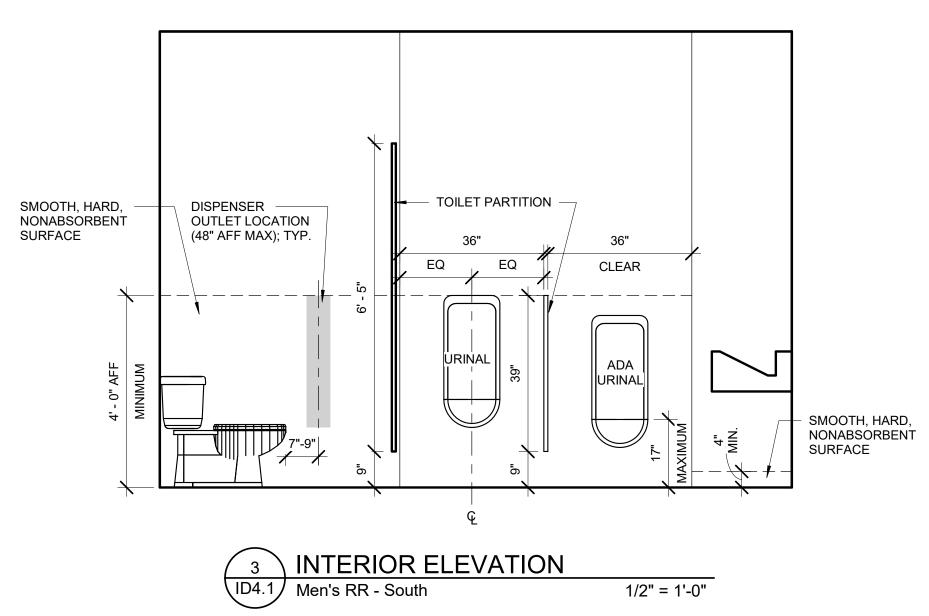

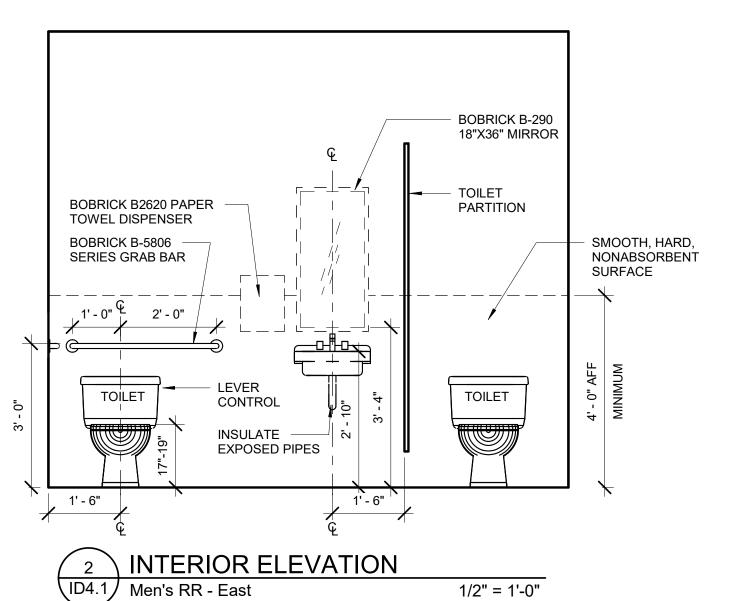

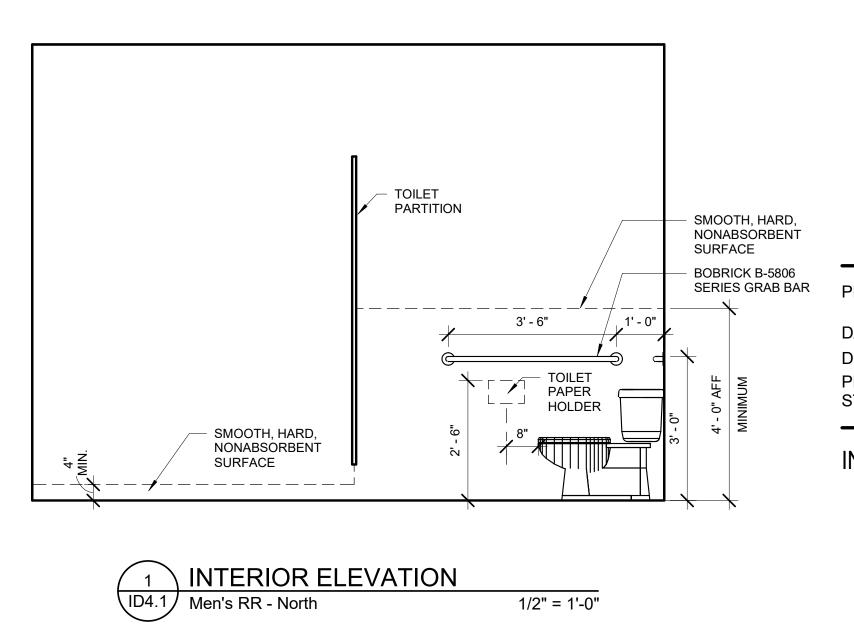

1/2" = 1'-0"

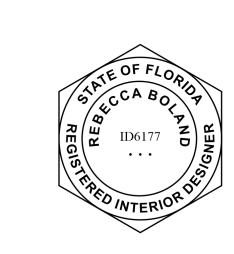


KR MECH 1 PROJECT NUMBER: 10/22/2021 DATE ISSUED: B. BOLAND DRAWN BY: PERMIT AND PRICING PLANS PROJECT STATUS:

INTERIOR ELEVATIONS



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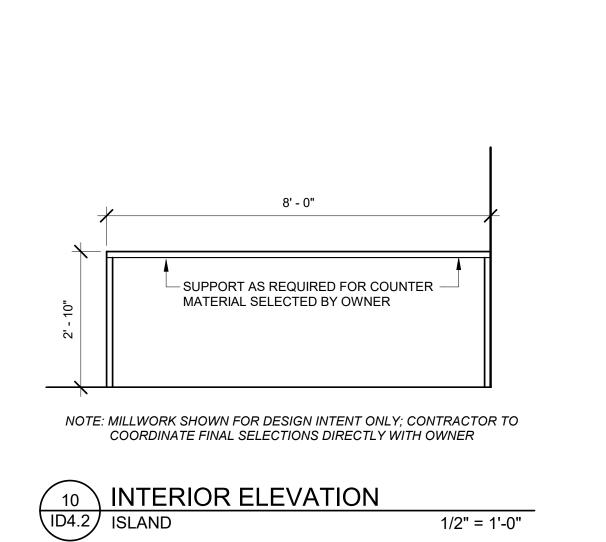



2672 PHYLLIS STREET JACKSONVILLE, FL 32206

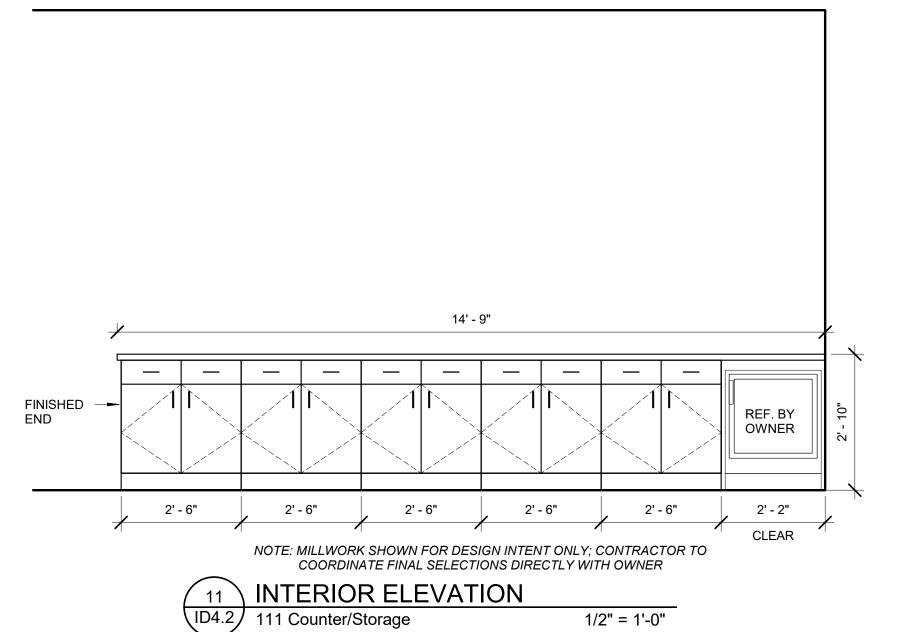
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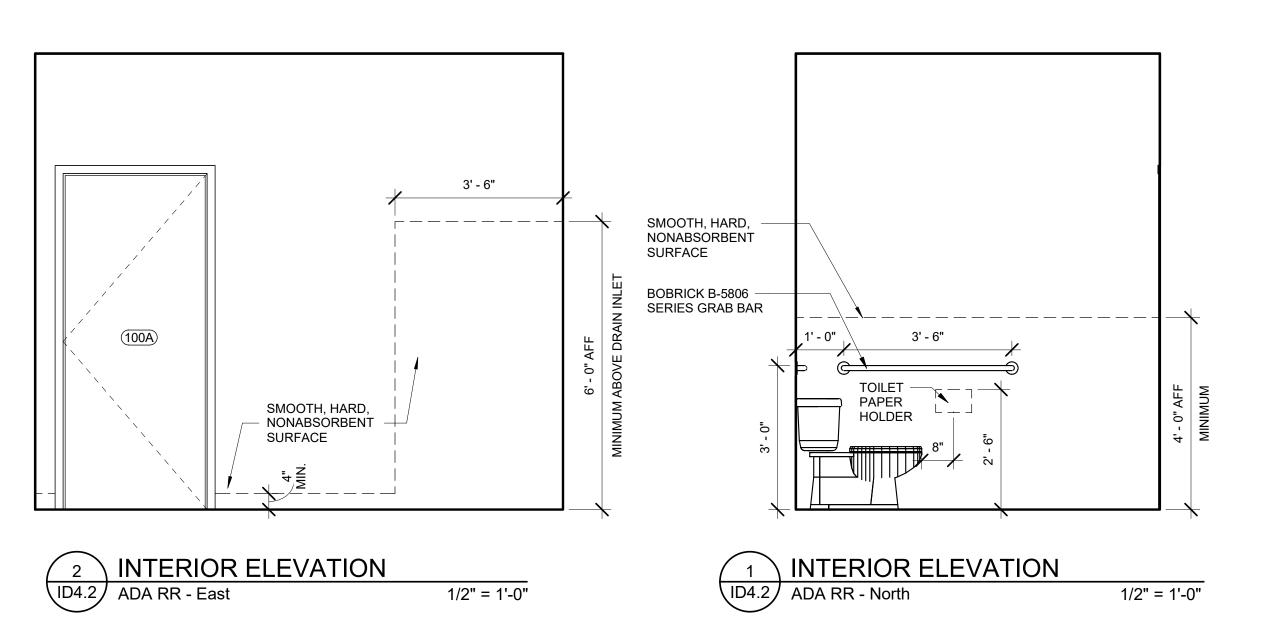
RAYMOND CHIN & KERRY MOWLAM


REVISIONS





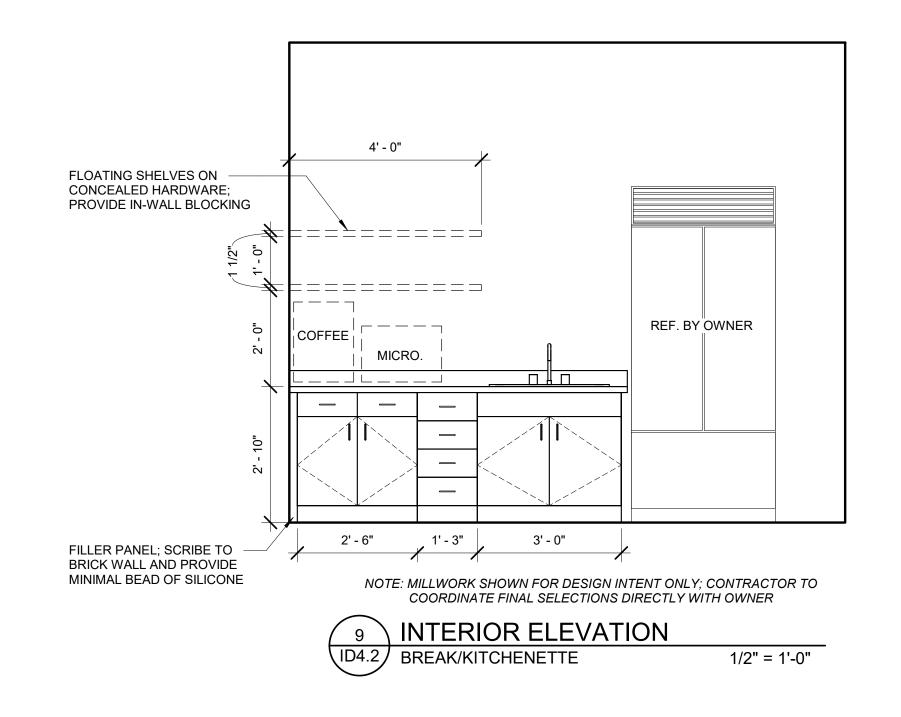

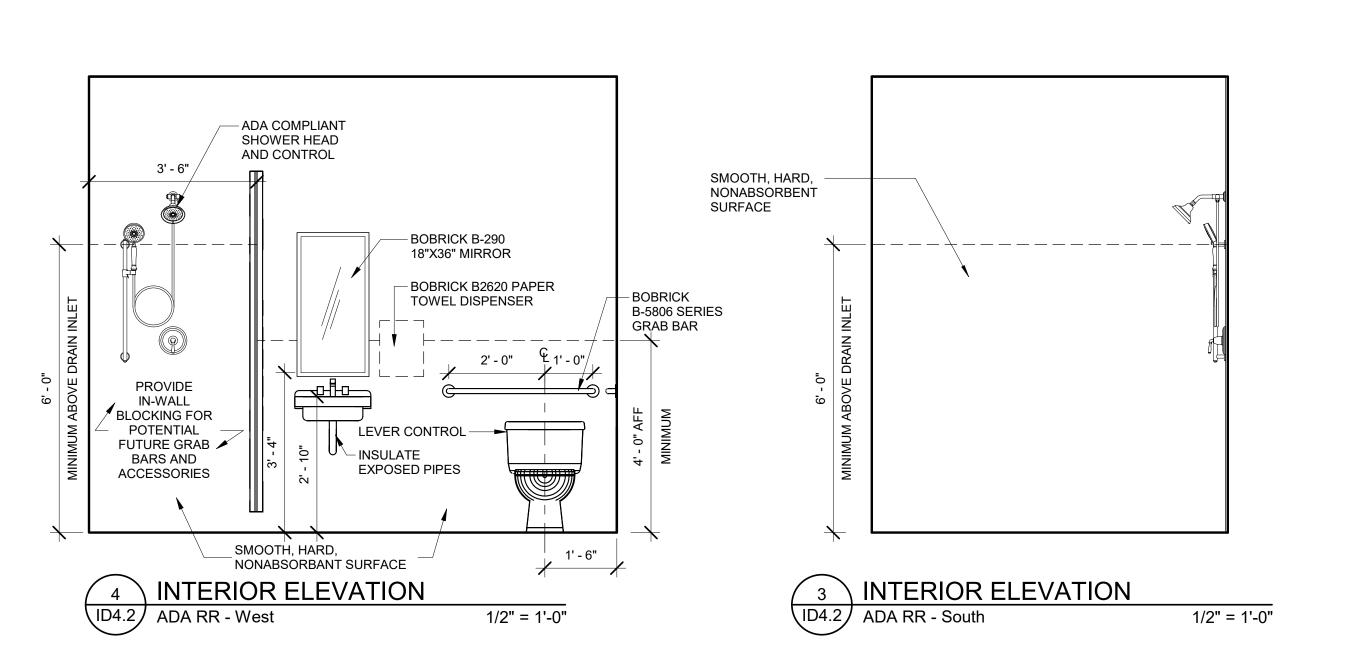

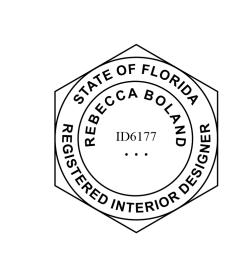


PROJECT NUMBER: DATE ISSUED:

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INTERIOR ELEVATIONS

KR MECH 1

10/22/2021

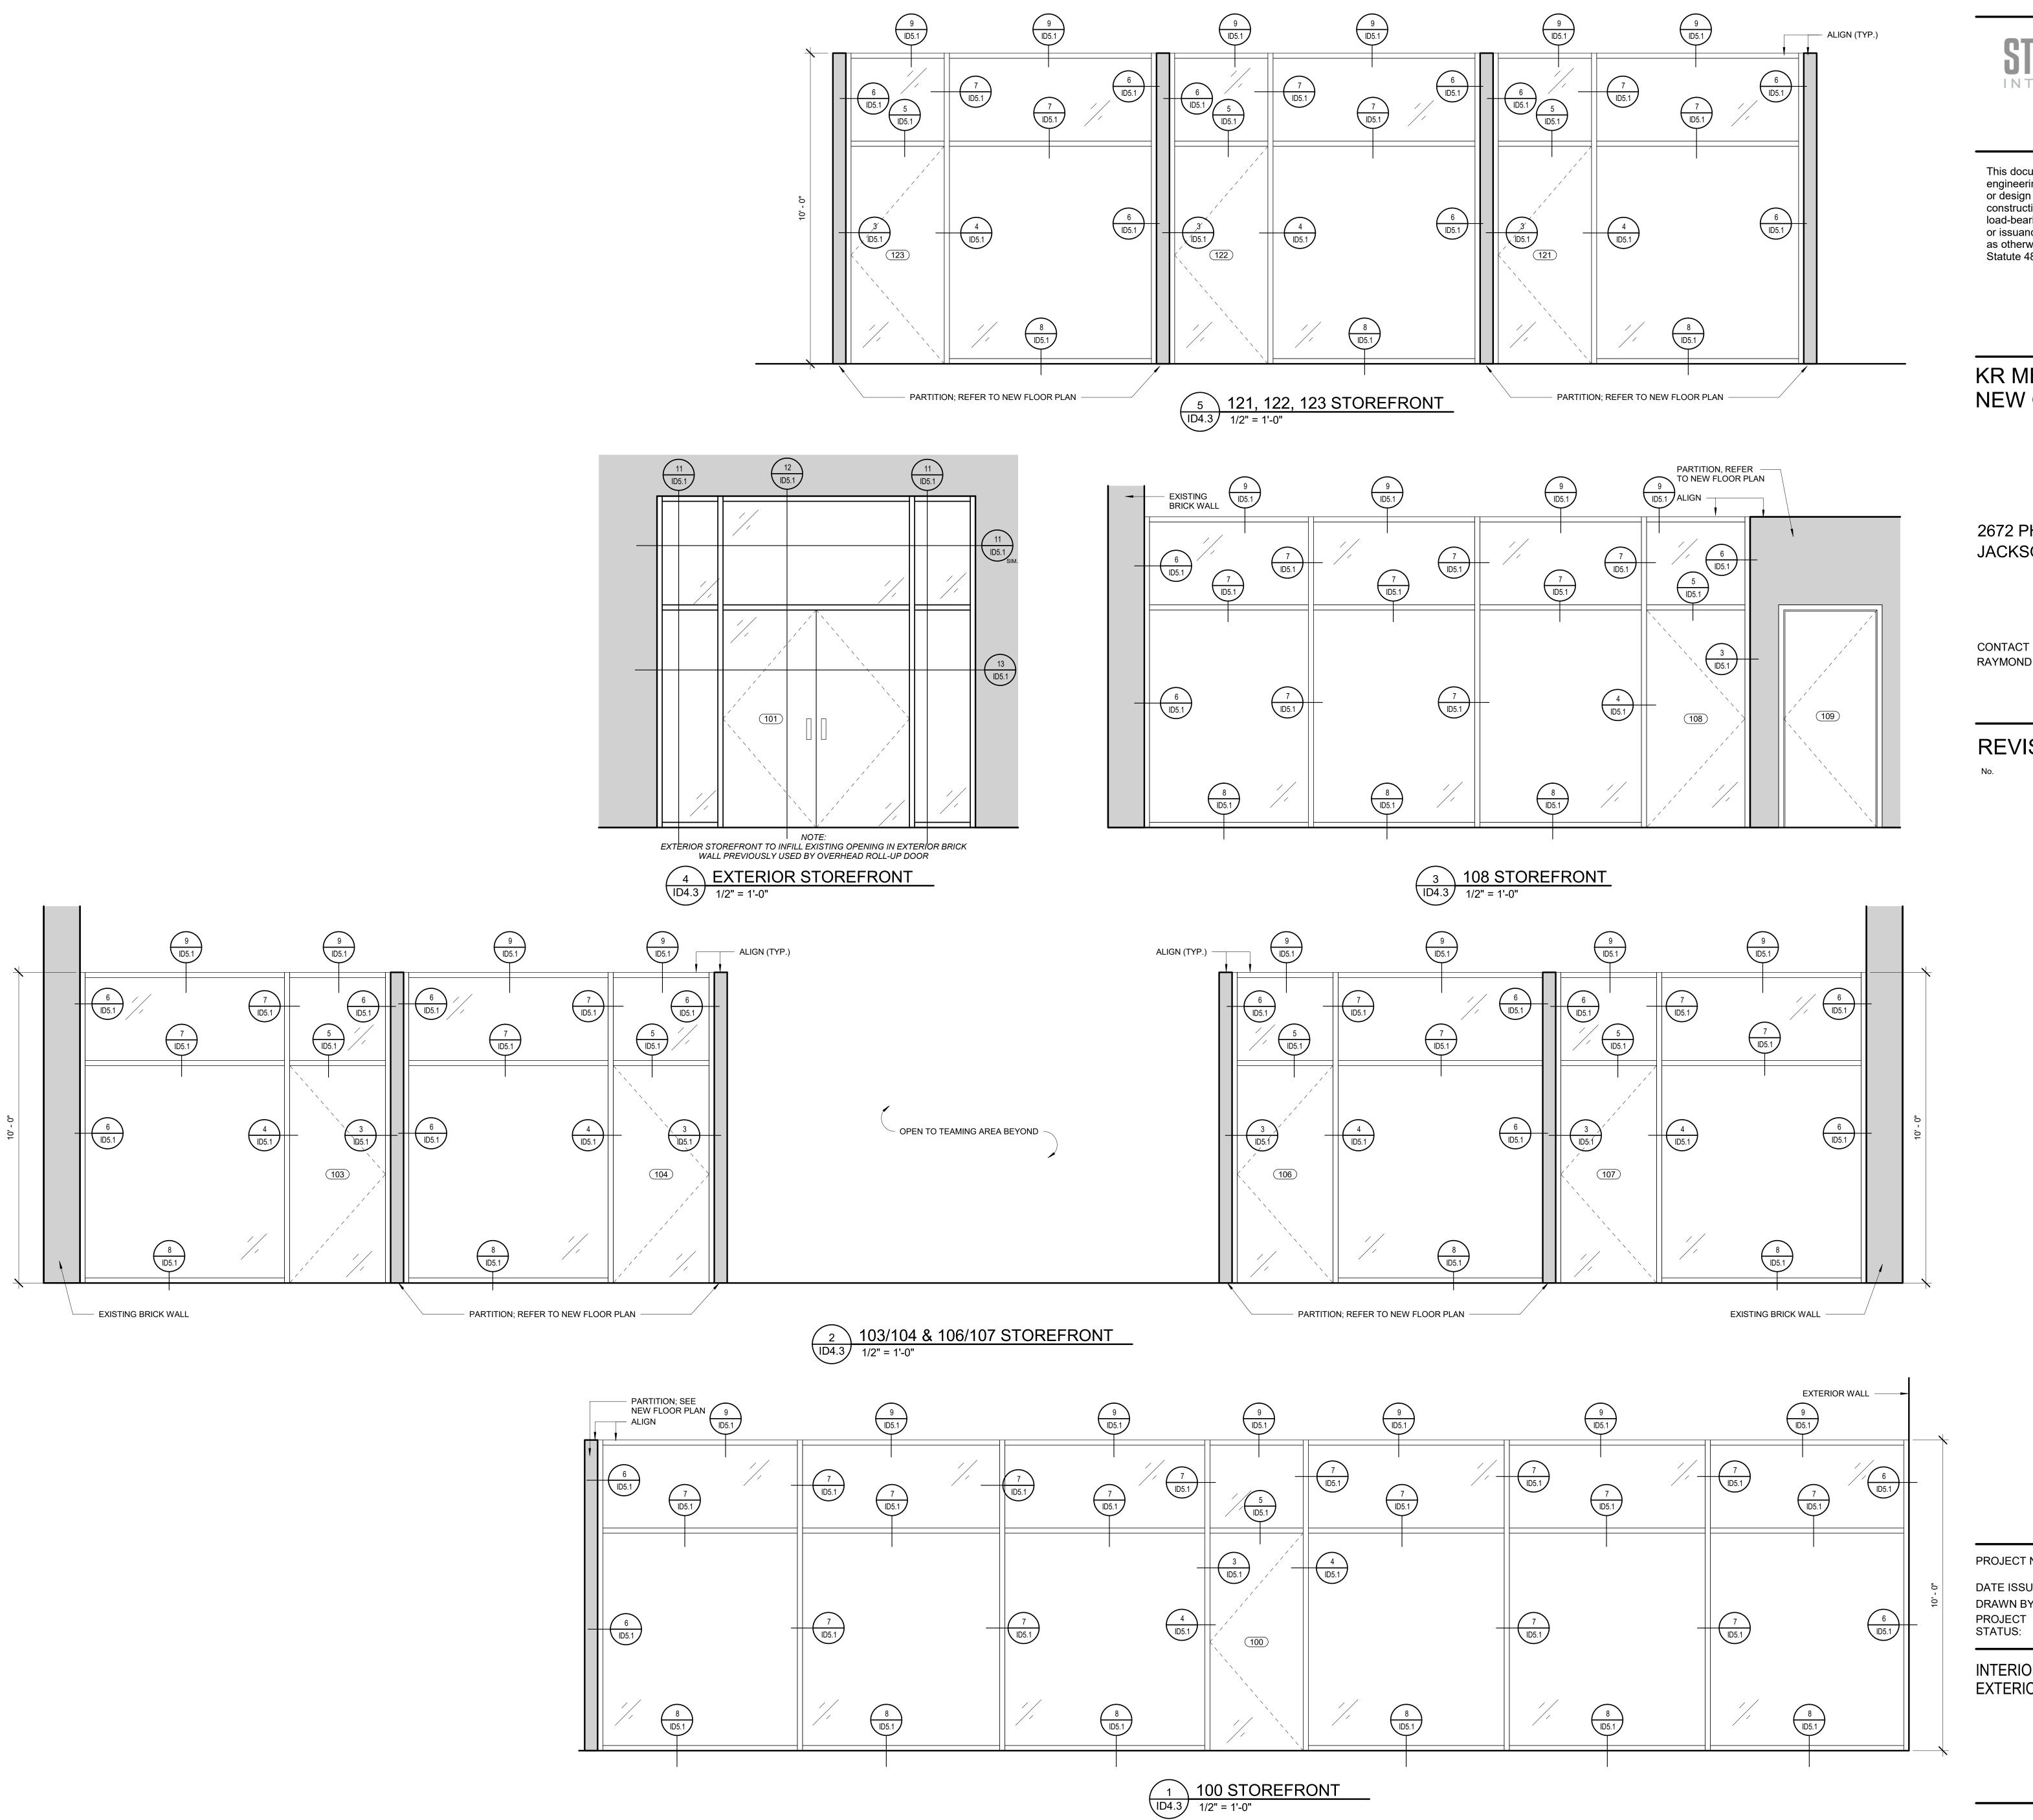

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CONTACT RAYMOND CHIN & KERRY MOWLAM

REVISIONS


PROJECT NUMBER:

DATE ISSUED: B. BOLAND PERMIT AND PRICING PLANS DRAWN BY:

INTERIOR ELEVATIONS AND EXTERIOR STOREFRONT

KR MECH 1

10/22/2021

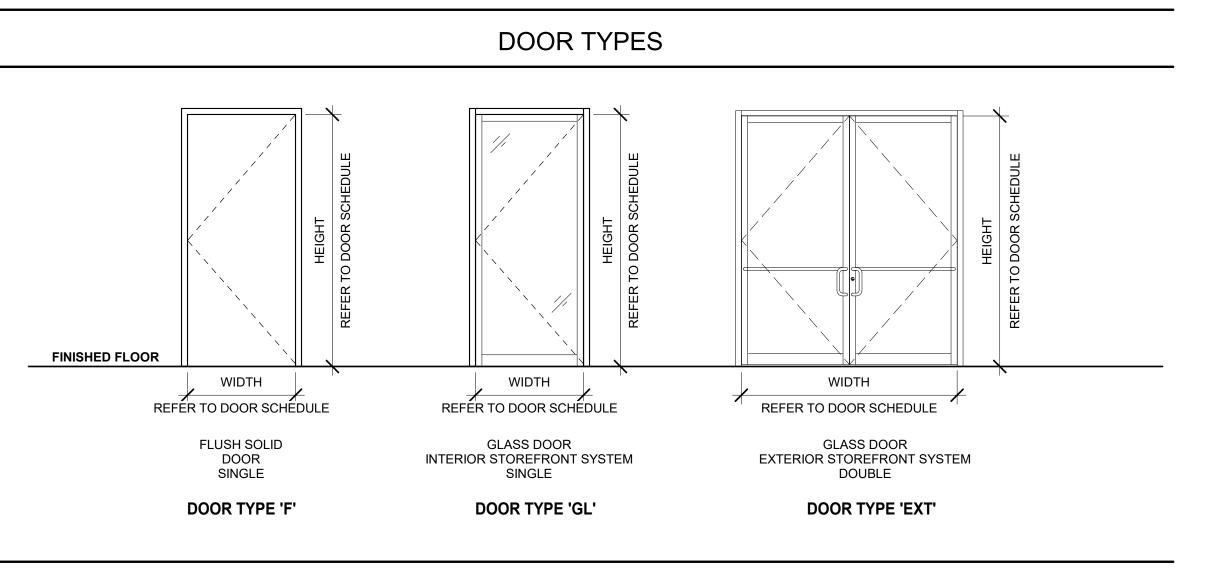

					DOOR S	SCHEDU	LE		
DOOR									
DR NO	TYPE	WIDTH X HGT X THK	MATL	FINISH	FRAME TYPE	FRAME FINSH	HDWR SET	COMMENTS	
RST FLOOR									
100	GL	3' - 0" X 7' - 0" X 1 3/4"	GLASS	TEMPERED	ALUM.	ALUM.	2	DOOR AND HARDWARE FROM STOREFRONT MANUFACTURER	
100A	F	3' - 0" X 7' - 0" X 1 3/4"	METAL	PAINT	HM	PAINT	4		
101	EXT	6' - 0" X 7' - 0" X 1 3/4"	GLASS	TEMPERED	ALUM.	ALUM.	1	DOOR AND HARDWARE FROM STOREFRONT MANUFACTURER	
102D	F	3' - 0" X 7' - 0" X 1 3/4"	METAL	PAINT	HM	PAINT	1		
103	GL	3' - 1" X 7' - 0" X 1 3/4"	GLASS	TEMPERED	ALUM.	ALUM.	2	DOOR AND HARDWARE FROM STOREFRONT MANUFACTURER	
104	GL	3' - 1" X 7' - 0" X 1 3/4"	GLASS	TEMPERED	ALUM.	ALUM.	2	DOOR AND HARDWARE FROM STOREFRONT MANUFACTURER	
106	GL	3' - 1" X 7' - 0" X 1 3/4"	GLASS	TEMPERED	ALUM.	ALUM.	2	DOOR AND HARDWARE FROM STOREFRONT MANUFACTURER	
107	GL	3' - 1" X 7' - 0" X 1 3/4"	GLASS	TEMPERED	ALUM.	ALUM.	2	DOOR AND HARDWARE FROM STOREFRONT MANUFACTURER	
108	GL	3' - 2" X 7' - 0" X 1 3/4"	GLASS	TEMPERED	ALUM.	ALUM.	2	DOOR AND HARDWARE FROM STOREFRONT MANUFACTURER	
109	F	3' - 0" X 7' - 0" X 1 3/4"	METAL	PAINT	HM	PAINT	2		
113	F	3' - 0" X 7' - 0" X 1 3/4"	METAL	PAINT	HM	PAINT	2		
114	F	3' - 0" X 7' - 0" X 1 3/4"	METAL	PAINT	HM	PAINT	2		
115A	F	3' - 0" X 7' - 0" X 1 3/4"	METAL	PAINT	MH	PAINT	4	PROVIDE THRESHOLD TO KEEP WATER IN SHOWER ROOM; ADA COMPLIAN	
116	F	3' - 0" X 7' - 0" X 1 3/4"	METAL	PAINT	HM	PAINT	3		
117	GL	3' - 0" X 7' - 2" X 1 3/4"	GLASS	TEMPERED	ALUM.	ALUM.	2	DOOR AND HARDWARE FROM STOREFRONT MANUFACTURER	
118	GL	3' - 0" X 7' - 2" X 1 3/4"	GLASS	TEMPERED	ALUM.	ALUM.	2	DOOR AND HARDWARE FROM STOREFRONT MANUFACTURER	
119	GL	3' - 0" X 7' - 2" X 1 3/4"	GLASS	TEMPERED	ALUM.	ALUM.	2	DOOR AND HARDWARE FROM STOREFRONT MANUFACTURER	
120	GL	3' - 0" X 7' - 2" X 1 3/4"	GLASS	TEMPERED	ALUM.	ALUM.	2	DOOR AND HARDWARE FROM STOREFRONT MANUFACTURER	
121	GL	3' - 0" X 7' - 0" X 1 3/4"	GLASS	TEMPERED	ALUM.	ALUM.	2	DOOR AND HARDWARE FROM STOREFRONT MANUFACTURER	
122	GL	3' - 0" X 7' - 0" X 1 3/4"	GLASS	TEMPERED	ALUM.	ALUM.	2	DOOR AND HARDWARE FROM STOREFRONT MANUFACTURER	
123	GL	3' - 0" X 7' - 0" X 1 3/4"	GLASS	TEMPERED	ALUM.	ALUM.	2	DOOR AND HARDWARE FROM STOREFRONT MANUFACTURER	
124	F	3' - 0" X 7' - 0" X 1 3/4"	METAL	PAINT	HM	PAINT	2		
125	F	3' - 0" X 7' - 0" X 1 3/4"	METAL	PAINT	HM	PAINT	1		

SIZE & HANDING

TYPICAL HOLLOW METAL EQUAL RABBET

MTL STUD DOOR JAMB DETAIL

2 SECTION DETAIL

ID5.1 HM - DOOR JAMB DETAIL

CAULK BOTH SIDES OF FRAME TO PARTITION

3" = 1'-0"



or design and is not to be used for construction of any load-bearing columns, load-bearing framing or walls of structures, or issuance of any building permit, except as otherwise provided by law (Florida Statute 481.2131)


KR MECHANICAL **NEW OFFICE**

2672 PHYLLIS STREET JACKSONVILLE, FL 32206

CONTACT

RAYMOND CHIN & KERRY MOWLAM

REVISIONS

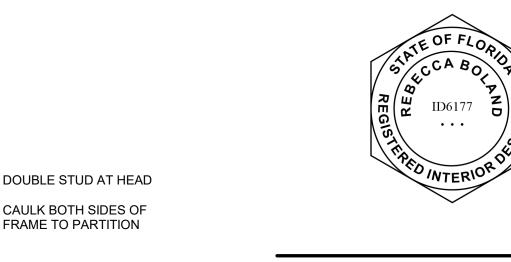

- REFER TO DOOR SCHEDULE AND FLOOR PLANS FOR

3" = 1'-0"

EQ

TYPICAL HOLLOW METAL EQUAL RABBET MTL STUD DOOR HEAD DETAIL


1 SECTION DETAIL

(ID5.1) HM - DOOR HEAD DETAIL

EQ

PROJECT NUMBER:	KR MECH 1
DATE ISSUED:	10/22/2021
DRAWN BY:	B. BOLAND
PROJECT STATUS:	PERMIT AND PRICING PLANS

DOOR SCHEDULE & DETAILS

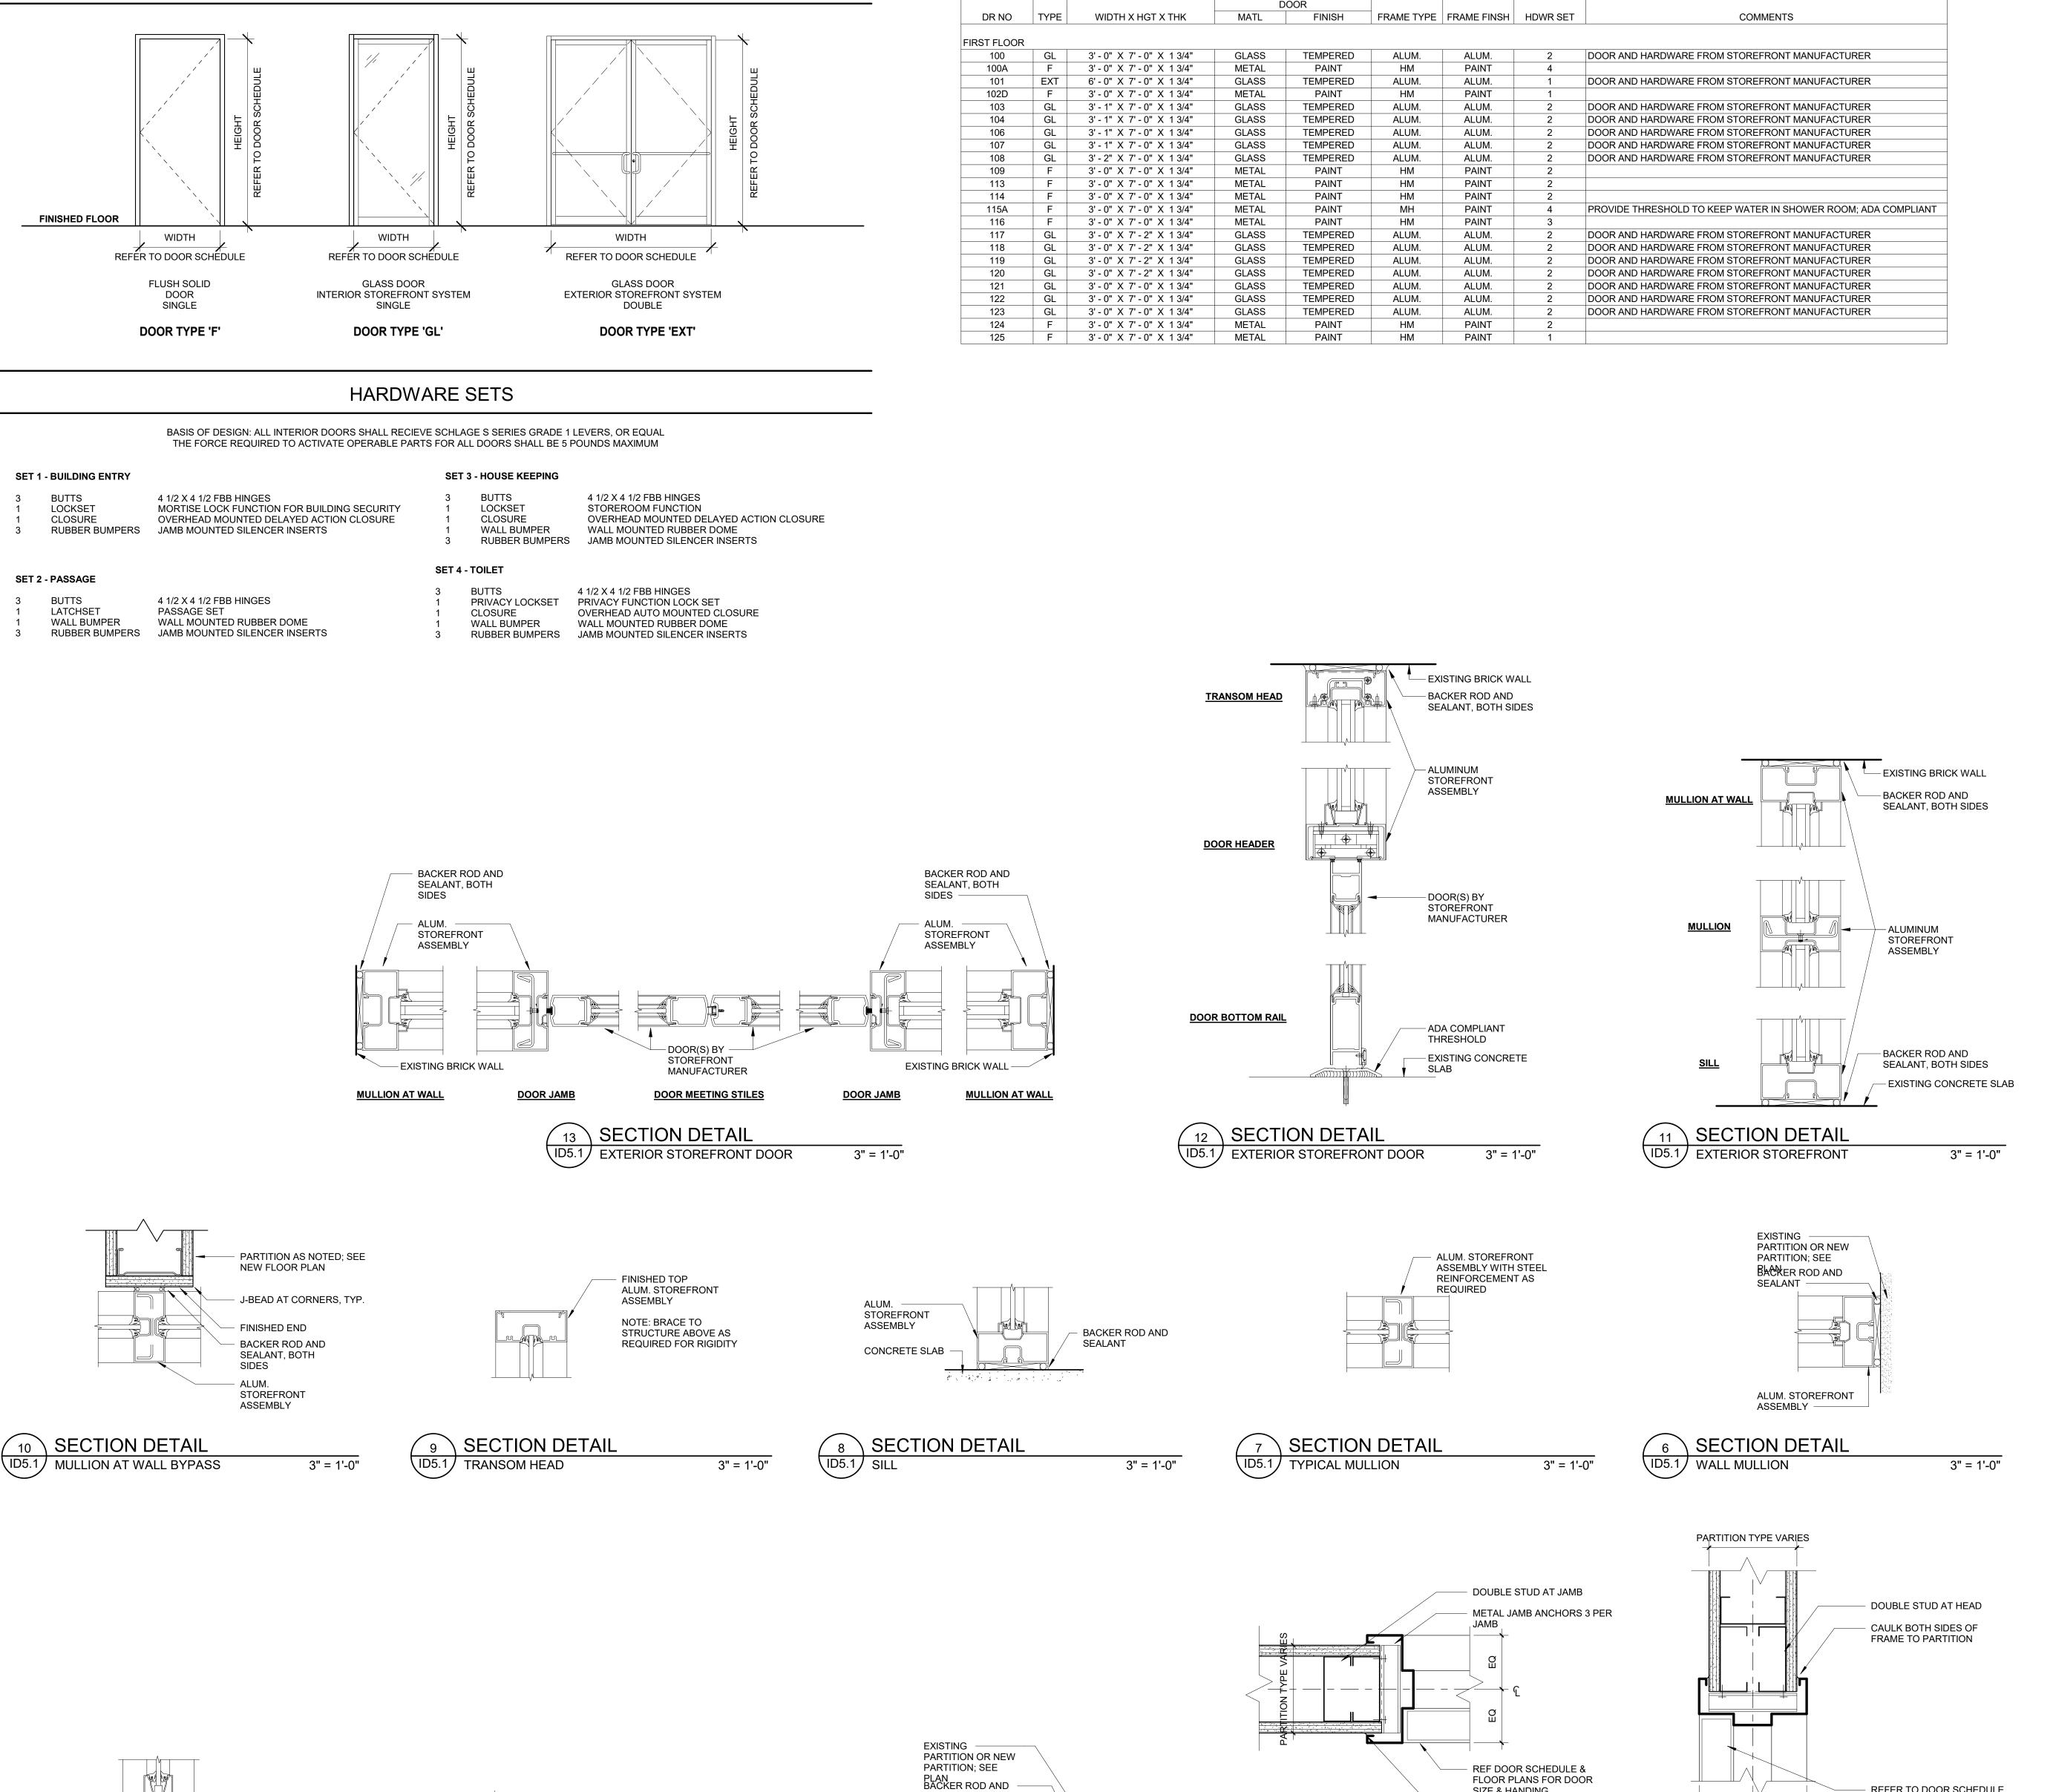

SEALANT

DOOR

3 SECTION DETAIL

(ID5.1) DOOR JAMB AT WALL

DOOR

4 SECTION DETAIL

ID5.1 DOOR JAMB WITH SIDELITE

ALUM. STOREFRONT

ASSEMBLY WITH STEEL REINFORCEMENT

3" = 1'-0"

STOREFRONT

ALUM. STOREFRONT ASSEMBLY

3" = 1'-0"


STOREFRONT


ASSEMBLY

STOREFRONT

3" = 1'-0"

DOOR

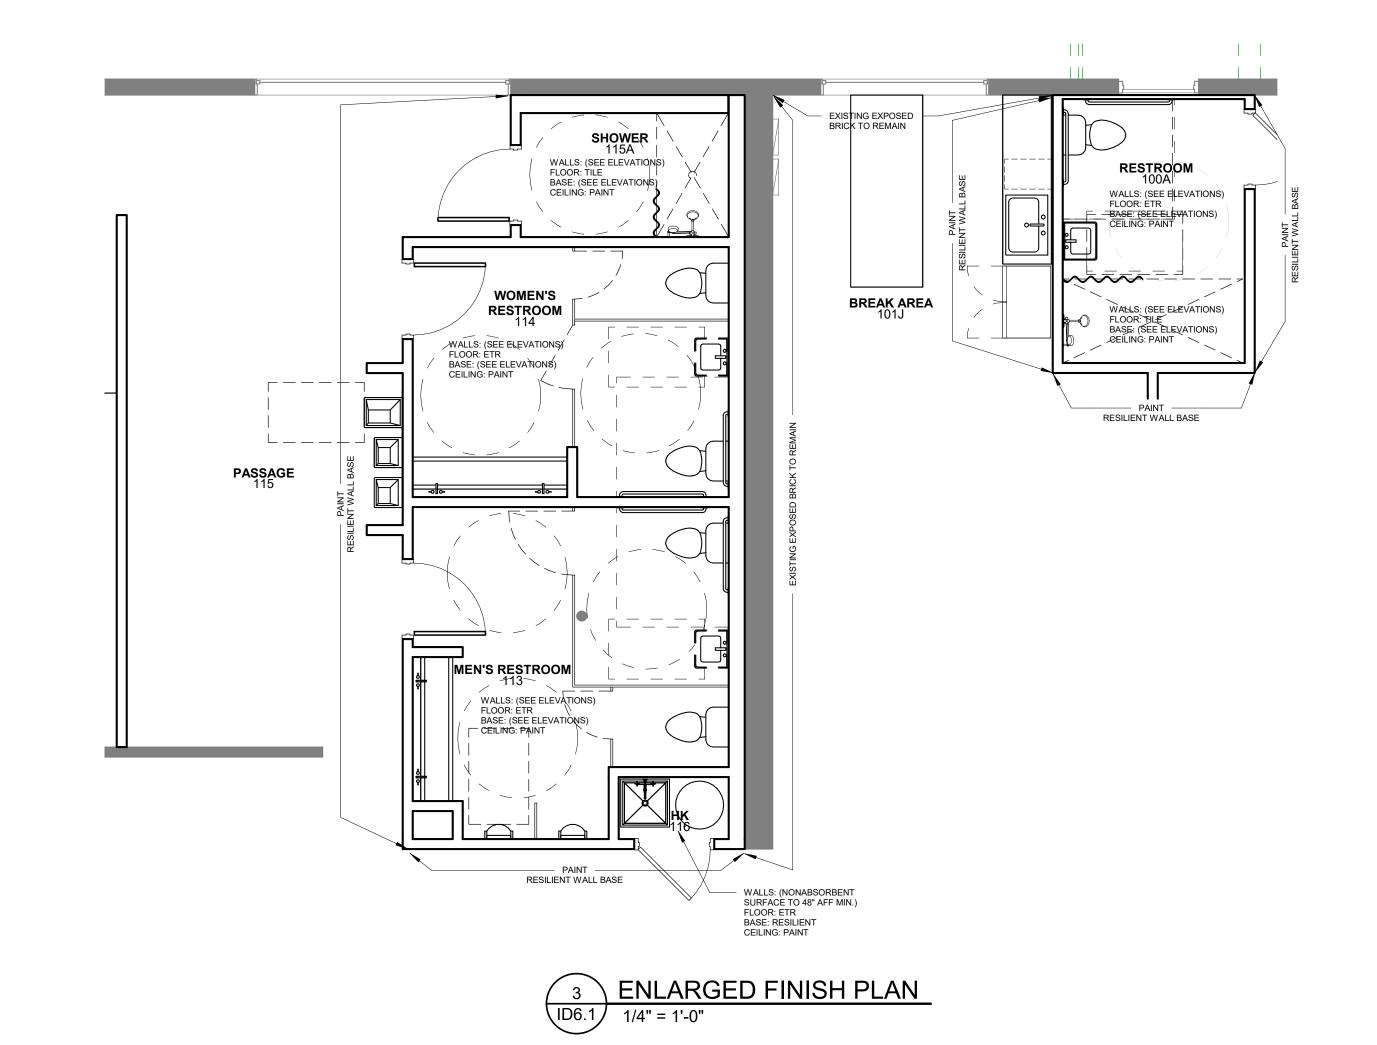

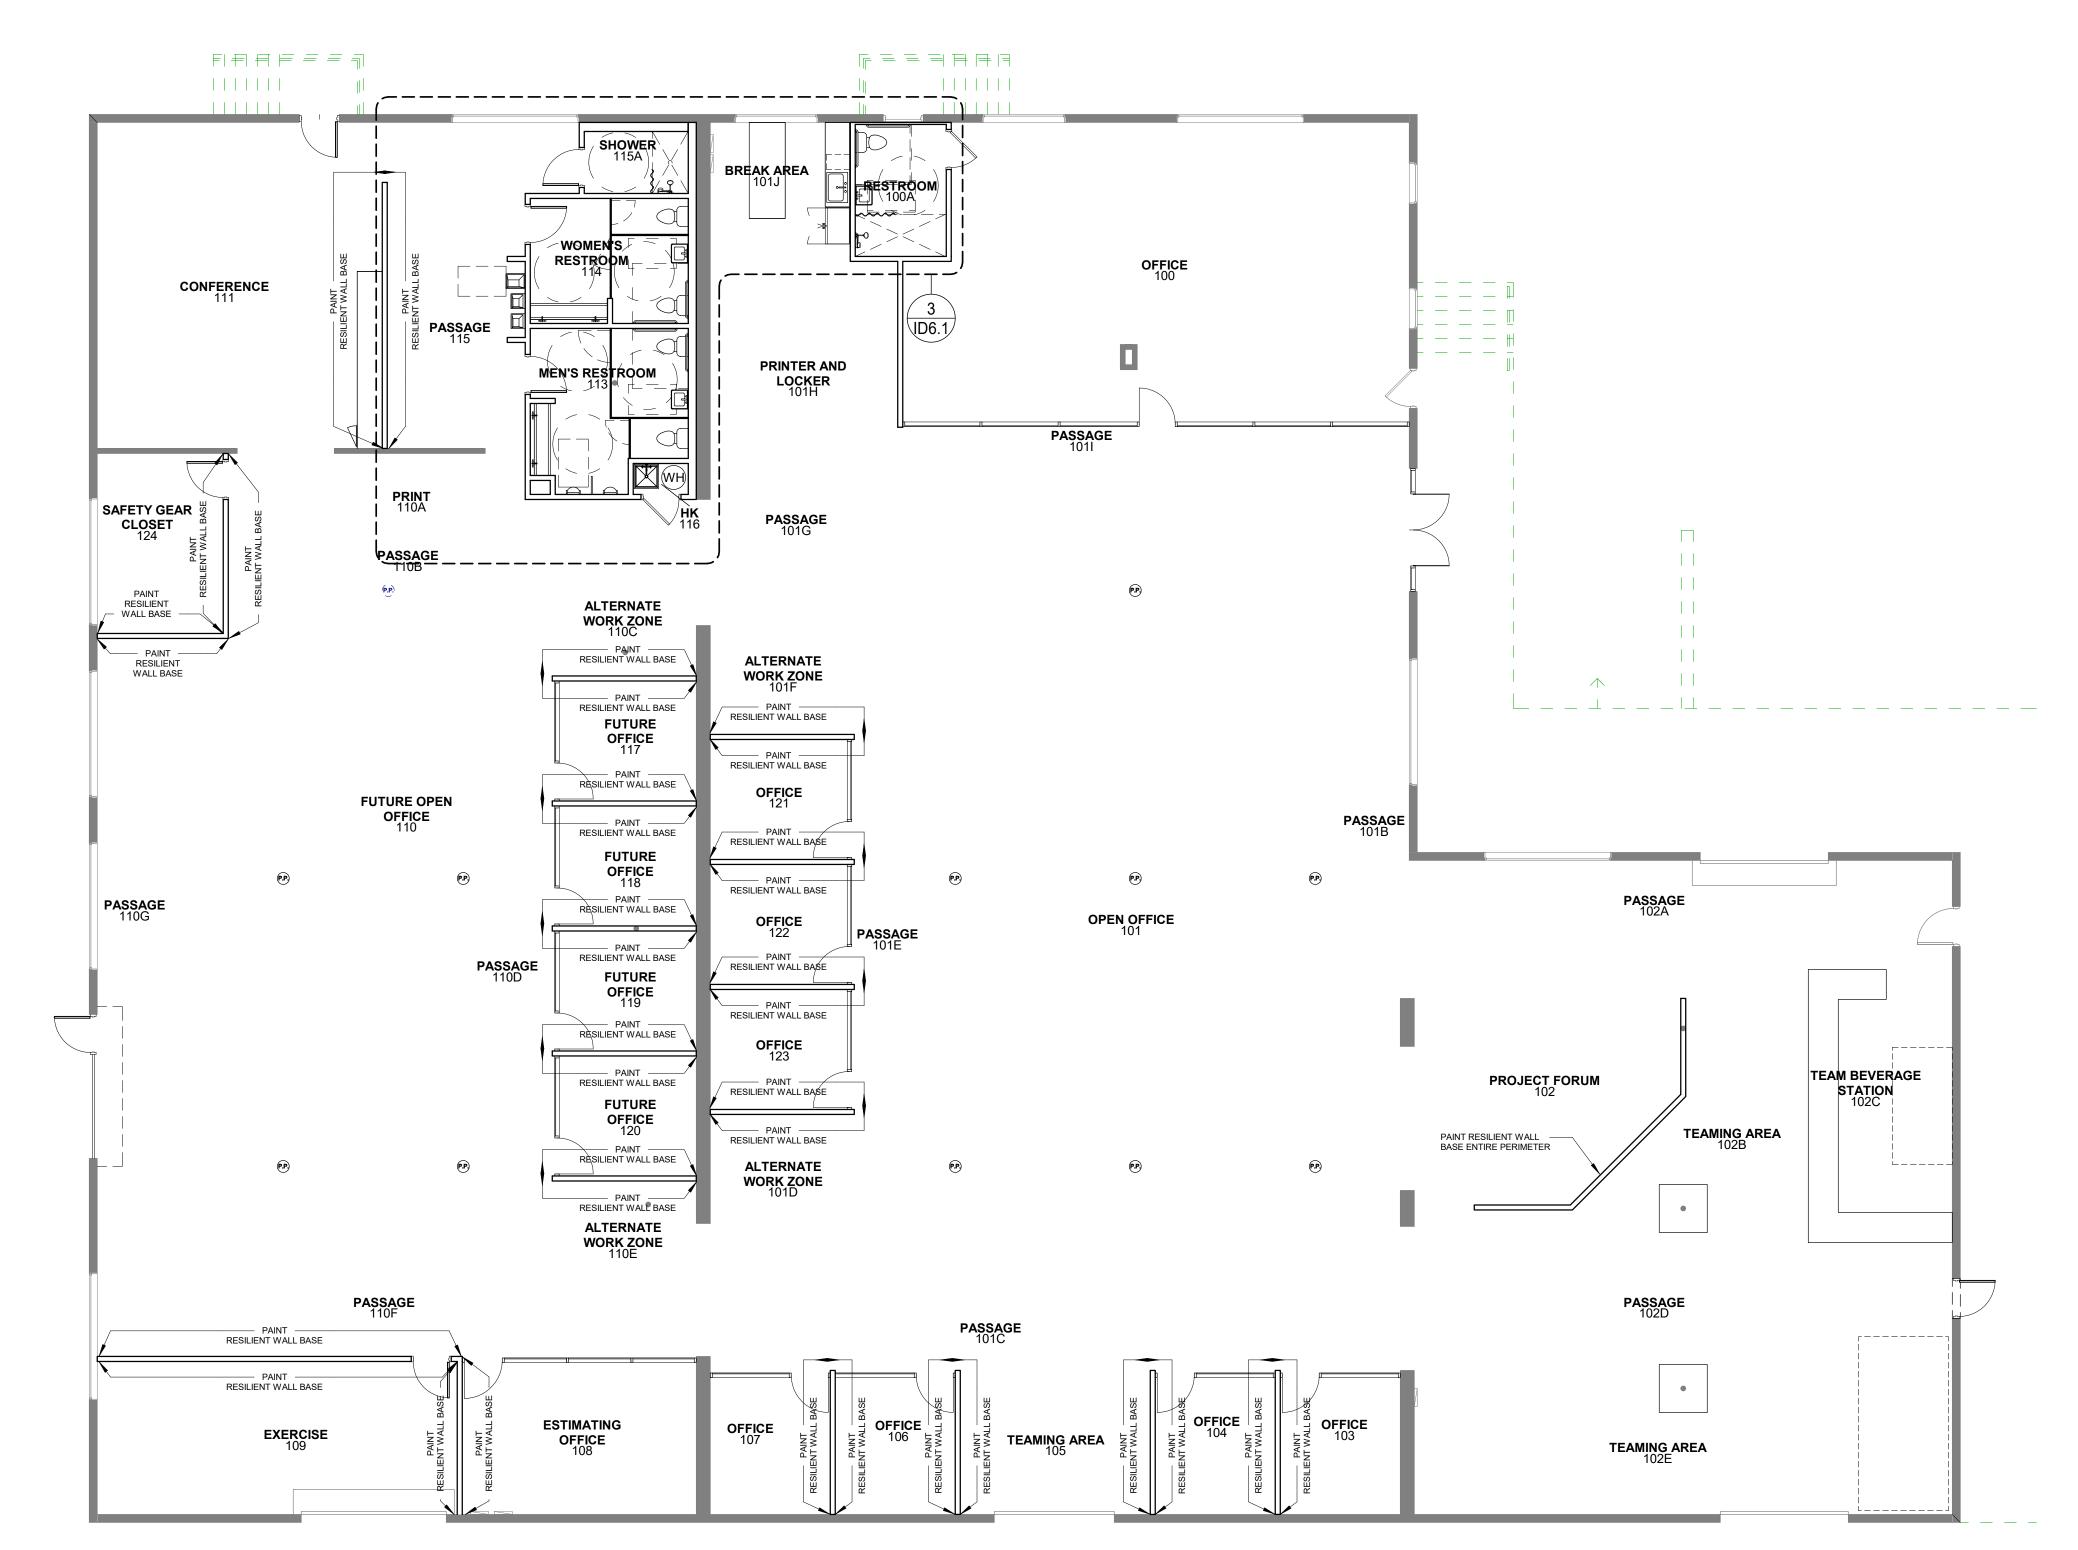

FINISH PLAN NOTES

MATERIALS TO BE SELECTED BY OWNER.

WITH OWNER.

OTHERWISE NOTED.

ABOVE DRAIN.

COATINGS.

ABOVE FINISHED FLOOR.

TO MEET AT CENTERLINE OF DOOR.

TO PROVIDE AN EVEN TRANSITION.

GENERIC FINISHES AND MATERIALS ARE NOTED FOR PRICING PURPOSES ONLY. ALL FINISHES AND

CONTRACTOR TO COORDINATE SELECTIONS DIRECTLY

INTERIOR DESIGNER DOES NOT TAKE RESPONSIBILITY

FOR FINISHES AND MATERIALS SELECTED BY OWNER.

DO NOT PROVIDE NEW FINISHES FOR BUILDING
ELEMENTS THAT ARE EXISTING TO REMAIN, UNLESS

WALLS IN RESTROOMS TO RECEIVE SMOOTH, HARD,

NONABSORBENT MATERIALS TO A MINIMUM OF 48"

ANY LOCATION WHERE TWO FLOORING FINISHES COME TOGETHER IN A DOORWAY, EXTEND FLOORING

WALLS IN SHOWERS TO RECEIVE SMOOTH, HARD, NONABSORBENT MATERIALS TO A MINIMUM OF 72"

VERIFY CONDITIONS PRIOR TO INSTALLATION OF

FOR TRANSITIONS OF DIFFERENT THICKNESS, USE

USE APPROPRIATE FLAME AND SMOKE CODES AND STANDARDS RATING REQUIREMENTS FOR FINISHES.

USE LOCAL VOC REQUIREMENTS FOR PAINTINGS AND

MATERIAL QUANTITIES REQUIRED FOR INSTALLATION.

ALL FINISH MATERIALS MUST BE FIELD VERIFIED BY

SURFACES AFTER INSTALLATION; REMAIN IN PLACE

INSTALLATION OF FINISHES AND MATERIALS PER

BE INSTALLED IN LENGTHS AS LONG AS FEASIBLE

WITHOUT GAPS AT SEAMS. TOP OF BASE TO ALIGN

BASE, UNLESS OTHERWISE NOTED. ALL WALL BASE TO

9. PRIOR TO FLOORING INSTALLATION ,TEST CONCRETE

11. THE CONTRACTOR IS RESPONSIBLE FOR ALL FINISH

ALL CONSTRUCTION TRAFFIC PATTERNS TO BE IMMEDIATELY PROTECTED ON ALL FLOORING

THE CONTRACTOR FOR ACCURACY.

13. ALL SUBSTRATES TO BE PREPARED PRIOR TO

MANUFACTURERS RECOMMENDATION.

14. PROVIDE CONTINUOUS ROLLS OF RESILIENT WALL

UNTIL FINAL CLEANING.

WITH ADJACENT PIECE.

SLAB FOR MOISTURE CONTENT BASED ON

MANUFACTURERS RECOMMENDATIONS.

FLOOR LEVELING TRANSITION MATERIAL AND FEATHER

STUDIO1019, LLC | IB26001903 (407)-864-1885 becca@studio1019.com


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KR MECHANICAL **NEW OFFICE**

2672 PHYLLIS STREET JACKSONVILLE, FL 32206

CONTACT RAYMOND CHIN & KERRY MOWLAM

REVISIONS

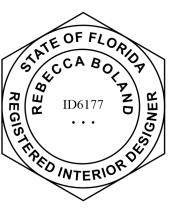

PROJECT NUMBER:

DATE ISSUED: DRAWN BY: PROJECT STATUS:

PERMIT AND PRICING

KR MECH 1

10/22/2021

B. BOLAND

PLANS

FINISH PLAN

1 FINISH PLAN | 1/8" = 1'-0"

- - - + TV BY OWNER -_ _ _ " PRINTER AND LOCKER 101H MEN'S RESTROOM PASSAGE 101l **SAFETY GEAR** (p,p) **ALTERNATE** WORK ZONE 110C **ALTERNATE** ┖╫═╶═╶╒╶╒╶╒╶═╶╒╶╒╶ FUTURE OFFICE 117 L _ _ _ _ _ _ -------FUTURE OFFICE 118 igsel wall MTD. BICYCLE RACK BY OWNER PA **FUTURE OPEN** FUTURE OFFICE 119 PROJECT FORUM 102 TEAM BEVERAGE AND TAPS FUTURE OFFICE 120 **ALTERNATE** WORK ZONE 110E **ESTIMATING** PASSAGE 102D PASSAGE 101C PLAN TABLE EXERCISE 109 TEAM GAMES (PINBALL, GALAGA, DARTS, ETC.)

FURNITURE PLAN NOTES

FURNITURE PLAN PROVIDED FOR REFERENCE ONLY. LAYOUT IS BASED ON OWNER'S EXISTING FURNITURE WITH TEST-FIT FOR FUTURE GROWTH.

1 FURNITURE PLAN ID7.1 1/8" = 1'-0"



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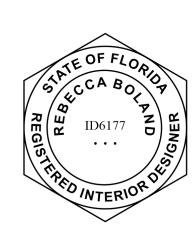
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FURNITURE PLAN

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