DESIGN NOTES:

This is to certify that the following project has been designed in accordance with the 2018 $\ensuremath{\mathsf{IBC}}$

= 2018 IBC

for the following loads and deflections:

COMMON DATA:

Building Code
Building Occupancy
Wind Speed, Vult
Wind Speed, Vasd

= || Normal = 105.00 mph = 81.33 mph = 5.0000 psf = 3.5000 psf = 1.0000 Ground Snow, Pg Roof Snow, Pf Importance

Seismic Design Category Importance Site Class Analysis Procedure

= A = 1.0000 = d = Equivalent Lateral Force

			PROJECT [DIMENSIONS		
PRO	DJECT: WIDTH	(ft) LENGTH	(ft) HEIGHT (ft)) PITCH	POROSITY & Cpi	
A	68	62	21	2.0:12	Closed $-(0.18/-0.18)$	
В	80	150	24	2.0:12	Closed - $(0.18/-0.18)$	

/	PROJEC ⁻	LOADING	(Building	Specific)		
PROJECT:	DEAD (psf)	LIVE (psf)	Coll. (psf)	SNOW (psf)	SNOW DRIFT	
Α	3.00	20.00	0.50	3.5000	47.36 psf and 12.93	ft
В	2.00	20.00	0.50	3.5000		

_		SEISMIC VALUES										
	PROJECT	Ss	S1	Sds	Sd1	Cs (long.)	Cs (trans)	Long. SFRS	Trans. SFRS	R_long	R_trans	
Α		0.1423	0.0354	0.1515	0.0560	0.051	0.051	OSMF	OSCBF	3	3	
В		0.1423	0.0354	0.1515	0.0560	0.051	0.051	OSMF	OSMF	3	3	

SIBUILD IT WITH STEEL STEEL BUILD IT TO LAST	

STEEL COMPONENTS, INC.

430 US Hwy 180 West Seminole, TX 79360 (432) 758-9900 (432) 758-9903 (fax)

	Drawing Status:
	FOR APPROVAL: THESE DRAWINGS, BY DEFINITION, ARE NOT FINAL, AND ARE FOR CONCEPTUAL USE ONLY. THEIR PURPOSE IS TO CONFIRM PROPER INTERPRETATION OF PROJECT DOCUMENTS, ONLY DRAWINGS ISSUED "FOR CONSTRUCTION" CAN BE CONSIDERED COMPLETE.
	FOR PERMIT: THESE DRAWINGS, ARE FOR PERMIT USE ONLY, AND AS SUCH, PIECE MARKS MAY NOT BE IDENTIFIED. ONLY DRAWINGS LABELED "FOR CONSTRUCTION" CAN BE CONSIDERED COMPLETE.
X	FOR CONSTRUCTION: FINAL DRAWINGS.

	DRAWING INDEX		
PAGE ID	DESCRIPTION		
C1 of 2	Drawing Cover		
C2 of 2	General Notes		
E1 – E5	Anchor Bolt Plan/Details		
E6 - E7	Roof Framing/Sheeting		
E8 - E11	Endwall Framing/Sheeting		
E12 - E18	Sidewall Framing/Sheeting		
E19 — E34	Rigid Frame Drawings		
E35 — E35	Partition Walls Crane Drawings		
E36 — E37			
E38 — E39	Mezzanine Drawings		
	Jack Beams		
E40 - E43	Wall/Roof Insulation		
E44 - E44	Wall/Roof Liner Panels		
E45 - E49	Wind Brace		
E50 - E51	Details		

BUILDING COLORS				
ROOF	Polar White			
WALL	Polar White			
EAVE	Black			
RAKE	Black			
JAMB	Black			
CORNER	Black			
BASE	Black			
GUTTER				

PANELS/INS	ULATION	
Roof Panels: PBR		
Roof Insulation: VR	Thick. 3	in.
Wall Panels: PBR		
Wall Insulation: VR	Thick. 3	in.

DEFLECTION	N LIMITS
EW COLUMN	H/180
EW RAFTER	L/180
GIRT (live)	L/90
PURLIN (live)	L/180
PANEL (live)	L/60
FRAME COLUMN	H/60
FRAME RAFTER	L/180

BUILDING COLORS		
ROOF	Polar White	
WALL	Polar White	
EAVE	Black	
RAKE	Black	
JAMB	Black	
CORNER	Black	
BASE	Black	
GUTTER	-	

			F
SALE	S PERSON: I	ВПВВУ	F
			,
			,
RFV	DATE	REVISION	

PURCHASER:

PROJECT:

JOB NUMBER:

ADDITIONAL NOTES:

JOB ADDRESS:

ODESSA, TX 79763

MADISON

PB50637

Sheet No. C1 of 2

	SALE	S PERSON: 1	ВПВВУ
	\triangle		
F-24823			
SEALED 01/17/2024	REV.	DATE	REVISION

General Notes

This drawing, and all information contained within, remains the property of JNL Steel. The building shall be erected using members called out in this drawing.

In the event that the design changes, it is the responsibility of the contractor to ensure that a stamped letter from the sealing engineer is provided, giving the approval.

3000 psi concrete is assumed for all calculations involving concrete strength.

Anchor Bolts

The anchor bolt diameters are determined in accordance with AISC using A307 anchors. Anchor bolt lengths are to be determined by a foundation engineer, and as such, cannot be provided with the building. It is the responsibility of the erector to purchase anchor bolts separately and no liability will be placed on JNL Steel or the stamping engineer for incorrect anchor bolt lengths.

Field Work

Minimal field work is expected with erecting metal buildings. If a customer does not tell JNL where to place an opening, we will "field locate" the building and it is the erectors responsibility to drill holes in the girt and place the opening. All field welding should be done by a certified welder in accordance with AWS D1.1.

Structural Bolts

Bolts not subject to tension or vibration loads should only be snug tightened. Bolts in slotted connections should be hand tightened with the thread damaged afterwards to prevent nut from backing out. This allows for vertical deflection of the connecting member. ASTM A307 bolts are used for girt to frame, purlin to frame, and all flange bracing connections unless noted. ASTM A325 are used everywhere else unless noted. Threads are assumed in the shear plane.

Material Delivery

JNL will attempt to deliver the building on an agreed upon date. Sometimes, through un-forseen events, this cannot be possible. JNL does not accept responsibility for costs associated with the customer renting personnel or equipment to unload the truck. Responsibility to unload the truck is placed on the customer, unless specifically stated in the contract.

Approval Drawings

Approval drawings are meant to show the erector general building geometry, framed opening locations, and clearances. If member sizes appear on drawings, they are not supposed to be taken as true size. Customer shall sign all pages of the approval drawings and return to JNL before building gets sent to stamping engineer. To ensure current pricing, approval drawings will need to be signed within (2) weeks of issue.

Contracts

Customer should review the contract thoroughly and make sure everything is clear and accounted for. Customer is responsible for supplying JNL with the appropriate design code. In the event that such data is not made available, customer should call the local building official. JNL or the stamping engineer will not be held liable for incorrect building codes. Building will not get sent to stamping engineer without a signed contract. Verbal confirmation over email, phone, or in-person will not be accepted.

Material Specifications

Hot Rolled: A992 Gr. 50
HSS: ASTM A500 Gr. 46
Built up Webs: A36
Built up Florges: A520 Gr.

Built up Flanges: A529 Gr. 55 Cold Formed: ASTM A1011 Gr. 55

Diagonal Rod brace yield stress is 36 ksi

Bracing: Steel cable is extra high strength per ASTM A475

Bolts: Primary member bolts conform to ASTM A325(U.N.) Secondary member bolts conform to ASTM A307 (U.N.)

Material Storage

Panels should be placed off the ground and slopped enough to provide good drainage. Board should be placed at close enough intervals to prevent the panels from sagging and resulting in water accumulation. Galvanized, and colored materials are subject to corrosion and discoloration if stored improperly.

Bracing

Bracing is an integral part of the building system. All bracing should be installed taut and free of slack. Walls utilizing panel shear should have temporary bracing until all panels are installed. During erection, contractor should install temporary bracing to provide stability, and help square the building. Do not remove bracing due to "inconvenience". If bracing needs to be moved/removed, contact a licensed professional for approval.



432-758-9900 430 US HWY 180 W SEMINDLE,TX 79360

CUSTOMER INFO

PROJECT

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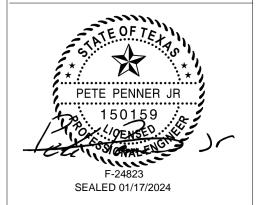
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General Notes

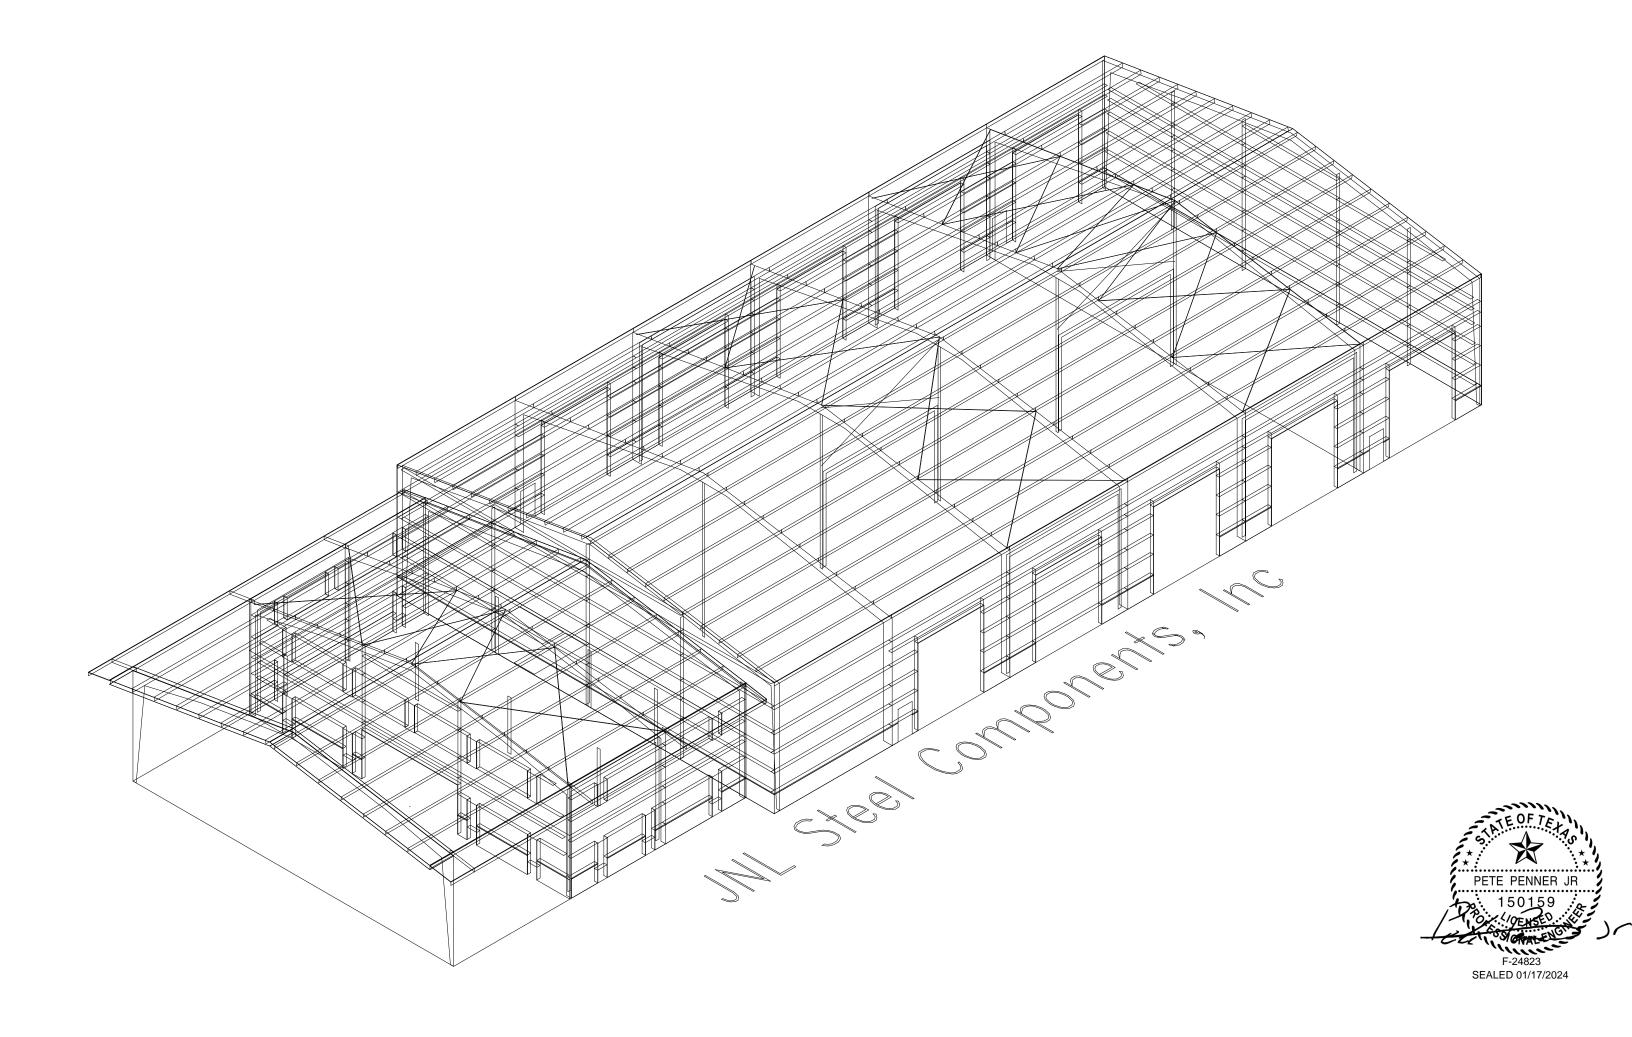
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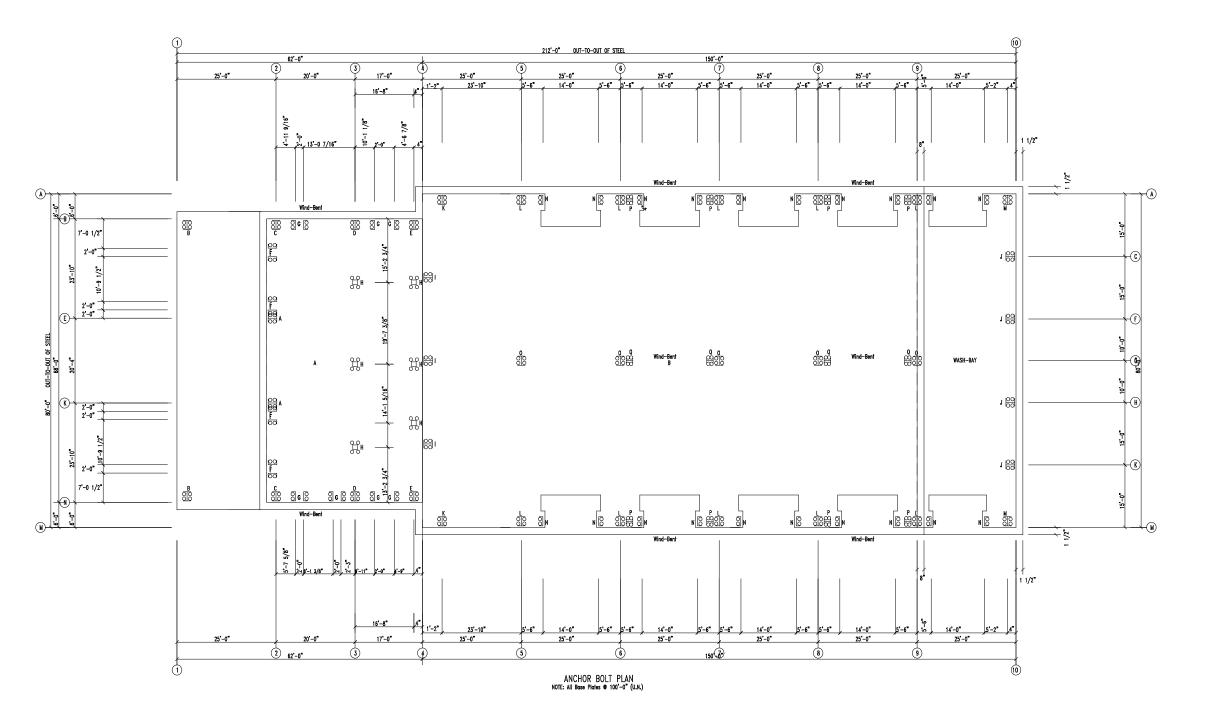
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C2 of 2 -- NTS

REVISIONS
ND. NOTES
BY DATE
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ALL COLUMNS TO BE AT FINISH FLOOR HEIGHT





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SHEET NAME/TITLE ANCHOR BOLT PLAN

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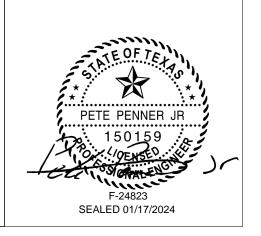
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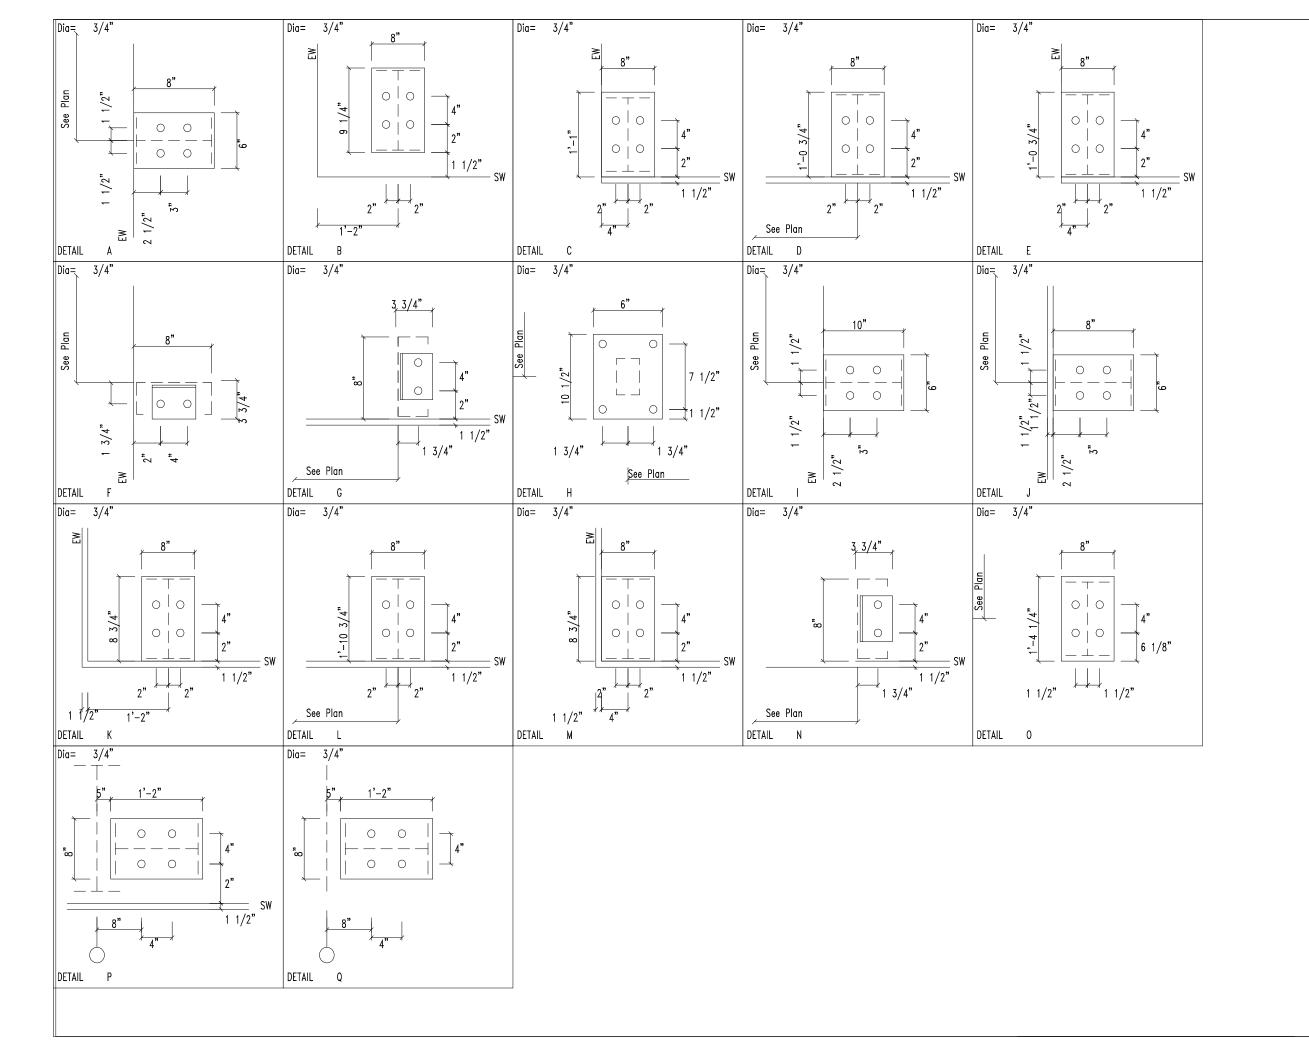
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SHEET NAME/TITLE
ANCHOR BOLT DETAILS

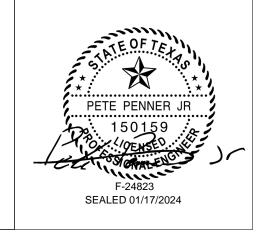
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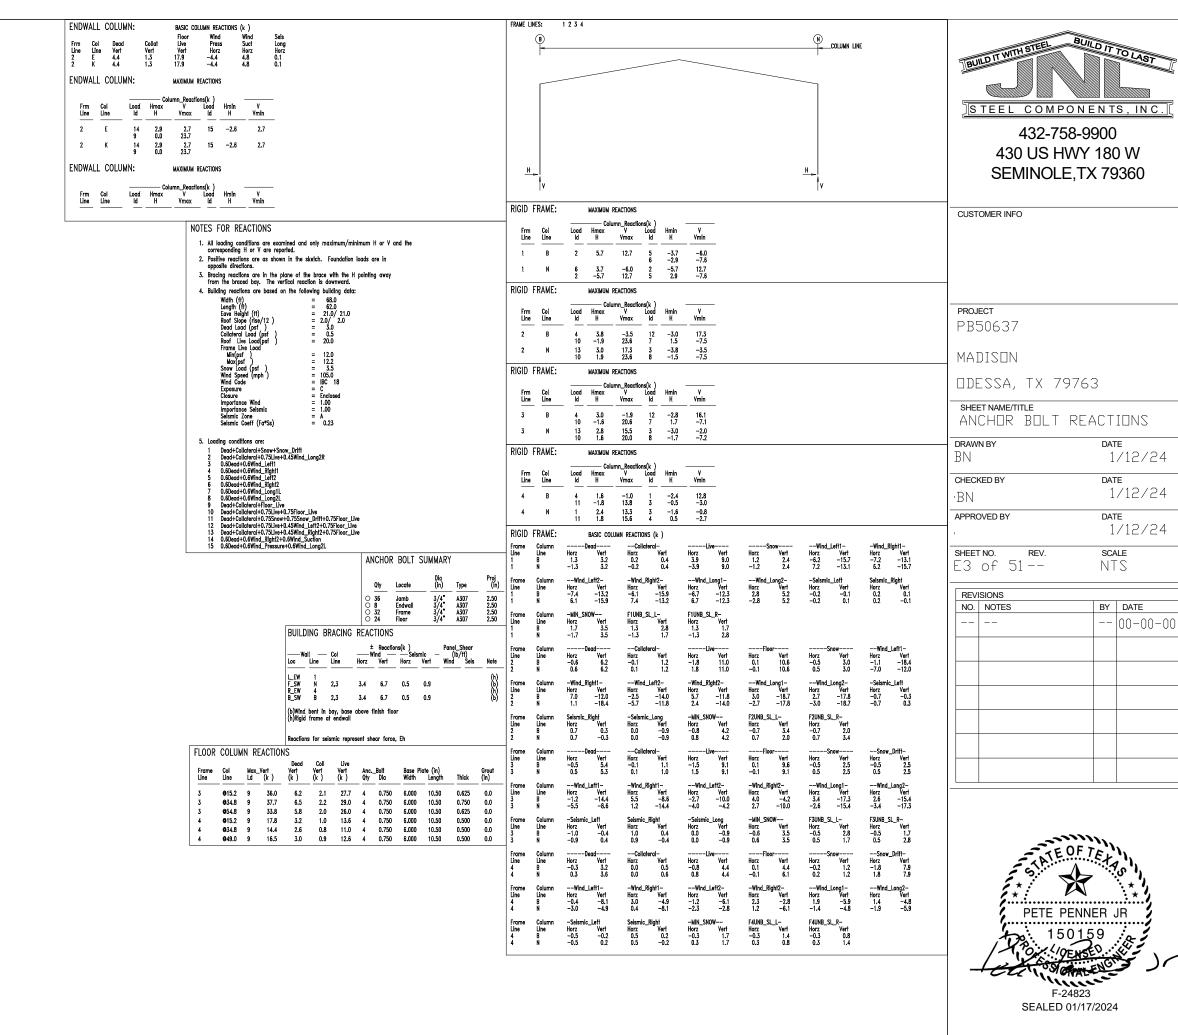
BN 1/12/24

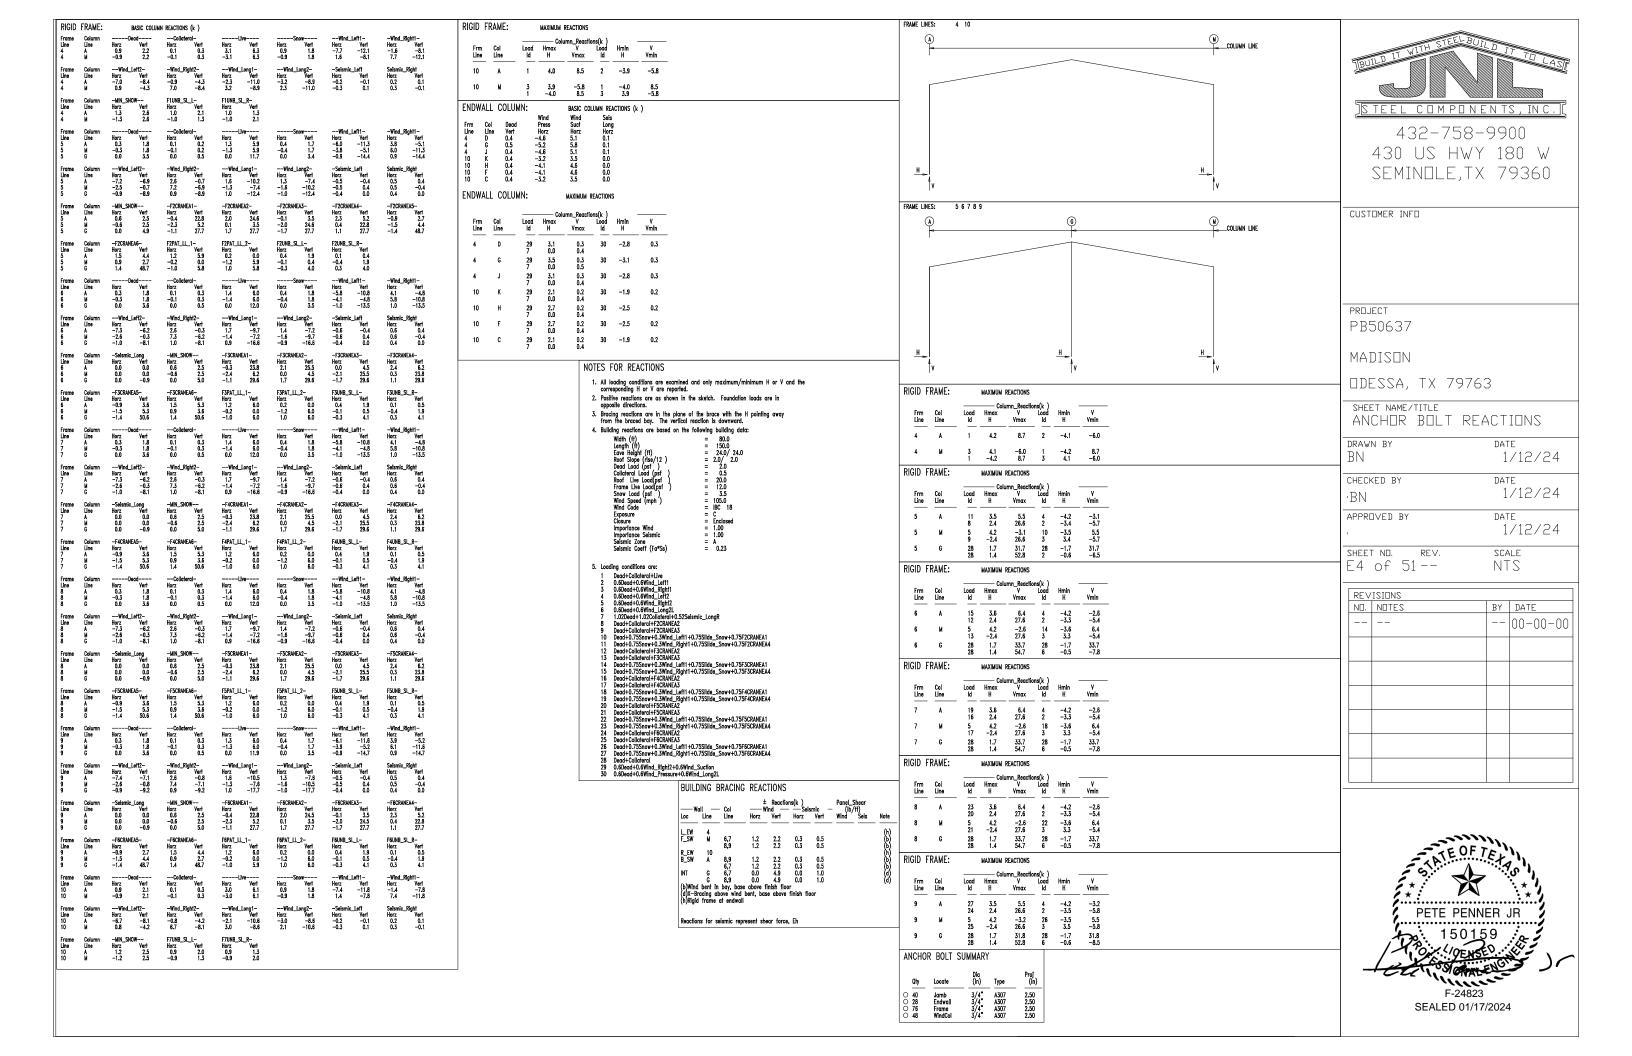
APPROVED BY DATE 1/12/24

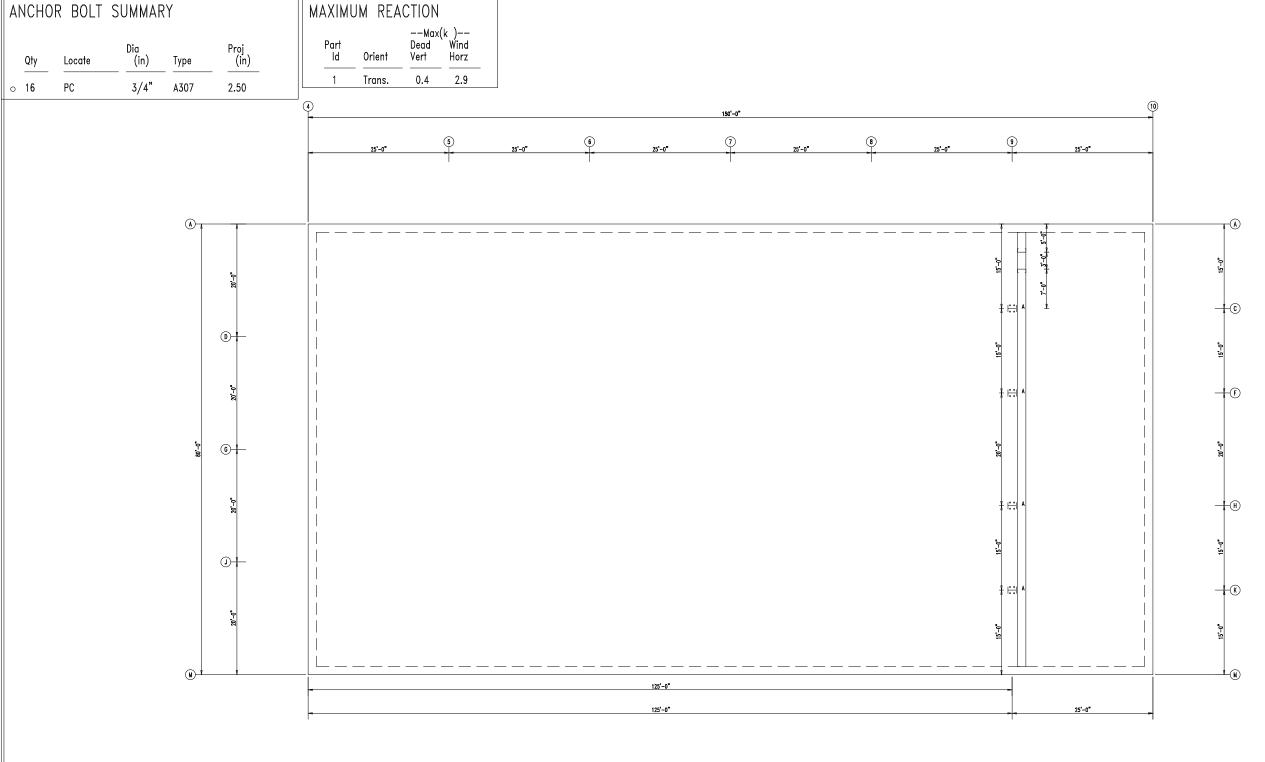
SHEET NO. REV. SCALE E2 of 51 -- NTS

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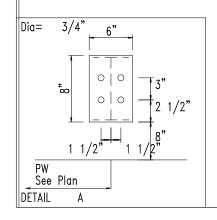














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SHEET NAME/TITLE KEY PLAN

DRAWN BY DATE
BN 1/11/24

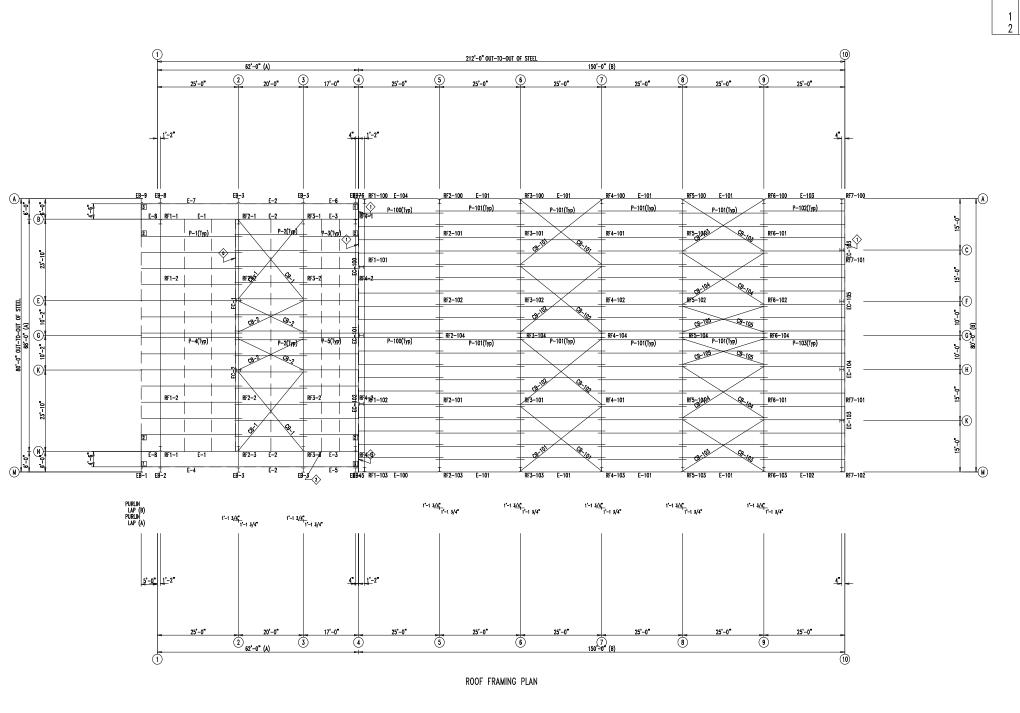
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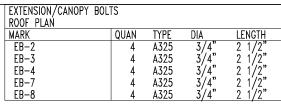
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 1/11/24

APPROVED BY DATE 1/11/24

SHEET NO. REV. SCALE E5 of 51 -- NTS







ANGLE TABLE					
ROOF	PLAN				
♦ID	MARK	LENGTH		DETAIL	
	L4X2	20'-0"		ANGLE_6	
1	L4X2	20'-0"			
2	TRFI G1	100'-0"			

INI LU I	100 0		_
MEMBER TA	BLE		OLICTOMED INCO
ROOF PLAN			CUSTOMER INFO
MARK	PART	LENGTH	
Α			
EB-1	8X25C14	8'-10 7/16"	
EB-2	W8X10	6'-2 1/8"	
EB-3	W8X10	6'-2 1/8"	
EB-4	W8X10	6'-2 1/8"	
EB-5	8X25CH14	8'-10 1/2"	PROJECT
EB-6	8X25CH14	8'-10 1/2"	
EB-7	W8X10	6'-2 1/8"	PB50637
EB-8	W8X10	6'-2 1/8"	
EB-9	8X25C14	8'-10 7/16"	MADISON
P-1	8X25Z14	31'-1 1/2"	
P-2	8X25Z14	22'-3 1/2"	
P-3	8X25Z14	18'-1 1/2"	DESSA, I
P-4	8X25Z14	31'-1 1/2"	SHEET NAME/TITLE
P-5	8X25Z14	18'-1 1/2"	· ·
E-1	E085322L	23'-1 1/4"	ROOF FRA
E-2	E085342L	19'-3 1/4"	
E-3	E085342L	15'-11 1/4"	DRAWN BY
E-4	E085342L	29'-7 3/8"	BN
E-5	E085342L	16'-7 3/8"	CHECKED BY
E-6	E085342L	16'-7 3′/8"	
E-7	E085342L	29'-7 3/8"	'BN
E-8	E085322L	5'-5 5/8"	APPROVED BY
CB-1	CB0250	29'-10' 1/4"	ATTROVED BY
CB-2	CB0250	22'-4 1/2"	
B	07/05244	002 4 4 /02	SHEET NO. F
P-100	8X25Z14	26'-1 1/2"	E6 of 51-
P-101	8X25Z14	27'-3 1/2" 26'-1 1/2"	
P-102	8X25Z14	26'-1 1/2"	
P-103	8X25Z14	26'-1 1/2"	REVISIONS
E-100	E085342L	24'-11 1/2"	NO. NOTES
E-101	E085342L	24'-11 1/2"	
E-102	E085342L	24'-11 1/2"	
E-103	E085342L	24'-11 1/2"	
E-104	E085342L	24'-11 1/2"	
CB-101	CB0250	31'-7"	
CB-102	CB0250	31'-10 1/4"	
CB-103	CB0250	29'-5 1/4"	
CB-104	CB0250	29'-2,3/4"	
CB-105	CB0250	26'-7"	\dashv \mid

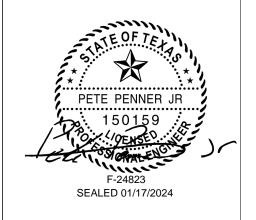
CONNECTION PLATES
ROOF PLAN
DID MARK/PART

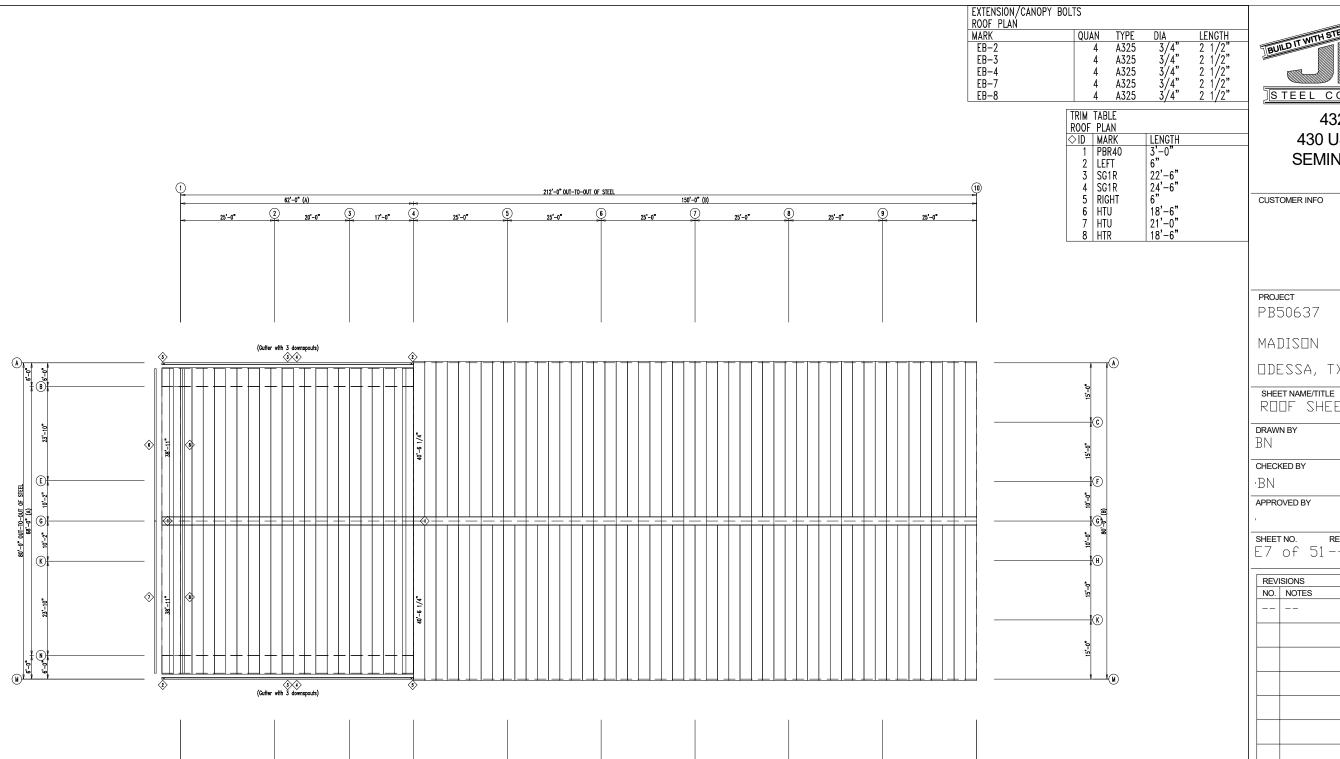
1 e1 2 d1 3 e2



432-758-9900 430 US HWY 180 W SEMINOLE,TX 79360

PROJ	ECT				
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	r no . of 51			sca NT	
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ROOF SHEETING PLAN PANELS: 26 Ga. PBR - Polar White

62'-0" (A)



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CUSTOMER INFO

PB50637

DDESSA, TX 79763

ROOF SHEETING

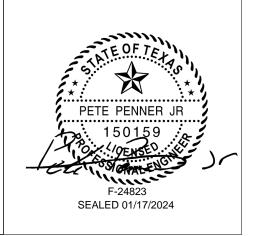
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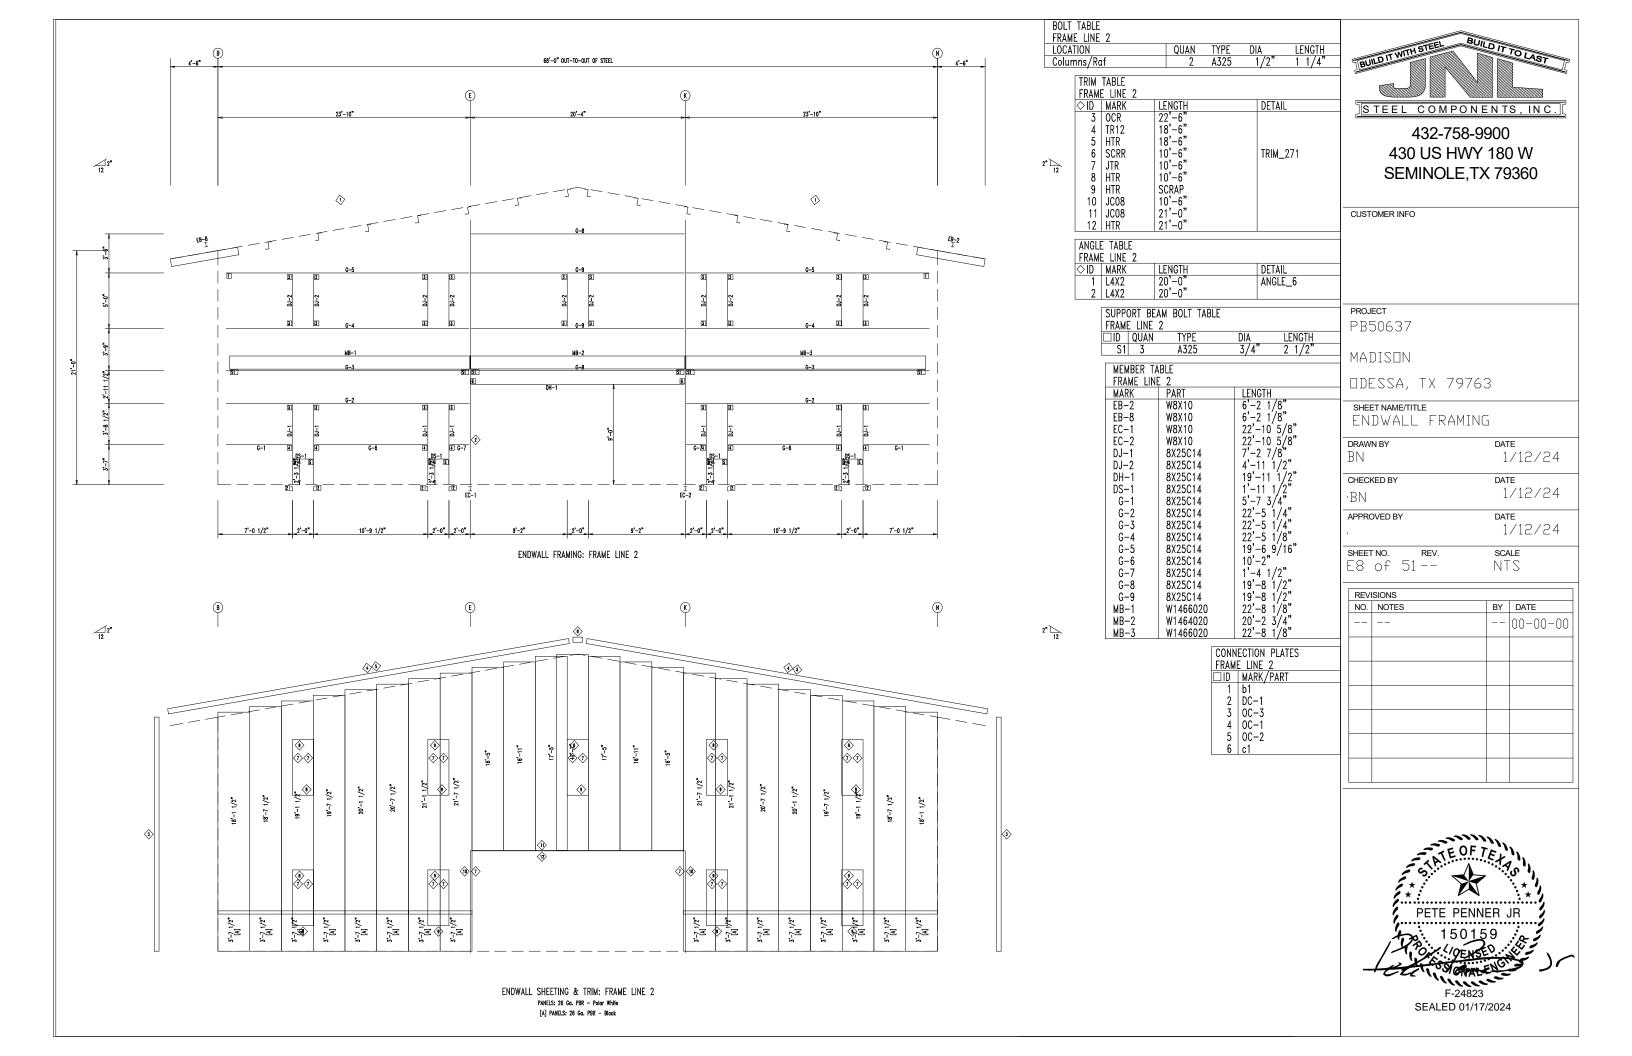
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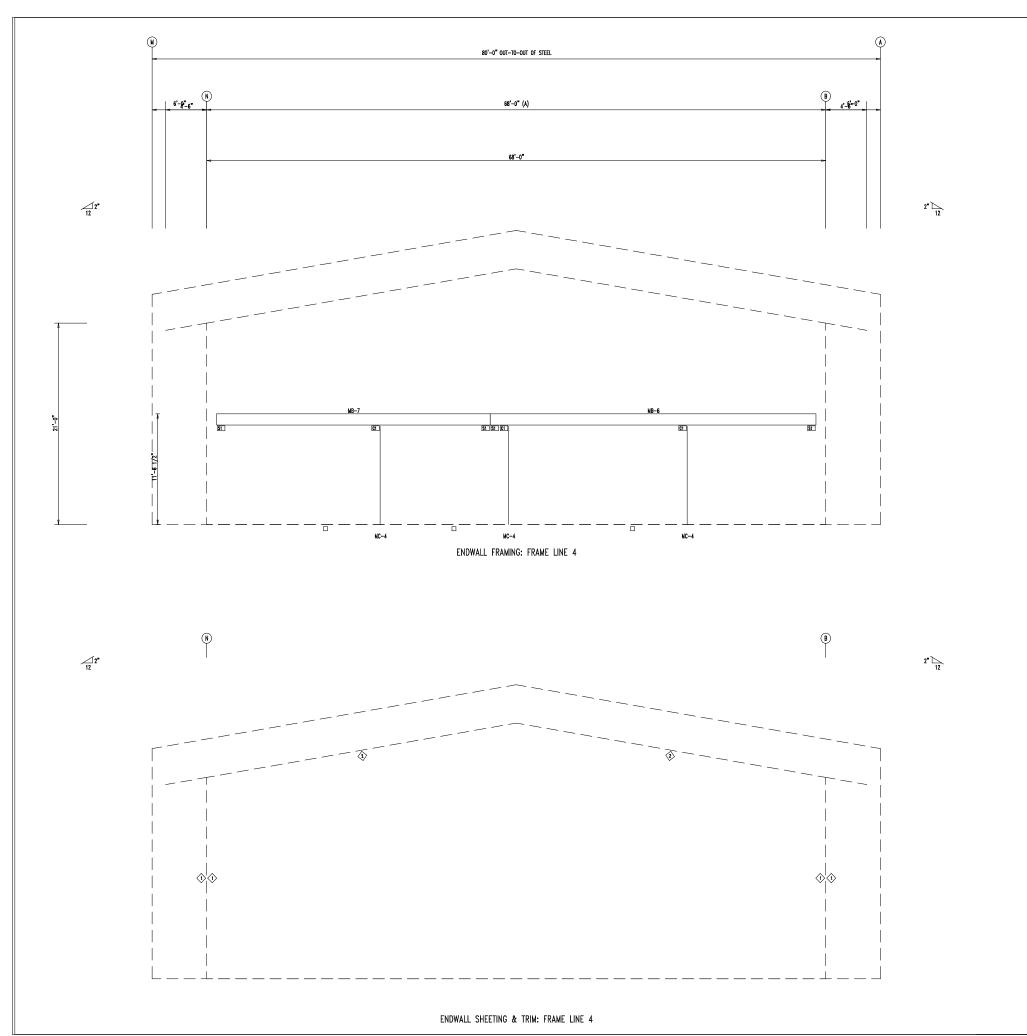
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SCALE E7 of 51--NTS

REVISIONS				
NO.	NOTES	BY	DATE	
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SUPF	ORT BEA	M BOLT TABLE		
FRAM	IE LINE 4	ļ		
□ID	QUAN	TYPE	DIA	LENGTH
S.	6	A325	3/4"	2 1/2"

COLUMN BOLT TABLE
FRAME LINE 4

ID QUAN TYPE
C1 4 A325

MEMBER TABLE FRAME LINE 4				
MARK	PART	LENGTH		
MB-6	W1464020	35'-9 3/8"		
MB-7	W1464020	30'-0 5/8"		
MC-4	T035035C	10'-4 1/2"		

		•
TRIM	TABLE	
	E LINE 4	
♦ID	MARK	LENGTH
1	ICR	21'-0"
2	SWTR	18'-6"



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CUSTOMER INFO

PROJECT

PB50637

MADISON

DDESSA, TX 79763

SHEET NAME/TITLE ENDWALL FRAMING

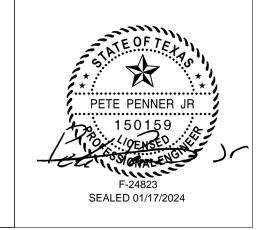
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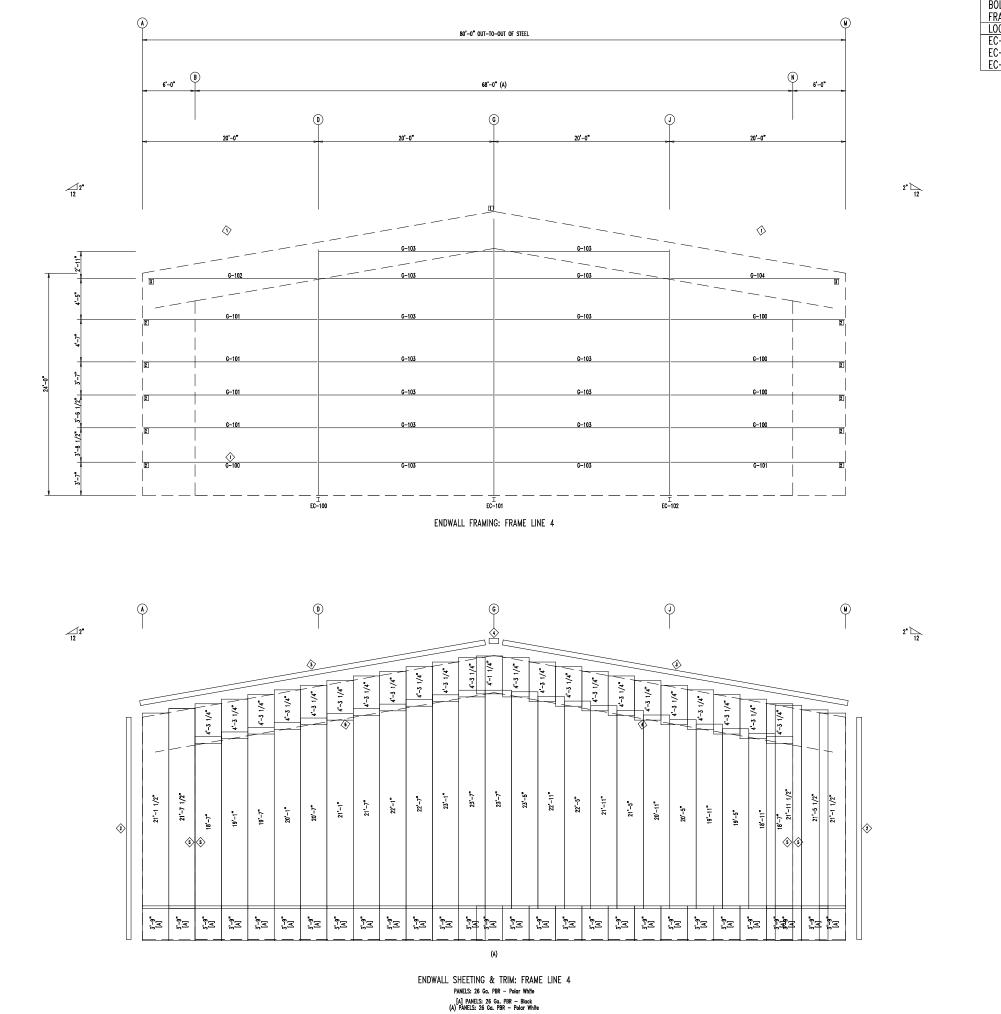
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SCALE SHEET NO. E9 of 51--NTS

NO.	SIONS NOTES	BY	DATE
			00-00-00





 BOLT TABLE

 FRAME LINE 4

 LOCATION
 QUAN TYPE
 DIA
 LENGTH

 EC-100/FRAME
 2 A325
 1/2" 1 1/4"

 EC-101/FRAME
 8 A325
 1/2" 1 1/4"

 EC-102/FRAME
 2 A325
 1/2" 1 1/4"

MEMBER TA	BLE	
FRAME LINE	₹ 4	
MARK	PART	LENGTH
EC-100	W1064030	26'-4 5/8"
EC-101	W1064030	29'-8 5/8"
EC-102	W1064030	26'-4 5/8"
G-100	8X25Z14	19'-8"
G-101	8X25Z14	19'-8"
G-102	8X25Z14	19'-0 1/16"
G-103	8X25Z14	19'-4 1/2"
G-104	8X25714	19'-0 1'/16"

		•
TRIM	TABLE	
FRAM	E LINE 4	
♦ID	MARK	LENGTH
2	OCR	24'-6"
3	SRR	21'-0"
4	PBA	2'-0"
5	ICR	21'-0"
6	SWTR	18'-6"

ANGLE	ETABLE	
FRAMI	E LINE 4	
⇒ID	MARK	LENGTH
1	L4X2	20'-0"

CONN	ECTION PLATES
FRAMI	E LINE 4
□ID	MARK/PART
1	n100
2	d101
3	d100



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CUSTOMER INFO

PROJECT PB50637

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ODESSA, TX 79763

SHEET NAME/TITLE ENDWALL FRAMING

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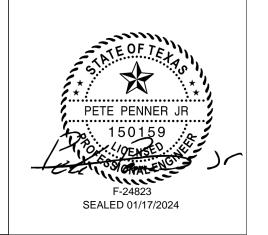
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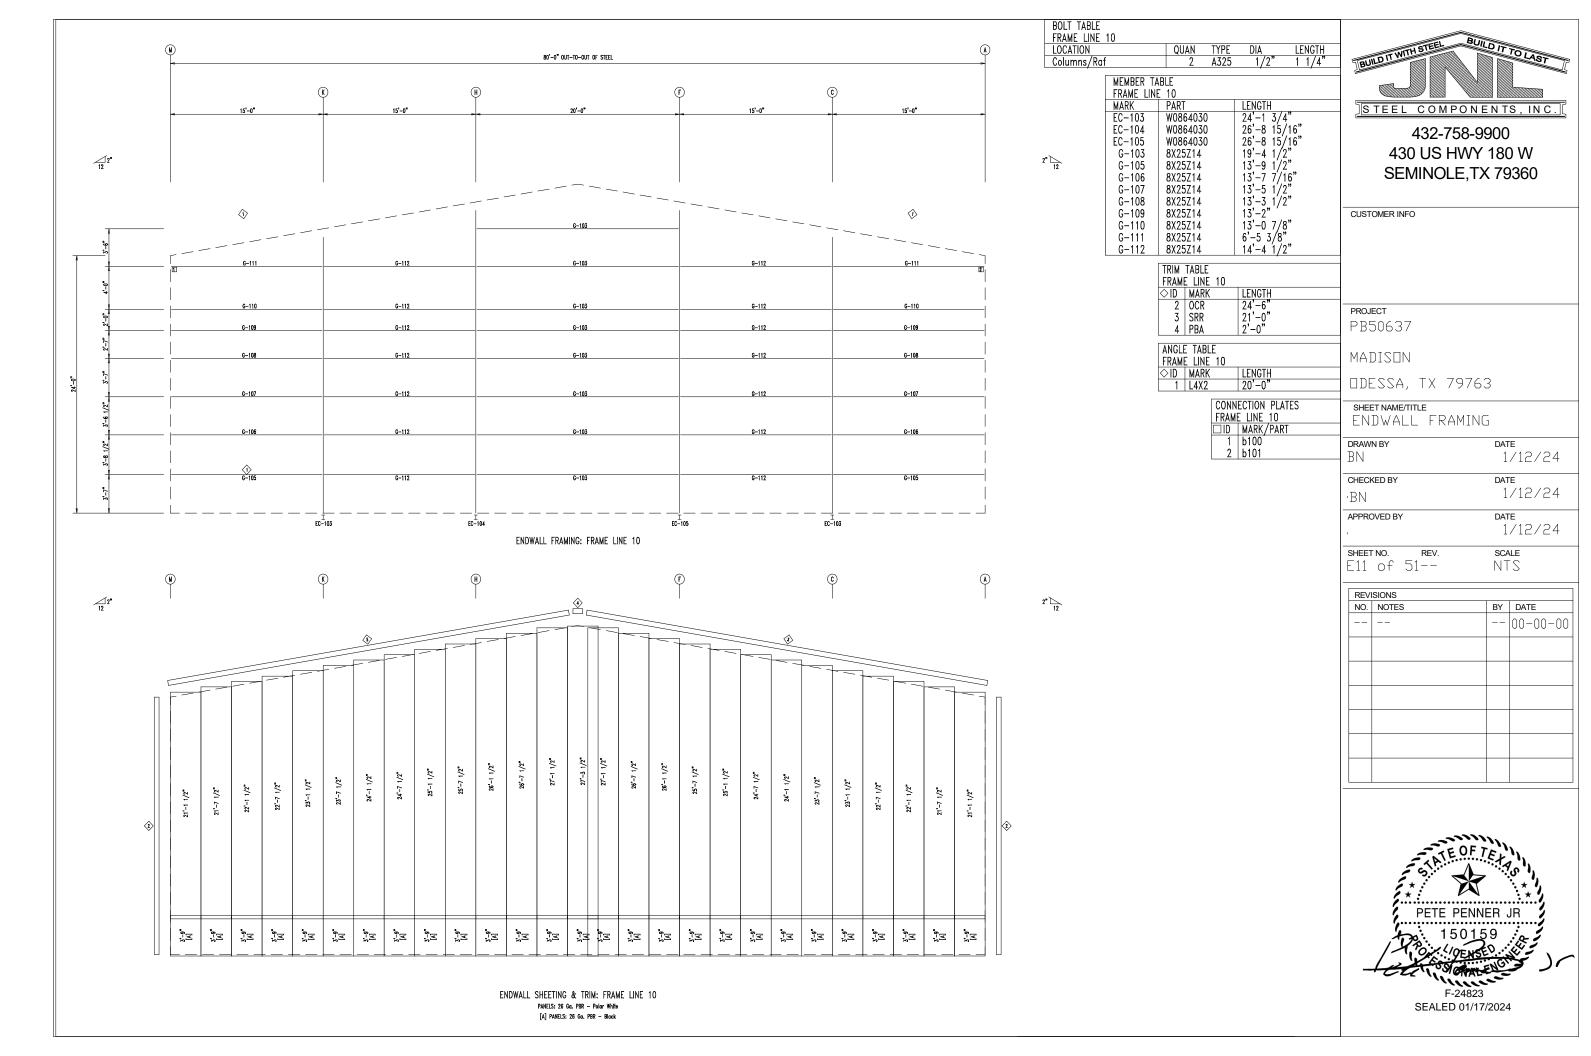
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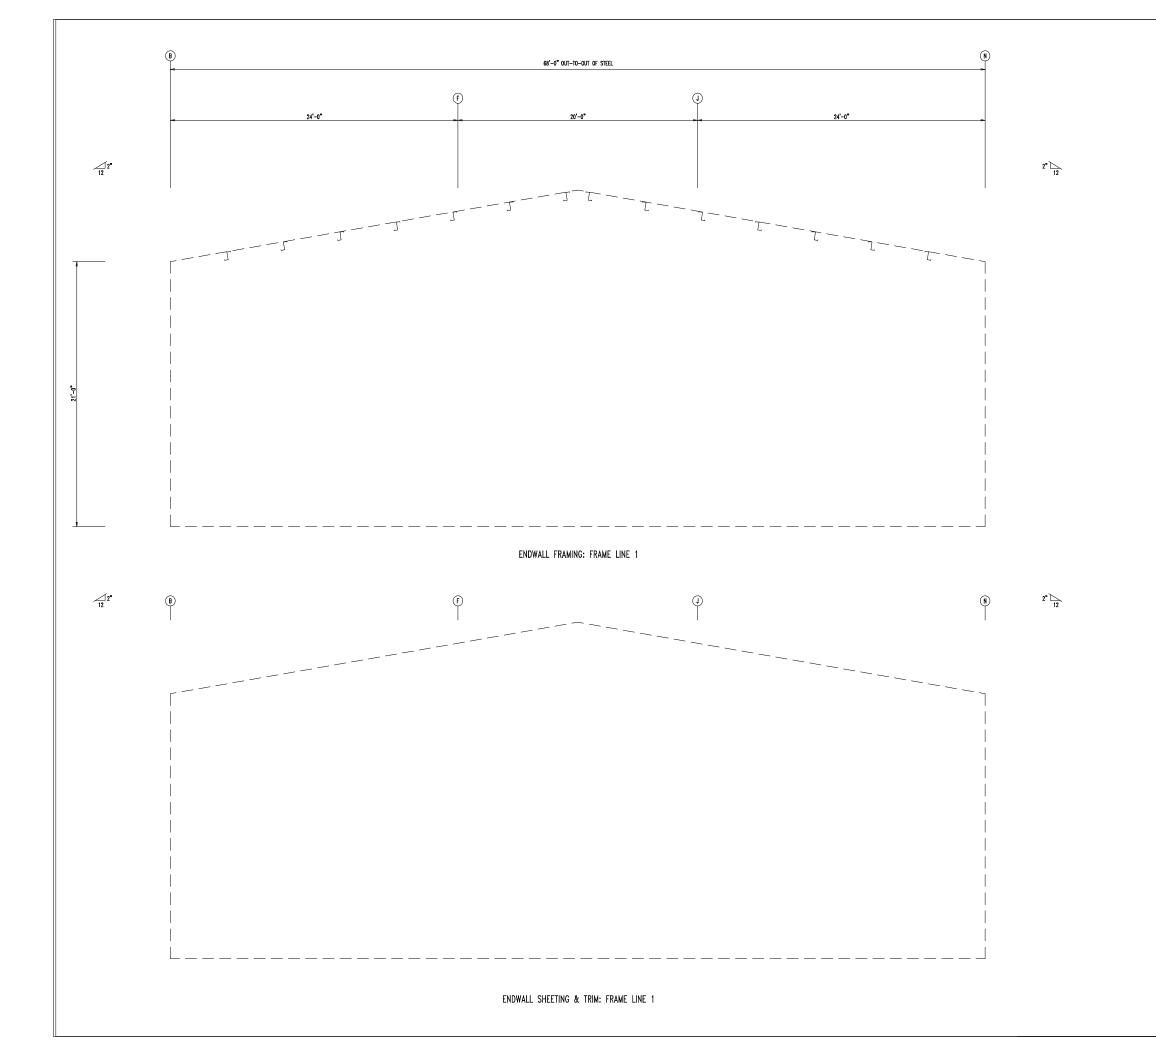
APPROVED BY DATE 1/12/24

SHEET NO. REV. SCALE E10 of 51-- NTS

NO.	NOTES	BY	,	DATE
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CUSTOMER INFO

PROJECT

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SHEET NAME/TITLE SIDEWALL FRAMING

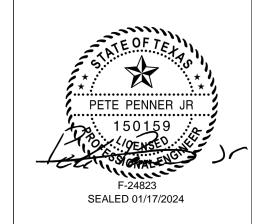
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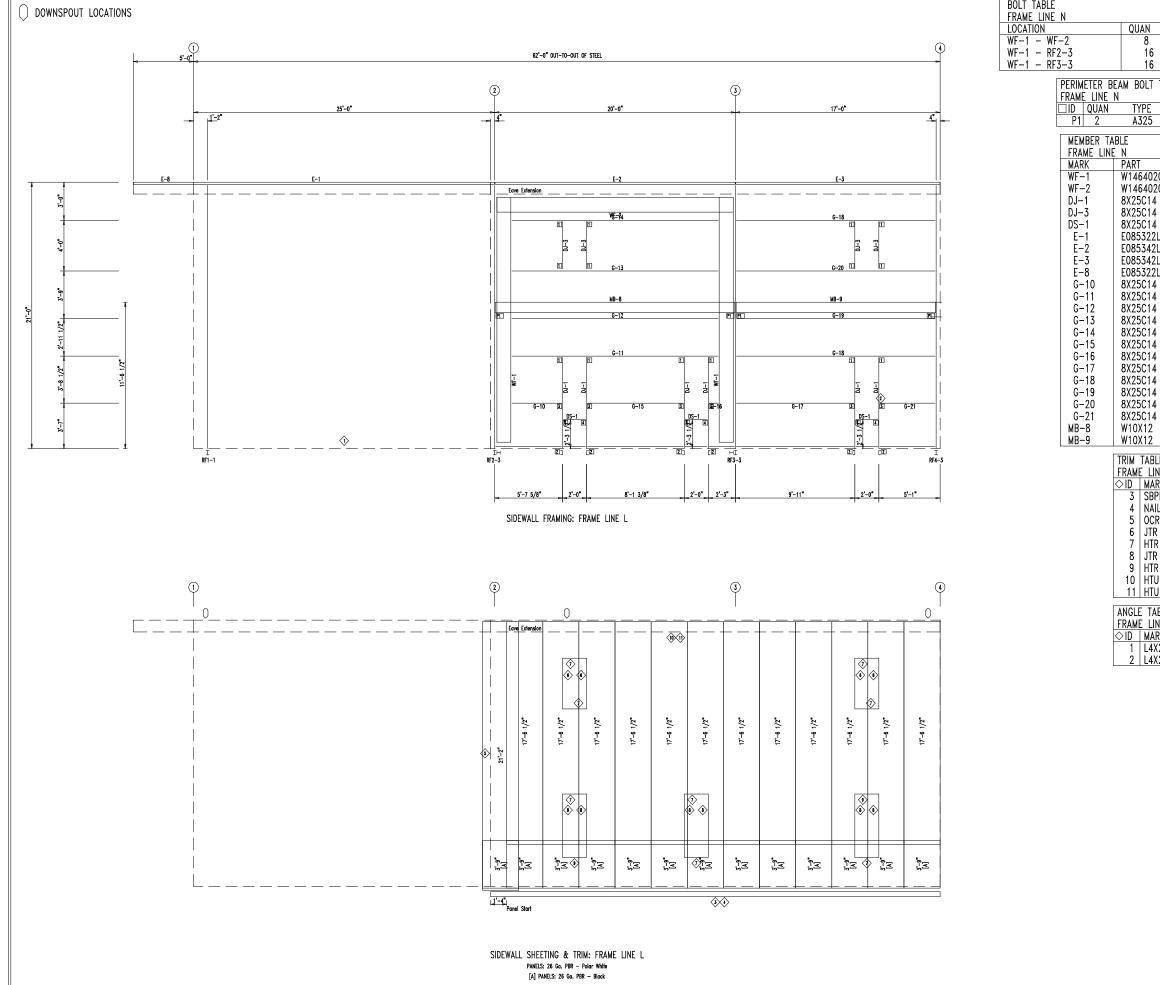
CHECKED BY DATE 1/12/24 ·BN

APPROVED BY DATE 1/12/24

SCALE E12 of 51--NTS

REVISIONS BY DATE NO. NOTES -- 00-00-00





BOLT TABLE UAN TYPE 8 A325 16 A325 16 A325 DIA 3/4" 5/8" 5/8"

PERIMETER BEAM BOLT TABLE 1 1/2'

LENGTH 19'-6" 17'-7 3/8" 7'-2 7/8" W1464020 W1464020 3'-11 1/2" 1'-11 1/2" 23'-1 1/4" E085322L 19'-3 1/4" 15'-11 1/4" 5'-5 5/8" 4'-1 9/16" E085342L E085342L E085322L 8X25C14

17'-7 3/8" 7'-5 7/8" 8 15/16" 9'-2'7/8" 15'-11 1/4" 15'-11 1/4" 15'-11 1/4" 4'-0 7/8" 19'-10 3/4" 16'-6 3/4"

TRIM TABLE FRAME LINE N ◇ID MARK 3 SBPR 4 NAIL I 22'-6" 5 OCR 6 JTR SCRAP 7 HTR SCRAP 8 JTR 10'-6' 9 HTR 10 HTU 11 HTU

ANGLE TABLE FRAME LINE N LENGTH SCRAP ◇ID MARK 1 L4X2 2 L4X2 20'-0'

CONNECTION PLATES FRAME LINE N 1 OC-3 2 DC-1 3 OC-1 4 OC-2



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CUSTOMER INFO

PROJECT PB50637

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DDESSA, TX 79763

SHEET NAME/TITLE SIDEWALL FRAMING

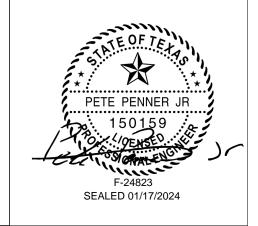
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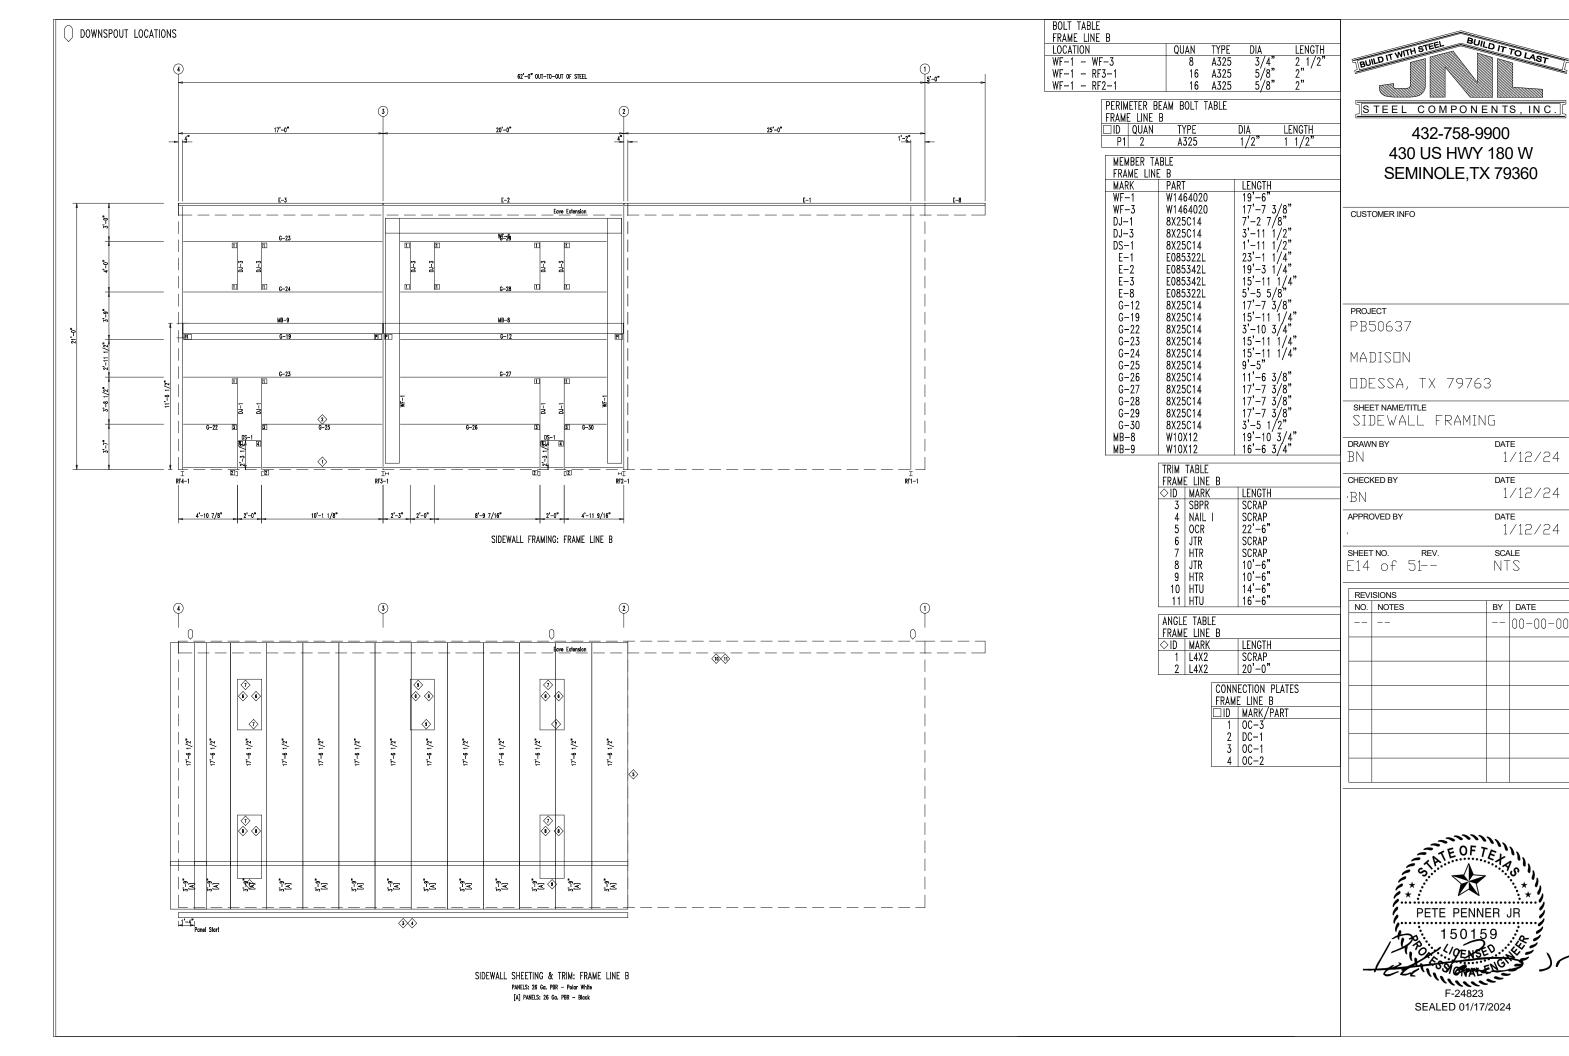
CHECKED BY DATE 1/12/24 ·BN

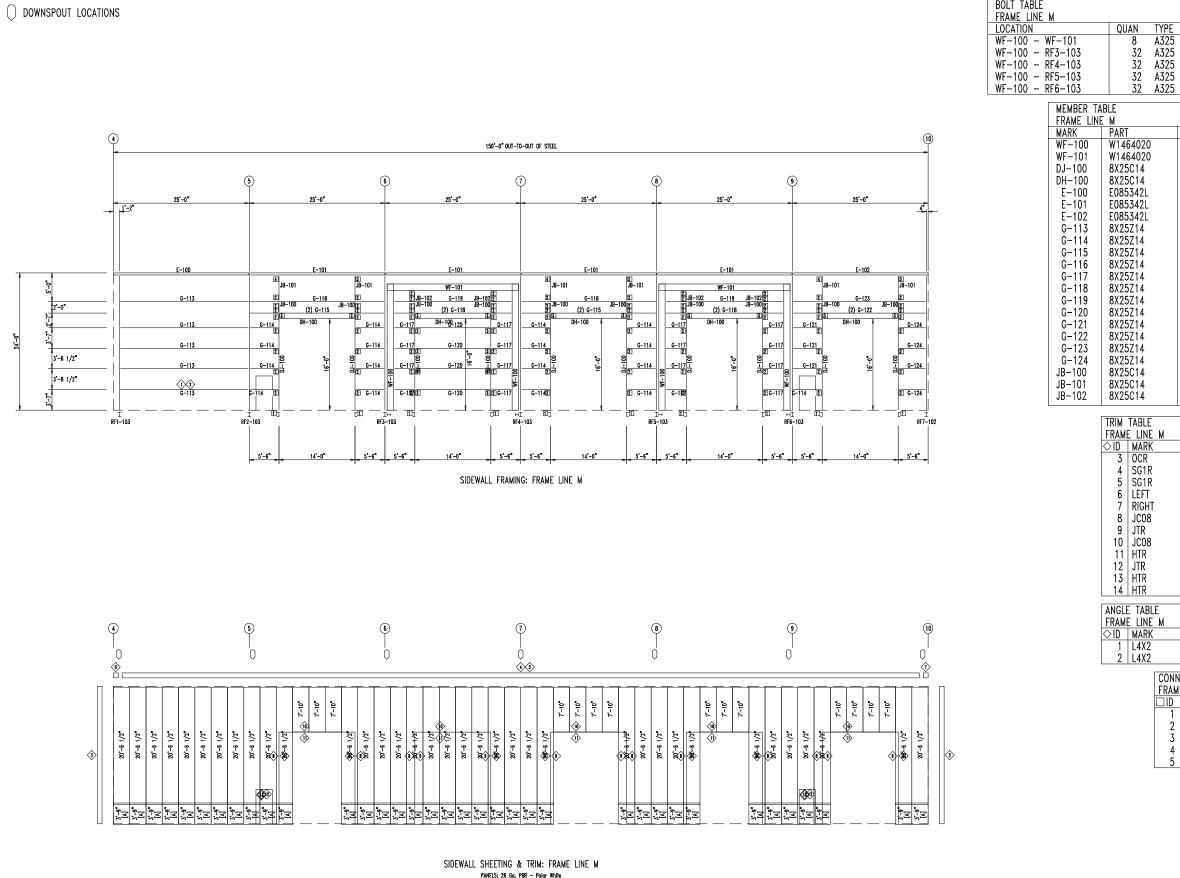
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REV. SCALE E13 of 51--NTS

REVISIONS NO. NOTES BY DATE -- 00-00-00







[A] PANELS: 26 Ga. PBR - Black

BOLT TABLE				
FRAME LINE M				
LOCATION	QUAN	TYPE	DIA	LENGTH
WF-100 - WF-101	8	A325	3/4"	2 1/2"
WF-100 - RF3-103	32	A325	5/8"	2"
WF-100 - RF4-103	32	A325	5/8"	<u>2</u> "
WF-100 - RF5-103	32	A325	5/8"	2"
WF-100 - RF6-103	32	A325	5′/8"	2"

<u> JISTEEL COMPONE</u>	<u>NTS,I</u>	<u>NC.</u>
432-758-9	9900	
430 US HWY Seminole,tx		
CUSTOMER INFO		
0001211211 2111 2		

LENGTH

22'-6"
21'-9 3/8"
16'-7 7/8"
13'-11 1/2"
24'-11 1/2"
24'-11 1/2"
24'-11 1/4"
4'-9 7/8" 24'-3 1/4" 24'-3 1/4" 24-3 1/4 3'-6 15/16" 21'-9 3/8" 21'-9 3/8" 13'-11 1/2" 4'-9 7/8" 23'-11 1/4" 23'-11 1/4" 4'-5 7/8" 1'-4 1/2" 3'-11 5/8" 1'-8 1/2"

PROJECT PB50637 MADISON

1/12/24

1/12/24

1/12/24

DATE

DATE

SCALE

NTS

DDESSA, TX 79763 SHEET NAME/TITLE SIDEWALL FRAMING

REV.

DRAWN BY

CHECKED BY

APPROVED BY

E16 of 51--

SHEET NO.

BN

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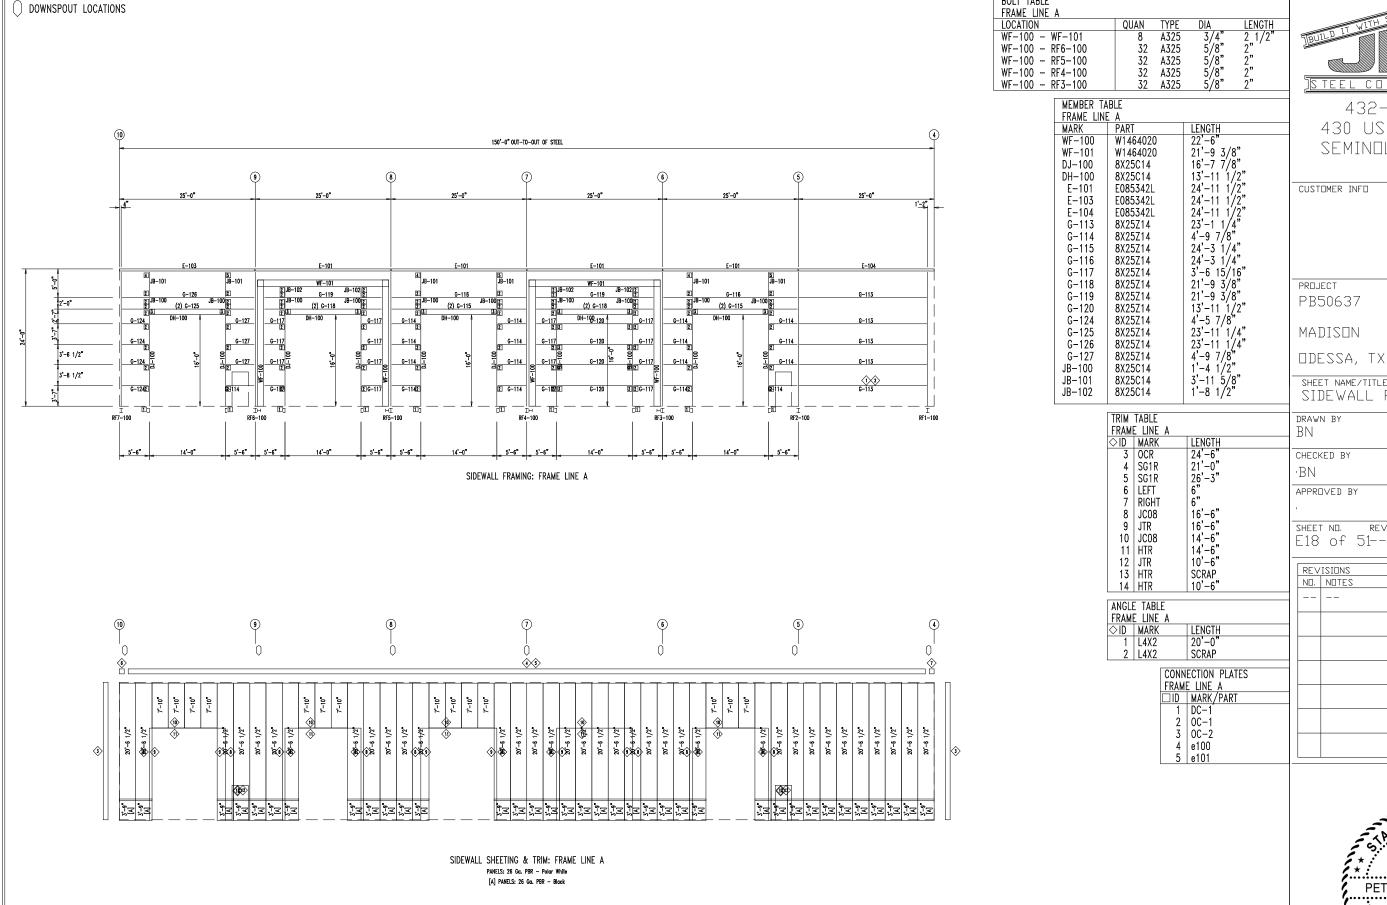
LENGTH 24'-6" 21'-0" 26'-3" 6" 6" 16'-6" 14'-6" 14'-6" 10'-6"

14	HTR	SCRAP
GLE	TABLE	
AMI	E LINE M	
D	MARK	LENGTH
1	L4X2	20'-0"
2	14X2	SCRAP

	SUKAP
CONN	ECTION PLATES
FRAMI	E LINE M
□ID	MARK/PART
1	DC-1
2	0C-1
3	0C-2
4	e100
5	e101
	FRAMID 1 2 3 4

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		ND.	NDTES	BY	DATE
		IND	NUTES		
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STEEL COMPONENTS, INC.

432-758-9900 430 US HWY 180 W SEMINDLE, TX 79360

CUSTOMER INFO

BOLT TABLE

MADISON

DDESSA, TX 79763

SHEET NAME/TITLE

SIDEWALL FRAMING

1/12/24

1/12/24

1/12/24

DATE

DATE

SCALE

NTS

REVISIONS ND. NOTES BY DATE 00-00-00				
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00-00-00	N□.	NOTES	BY	DATE
				00-00-00
		•		



SPLICE BOLT	TABLE					
	Qty					
Mark	Тор	Bot	Int	Type	Dia	Length
SP-1	4	4	2	A325	0.750	2.50
SP-2	4	4	0	A325	0.750	2.50

FLANGE BRACES: Both Sides(U.N.)
FBxxD(1): xx=length(in)
D - FB2X2X07

MEMBER	TABLE				
	Web Depth	Web Plate	Outside Flange	Inside Flange	
Mark	Start/End	Thick Length	W x Thk x Length	W x Thk x Length	
RF1-1	8.0/29.2	0.135 211.0	6 x 3/8" x 242.8	6 x 1/2" x 220.3	5
	29.2/30.0	0.188 36.0	6 x 3/8" x 26.0	,	1
RF1-2	24.0/14.0	0.135 146.0	6 x 1/4" x 386.0	6 x 1/4" x 146.4	
	14.0/14.0	0.135 240.0	,	6 x 1/4" x 237.6	
EB-2	W8X10			,	
EB-8	W8X10				'

CONN	ECTION	PLATES
□ ID	Mark,	/Part
1	h1	



432-758-9900 430 US HWY 180 W SEMINOLE,TX 79360

CUSTOMER INFO

PROJECT

·BN

PB50637

MADISON

DDESSA, TX 79763

SHEET NAME/TITLE RIGID FRAME ELEVATION

DRAWN BY 1/12/24 BN

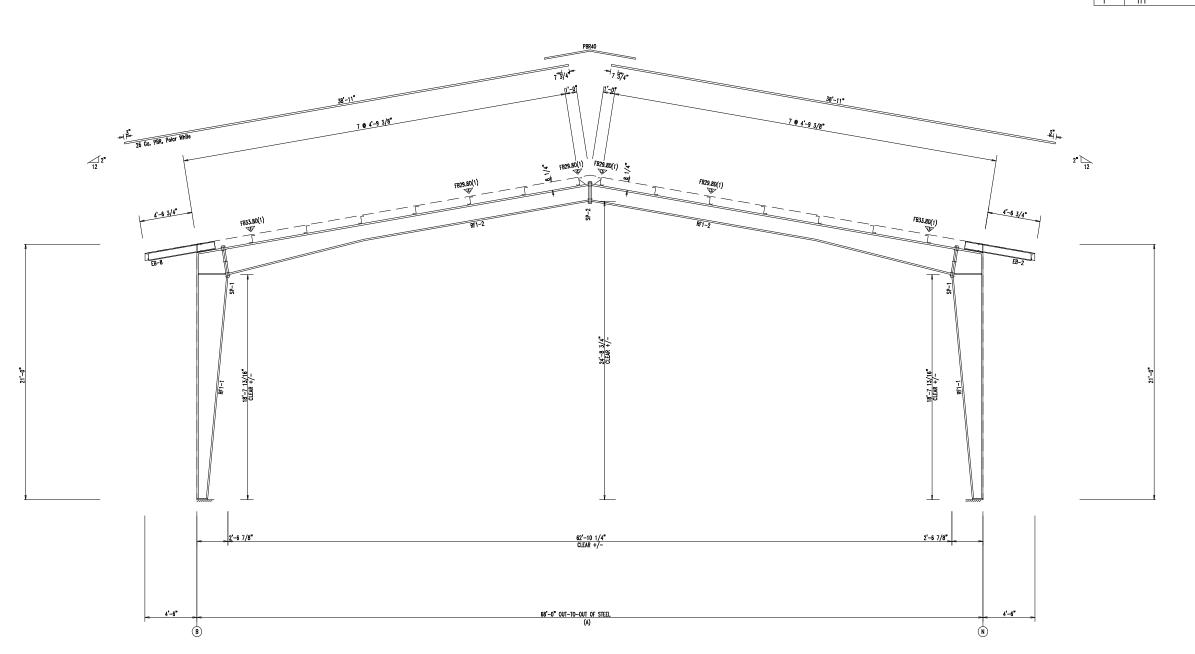
DATE CHECKED BY 1/12/24

APPROVED BY DATE 1/12/24

SCALE E19 of 51--NTS

NO.	SIONS NOTES	BY	DATE
			00-00-00





RIGID FRAME ELEVATION: FRAME LINE 1

SPLICE BOLT	TABLE						
	Qty						
Mark	Top	Bot	Int	Type	Dia	Length	
SP-1	4	4	2	A325	0.750	2.50	
SP-2	4	4	0	A325	0.750	2.50	

SUPPO	RT RFA	M BOLT	TABI F		
00110	ICI DEA	III DOLI	ITABLE		_
חום ו	Ωŧν	Type	Dia	Lenath	
I <i>U</i>	QIY	1)pc	Diu	rendin	
C1	7	1705	0.750	2 50	
3		ASZS	0./50	2.50	

FLANGE BRACES: Both Sides(U.N.)
FBxxD(1): xx=length(in)
D - FB2X2X07

MEMBER TAB	LE				
	Web Depth	Web P	late	Outside Flange	Inside Flange
Mark	Start/End	Thick	Length	W x Thk x Length	W x Thk x Length
RF2-1	12.0/12.0 12.0/12.0	0.135	208.9	6 x 1/4" x 127.5	6 x 3/8" x 127.5 6 x 1/2" x 89.1
	12.0/12.0	0.250	36.0	6 x 3/8" x 115.4	6 x 1/2" x 89.1
	'			6 x 1/4" x 12.5 6 x 1/4" x 399.5	,
RF2-2	24.0/14.0	0.135	163.6	6 x 1/4" x 399.5	6 x 1/4" x 163.9 6 x 1/4" x 237.6 6 x 1/2" x 89.1 6 x 3/8" x 127.5
	14.0/14.0	0.135	240.0	,	6 x 1/4" x 237.6
RF2-3	12.0/12.0	0.250	36.0	6 x 1/4" x 12.5 6 x 3/8" x 115.4	6 x 1/2" x 89.1
	12.0/12.0	0.135	208.9	6 x 3/8" x 115.4	6 x 3 [′] /8" x 127.5
	/			6 x 1/4" x 127.5	·
EB-3	W8X10			,	

BUILD IT WITH STEEL BUILD IT TO LAST

432-758-9900 430 US HWY 180 W SEMINOLE,TX 79360

CUSTOMER INFO

PLATES

PROJECT PB50637

MADISON

DDESSA, TX 79763

SHEET NAME/TITLE RIGID FRAME ELEVATION

 DRAWN BY
 DATE

 BN
 1/12/24

 CHECKED BY
 DATE

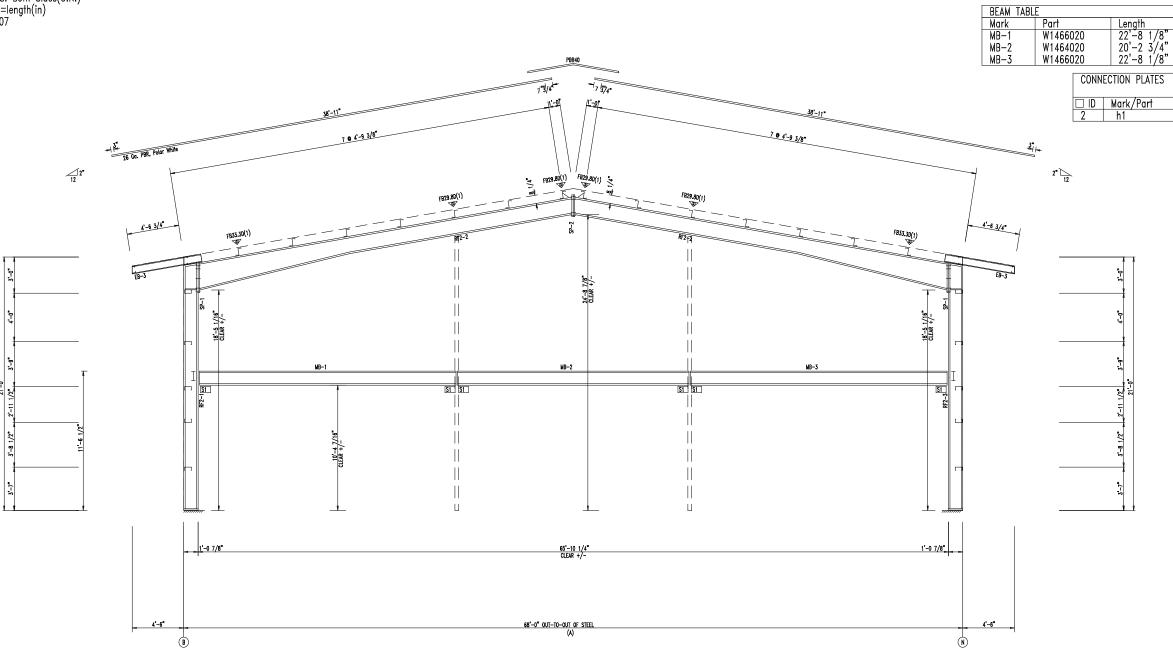
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 1/12/24

 APPROVED BY
 DATE

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 1/12/24

SHEET NO. REV. SCALE E20 of 51- NTS





RIGID FRAME ELEVATION: FRAME LINE 2

SPLICE BOLT	TABLE						
N 1	Qty	D. I	1.1	т	D.	1 11	
Mark	Тор	Bot	Int	Type	Dia	Length	
SP-1	4	4	2	A325	0.750	2.50	
SP-2	4	4	0	A325	0.750	2.50	
CURRORT REAL POLT TARLE							

SUPPORT BEAM BOLT TABLE								
□ID	Qty	Type	Dia	Length	٦			
S1	3	A325	0.750	2.50				
S2	6	A325	0.750	2.50				
S3	4	A325	0.750	2.50				

SUPP0	RT COL	.UMN BOLT	TABLE		
□ID	Qty	Type	Dia	Length	
C1	4	A325	0.750	2.50	

MEMBER TA	BLE				
	Web Depth	Web Pl	late	Outside Flange	Inside Flange
Mark	Start/End	Thick	Length		W x Thk x Length
RF3-1	12.0/12.0	0.135	208.9	6 x 1/4" x 242.9	6 x 1/4" x 127.5
	12.0/12.0	0.375	36.0	6 x 1/4" x 12.4	6 x 1/2" x 93.2
RF3-2	20.0/14.0	0.135	162.5	6 x 1/4" x 399.1	6 x 1/4" x 162.6
	14.0/14.0	0.135	240.0	,	6 x 1/4" x 237.6
RF3-3	12.0/12.0	0.375	36.0	6 x 1/4" x 12.4 6 x 1/4" x 242.9	6 x 1'/2" x 93.2 6 x 1/4" x 127.5
	12.0/12.0	0.135	208.9	6 x 1/4" x 242.9	6 x 1 [′] /4" x 127.5
EB-3	W8X10			,	,

BEAM TABL	E	
Mark	Part	Length
MC-1	T035035D	10'-4 1/2"
MC-2	T035035D	10'-4 1'/2"
MC-3	T035035C	10'-4 1'/2"
MB-4	W1464025	35'-9 1/8"
MB-5	W1464025	30'-0 7'/8"



CUSTOMER INFO

PROJECT

PB50637

MADISON

ODESSA, TX 79763

SHEET NAME/TITLE RIGID FRAME ELEVATION

DRAWN BY DATE
BN 1/12/24

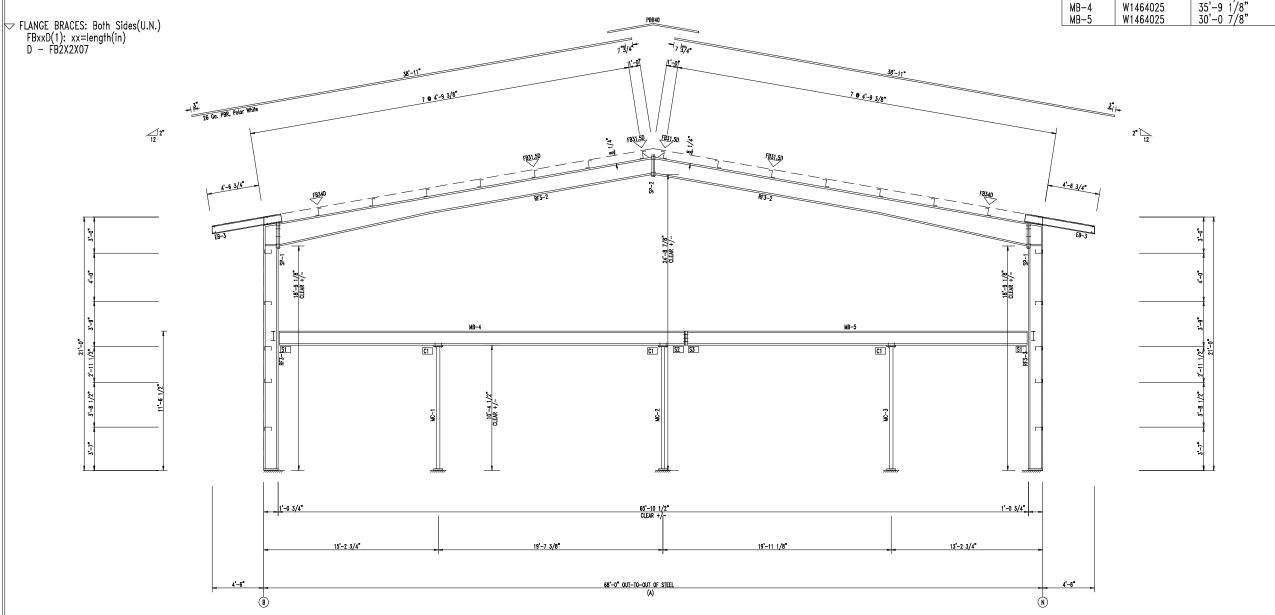
CHECKED BY DATE
BN 1/12/24

APPROVED BY DATE 1/12/24

SHEET NO. REV. SCALE E21 of 51-- NTS

REV	REVISIONS						
NO.	NOTES	BY	DATE				
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RIGID FRAME ELEVATION: FRAME LINE 3

SPLICE BOLT	TABLE					
Mark	Qty Top	Bot	Int	Type	Dia	Length
SP-1	4	4	0	A325	0.750	2.50
SP-2	4	4	2	A325	0.750	2.50

SUPPO	RT BEA	M BOLT	TABLE	
□ID	Qty	Type	Dia	Length
S1	3	A325	0.750	2.50
S2	6	A325	0.750	2.50
S3	4	A325	0.750	2.50
	S1	□ ID Qty S1 3	□ ID Qty Type S1 3 A325 S2 6 A325	□ ID Qty Type Dia S1 3 A325 0.750 S2 6 A325 0.750

SUPP0	RT COL	UMN BOLT	TABLE		
	Qty	Type	Dia	Length	
C1	4	A325	0.750	2.50	

FLANGE BRACES: Both Sides(U.N.)
FBxxD(1): xx=length(in)
D - FB2X2X07

MEMBER TAE	BLE				
	Web Depth	Web F		Outside Flange	Inside Flange
Mark	Start/End	Thick	Length	W x Thk x Length	W x Thk x Length
RF4-1	12.0/12.0	0.135	208.9	8 x 1/4" x 242.9	8 x 1/4" x 127.5
	12.0/12.0	0.500	36.0	8 x 1/4" x 12.4 6 x 1/4" x 399.1	8 x 3/8" x 97.2
RF4-2	16.0/16.0	0.135	298.0	6 x 1/4" x 399.1	6 x 1/2" x 165.8
	16.0/16.0	0.135	103.8		6 x 1/4" x 233.3
RF4-3	12.0/12.0	0.500	36.0	8 x 1/4" x 12.4 8 x 1/4" x 242.9	8 x 3/8" x 97.2 8 x 1/4" x 127.5
	12.0/12.0	0.135	208.9	8 x 1/4" x 242.9	8 x 1/4" x 127.5
EB-4	W8X10			,	,
EB-7	W8X10				
RF1-100	8.0/22.0	0.135	281.9	6 x 1/4" x 278.9	6 x 1/4" x 258.5
				6 x 1/4" x 18.5 6 x 1/4" x 466.6	
RF1-101	20.0/16.0	0.135	229.9	6 x 1/4" x 466.6	6 x 1/4" x 229.9
	16.0/16.0	0.135	236.7		6 x 1/4" x 234.0
RF1-102	16.0/16.0	0.135	236.7	6 x 1/4" x 466.6	6 x 1/4" x 234.0
	16.0/20.0	0.135	229.9		6 x 1/4" x 229.9
RF1-103	22.0/ 8.0	0.135	281.9	6 x 1/4" x 18.5 6 x 1/4" x 278.9	6 x 1/4" x 258.5
				6 x 1/4" x 278.9	



432-758-9900 430 US HWY 180 W SEMINOLE,TX 79360

CUSTOMER INFO

PROJECT PB50637

MADISON

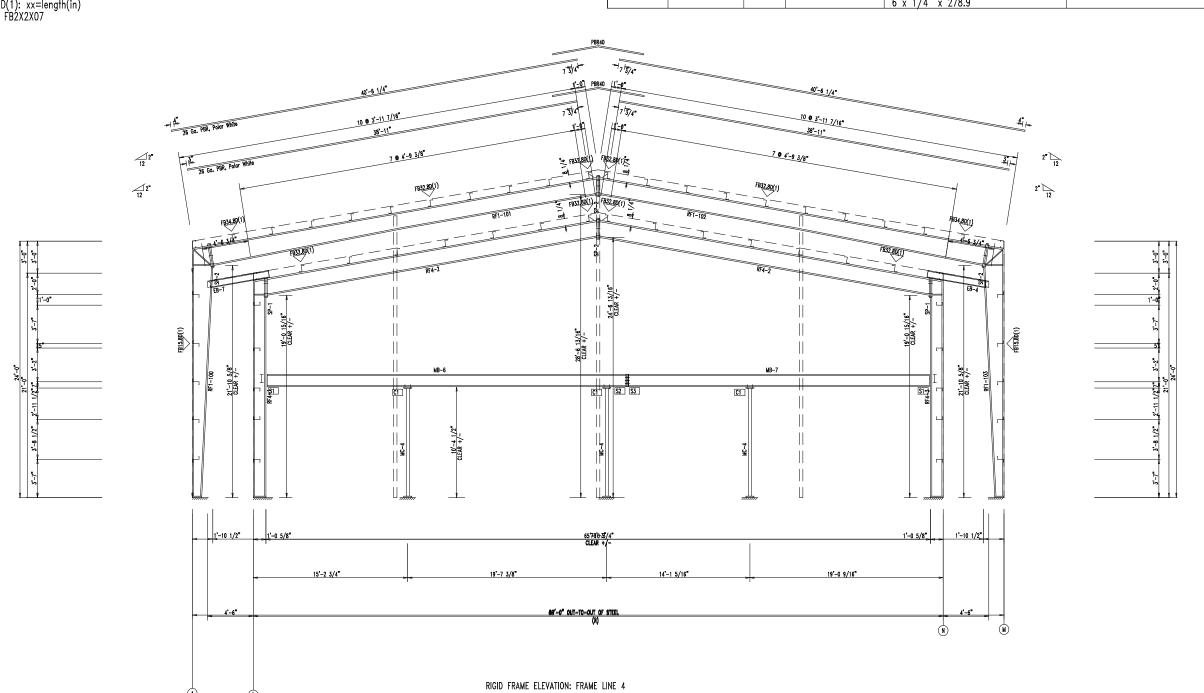
DDESSA, TX 79763

SHEET NAME/TITLE
RIGID FRAME ELEVATION

drawn by BN	DATE 1/12/24
CHECKED BY	DATE 1/12/24
APPROVED BY	DATE 1/12/24
SHEET NO. REV. E23 of 51-	scale NTS
	BN CHECKED BY BN APPROVED BY SHEET NO. REV.

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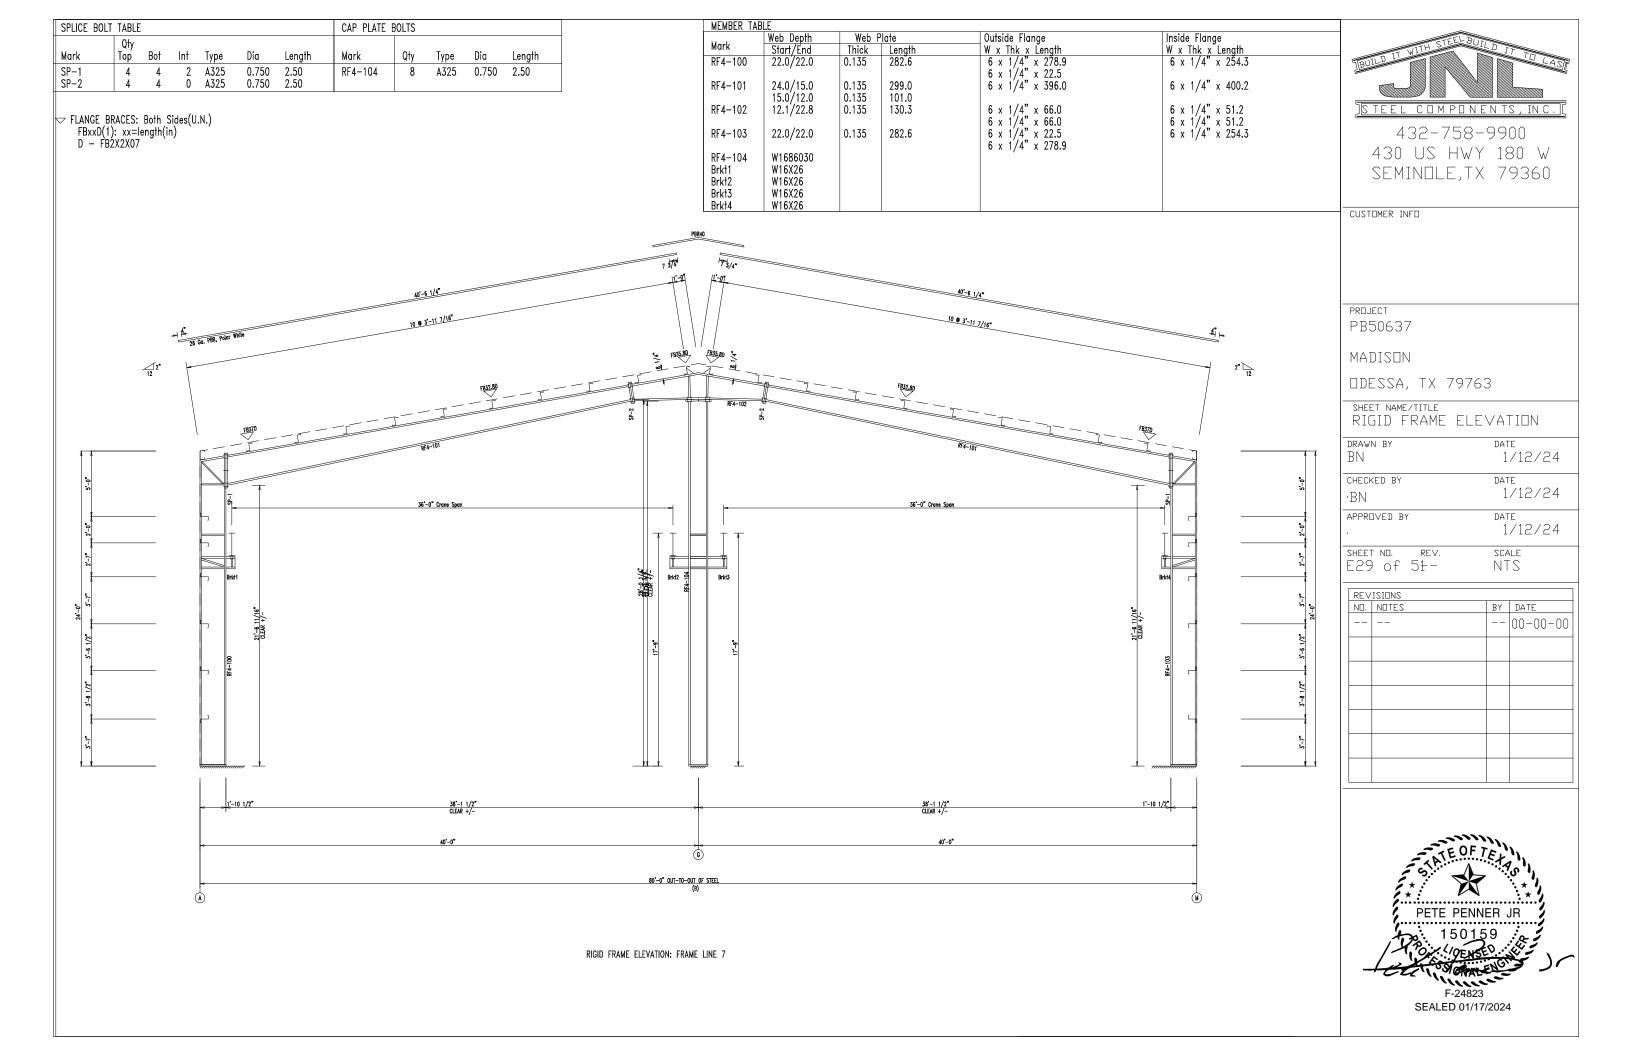


SPLICE BOLT TABLE	CAP PLATE BOLTS Mark Qty Type Dia Length RF2-104 8 A325 0.750 2.50	MEMBER 1 Mark RF2-100 RF2-101 RF2-102 RF2-103 RF2-104 Brkt1 Brkt2 Brkt3 Brkt4	Web Depth Web Plate Start/End Thick Length 22.0/22.0 0.135 282.6 24.0/15.0 0.135 299.0 15.0/12.0 0.135 101.0 12.1/22.8 0.135 130.3	Outside Flange W x Thk x Length 6 x 1/4" x 278.9 6 x 1/4" x 22.5 6 x 1/4" x 396.0 6 x 1/4" x 66.0 6 x 1/4" x 66.0 6 x 1/4" x 22.5 6 x 1/4" x 22.5	Inside Flange W x Thk x Length 6 x 1/4" x 254.3 6 x 1/4" x 400.2 6 x 1/4" x 51.2 6 x 1/4" x 51.2 6 x 1/4" x 254.3	IS TEEL COMPONENTS, INC. (432-758-9900 430 US HWY 180 W SEMINOLE, TX 79360
2° (12° (12° (12° (12° (12° (12° (12° (1	40'-6 1/4" 10 9 3'-11 7/16" FREEZ-80 FREEZ-80 36'-0" Crune Span	773/4* 1 3/74 1 3/74 1 2 0 0 0 0 0 0 0 0 0 0 0 0 0 0 0 0 0 0	7832.80 7	40'-6 1/4* 10 • 3'-11 7/16' R72-101 Crone Span	3-7* 3-8 1/2* 3-5 1/2* 2-0* 5-0*	PROJECT PB50637 MADISON ODESSA, TX 79763 SHEET NAME/TITLE RIGID FRAME ELEVATION DRAWN BY BN 1/12/24 CHECKED BY BN 1/12/24 APPROVED BY
1,1-10 1/2*	36'-1 1/2" CLEAR +/-		;	5'-1 1/2" EAR +/-	1'-10 1/2"	2000
(4)	40'-0"	80'-0" OUT-TO-OUT OF STEEL (8) RIGID FRAME ELEVATION: FRAME LINE 5		40'-0"	®	PETE PENNER JR 150159 150159 F-24823 CFAIRE DAMATICAL

SEALED 01/17/2024

SPLICE BOLT TABLE	CAP DIATE DOLTS	MEMBER TA	RIF			
SPLICE BOLT TABLE	CAP PLATE BOLTS Mark Qty Type Dia Length RF3-104 8 A325 0.750 2.50	MEMBER 1A Mark RF3-100 RF3-101 RF3-102 RF3-103 RF3-104 Brkt1 Brkt2 Brkt3 Brkt4	Web Depth Web Plate Start/End Thick Length 22.0/22.0 0.135 282.6	Outside Flange W x Thk x Length 6 x 1/4" x 278.9 6 x 1/4" x 396.0 6 x 1/4" x 66.0 6 x 1/4" x 66.0 6 x 1/4" x 22.5 6 x 1/4" x 278.9	Inside Flange W x Thk x Length 6 x 1/4" x 254.3 6 x 1/4" x 400.2 6 x 1/4" x 51.2 6 x 1/4" x 51.2 6 x 1/4" x 254.3	TEULD TO LASS STEEL COMPONENTS, INC. ID 432-758-9900 430 US HWY 180 W SEMINOLE, TX 79360 CUSTOMER INFO
25 GO. 1900, Polar White 25 GO. 1900, Polar White 12 1/2 12 1/2 12 1/2 13 1/4 1/2 14 1/2 15 1/4 1/2 16 1/4 1/2 17 1/4 1/2 18 1/4 1/4 1/2 18 1/4 1/4 1/4 1/4 1/4 1/4 1/4 1/4 1/4 1/4	10 • 3'-11 7/15' 10 • 3'-11 7/15' REST-80 REST-101	7 3 7 7 7 7 7 7 7 7 7 7 7 7 7 7 7 7 7 7		60-6 1/4° 83-101	21-6 11/16* The second	PROJECT PB50637 MADISON ODESSA, TX 79763 SHEET NAME/TITLE RIGID FRAME ELEVATION DRAWN BY BN 1/12/24 CHECKED BY BN 1/12/24 CHECKED BY APPROVED BY APPROVED BY APPROVED BY APPROVED BY BN REV. SCALE E27 of 51- NTS REVISIONS NO. NOTES BY DATE 00-00-00
1'-10 1/2"	36'-1 1/2" CLEAR +/- 40'-0"	80"-0" OUT-TO-OUT OF STEEL.	38'-1 1/2" CLEAR +/- 40'-0"		1'-10 1/2	PETE PENNER JR
		RIGID FRAME ELEVATION: FRAME LINE 6				F-24823 SEALED 01/17/2024

SEALED 01/17/2024



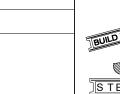
SPLICE BOLT TABLE Qty	CAP PLATE BOLTS	MEMBE Mark	R TABLE Web Depth Web	Plate	Outside Flange	Inside_Flange	STEEL BUTT
Mark Top Bot Int Type Dia Length	Mark Qty Type Dia Length RF5-104 8 A325 0.750 2.50	RF5-11 RF5-11 RF5-11 RF5-11 RF5-11 Brk11 Brk12 Brk43 Brk14	01 24.0/15.0 0.135 15.0/12.0 0.135 02 12.1/22.8 0.135 03 22.0/22.0 0.135	Length 282.6 299.0 101.0 130.3 282.6	Outside Flange W x Thk x Length 6 x 1/4" x 278.9 6 x 1/4" x 22.5 6 x 1/4" x 396.0 6 x 1/4" x 66.0 6 x 1/4" x 66.0 6 x 1/4" x 22.5 6 x 1/4" x 278.9	Inside Flange W x Thk x Length 6 x 1/4" x 254.3 6 x 1/4" x 400.2 6 x 1/4" x 51.2 6 x 1/4" x 51.2 6 x 1/4" x 254.3	STEEL COMPONENTS, INC. C. 432-758-9900 430 US HWY 180 W SEMINOLE, TX 79360
2° 12° 17° 17° 17° 17° 17° 17° 17° 17° 17° 17	10 9 3-11 7/16* 10 9 3-11 7/16* 10 9 3-11 7/16* 10 9 3-11 7/16* 10 9 3-11 7/16* 10 9 3-11 7/16* 10 9 3-11 7/16*	7 3/4 7 7 3/4 7 7 3/4 7 7 3/4	102 2-45	_	8 1/4° 	2. 5. 5. 5. 5. 5. 5. 5. 5. 5. 5. 5. 5. 5.	PROJECT PB50637 MADISON ODESSA, TX 79763 SHEET NAME/TITLE RIGID FRAME ELEVATION DRAWN BY BN 1/12/24 CHECKED BY -BN 1/12/24 APPROVED BY - 1/12/24 SHEET NO. REV. SCALE E31 of 51 NTS REVISIONS NO. NOTES 00-00-00
A	38"-1. 1/2" CLEAR +/- 40"-0"	80'-0" OUT-TO-OUT OF STEEL (8)		38'-1 1/2" CIEAR +/- 40'-0"		1'-10 1/2"	PETE PENNER JR
		RIGID FRAME ELEVATION: FRAME LINE 8					F-24823 SEALED 01/17/2024

SPLICE BOLT TABLE CAP PLATE BOLTS	MEMBER TABLE		1	
Mark Oty Top Dia Length Mark Qty Type Dia Length SP-1 SP-2 4 4 2 A325 0.750 0.750 2.50 RF6-104 8 A325 0.750 0.750 2.50	Mark Web Depth Start/End RF6-100 22.0/22.0 RF6-101 24.0/15.0	Web Plate Outside Flange Thick Length W x Thk x Length 0.135 282.6 6 x 1/4" x 278.9 6 x 1/4" x 22.5 6 x 1/4" x 396.0	Inside Flange W x Thk x Length 6 x 1/4" x 254.3 6 x 1/4" x 400.2	TRUILD IT WITH STEEL BUILD IT TO LAST
FLANGE BRACES: Both Sides(U.N.) FBxxD(1): xx=length(in) D - FB2X2X07	RF6-102 15.0/12.0 12.1/22.8 RF6-103 22.0/22.0	0.135 299.0 6 x 1/4" x 396.0 0.135 130.3 6 x 1/4" x 66.0 6 x 1/4" x 66.0 6 x 1/4" x 66.0 6 x 1/4" x 22.5 6 x 1/4" x 278.9	6 x 1/4" x 51.2 6 x 1/4" x 51.2 6 x 1/4" x 254.3	18 TEEL COMPONENTS, INC. (432-758-9900 430 US HWY 180 W
	RF6-104 W1686030 Brkt1 W16X26 Brkt2 W16X26 Brkt3 W16X26 Brkt4 W16X26			SEMINDLE, TX 79360
	75/4* 1 514			COOTENER IN E
10 € 3'-11 7/16"		10 € 3'-11 7/16*	4; p.	PREJECT PB50637
12 ² *	F85.80 (R85.80)		2* 12	MADISON ODESSA, TX 79763 SHEET NAME/TITLE
18370 RFG-101	\$ \$ \$	W6-101	FB370	RIGID FRAME ELEVATION DRAWN BY BN 1/12/24
So S	——————————————————————————————————————	36'-0™ Crone Span	2-2-0.	CHECKED BY BN 1/12/24 APPROVED BY DATE 1/12/24
-1-1-1-1-1-1-1-1-1-1-1-1-1-1-1-1-1-1-1	Brids Brids		Brid4 - 2-7-2	SHEET NO. REV. SCALE E33 of 51- NTS REVISIONS NO. NOTES BY DATE
21-6 1/2° 21-6 11/16° CLEAR 4/-	17-9°		21-6 11/16* CIERR +/103 -104 -104 -105 -104 -104 -104 -105 -104 -104 -104 -105 -105 -105 -105 -105 -105 -105 -105	00-00-00
			3. 1-8-1/2°	
12-10 1/2" 38-1 1/2" CLEAR +/-	-	38"-1 1/2" CLEAR +/-	1'-10 1/2"	
40'-0"	6) -0" 007-10-001 OF STEEL	40'-0"	-	STATE OF TEXT
	(#) RIGID FRAME ELEVATION: FRAME LINE 9		Ŵ	PETE PENNER JR 150159 150159 F-24823 SEALED 01/17/2024

SPLICE BOL	T TABLE						
Mark	Qty Top	Bot	Int	Туре	Dia	Length	
SP-1	4	4	2	A325	0.750	2.50	

FLANGE BRACES: Both Sides(U.N.)
FBxxD(1): xx=length(in)
D - FB2X2X07

MEMBER TAB	E				
14 1	Web Depth	Web P	'late	Outside Flange	Inside Flange
Mark	Start/End	Thick	Length	W x Thk x Length	W x Thk x Length
RF7-100	8.0/20.0	0.135	281.6	6 x 1/4" x 278.9	6 x 1/4" x 258.1
	, , , , , , , , , , , , , , , , , , ,			6 x 1/4" x 16.5	
RF7-101	20.0/16.0	0.135	228.6	6 x 1/4" x 468.6	6 x 1/4" x 228.6 6 x 1/4" x 237.3
	16.0/16.0	0.135	240.0	,	6 x 1/4" x 237.3
RF7-102	20.0/ 8.0	0.135	281.6	6 x 1/4" x 16.5	6 x 1/4" x 258.1
	'			6 x 1/4" x 278.9	'



STEEL COMPONENTS, INC. 432-758-9900

430 US HWY 180 W SEMINOLE,TX 79360

CUSTOMER INFO

PROJECT

PB50637

MADISON

DDESSA, TX 79763

SHEET NAME/TITLE RIGID FRAME ELEVATION

DRAWN BY 1/12/24 BN

CHECKED BY DATE

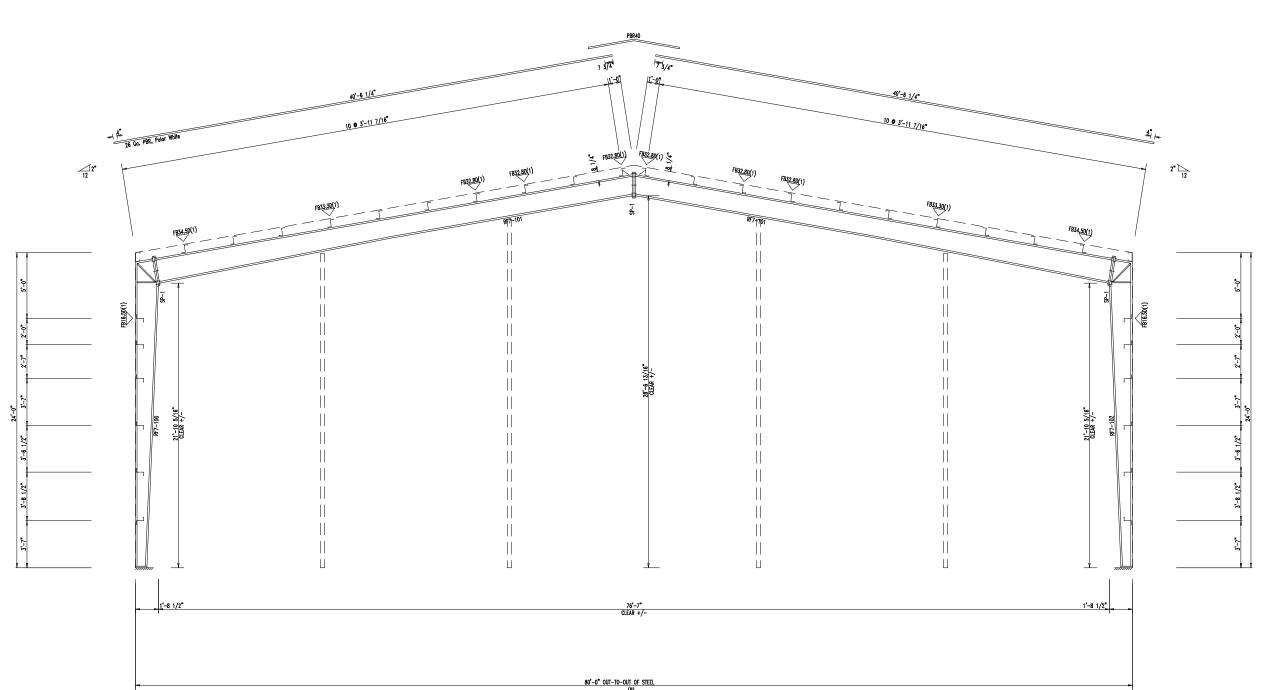
1/12/24 ·BN APPROVED BY DATE

1/12/24

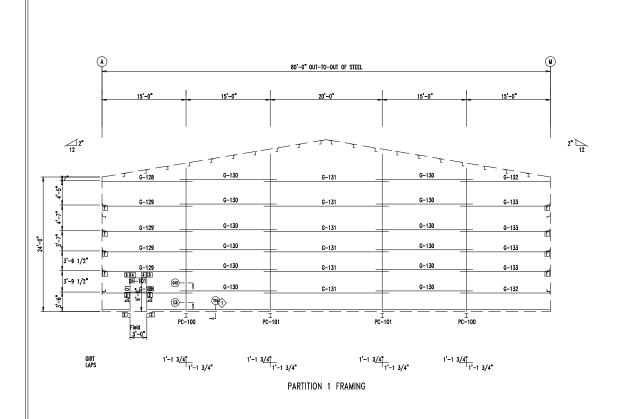
SCALE E34 of 51-NTS

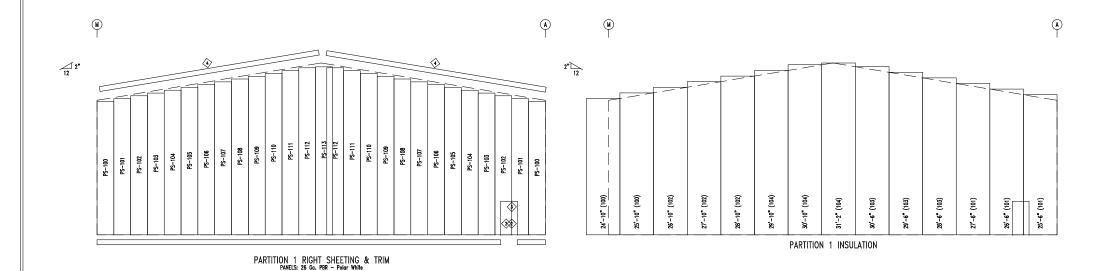
REVISIONS BY DATE NO. NOTES -- 00-00-00





RIGID FRAME ELEVATION: FRAME LINE 10





MEMBER TA	BLE	
PARTITION	1	
MARK	PART	LENGTH
PC-100	W0864030	23'-11 5/8"
PC-101	W0864030	26'-11 1'/4"
DJ-101	8X25C14	6'-11 3/8"
DH-101	8X25C14	2'-11 1'/2"
G-128	8X25Z14	15'-5 1'/4"
G-129	8X25Z14	15'-5 1'/4"
G-130	8X25Z14	17'-3 1'/2"
G-131	8X25Z14	22'-3 1'/2"
G-132	8X25Z14	15'-5 1'/4"
G-133	8X25Z14	15'-5 1'/4"
	•	

STEEL COMPONENTS, INC. 432-758-9900 430 US HWY 180 W SEMINOLE,TX 79360

ANGLE TABLE

PARTITION 1

OID PART

1 L4X2X14

TRIM TABLE
PARTITION 1

◇ID PART
2 TRJTR LENGTH 10'-6" 10'-6" 10'-2" 3 TRHTR 4 TRIA2

WALL INSULATION TABLE PARTITION 1 ROLL MARK WIDTH LENGTH PI-100 PI-101 PI-102 PI-103 PI-104 6'-0" 6'-0" 6'-0" 6'-0" 50'-8" 79'-6" 83'-6" 88'-6" 91'-10" 102 103 104

PANEL TABLE	
PARTITION 1	
MARK	LENGTH
PS-100	23'-9 3/4"
PS-101	24'-3 3'/4"
PS-102	24'-9 3/4"
PS-103	25'-3 3/4"
PS-104	25'-9 3/4"
PS-105	26'-3 3/4"
PS-106	26'-9 3'/4"
PS-107	27'-3 3'/4"
PS-108	27'-9 3/4"
PS-109	28'-3 3/4"
PS-110	28'-9 3/4"
PS-111	29'-3 3/4"
PS-112	29'-9 3/4"
PS-113	29'-11 3/4"

CONNECTION PLATES
PARTITION 1

ID MARK/PART

1 r100
2 DC-1
3 OC-1
4 OC-2

CUSTOMER INFO

PROJECT PB50637

MADISON

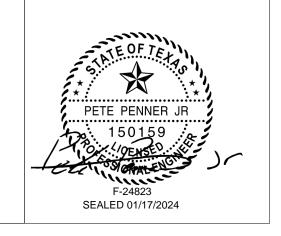
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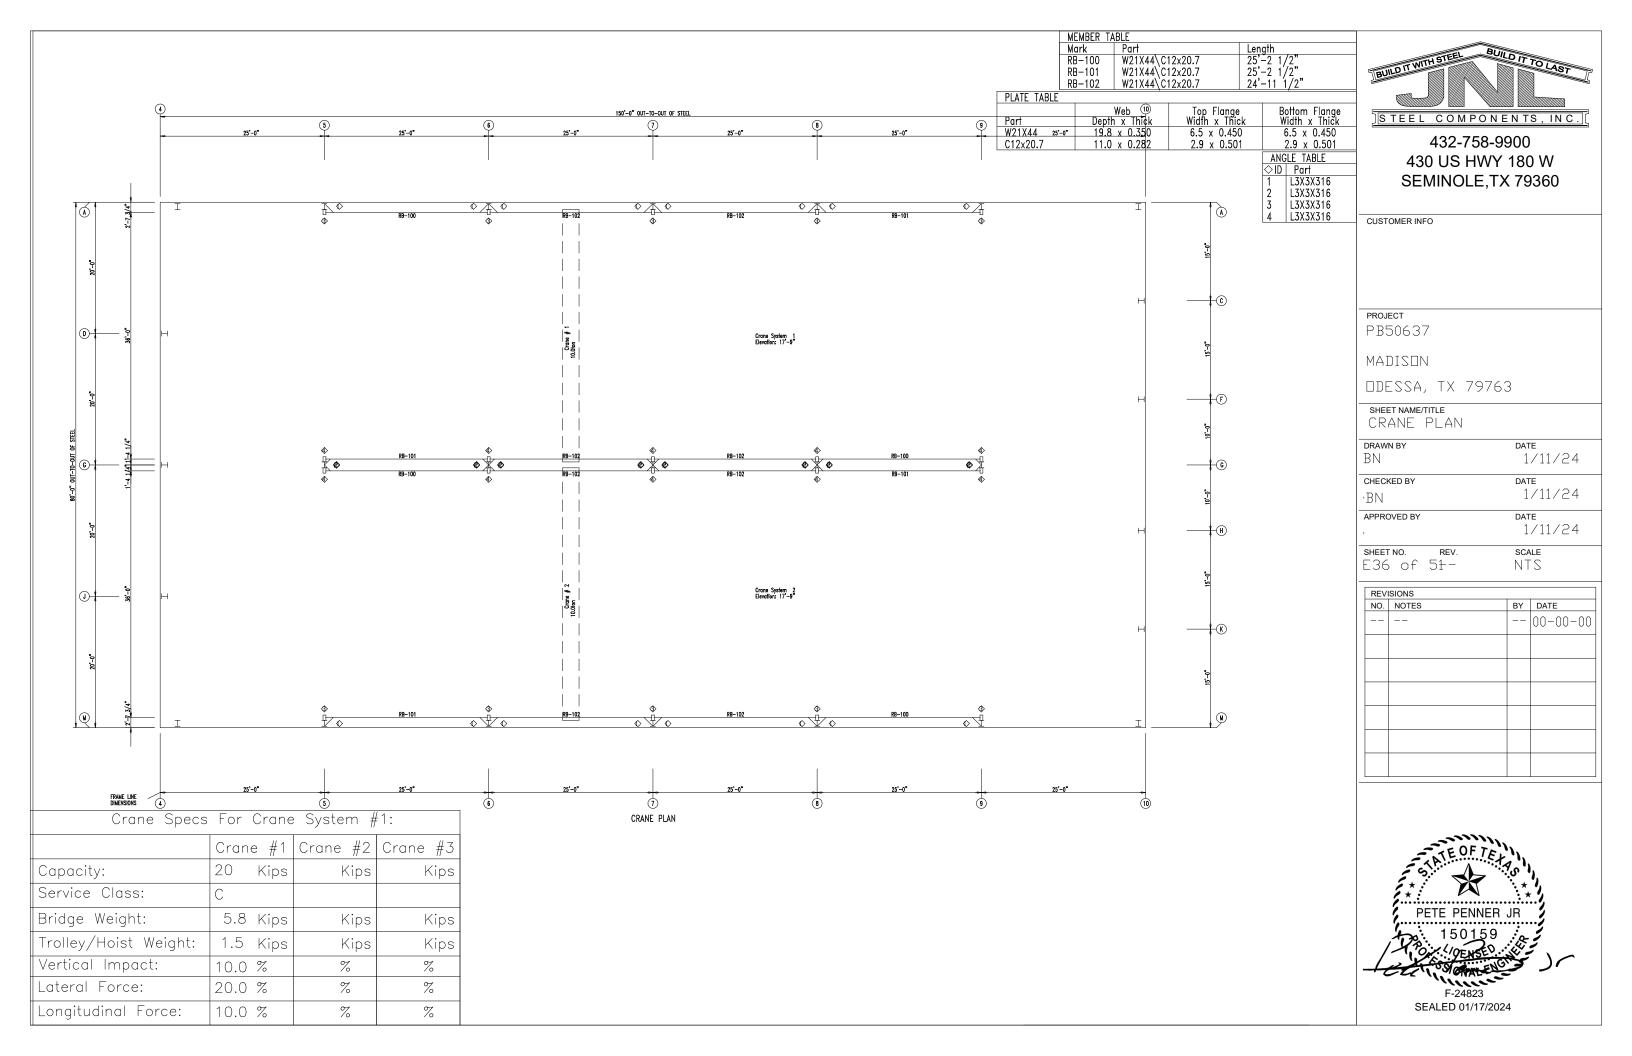
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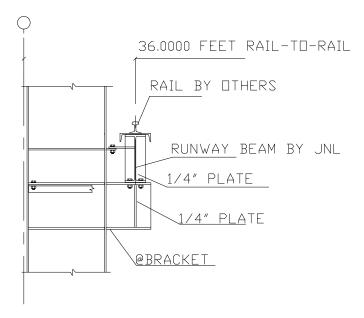
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SHEET NO. SCALE REV. E35 of 51-NTS

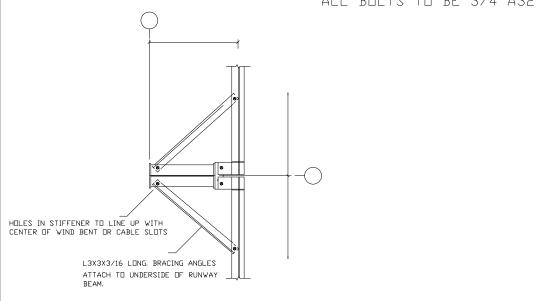
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	Dī	DATE
		00-00-00







ALL BOLTS TO BE 3/4 A325 BOLTS





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SHEET NAME/TITLE CRANE PLAN

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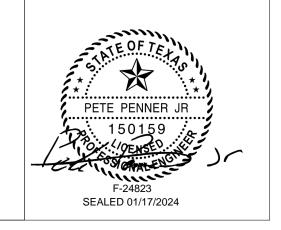
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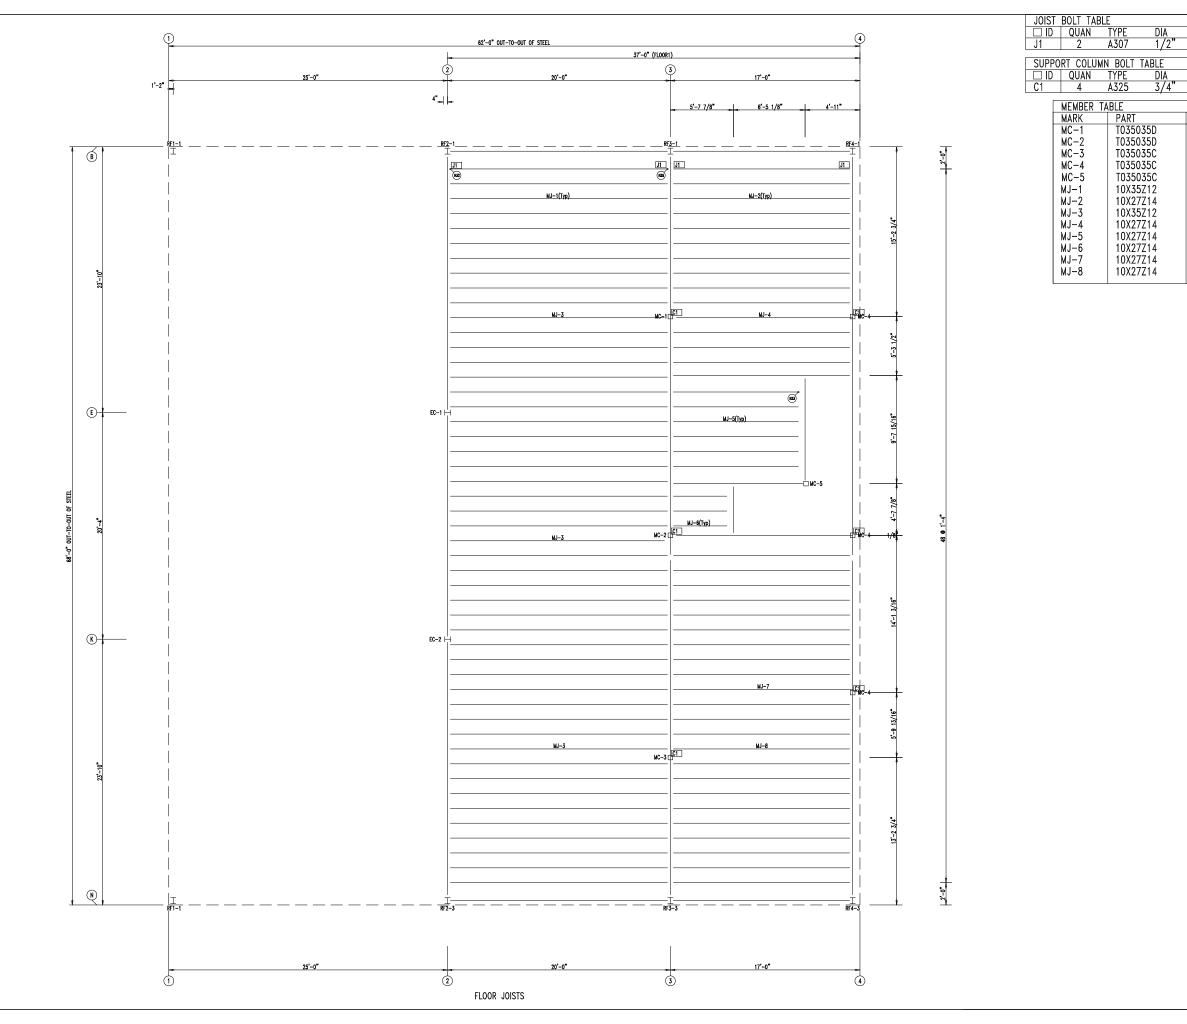
APPROVED BY DATE 1/11/24

SHEET NO. REV. SCALE

E37 of 51- NTS

NO.	NOTES	BY	DATE
			00-00-00





JOIST	BOLT TAE	ILE		
	QUAN	TYPE	DIA	LENGTH
J1	2	A307	1/2"	1 1/4"
			•	
SUPP0	RT COLUN	IN BOLT	TABLE	
	QUAN	TYPE	DIA	LENGTH
C1	4	1325	3/1"	2 1/2"

MEMBER TA	BLE	
MARK	PART	LENGTH
MC-1	T035035D	10'-4 1/2"
MC-2	T035035D	10'-4 1/2"
MC-3	T035035C	10'-4 1/2"
MC-4	T035035C	10'-4 1/2"
MC-5	T035035C	11'-6" [′]
MJ-1	10X35Z12	19'-5"
MJ-2	10X27Z14	16'-1"
MJ-3	10X35Z12	19'-5"
MJ-4	10X27Z14	16'-1"
MJ-5	10X27Z14	11'-5 1/2"
MJ-6	10X27Z14	5'-2 1/4"
MJ-7	10X27Z14	16'-1" [′]
MJ-8	10X27Z14	16'-1"
ı		



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SHEET NAME/TITLE
FLOOR JOISTS

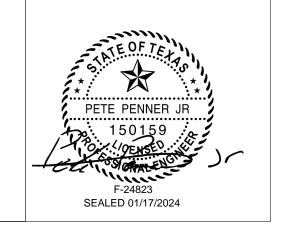
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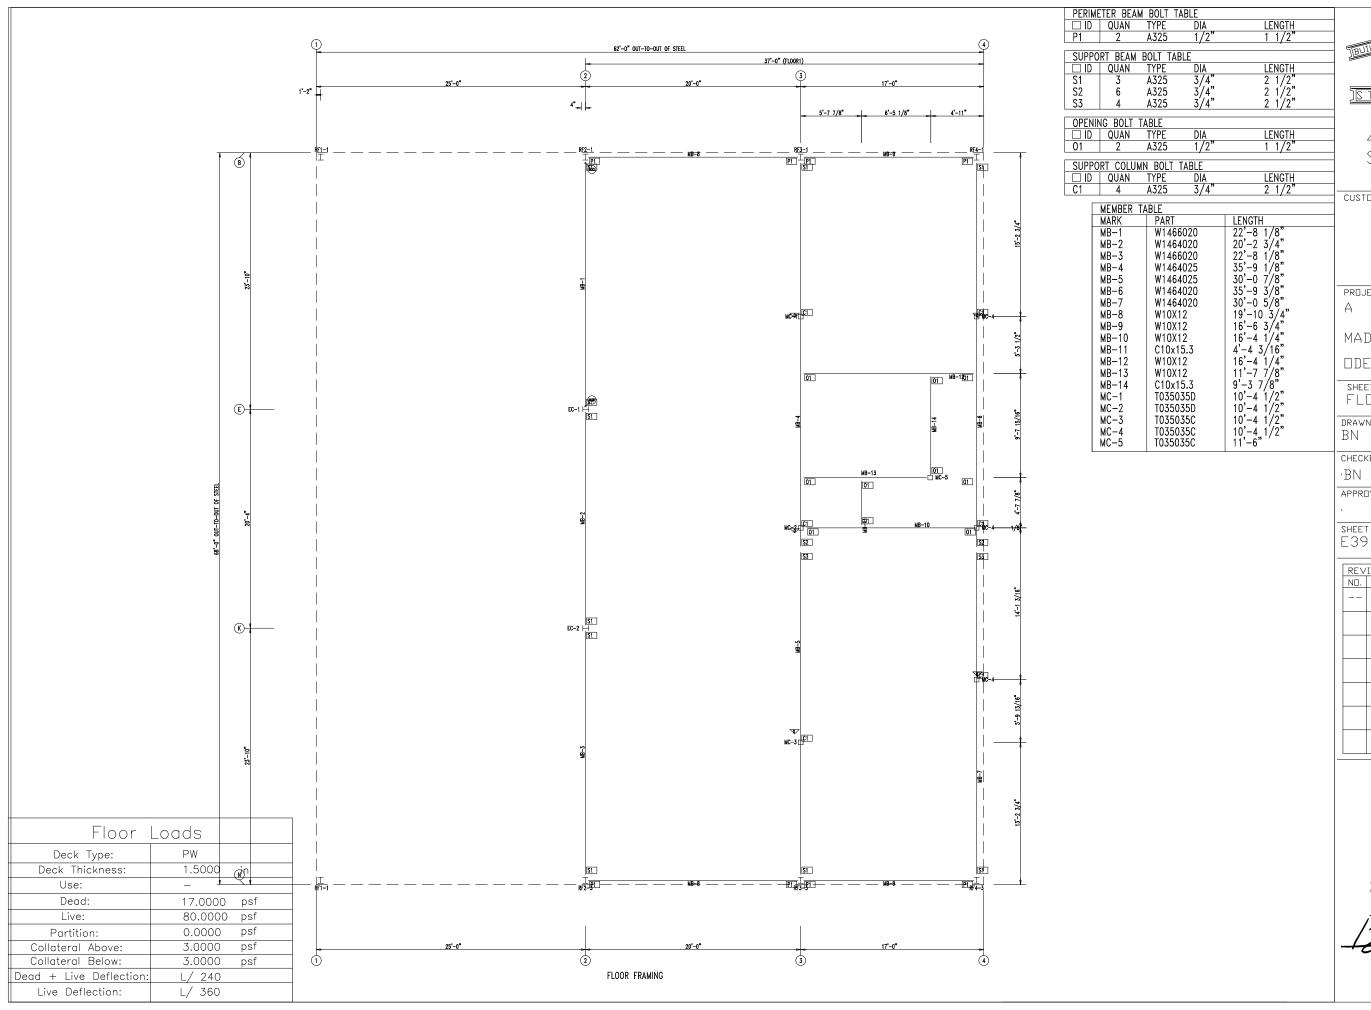
CHECKED BY DATE 1/11/24 ·BN

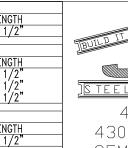
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REVISIONS NO. NOTES BY DATE -- 00-00-00









CUSTOMER INFO

PROJECT

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SHEET NAME/TITLE FLOOR FRAMING

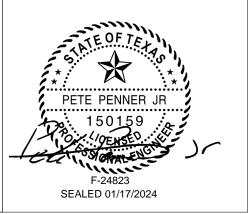
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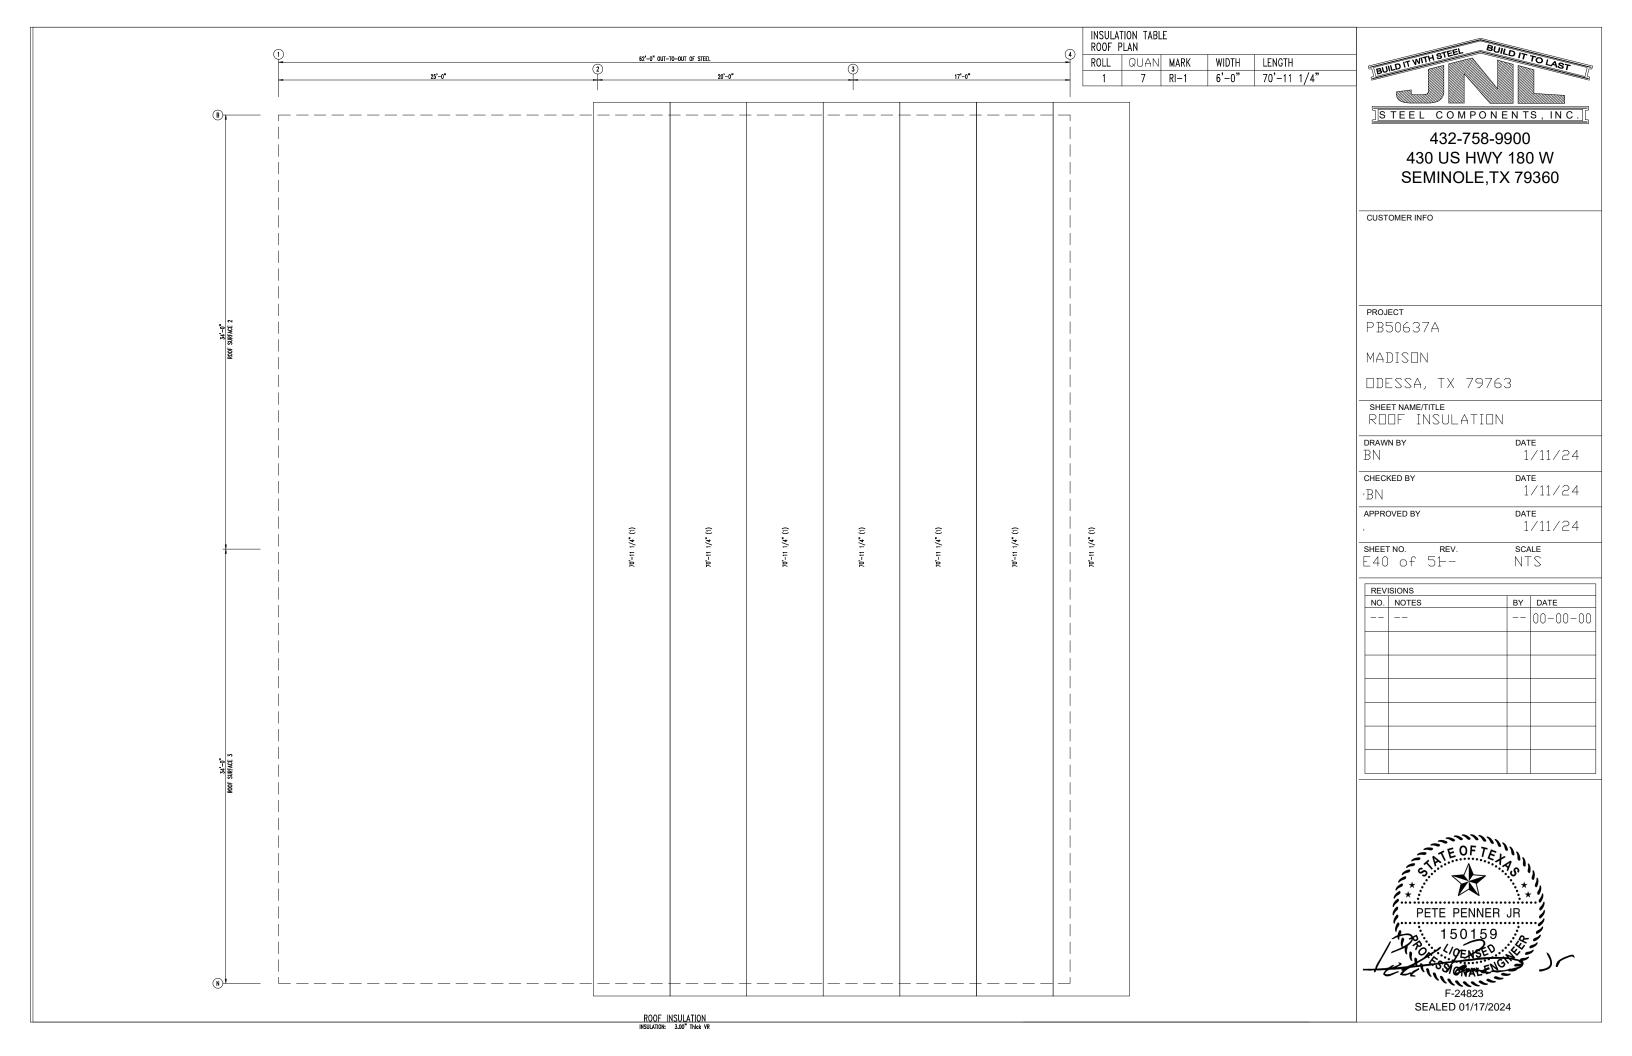
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SCALE SHEET NO. E39 of 51-NTS

REVISI□NS NO. NOTES BY DATE -- 00-00-00





INSULAT ROOF P	TION TABL	.E		
ROLL	QUAN	MARK	WIDTH	LENGTH
100	25	RI-100	6'-0"	83'-1 1/4"



CUSTOMER INFO

PROJECT PB50637

MADISON

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SHEET NAME/TITLE
ROOF INSULATION

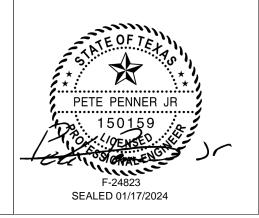
BN DATE
1/11/24

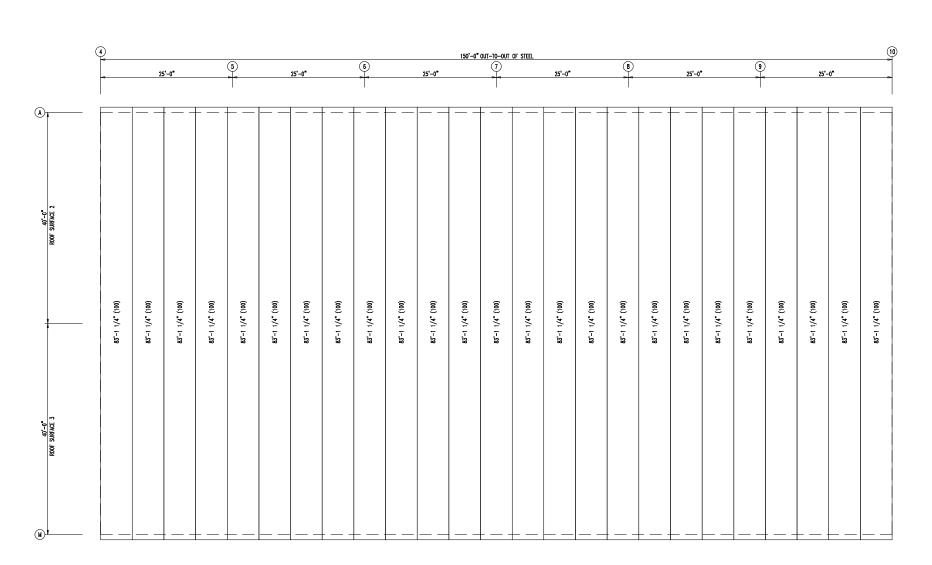
CHECKED BY DATE 1/11/24

APPROVED BY DATE 1/11/24

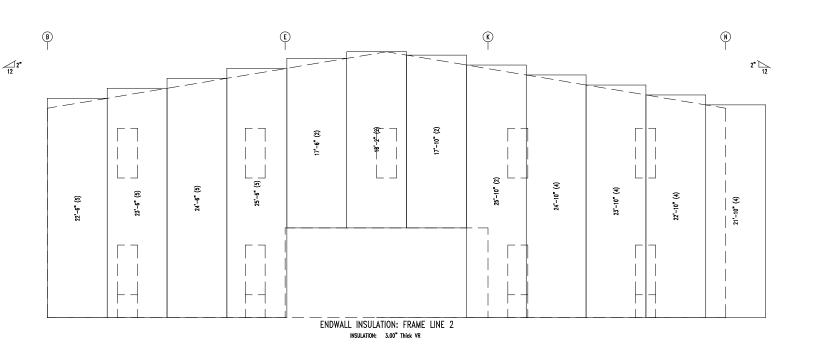
SHEET NO. REV. SCALE E41 of 51-- NTS

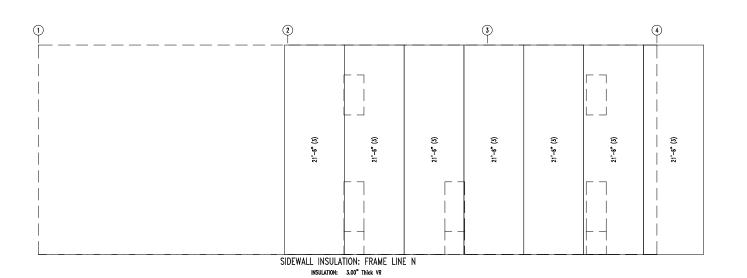
REVI	SIONS		
NO.	NOTES	BY	DATE
			00-00-00

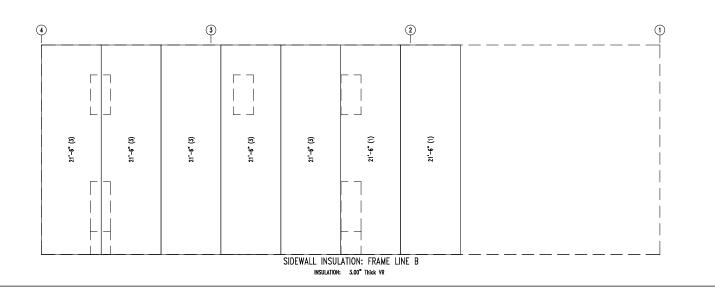




ROOF INSULATION INSULATION: 3,00° Thick VR







	TION TABL LINE 1 N				
ROLL	QUAN	MARK	WIDTH	LENGTH	
1 2 3 4 5	1 1 3 1	WI-1 WI-2 WI-3 WI-4 WI-5	6'-0"	43'-0" 79'-4" 86'-0" 93'-4" 96'-0"	

LEGEND: 43'-0" (1) Length (Roll #)



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SHEET NAME/TITLE WALL INSULATION

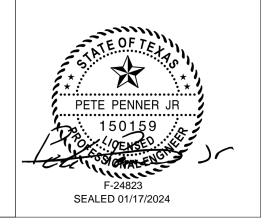
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BN 1/11/24

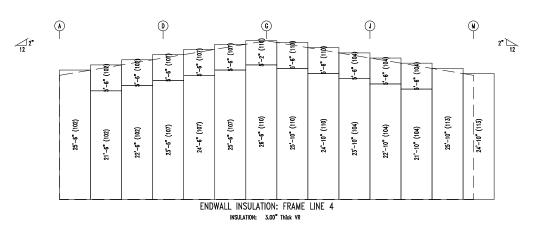
CHECKED BY DATE
-BN 1/11/24

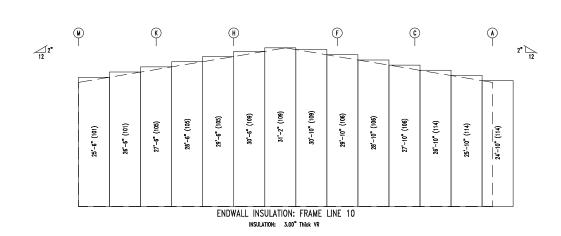
APPROVED BY DATE 1/11/24

SHEET NO. REV. SCALE E42 of 51- NTS

REVISIONS NO. NOTES BY DATE											
NO.	NOTES	BY	DATE								
			00-00-00								







4				5			6			7				8				9	ı			10
						8'-6" (103)						8'-6" (108)				8'-6" (108)				8'-6" (108)	8'-6" (108)	
24'-6" (113)	24"-6" (113)	24'-6" (111)	24'-6" (111)	24'-6" (111)	24'-6" (111)		 24"-6" (103)	24*-6" (103)	24"-6" (111)	 24"-6" (111)	24"-6" (111)		24'-6" (108)	24"-6" (108)	24'-6" (108)		24'-6" (108)	24*-6" (108)	24'-6" (108)			24"-6" (101)
									SIDEW	ULATION: ION: 3.00*	FRAME Thick VR	LINE M				L						

10				9				8				7				6				5)			4
	8'-6" (112)	8'-6" (112)				8'-6" (112)				8'-6" (103)								8'-6" (103)						
24"-6" (114)		•	24'-6" (112)	24'-6" (112)	24'-6" (112)		24'-6" (103)	24'-6" (103)	24'-6" (103)		24"-6" (111)	24'-6" (111)	24'-6" (111)	24"-6" (111)	24'-6" (103)	24'-6" (103)	24'-6" (103)		24'-6" (111)	24'-6" (111)	24'-6" (111)	24"-6" (111)	24'-6" (100)	24'-6" (100)
	SIDEWALL INSULATION: FRAME LINE A INSULATION: 3.00° Thick VR																							

NSULAT	ΠOΝ	TΑ	BLE			
RAME	LINE	4	М	10	Α	
ROLL	ดเ	JΑI	ΝĪ	MA	RK	

ROLL	QUAN	MARK	WIDTH	LENGTH
100	1	WI-100	6'-0"	49'-0"
101	1	WI-101	6'-0"	76'-6"
102	1	WI-102	6'-0"	80'-6"
103	3	WI-103	6'-0"	82'-0"
104	1	WI-104	6'-0"	85'-0"
105	1	WI-105	6'-0"	85'-6"
106	1	WI-106	6'-0"	86'-6"
107	1	WI-107	6'-0"	90'-0"
108	2	WI-108	6'-0"	90'-6"
109	1	WI-109	6'-0"	92'-6"
110	1	WI-110	6'-0"	93'-4"
111	4	WI-111	6'-0"	98'-0"
112	1	WI-112	6'-0"	99'-0"
113	1	WI-113	6'-0"	99'-8"
114	1	WI-114	6'-0"	102'-0"

LEGEND: 49'-0" (1) Length (Roll #)



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SHEET NAME/TITLE WALL INSULATION

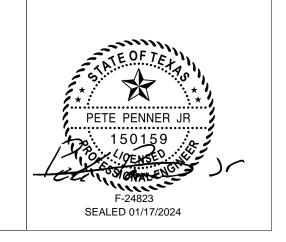
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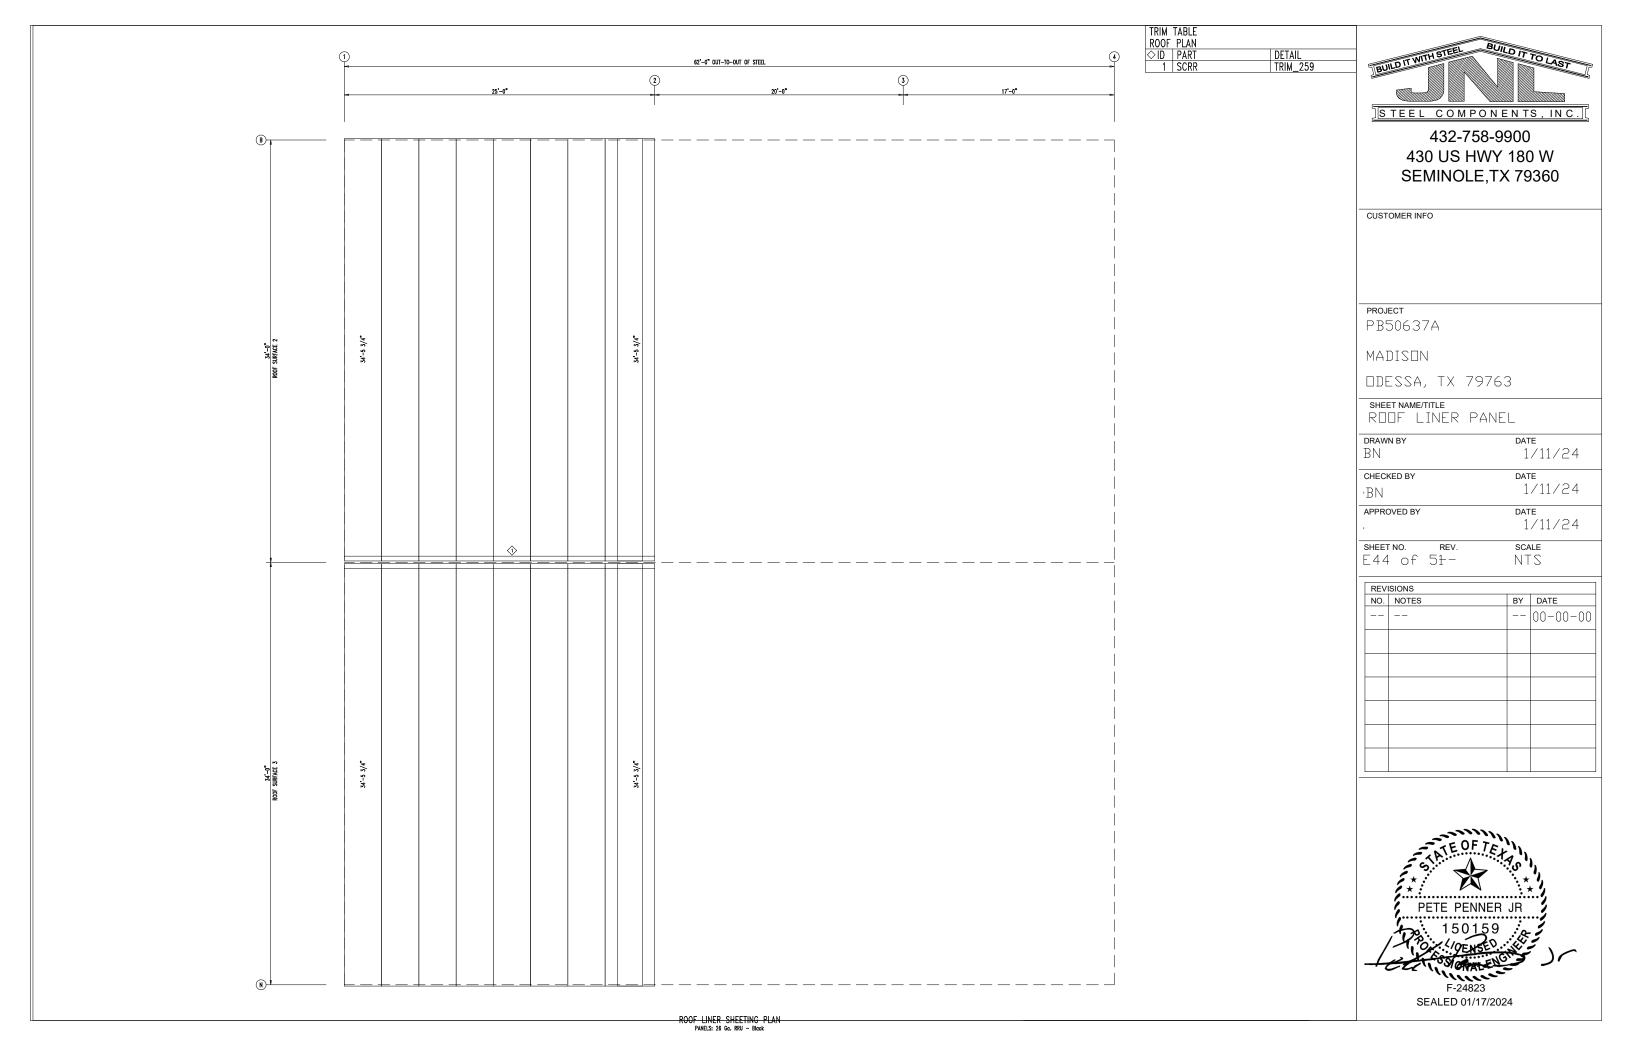
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·BN 1/11/24

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SHEET NO. REV. SCALE E43 of 51- NTS





SPLICE BOLT	S				
Splice Mark	Quan Top/	Bot	 Туре	Bolt Dia	 Length
SP- 1	4	4	A325	0.750	2.50





CUSTOMER INFO

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SHEET NAME/TITLE
WIND BENT ELEVATION

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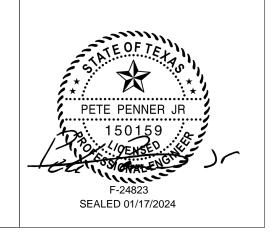
•BN 1/11/24

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1/11/24

SHEET NO. REV. SCALE E 45 of 51- NTS

REVI	SIONS		
NO.	NOTES	BY	DATE
			00-00-00



	WF-2	Š ,
21'-0"		
	WF-1 18-10 GLEW +/-	¥.
, ,		
	1/18 11'-2" 17"-7 7/8" CLEAR +/- 20"-0"	1'-2"

Section 1972 The Sectio	PLICE BOLTS plice		
5 1/16 21'-2" 21'-9 7/8" 1'-2" 5, 1/16"		VEX.10 STUB WITH 6X8X1/2" PLATE CDINNECT WITH 40 5/8" A325 BDLTS EACH END WIND BENT PER DESIGN CRANE BEAMS/ANGLES NOT SHOWN FIRE CLARITY	
	5 1/ <u>1</u> g	21'-9 7/8" 1'-2" CLEAR +/- 25'-0"	

MEMBER LENGTH 21'-9 3/8" 22'-6" W1464020 W1464020



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CUSTOMER INFO

PROJECT PB50637

MADISON

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SHEET NAME/TITLE
WIND BENT ELEVATION

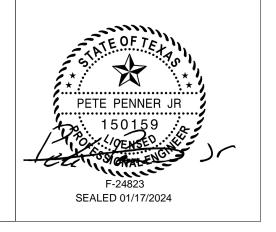
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DATE APPROVED BY 1/11/24

SHEET NO. SCALE E46 of 51-NTS

REV	ISIONS		
NO.	NOTES	BY	DATE
			00-00-00



SPLICE BOLTS	S				
Splice Mark	Quan Top/	Bot	 Type	Bolt Dia	 Length
SP- 1	4	4	A325	0.750	2.50





CUSTOMER INFO

PROJECT PB50637A

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SHEET NAME/TITLE
WIND BENT ELEVATION

DRAWN BY DATE

BN 1/11/24

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•BN 1/11/24

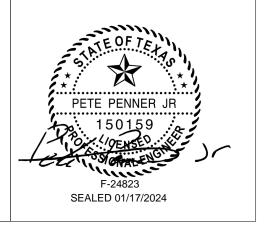
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1/11/24

SHEET NO. REV. SCALE

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NO.	NOTES	BY	DATE
			00-00-00



P-1 4 4 A325	0.750 2.50			
	1			 _ — — — -
				
			WF-3	
		 		1
	21,-0.			
	20'-0"			
		WF-1 18'-10" GLEAR +/-		
				<u></u>
	• •			
		1/18 1'-2'	17'-7 7/8" CLEAR +/- 20'-0"	1'-2"
		3		
			WIND BENT ELEVATION: FRAME LINE B	

SPLICE BOLTS Splice QuanBolt		MEMBER :
Splice Quan Bolt Mark Top/ Bot Type Dia Length SP- 1 4 4 A325 0.750 2.50		WF-101 WF-100
24-47 27-43	AND THE MIN SOCIETY PATE CONCERT STEEL SOCIETY FROM SOCIETY CONCERT STEEL SOCIETY CONCER	
5 1/19	1'-2" 21'-9 7/8" 1'-2" 5.1/16 CLEAR +/- 25'-0"	6 *
(0)	WIND BENT ELEVATION: FRAME LINE A 6	

MEMBER LENGTH 21'-9 3/8" 22'-6" W1464020 W1464020



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CUSTOMER INFO

PROJECT PB50637

MADISON

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SHEET NAME/TITLE
WIND BENT ELEVATION

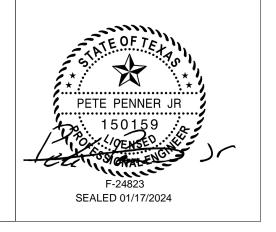
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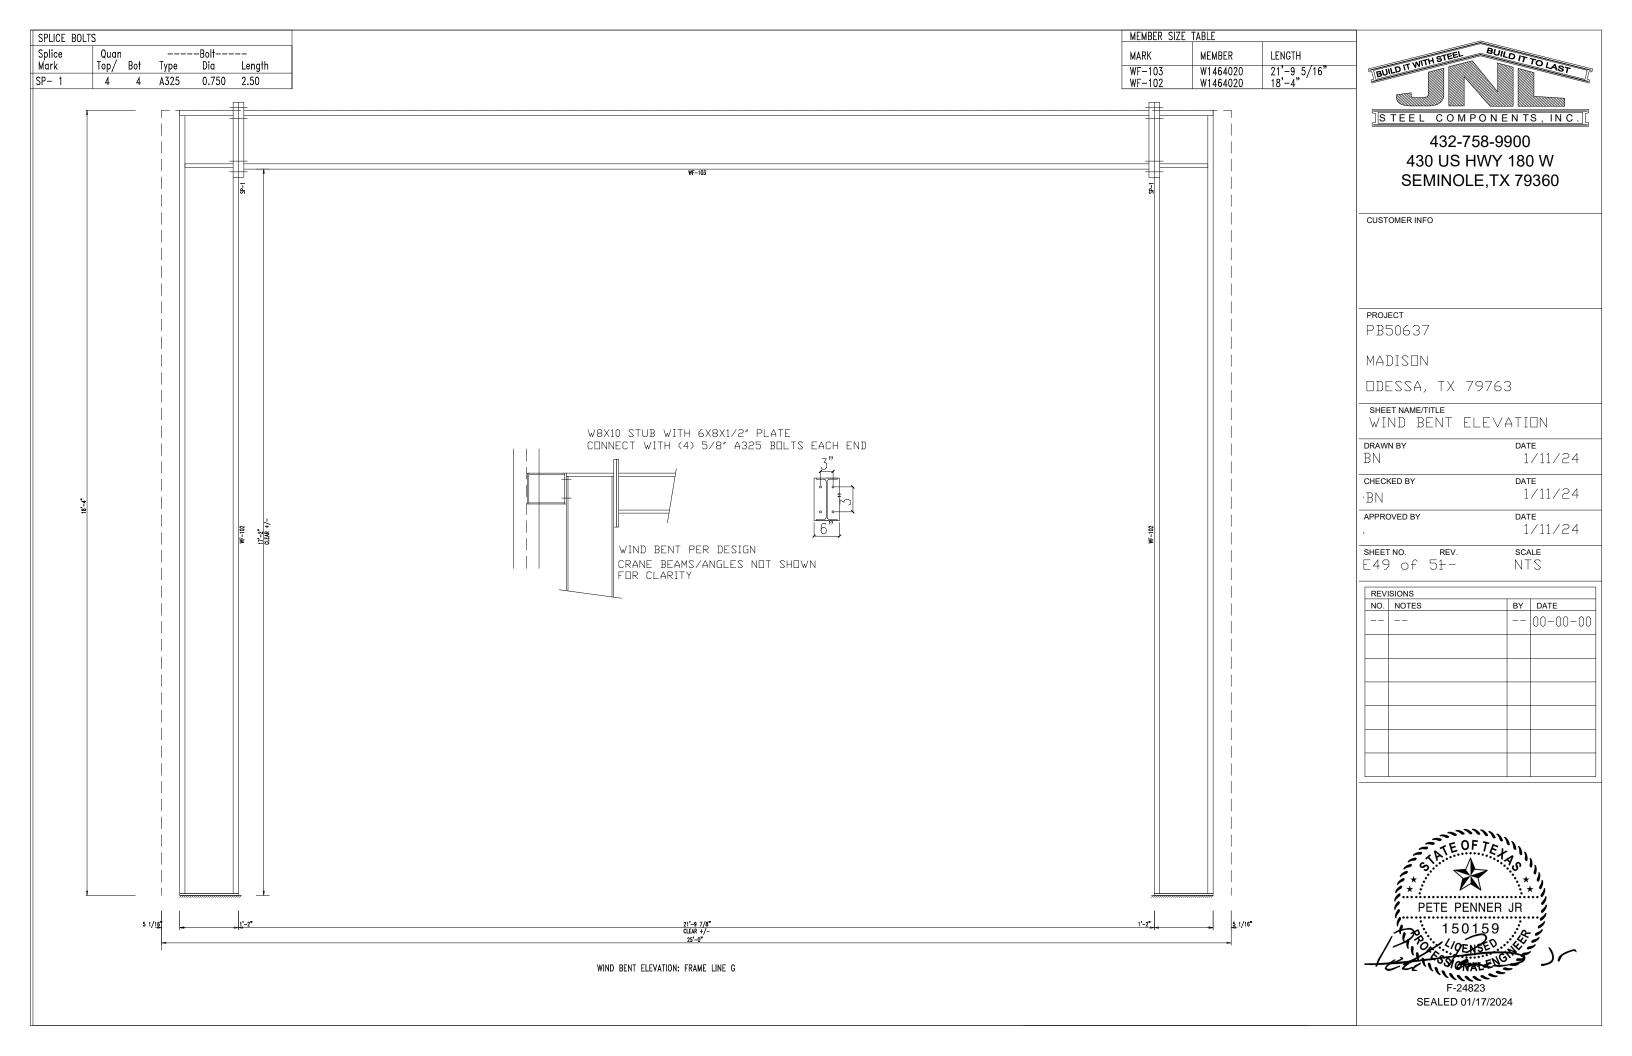
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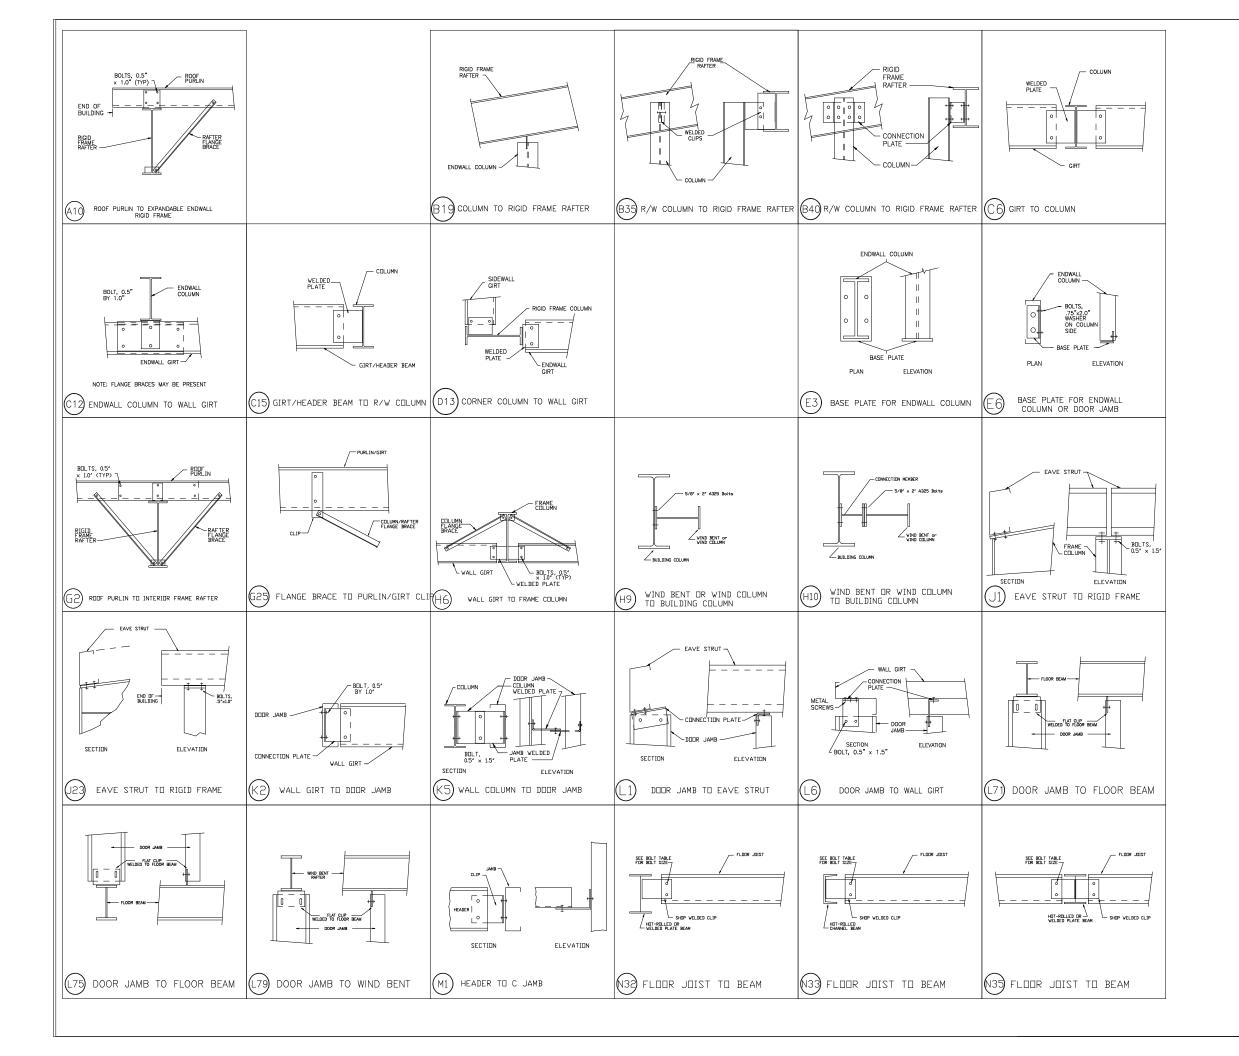
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SCALE SHEET NO. E48 of 51-NTS

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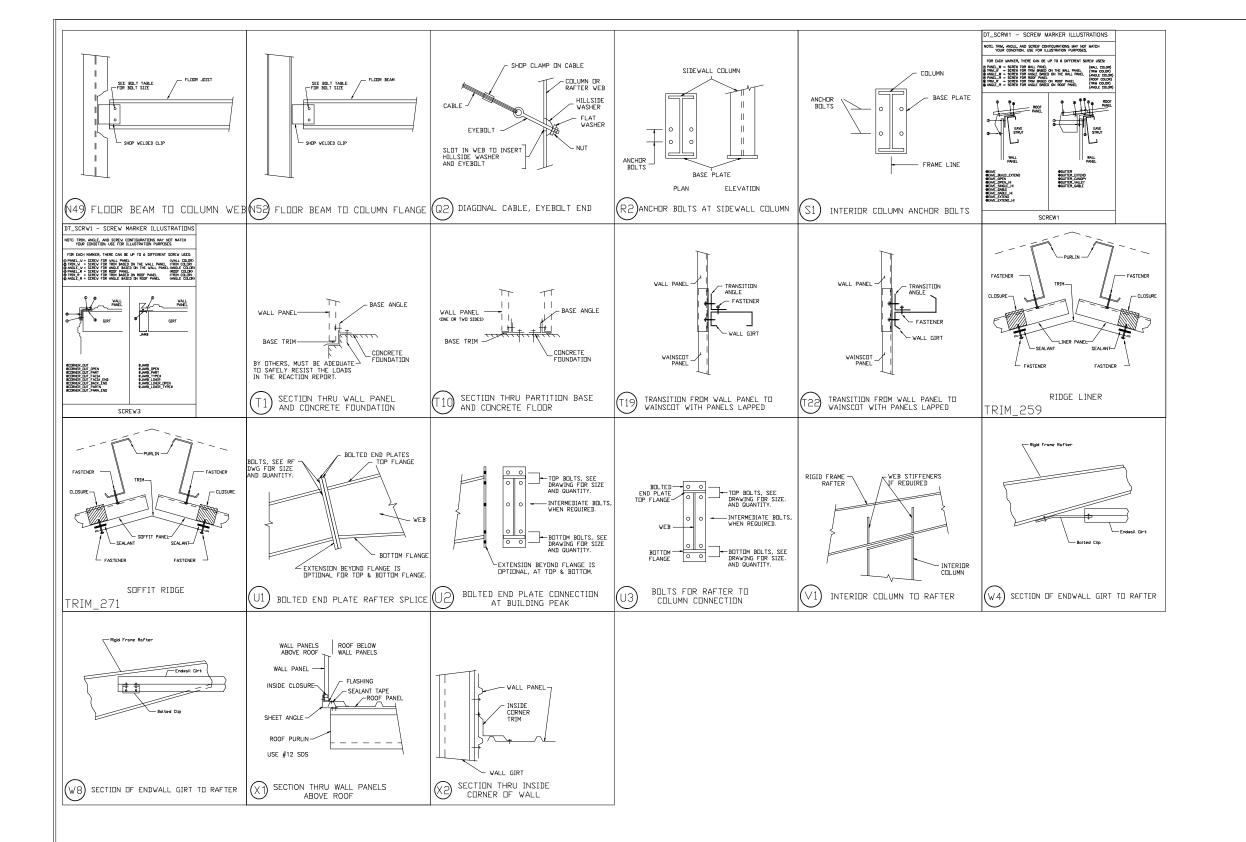
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SHEET NAME/TITLE
DETAIL DRAWINGS

DRAWN BY	DATE
BN	1/12/24
CHECKED BY	DATE
·BN	1/12/24
APPROVED BY	DATE
-	1/12/24
SHEET NO. REV.	SCALE
E50 of 51-	NTS
	BN CHECKED BY BN APPROVED BY

NO.	NOTES	BY	DATE
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SHEET NAME/TITLE
DETAIL DRAWINGS

